

RESIDENTIAL SITE PLAN APPLICATION (townhouses, apts. etc.)

City of Rochester, New Hampshire

Unclear: October 26, 2021 Is a conditional use needed? Yes: X No: Unclear: Unclear: (If so, we encourage you to submit an application as soon as possible.)
Property information
Tax map #: 137 ; Lot #('s): 35-1 ; Zoning district: Highway Commercial
Property address/location: 29 Wadleigh Road
Name of project (if applicable): Wadleigh Road Apartments
Size of site: 8.40 acres; overlay zoning district(s)?
Property owner Name (include name of individual): SSG, LLC Mailing address: 120 Washington Street, Suite 302, Rochester, NH 03839
Telephone #: Email:
Applicant/developer (if different from property owner) Name (include name of individual): Fenton Groen, Groen Construction Mailing address: 120 Washington Street, Suite 302, Rochester, NH 03839 Telephone #: 603-330-7884 Email: fenton@groenconstruction.com
Engineer/designer Name (include name of individual): Bradford Jones, Jones & Beach Engineers, Inc. Mailing address: PO Box 219, Stratham, NH 03885
Telephone #: 603-772-4746 Fax #:
Email address: bjones@jonesandbeach.com Professional license #:
Proposed use (You are not bound by information on bedrooms and type of ownership unless that is a condition of approval.) Total number of proposed dwelling units: 52; number of existing dwelling units: 0
Proposed bedrooms/unit: 52 ; total number of proposed bedrooms: 90

New building(s)? addition(s)/modifications to existing building(s)?
Townhouses/rowhouses: flats:x duplexes: freestanding detached units:
Proposed ownership - leasehold: x fee simple conveyance: condominiums:
Utility information
City water? yes x no ; How far is City water from the site? 660
City sewer? yes x no; How far is City sewer from the site? 680'
If City water, what are the estimated total daily needs? 13,500 gallons per day
Where will stormwater be discharged? Route 125 and on-site
Other information
parking spaces: existing: o total proposed: 103; Are there pertinent covenants?
Describe existing conditions/use (vacant land?): Vacant Land
Check any that are proposed: variance; special exception; conditional use
Wetlands: Is any fill proposed? X ; area to be filled: 3,750 ; buffer impact? yes

Proposed post-development disposition of site (should total 100%)					
	Square footage	% overall site			
Building footprint(s) – give for each building	17,874	4.9			
Parking and vehicle circulation	71,150	19.4			
Planted/landscaped areas (excluding drainage)	84,500	23.1			
Natural/undisturbed areas (excluding wetlands)	156,810	42.9			
Wetlands	32,670	8.9			
Other – drainage structures, outside storage, etc.	2900	0.8			

Comments

Please feel free to add any comments, additional information, or requests for waivers here: The developer has been in front of the ZBA for a variance.

Submission of application

This application must be signed by the property owner, applicant/developer (if different from property owner), and/or the agent.

I(we) hereby submit this Site Plan application to the City of Rochester Planning Board pursuant to the City of Rochester Site Plan Regulations and attest that to the best of my knowledge all of the information on this application form and in the accompanying application materials and documentation is true and accurate. As applicant/developer (if different from property owner)/as agent, I attest that I am duly authorized to act in this capacity.

Signature of property owner:	Fenten Brown, Manager, 456,110
	Date: 10/76/7/
Signature of applicant/developer:	West Fenten Green, President,
	Date: 10/26/21 Green Construction
Signature of agent:	
1	Date:
Authorization to enter subject pro	operty

I hereby authorize members of the Rochester Planning Board, Zoning Board of Adjustment, Conservation Commission, Planning Department, and other pertinent City departments. boards and agencies to enter my property for the purpose of evaluating this application including performing any appropriate inspections during the application phase, review phase. post-approval phase, construction phase, and occupancy phase. This authorization applies specifically to those particular individuals legitimately involved in evaluating, reviewing, or inspecting this specific application/project. It is understood that these individuals must use all reasonable care, courtesy, and diligence when entering the property.

Signature of property owner: Ferton Grover, Marager 43



85 Portsmouth Avenue, PO Box 219, Stratham, NH 03885 603.772.4746 - JonesandBeach.com

October 26, 2021

Rochester Planning Board Attn. Nel Sylvain, Chair 31 Wakefield Street Rochester, NH 03867

RE: Site Plan Application

29 Wadleigh Road, Rochester, NH

Tax Map 137, Lot 35-1 JBE Project No. 21137

Dear Mr. Sylvain,

Jones & Beach Engineers, Inc., respectfully submits a Site Plan Application for the above-referenced parcel on behalf of our client, Groen Construction. The intent of this application is to design a 52 unit, 17,874 sq ft apartment building that will be serviced by a new sewer and water connection extension off of Wadleigh Road. Currently, Jones & Beach has completed a boundary and topographical survey and located the wetland flags recently set by Gove Environmental Services, Inc.

The area of the parcel is 8.4 acres or 364,175 sq ft. in size and the northwest side of the property is bounded by the Axe Handel Brook. A portion of the property is within the floodplain and depicted on the site plans. A portion of the existing Wadleigh Road will be reconstructed and paved after utilities are installed. Our project will require one wetland crossing to access the property. The existing cell tower will remain and a new access road will be constructed to the tower. This project will require a DES AOT and Wetland permit.

The zoning for our parcel is Highway Commercial HC and there will be 104 parking spaces required. Currently the site has overhead power and communications from Wadleigh Road to the existing cell tower on the property. Underground power will be installed on our property to service the proposed apartment building.

Separate from this application the developer has approval by the Zoning Board of Adjustments for relief from the following sections of the Zoning Ordinance:

- §275-20.2(K)(3), which requires in relevant part that multifamily residential uses within commercial districts be only secondary uses, and that first floor consist of only commercial uses.
- §275-19.2E, which requires 7,500sq ft to be used as the minimum number of square feet of lot space per dwelling unit, given the location of the lot outside the density rings as shown on the zoning map.

• Table 19-B Dimensional Standards – Commercial Districts, which permits a maximum building height of three (3) stories.

Four (4) copies of the following are provided in support of this application with the following items:

- 1. Site Plan Application with Checklist.
- 2. Current Deed.
- 3. Signed Authorization.
- 4. Abutters List with Three (3) Sets of Mailing Labels.
- 5. Tax Map.
- 6. Two (2) Traffic Memo.
- 7. Two (2) Drainage Analysis.
- 8. Three (3) Full Size Plan Sets.
- 9. Four (4) Half-Size Plan Sets (folded).
- 10. Four (4) Architectural Plan Sets.
- 11. One (1) PDF of All Documents.

If you have any questions or need any additional information, please feel free to contact our office. Thank you very much for your time.

Very truly yours,

JONES & BEACH ENGINEERS, INC.

Bradford Jones Vice President

cc: Fenton Groen, Groen Construction (application & plans via email)



Site Plan Checklist (residential and nonresidential)

*To be filled out by applicant/agent (with notes to be inserted by staff)

See regulations for other specific requirements

City of Rochester Planning & Development Department

Project Name: Wadleigh Road Apartments		Map:	137	Lot:_	35 Date: 10/26/21
Applicant/agent: Groen Construction, Fenton Gro	en	_ Signa	ature: _	/u	
(Staff review by:		_ Date:		10	7/27/21
General items				Waive	
4 sets completed application	Yes	No	N/A	Requ	ested Comments
Total application fee	X				
4 copies of narrative	x				
3 sets of full-size plans	X				
2 sets of 11 X 17 reductions	x				
Completed abutters list	X				
Copy of existing covenants, easements, deed restrictions	x				
Plan Information Basic information including: Title sheet Name of Project Date North arrow Scale Legend Revision block Vicinity sketch -not less than 1" = 1,000	x				
Name and address of developer/applicant	х				
Name, stamp, and NH license # of land survey, engineer, and/or architect	X				
City tax map & lot #'s	X				
Notation on plans: "For more information about this site plan contact"		X			

General items Continued				Waive		_
Approval block (for signature by staff attesting to Planning Board approval)	Yes	No	N/A	Reque	ested ———	Comments
References to neighboring plans and subdivisions		x				
Surveyed property lines including: existing and proposed bearings existing and proposed distances pins, stakes, bounds monuments benchmarks 	х					
Include error of closure statement		x				
Information on abutting properties: owner name owner address tax map and lot # square footage of lots approximate building footprints use	x					
Zoning Zoning designations of subject tract and in vicinity of tract	х				·	
Zoning requirements for district: • frontage • lot dimensions/density • all setbacks • lot coverage	x					
Zoning overlay districts	X					
Existing Topographic Features: Contour lines a (not to exceed two-foot Intervals, except on steep slopes) and spot elevations	X					
Soil types and boundaries		X				
Soil test pit locations, profiles, and	X					
Depth to water table and ledge Percolation test locations and results	X					

Existing Topographic Features Co				Waiv	
Water features (ponds, streams)	Yes	No	N/A	Requ	ested Comments
Wetlands including name of certified Wetlands scientist who delineated		x			
Statement whether located in flood area, And if so, 100 year flood elevation	X				
Delineation of trees and open areas		X			
Overview of types of trees and vegetation		X			
Stone walls and archaeological features	X				
Locations of trails and paths	X				
Other natural/cultural resources (productive farmland, habitats, scenic views, historic structures, etc)	х				
Building Information Existing buildings/structures including square footage and use			X		
Proposed building/structures including square footage first floor elevation use # bedrooms per unit if residential	x				Previously Submitted
Elevation drawing of proposed buildings and structures as follows: • Showing all four sides • Drawn to scale with dimensions • Showing exterior materials • Showing exterior colors	X				Previously Submitted
Circulation and Parking Plans Existing and proposed driveways and access points including: Width of opening Turning radii Cross section of driveway		x			
Curbing & edge treatment	X				
Traffic control devices, if appropriate:		Х			II-dead \$16/0010

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Updated 5/6/2019

Circulation and Parking Plans Co.	<u>ntinu (</u>	ed:		Waive	r	
Number of parking spaces required by ordinance	Yes	No	N/A	Reque	ested ———	Comments
• proposed		_	_			
Parking layout and dimensions of spaces	x					
Handicap spaces	х					
Loading area			x			
Pedestrian circulation plan (including existing sidewalks in vicinity, if any)		X				
Bicycle rack, if appropriate		x				
Buffers, landscaping & screening	X					
Snow storage areas/plan	x					
<u>Utilities</u> Show all pertinent existing and proposed p	rofiles	, elevat	tions, m	naterials	, sizes	, and details
Water lines/well (with protective radius)	x					
Sewer lines/septic and leaching areas	X					
Pump stations			x			
Stormwater management system: pipes, culverts,, catch basins detention/ retention basins, swales, rip rap, etc.	Х					
Fire hydrant location(s) and details	x					
Electric, telephone, cable TV (underground or overhead)	х					
Gas lines	x					
Fire alarm connections	X					
Treatment of solid waste (dumpsters?)	Х					
Handing of oil, grease, chemicals hazardous materials/waste		х				

<u>Landscaping Plan</u>			h1/4	Waive	
Demarcation of limits of construction, clear delineation of vegetation to be saved and strategy for protecting vegetation	Yes 	No x	N/A	Reque	ested Comments
Proposed ground cover, shrubbery, and trees including: • botanical and common names • locations and spacing • total number of each species • size at installation	x				
Planting plan (size of holes, depth of planting, soil amendments, etc.)	X				
Irrigation: system? soaker hose? Manual? undergrou	☐ und, et	x c.			
Protection of landscaping from vehicles (Curb stops, berm, railroad ties, etc)		X			
Specification all finished ground surfaces and edges (greenspace, mulch, asphalt, concrete, etc.)	X				
Fencing/screening		x			
Signage Location and type of signs: Attached to building Freestanding Directional, if appropriate		x			
Dimensions of signs: Height Area Setback		X			
Elevation drawings with colors & materials					
Type of Illumination, if proposed	X				

Outdoor Lighting				Waiver	
Locations	Yes	No	N/A	Requested	Comments
Height of fixtures		х			
Wattage	X				
Type of light (high pressure sodium, etc)		X			
Design/cut sheets of fixtures	X				
Illumination study, if appropriate		X			
Other Elements Traffic study, if appropriate		X			
Drainage study with calculations, storm V impact analysis, and mitigation plan	Vater	x			
Grading plan (including finish grades)	X				
Earth being removed from site(in cubic yards	s) 🗌	x			
Erosion and sedimentation plan	X				
Proposed covenants, easements, And deed restrictions, if any		x			
Fiscal impact study, if requested		X			
Additional Comments:					
					-

Doc#0014166 Oct 1, 2018 2:47 PM Book 4605 Page 0408 Page 1 of 5 Register of Deeds, Strafford County C/H L-CHIP STA135272

Return to: Wensley & Jones, P.L.L.C. 40 Wakefield Street Rochester, NH 03867



<u>DEED AND</u> ASSIGNMENT AND ASSUMPTION OF EASEMENT(S)

KNOW ALL MEN BY THESE PRESENTS, that JEN-SCOT REALTY, INC., a New Hampshire corporation with a mailing address of P. O. Box 632, New Castle, New Hampshire 03854 (hereinafter referred to as the "Grantor"), for consideration paid, grants to SSG, LLC, a New Hampshire limited liability company with an address of 120 Washington Street, Suite #302, Rochester, New Hampshire 03839 (hereinafter referred to as the "Grantee"), with warranty covenants and quitclaim covenants as to TRACT I and with quitclaim covenants as to TRACT II:

Rochester, New Hampshire (2 Tracts):

A. TRACT I (conveyed with warranty covenants and quitclaim covenants):

A certain tract or parcel of land, situated in the City of Rochester, County of Strafford and State of New Hampshire on the northeasterly side of the Spaulding Turnpike. Said parcel appearing on a plan of land for Normand Ramsey, Rochester, New Hampshire, prepared by Berry Const. Co. dated May 29, 1981.

This parcel is designated on said plan as "AREA 8.0 acres +/-", and bounded and described as follows:

Beginning at a point on the northeasterly side of the Spaulding Turnpike which point is the southerly corner of said lot and in the center of "Old Concord State Road", so-called, thence running by said Spaulding Turnpike along a curve to the right with a radius of two thousand eight hundred sixty-five (2865) feet, a distance of five hundred forty-seven (547) feet to a point; thence continuing by said Spaulding Turnpike North 21° 43' 07" West a distance of six hundred eighty-eight and ninety-three hundredths (688.93) feet to the southerly side of Axe Handle Brook; thence turning and following said Brook in a generally southeasterly direction a distance

1

of one thousand three hundred twenty (1320) feet to a point approximately in the center of Old Concord State Road, so-called; thence turning and running South 51° 31' 33" West a distance of one hundred ninety-two and eighty-eight hundredths (192.88) feet to a point; thence continuing South 52° 57' 45" West a distance of three hundred forty-two (342) feet to the point of beginning.

Said parcel containing eight (8) acres, more or less.

Meaning and intending to describe and convey the same premises conveyed in Warranty Deed of Normand H. Ramsey and Pamela H. Ramsey to Jen-Scot Realty, Inc. dated January 3, 1985 and recorded in the Strafford County Registry of Deeds at Book 1167, Page 674.

B. TRACT II (conveyed with quitclaim covenants):

A certain parcel of land located at the northerly end of Axe Handle Road (formerly, and sometimes currently, known and referred to as Wadleigh Road), and on the easterly sideline of the Spaulding Turnpike, now also known as New Hampshire Route 16, in the City of Rochester, Strafford County, State of New Hampshire; said parcel being shown as "OLD GONIC ROAD, a.k.a OLD CONCORD STATE ROAD" on a certain plan entitled "Plan of Land, Parcel No. 5, Tax Assessor's Map No. 59 and Parcel No. 2, Tax Assessor's Map No. 8, New Hampshire Route 125, a.k.a. Gonic Road, City of Rochester, County of Strafford, New Hampshire", dated September 7, 1989, as prepared by CIVILWORKS, INC., and recorded in the Strafford County Registry of Deeds as Plan No. 37A-28, and being more particularly bounded and described as follows:

Beginning at an iron rod set in the ground on the easterly sideline of said Spaulding Turnpike and the southwesterly corner of land now or formerly of Jen-Scot Realty, Inc. and the westerly corner of the herein conveyed premises; thence running North 37° 55' 18" East, 331.00 feet along a stone wall and land now or formerly of said Jen-Scot Realty, Inc. to a drill hole set in said stone wall; thence running on the same line North 37° 55' 18" East, 60.93 feet along land now or formerly of said Jen-Scot Realty, Inc. to an iron rod set in the ground; thence turning and running South 57° 58' 38" East, 31.98 feet along land now or formerly of said Jen-Scot Realty, Inc. to an iron rod set in the ground; thence running on the same line South 57° 58' 38" East, 31.97 feet along land now or formerly of said Jen-Scot Realty, Inc. to an iron rod set in the ground; thence turning and running South 37° 02' 44" West, 66.25 feet along the northerly end of said Axe Handle Road to a drill hole set in a stone wall; thence turning and running South 41° 51' 33" West, 337.13 feet along said stone wall and land now or formerly of said Jen-Scot Realty, Inc. to an iron rod set in the ground on the easterly sideline of said Spaulding Turnpike; thence turning and running on a curve to the right with a radius of 2,715.00 feet, an arc distance of 41.68 feet to an iron rod set in the ground and being the point of beginning.

Said parcel containing 21,800 square feet, more or less.

To the extent that the real property described as part of this TRACT II overlaps with the real property described as a part of TRACT I above, such real property is conveyed solely with

quitclaim covenants and without warranty covenants.

Meaning and intending to describe and convey with quitclaim covenants the same premises conveyed in Quitclaim Deed of the City of Rochester to Jen-Scot Realty, Inc. dated December 7, 1994 and recorded in the Strafford County Registry of Deeds at Book 1781, Page 669.

With regard to both TRACT I and TRACT II above, further reference is made to plan entitled, "Plan of Land, Parcel No. 5, Tax Assessor's Map 59 and Parcel No. 2, Tax Assessor's Map No. 8, New Hampshire Route 125 a.k.a. Gonic Road, City of Rochester, County of Strafford, New Hampshire as prepared for Owner of Record: Jen-Scot Realty, Inc." dated September 7, 1989 and recorded in the Strafford County Registry of Deeds as Plan #37A-28.

C. ASSIGNMENT AND ASSUMPTION OF EASEMENT(S):

WHEREAS, Grantor and Unison Site Management, L.L.C., a Delaware limited liability company ("Unison"), entered into that Easement and Assignment Agreement dated October 7, 2004 ("Easement Agreement"), which was recorded in Book 3107, Page 524 in the Strafford County Registry of Deeds ("Registry"), for that property located in Rochester, Strafford County, New Hampshire, in which Grantor granted to Unison an exclusive perpetual easement for an approximately 3,400 square foot portion (said portion being the "Communication Easement") of that property identified as Tax ID Number 65140-0137-0035-0001, and being described in Book 1167, Page 674 in the Registry (the "Grantor's Property"), together with a non-exclusive perpetual easement for ingress, egress and utilities over a portion of the Grantor's Property leading from Wadleigh Road to the Easement Area ("Access and Utility Easement"); and

WHEREAS, Unison assigned its right, title and interest in the Easement Agreement to Cell Tower Lease Acquisition LLC, a Delaware limited liability company ("Cell Tower"), pursuant to that Assignment of Easement dated October 13, 2004, and recorded in Book 3107, Page 536 in the Registry; and

WHEREAS, Cell Tower assigned its right, title and interest in the Easement Agreement to Global Signal Acquisitions IV LLC, a Delaware limited liability company ("Global"), pursuant to that Assignment and Assumption of Easements and Leases dated November 8, 2011, and recorded in Book 3970, Page 226 in the Registry; and

WHEREAS, Grantor and Global entered into a First Amendment to Easement and Assignment Agreement dated October 23, 2014 ("First Amendment"), which was recorded in Book 4266, Page 126 in the Strafford County Registry of Deeds ("Registry"), and, among other things, made certain changes and/or amendments to the provisions of the Easement and Assignment Agreement dated October 7, 2004 and recorded in the Registry at Book 3107, Page 524; and

WHEREAS, this conveyance is specifically made subject to the Easement Agreement referred to above, and dated October 7, 2004 and recorded in Book 3107, Page 524 of the

Registry, as the same shall have been modified, amended and/or otherwise changed since the Easement Agreement's execution on October 7, 2004 (the "Existing Easements").

NOW, THEREFORE, for good and valuable consideration, the receipt and sufficiency of which are hereby acknowledged, Grantor, being the current owner of the real property described as above as TRACT I and TRACT II, and with respect to which the Existing Easements are located, the said Grantor does by these presents hereby grant, bargain, convey, sell, assign, transfer, set over and deliver unto the said Grantee, as Assignee, its successors, transferees, and assigns forever, and Grantee, as Assignee, does, by its acceptance hereof, assume and accept all of the rights, title, interest and responsibilities and obligations of said Grantor under, in and to the Existing Easements, together with any and all ingress/egress, utilities or other rights related to the said Existing Easements.

Dated this 28 day of Sentrales, 2018. JEN-SCOT REALTY, INC.

> Normand H. Ramsey, Duly Authorized President

STATE OF NEW HAMPSHIRE STRAFFERD.

2018

Personally appeared Normand H. Ramsey, duly authorized President of Jen-Scot Realty, Inc., known to me or satisfactorily proven to be the same person whose name is subscribed to the foregoing instrument and acknowledged that he executed the same for the purposes therein contained on behalf of Jen-Scot Realty, Inc.

Before me,

Mary Public/Justice of the Peace

Sint Name: My Commission Expires:

DEED AND ASSIGNMENT AND ASSUMPTION OF EASEMENT(S) ACCEPTED BY:

SSG, LLC, by

Groen Construction, as d/b/a for Groen Construction,

Manager

Inc.,

Print Name: Fenton Groen

Title:

President of Groen Construction Inc.

Duly Authorized

STATE OF NEW HAMPSHIRE COUNTY OF STRAFFORD

On SET. 2. , 2018, before me, the undersigned officer, personally appeared Fenton Groen, President of Groen Construction, Inc. d/b/a Groen Construction, and who acknowledged Groen Construction to be the Manager of SSG, LLC, and acting in said capacity, and being authorized so to do, executed the foregoing instrument on behalf of SSG, LLC as its voluntary act and deed for the purposes therein contained.

Before me,

Justice of the Peace/Notary Public

MINIOTHERE

Print Name:

My Commission Expires:

P.O. Box 1721 • Concord, NH 03302 tel: (603) 731-8500 • fax: (866) 929-6094 • sgp@ pernaw.com

Transportation: Engineering • Planning • Design

MEMORANDUM

Ref:

2156A

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To:

Bradford Jones, Vice President Jones & Beach Engineers, Inc.

From:

Stephen G. Pernaw, P.E., PTOE

Subject: Proposed Wadleigh Road Apartments

Rochester, New Hampshire

Date: October 8, 2021

As requested, our office has conducted a trip generation analysis for the proposed residential development depicted on the plan entitled: "Overview Site Plan," Sheet C2, dated 9/8/21, revised 9/21/21, by your office (see Attachment 1). Available traffic count data was also researched at the NHDOT. The purpose of this memorandum is to summarize the available count data in the trip generation analysis for the subject site. Our findings with respect to trip generation, traffic operations, capacity and safety. To summarize:

<u>Proposed Development</u> – According to Attachment 1, the proposed development involves the construction of a four-story apartment building on an extension of Wadleigh Road, which currently provides access to the Anchorage Inn. The proposed building will contain 52 dwelling units. The existing cell tower facility will remain. Figure 1 shows the location of the subject site with respect to the area roadway system, as well as the closest NHDOT traffic count station.

Existing Conditions – NH125 functions as a state-maintained minor arterial roadway and it carries through traffic in a general north-south direction from Barrington to the south, through Rochester to Milton to the north, and points beyond. In the immediate study area, NH125 is a three-lane facility that provides one through lane in each direction, a dual-use center turn lane, and paved shoulders on both sides of the highway. In the vicinity of the Wadleigh Road intersection, the horizontal alignment of NH125 follows a gradual eastbound horizontal curve to the right, and the vertical alignment is essentially flat. The speed limit on NH125 is posted at 30 miles per hour in both directions.

Existing Traffic Volumes - Research of available traffic count data in the area revealed that the NHDOT has conducted short-term traffic count on NH125 north of Brock Street in 2019. The Annual Average Daily Traffic (AADT) volume in 2019 was 17,078 vehicles per day (vpd), up from 15,640 vpd in 2018. The diagrams on Page 3 summarize the daily and hourly variations in traffic flow on NH125 during pre-Covid conditions. The raw traffic count data is attached (see Attachments 2-4). In all cases the PM peak hour represents a worst-case situation. Interesting to note, the 2020 AADT estimate was lower at 14,414 vpd due to the Covid-19 pandemic.

1

Letter of Authorization

I, Fenton Groen, Groen Construction, 120 Washington Street Suite 302, Rochester, NH 03839, developer of property located in Rochester, NH, known as Tax Map 137, Lot 35-1, do hereby authorize Jones & Beach Engineers, Inc., PO Box 219, Stratham, NH, to act on my behalf concerning the previously-mentioned property. The parcel is located on 29 Wadleigh Road in Rochester, NH.

I hereby appoint Jones & Beach Engineers, Inc., as my agent to act on my behalf in the review process, to include any required signatures.

Groen Construction


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ONES& BEACH ENGINEERS INC.


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I, SSG, LLC, 120 Washington Street Suite 302, Rochester, NH 03839, owner of property located in Rochester, NH, known as Tax Map 137, Lot 35-1, do hereby authorize Jones & Beach Engineers, Inc., PO Box 219, Stratham, NH, to act on my behalf concerning the previously-mentioned property. The parcel is located on 29 Wadleigh Road in Rochester, NH.

I hereby appoint Jones & Beach Engineers, Inc., as my agent to act on my behalf in the review process, to include any required signatures.




Pernaw & Company, Inc.

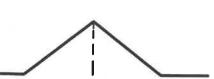


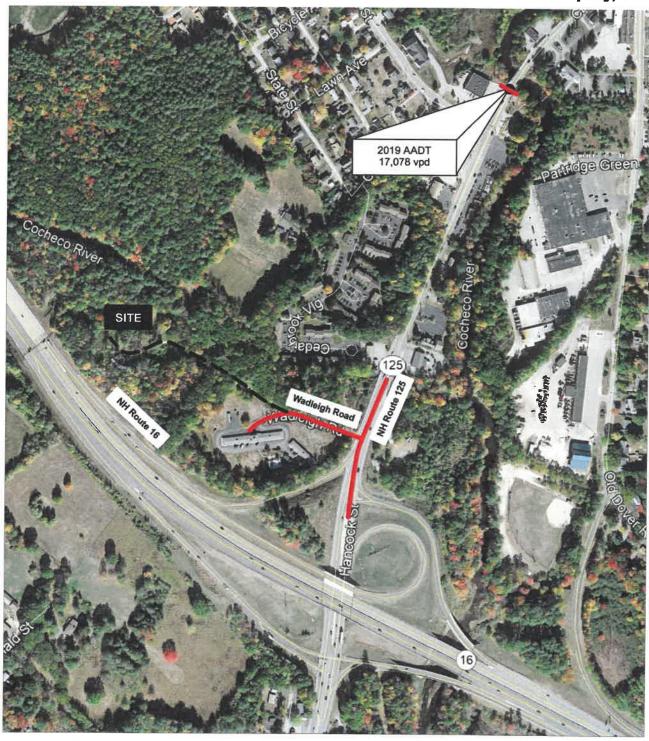= AUTOMATIC TRAFFIC RECORDER LOCATION (NHDOT)

2156A



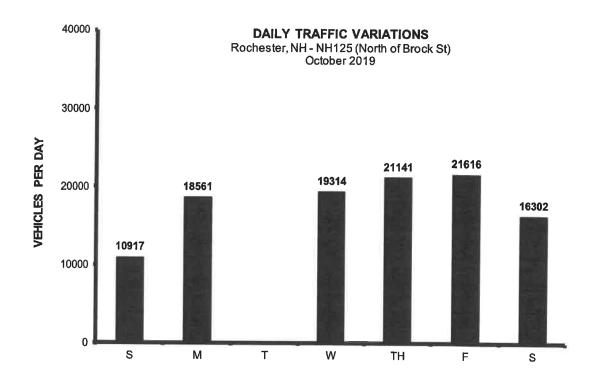

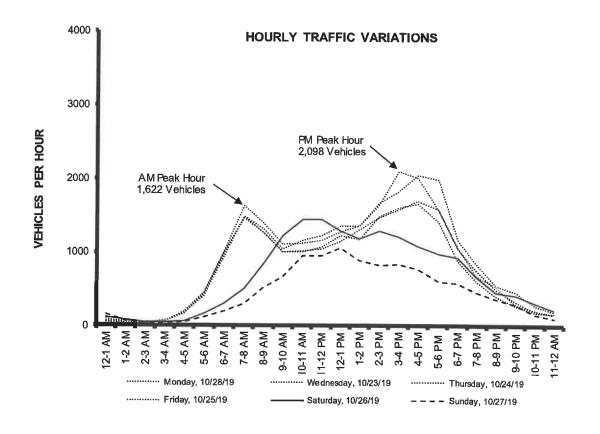



<u>Traffic Generation</u> - To estimate the quantity of vehicle-trips that will be produced by the proposed residential development, Pernaw & Company, Inc. considered the standardized tripgeneration rates and equations published by the Institute of Transportation Engineers (ITE)¹. The most applicable land use category is ITE Land Use Code 221 (Multifamily Housing / Mid-Rise), which includes apartments. The following results are summarized on Table 1 and are based upon the number of dwelling units as the independent variable. This table shows that the proposed apartment building will generate approximately 11 vehicle-trips (2 entering, 9 departures) during the weekday PM peak hour period, and 21 vehicle-trips (13 arrivals, 8 departure) during the worst-case weekday PM peak hour period.

Table 1	Trip G	Seneration Summary
		52 Apartments 1
Weekday Total (2	4 hrs.)	
	Entering	101 veh
	Exiting	<u>101</u> <u>veh</u>
	Total	202 trips
Weekday AM Pea	k Hour	
	Entering	2 veh
	Exiting	9 veh
	Total	11 trips
Weekday PM Peal	k Hour	
	Entering	13 veh
	Exiting	8 veh
	Total	21 trips

1ff E Land Use Code 221- Multifamily Housing (Mid-Rise) 11h Edition

It is reasonable to expect that the majority of residents will utilize NH16 or NH125 to travel to/from points south depending upon their ultimate trip origin/destination. This means left-turn arrivals and right-turn departures will likely be the predominant traffic movements at the NH125/Wadleigh Road intersection. Favorably, there is an existing center turn lane to accommodate left-turn arrivals onto Wadleigh Road.

¹ Institute of Transportation Engineers, *Trip Generation Manual*, 11th edition (Washington, D.C., 2021).



Findings & Conclusions:

- 1. According to data collected at the NHDOT count station that is located approximately 0.3 miles north of Wadleigh Road, this section of NH125 carried an AADT volume of approximately 17,078 vehicles per day in 2019, up from 15,640 vpd in 2018. The highest hourly traffic volumes occurred from 7:00 to 8:00 AM and from 3:00 to 4:00 or 4:00 to 5:00 PM on weekdays. The 2020 AADT was lower at 14,414 vpd due to the pandemic.
- 2. The trip generation analyses indicates that the proposed residential apartment building will generate approximately 11 vehicle-trips during the AM peak hour (2 arrivals, 9 departures) and 21 vehicle-trips during the PM peak hour (13 arrivals, 8 departures) when completed.
- 3. Development sites that generate fewer than 500 vehicle-trips per day are generally considered to be "low" volume traffic generators. Based on the daily estimate of 202 vehicle-trips per day (see Table 1), the proposed apartment building is not considered to be a major traffic generator.

Attachments

PERNAW NO. 5234


CENSED CHILINIAN

ONAL ENGINEER

O

Stephen G. Pernaw & Company, Inc.

ATTACHMENTS

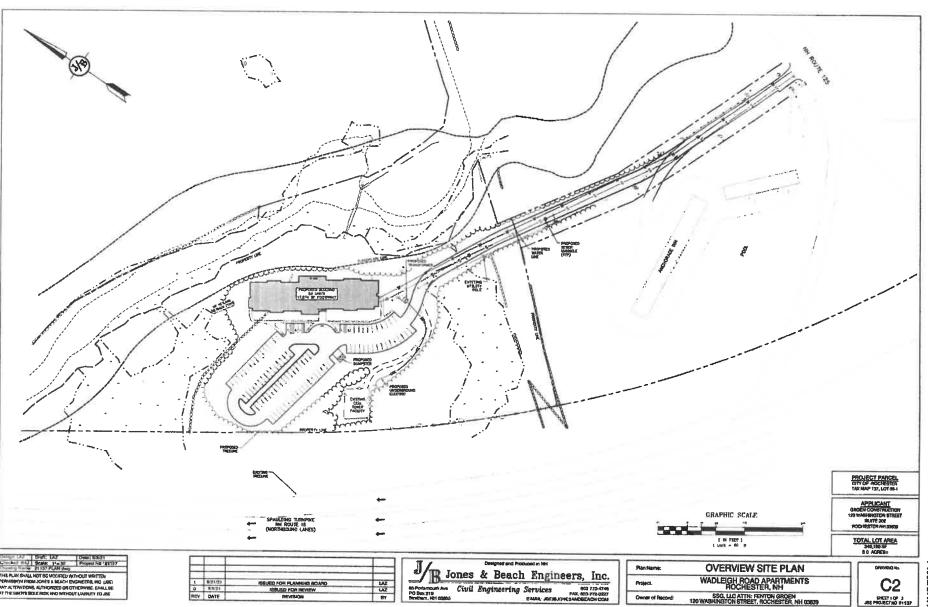

Project.

LAZ CAZ BY

1 8:21/21 0 9:931 REV DATE

ISSUED FOR PLANNING BOARD ISSUED FOR REVIEW REVISION

Attachment 1

C2 SHEET 1 09 1 JEE PHOLECT NO \$11339







Transportation Data Management System

List View All DIRs

Location ID	82389074	MPO ID	
	SPOT	HPMS ID	
On NHS	No	On HPMS	Yes
LRS ID	S0000125	LRS Loc Pt.	155
SF Group	04	Route Type	
AF Group	04	Route	NH 125
GF Group	E	Active	Yes
Class Dist Grp	Default	Category	3
Seas Clss Grp	Default		
WIM Group	Default		
QC Group	Default	NAME 3	
Fnct'l Class	Minor Arterial	Milepost	
Located On	Gonic Rd		
Loc On Alias	NH 125 (GONIC RD) NORTH OF BROCK ST (SB-NB) (81:	389037-8138903	38)
/lore Detail			

Directions: 2-WAY NB SB

Year	AADT	DHV-30	K %	D %	PA	BC	Src
2020	14,414 ³		12	51	13,117 (91%)	1,297 (9%)	Grown from 2019
2019	17,078	2,098	12	51	15,645 (92%)	1,433 (8%)	
2018	15,640 ³				14,420 (92%)	1,220 (8%)	Grown from 2017
2017	15,333 ³				14,230 (93%)	1,103 (7%)	Grown from 2016
2016	15,032 ³				13,710 (91%)	1,322 (9%)	Grown from 2015

Trave	l Demand	Model	4-10-16		OF SAIN	3 4 1 1	10-55	50 /5 100	100	FOR FORE
	Model Year	Model AADT	AM PHV	AM PPV	MD PHV	MD PPV	PM PHV	PM PPV	NT PHV	NT PPV

VOLUME COUNT					
	Date	Int	Total		
199	Mon 10/28/2019	60	18,561		
40	Sun 10/27/2019	60	10,917		
30	Sat 10/26/2019	60	16,302		
40	Fri 10/25/2019	60	21,616		
40	Thu 10/24/2019	60	21,141		
40	Wed 10/23/2019	60	19,314		
40	Thu 10/20/2016	60	19,627		
40	Wed 10/19/2016	60	19,717		

Year	Annual Growth
2020	-16%
2019	9%
2018	2%
2017	2%
2016	2%
2015	3%
2014	2%
2212	401









Excel Version

Weekly Volume Re	eport	CAR US WATER	SALE NO TRANSPORTED TO THE PARTY OF THE PART
Location ID:	82389074	Туре:	SPOT
Located On:	Gonic Rd		
Direction:	2-WAY		
Community:	ROCHESTER	Period:	Mon 10/21/2019 - Sun 10/27/2019
AADT:	17078		

09

Start Time	Mon	Tue	Wed	Thu	Fri	Sat	Sun	Avg	Graph
12:00 AM			84	57	62	115	153	94	
1:00 AM			43	64	61	71	65	61	0.39
2:00 AM			44	41	46	51	38	44	
3:00 AM			76	62	59	54	32	57	
4:00 AM			174	199	173	67	50	133	2
5:00 AM			438	448	420	167	116	318	and
6:00 AM			989	983	921	303	190	677	3.89
7:00 AM			(1460)	(1622)	(1482)	513	304	1,076	The state of the s
8:00 AM			1258	1389	1308	849	521	1,065	
9:00 AM			1007	1108	1046	1224	663	1,010	
10:00 AM			1018	1123	1152	1439	955	1,137	6.49
11:00 AM			1046	1155	1222	1441	953	1,163	6.5%
12:00 PM			1145	1269	1353	1286	1056	1,222	6.8%
1:00 PM			1302	1353	1351	1189	879	1,215	6.8%
2:00 PM			1474	1646	1671	1284	816	1,378	7.7%
3:00 PM			1581	2098	1823	1214	835	1,510	8.5%
4:00 PM			2 1694	2004	2040	1084	768	1,518	8.5%
5:00 PM			1577	1565	1974	970	592	1,336	7.5%
6:00 PM			1052	1041	1153	925	578	950	5.3%
7:00 PM			671	742	836	669	455	675	3.8%
8:00 PM			533	500	543	448	364	478	2.7%
9:00 PM			285	323	454	409	282	351	2.0%
10:00 PM			211	200	277	307	151	229	1.3%
11:00 PM			152	149	189	223	101	163	0.9%
Total	0	0	19,314	21,141	21,616	16,302	10,917	100	0.0 A
24hr Total			19314	21141	21616	16302	10917	17,858	
AM Pk Hr			7:00	7:00	7:00	11:00	10:00	11,000	
AM Peak			1460	1622	1482	1441	955	1,392	
PM Pk Hr			4:00	3:00	4:00	12:00	12:00	,,,,,,,,,,,,,,,,,,,,,,,,,,,,,,,,,,,,,,,	
PM Peak			1694	2098	2040	1286	1056	1,635	
% Pk Hr			8.77%	9.92%	9.44%	8.84%	9.67%	9.33%	







Transportation Data Management System



Excel Version


Weekly Volume Re	eport	- 2	· · · · · · · · · · · · · · · · · · ·
Location iD:	82389074	Type:	SPOT
Located On:	Gonic Rd		
Direction:	2-WAY		
Community:	ROCHESTER	Period:	Mon 10/28/2019 - Sun 11/3/2019
AADT:	17078		

Start Time	Mon	Tue	Wed	Thu	Fri	Sat	Sun	Avg	Graph
12:00 AM	56							56	0.3%
1:00 AM	33							33	0.2%
2:00 AM	31							31	0.2%
3:00 AM	58							58	0.3%
4:00 AM	175							175	0.9%
5:00 AM	406						_	406	2.2%
6:00 AM	962							962	5.2%
7:00 AM	1487							1,487	8.0%
8:00 AM	1262							1,262	6.8%
9:00 AM	1006							1,006	5.4%
10:00 AM	1003						_	1,003	5.4%
11:00 AM	1068							1,068	5.8%
12:00 PM	1224							1,224	6.6%
1:00 PM	1176							1,176	6.3%
2:00 PM	1485							1,485	8.0%
3:00 PM	1595							1,595	8.6%
4:00 PM	(1648)							1,648	8.9%
5:00 PM	1402						-	1,402	7.6%
6:00 PM	870							870	4.7%
7:00 PM	602				_		_	602	3.2%
8:00 PM	399							399	2.1%
9:00 PM	273			+		-	-	273	1.5%
10:00 PM	175		-					175	0.9%
11:00 PM	165		-					165	0.9%
Total	18,561	0	0	0	0	0	0	103	0.576
24hr Total	18561				-	-	- 0	18,561	
AM Pk Hr	7:00							10,001	
AM Peak	1487							1,487	
PM Pk Hr	4:00							.,,	
PM Peak	1648							1,648	
% Pk Hr	8.88%							8.88%	

Query

DATA SOURCE:	
Trip Generation Manual, 11th Ed	~
SEARCH BY LAND USE CODE:	
221	
LAND USE GROUP:	
(200-299) Residential	
LAND USE:	
221 - Multifamily Housing (Mid-Rise)	~
LAND USE SUBCATEGORY:	
Not Close to Rail Transit	~
SETTING/LOCATION:	
General Urban/Suburban	~
INDEPENDENT VARIABLE (IV):	~~ ~ ~~
Dwelling Units	~
TIME PERIOD:	
Weekday	
TRIP TYPE:	
Vehicle	~
ENTER IV VALUE TO CALCULATE TRIPS:	
52 Calculate	

Data Plot and Equation

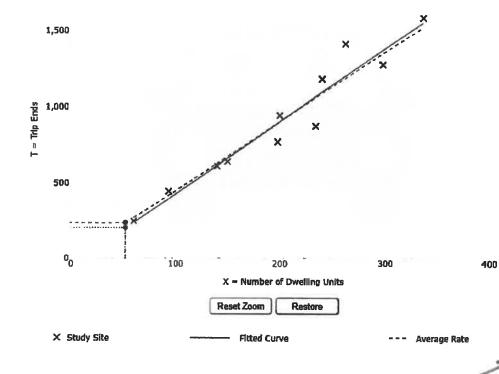

DATA STATISTICS

Land Use:

Multifamily Housing (Mid-Rise) - Not Close to Rail Transit (221) Click for Description and Data Plots

Independent Variable:

Dwelling Units

Time Period:

Weekday

Setting/Location:

General Urban/Suburban

Trip Type:

Vehicle

Number of Studies:

Avg. Num. of Dwelling Units.

201

Average Rate:

454

Range of Rates:

376-540

Standard Deviation:

0.51

Fitted Curve Equation:

T = 4 77(X) - 46.46

R2

0.93

Directional Distribution:


50% entering 50% exiting


Calculated Trip Ends:

Average Rate: 236 (Total) 118 (Entry), 118 (Exit)

Fifted Curve, 202 (Total), 101 (Entry), 101 (Exil)

Use the mouse wheel to Zoom Out or Zoom in. Hover the mouse pointer on data points to view X and T values.

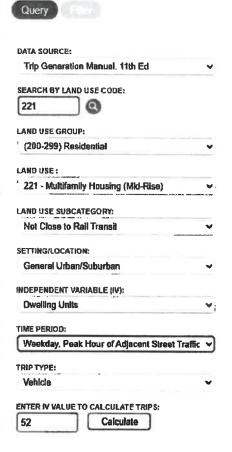


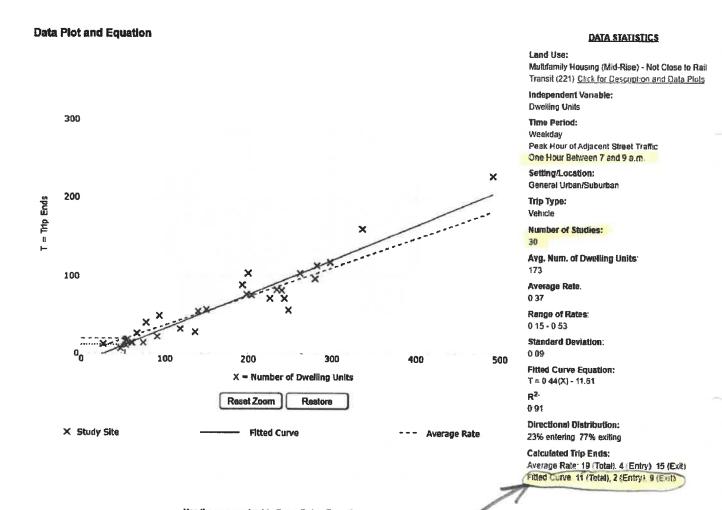

a	207 870	-
	Query	
w	willing	

DATA SOURCE: Trip Generation Manual, 11th Ed	
The advisor manager and and	-
SEARCH BY LAND USE CODE:	
221	
LAND USE GROUP:	
' (200-299) Residential	~
LAND USE :	
221 - Multifamily Housing (Mid-Rise)	٧
LAND USE SUBCATEGORY:	
Not Close to Rail Transit	٧
SETTING/LOCATION:	
General Urban/Suburban	*
INDEPENDENT VARIABLE (IV):	***
Dwelling Units	٧
TIME PERIOD:	
Weekday, Peak Hour of Adjacent Street Traffic	~
TRIP TYPE:	
Vehicle	~
ENTER IV VALUE TO CALCULATE TRIPS:	
52 Calculate	

Data Plot and Equation

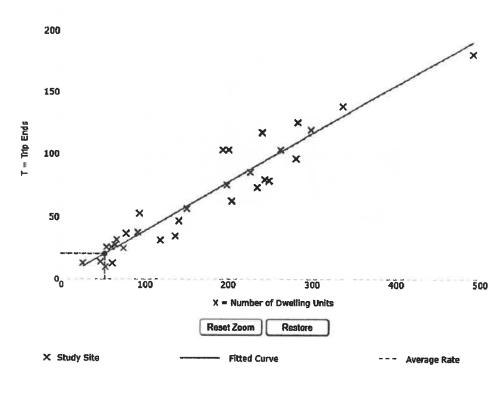

DATA STATISTICS

Land Use:

Multifamily Housing (Mid-Rise) - Not Close to Rail Transit (221) Chek for Description and Data Plots

Independent Variable:

Dwelling Units

Time Period:

Weekday

Peak Hour of Adjacent Street Traffic

One Hour Between 4 and 6 p.m.

Setting/Location:

General Urban/Suburban

Trip Type:

Vehicle

Number of Studies:

31

Avg. Num. of Dwelling Units:

169

Average Rate:

0.39

Range of Rates:

0 19 - 0 57

Standard Deviation:

0 08

Fitted Curve Equation:

T = 0.39(X) + 0.34

R²

0.91

Directional Distribution:

61% entering, 39% exiting

Calculated Trip Ends:

Average Rate 20 (Total), 12 (Entry) 8 (Exit

(Fitted Curve 21 (Total), 13 (Entry), 8 (Exit)


Use the mouse wheel to Zoom Out or Zoom in. Hover the mouse pointer on data points to view X and T values.

GENERAL LEGEND EXISTING PROPOSED SETBACK LINES CENTERLINE FRESHWATER WELLANDS LINE STREAM CHANNEL TREE LINE STONEWALL FRESHWATER WELLANDS LINE STONEWALL FRESHWATER WELLANDS FRESHWATER WELLANDS FRESHWATER LINE STONEWALL FRESHWATER LINE FRESHWATER LINE FRESHWATER LINE STONEWALL FRESHWATER LINE STONEWALL FRESHWATER LINE STONEWALL FRESHWATER LINE STONEWALL FRESHWATER LINE WATER LINE WATER LINE WATER LINE WATER LINE WATER SERVICE COVERNEAD ELECTRIC GUARDRAN GUARDRAN GUARDRAN GUARDRAN FRESHWATER BOUND FRESHWATER LINE FRESHWATER LINE WATER LINE

RETAINING WALL

RESIDENTIAL DEVELOPMENT "WADLEIGH ROAD APARTMENTS"

TAX MAP 137, LOT 35-1 WADLEIGH ROAD, ROCHESTER, NH

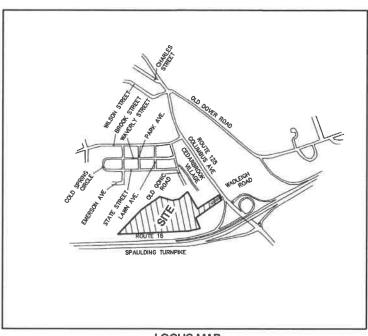

LOCUS MAP SCALE 1" = 1000'

CIVIL ENGINEER / SURVEYOR JONES & BEACH ENGINEERS, INC.

JONES & BEACH ENGINEERS, INC. 85 PORTSMOUTH AVENUE PO BOX 219 STRATHAM, NH 03885 (603) 772-4746 CONTACT: BRAD JONES EMAIL: BJONES@JONESANDBEACH.COM

TRAFFIC ENGINEER STEPHEN G. PERNAW & COMPANY, INC.

P.O. BOX 1821 CONCORD, NH 03302 (603) 731-8500 CONTACT: STEPHEN G. PERNAW EMAIL: SGP@PERNAW.COM

WETLAND CONSULTANT

GOVE ENVIRONMENTAL SERVICES, INC.
8 CONTINENTAL DR., BUILDING 2, UNIT H
EXETER, NH 03833-7526
(603) 778-0644
CONTACT: JAMES GOVE
EMAIL: JGOVE@GESINC.BIZ

LANDSCAPE DESIGNER

LM LAND DESIGN, LLC
11 SOUTH ROAD
BRENTWOOD, NH 03833
(603) 770-7728
CONTACT: LISE McNAUGHTON
LMLANDDESIGN@GMAIL.COM

WATER AND SEWER

ROCHESTER DEPARTMENT OF PUBLIC WORKS 45 OLD DOVER ROAD ROCHESTER, NH 03867 (603) 332-4096 CONTACT: MICHAEL BEZANSON, P.E.

ELECTRIC EVERSOURCE

EVERSOURCE ENERGY 74 OLD DOVER ROAD ROCHESTER, NH 03867 (603) 555-5334 CONTACT: MARK BOUCHER

SHEET INDEX

CS COVER SHEET

OVR EX OVERVIEW EXISTING CONDITIONS PLAN

C1-C2 EXISTING CONDITIONS PLAN

OVR S OVERVIEW SITE PLAN

C3-C4 SITE PLAN

C5 GRADING AND DRAINAGE PLAN

P1-4 PLAN AND PROFILE

U1-U2 UTILITY PLAN

L1 LANDSCAPE PLAN

L2-L3 LIGHTING PLAN

D1-D4 DETAIL SHEETS

E1 EROSION AND SEDIMENT CONTROL DETAILS

TELEPHONE
CONSOLIDATED COMMUNICATIONS
1575 GREENLAND ROAD
GREENLAND, NH 03840
(603) 427-5525
CONTACT: JOE CONSIDINE

CABLE TV

COMCAST COMMUNICATION CORPORATION 334-B CALEF HIGHWAY EPPING, NH 03042-2325 (603) 679-5695

NATURAL GAS UNITIL SERVICE CORP

325 WEST ROAD PORTSMOUTH, NH 03801 (603) 294-5261 MACLEAND@UNITIL.COM PROJECT PARCEL CITY OF -ROCHESTER TAX MAP 137, LOT 35-1

APPLICANT
GROEN CONSTRUCTION
120 WASHINGTON STREET
SUITE 302
ROCHESTER NH 02838

TOTAL LOT AREA

8.4 ACRES±

APPROVED - ROCHESTER, NH PLANNING BOARD

PRELIMINARY NOT FOR CONSTRUCTION DATE:

Design: LAZ Draft: LAZ Date: 9/8/21
Checked: BAJ Scale: AS NOTED Project No.: 21137
Drawing Name: 21137-PLAN.dwg
THIS PLAN SHALL NOT BE MODIFIED WITHOUT WRITTEN
PERMISSION FROM JONES & BEACH ENGINEERS, INC. (JBE).
ANY ALTERATIONS, AUTHORIZED OR OTHERWISE, SHALL BE
AT THE USER'S SOLE RISK AND WITHOUT LABILITY TO JBE.



1	9/21/21	ISSUED FOR PLANNING BOARD	LAZ
0	9/8/21	ISSUED FOR REVIEW	LAZ
REV.	DATE	REVISION	BY

Designed and Produced in NH

B Jones & Beach Engineers, Inc.

85 Portsmouth Ave. Cit PO Box 218 Stratham, NH 03885

Civil Engineering Services 603-772-4746

E-MAIL: JBE@JONESANDBEACH.COM

Plan Name Project: **COVER SHEET**


WADLEIGH ROAD APARTMENTS ROCHESTER, NH

Owner of Record:


SSG, LLC ATTN: FENTON GROEN
120 WASHINGTON STREET, ROCHESTER, NH 03839

DRAWING No.

SHEET 1 OF 22 PROJECT NO 2115 PROJECT NAME AND LOCATION STATEMENT OF THE PROJECT NAME AND LOCATION STATEMENT OF THE PROPERTY OF THE PROPERTY

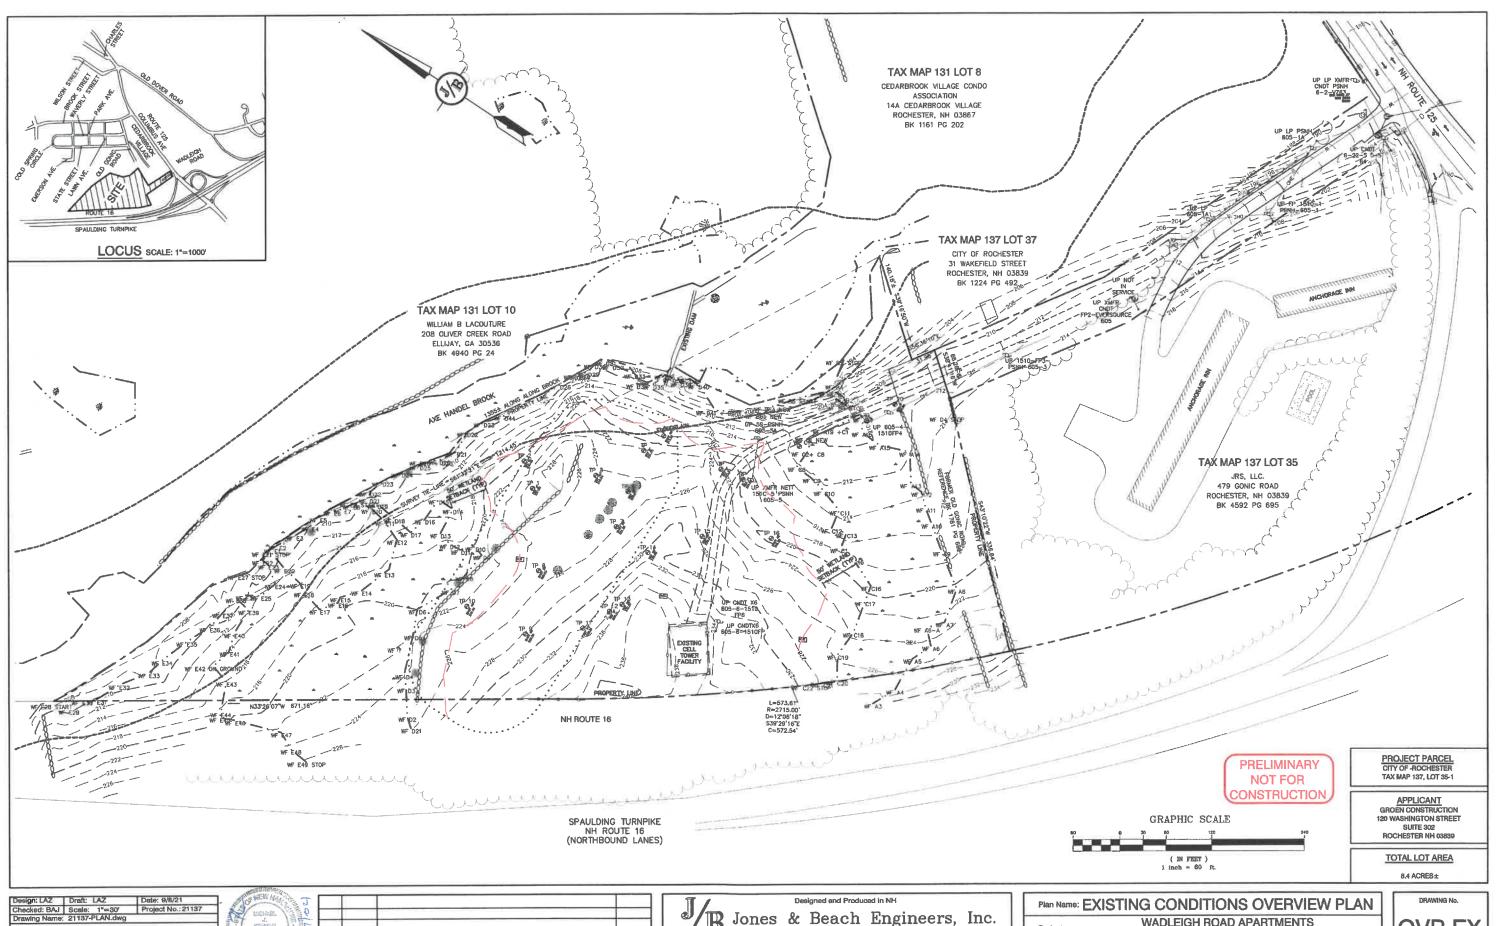


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Jones & Beach Engineers, Inc.

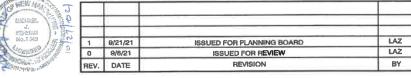85 Portsmouth Ave. Civil Engineering Services
PO Box 219
Stratham, NH 03885
E-MAIL: JBE@ Services FAX: 603-772-0227 E-MAIL: JBE@JONESANDBEACH.COM Project:

WADLEIGH ROAD APARTMENTS ROCHESTER, NH SSG, LLC ATTN: FENTON GROEN
120 WASHINGTON STREET, ROCHESTER, NH 03839 **OVR EX**




ANY ALTERATIONS, AUTHORIZED OR OTHERWISE, SHALL BE IT THE USER'S SOLE RISK AND WITHOUT LIABILITY TO JBE.

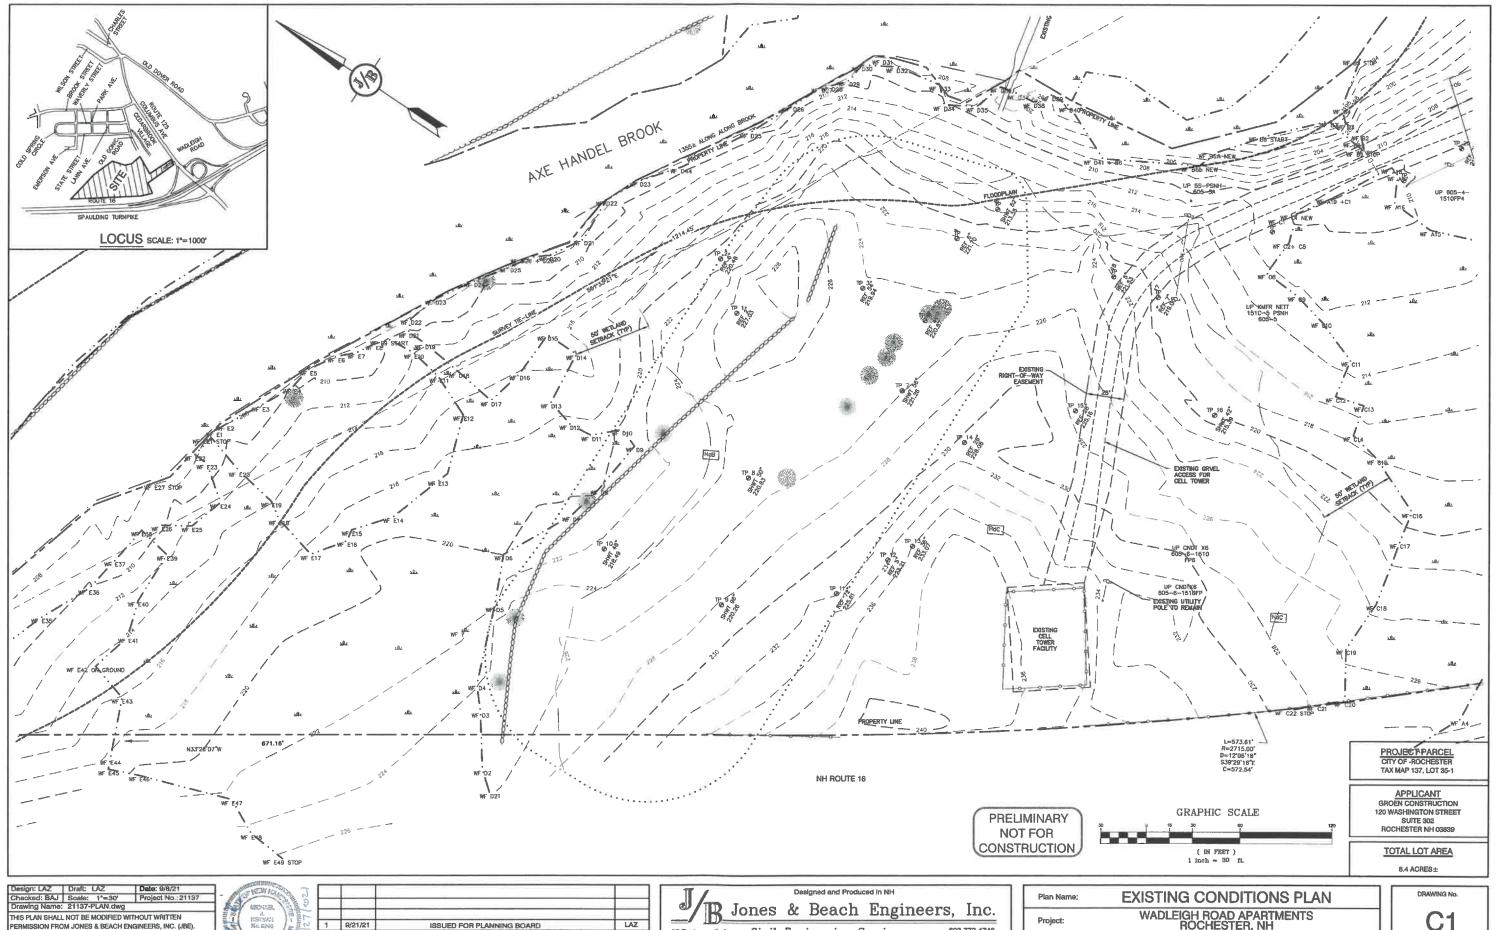LAZ 9/21/21 ISSUED FOR PLANNING BOARD 0 9/8/21 ISSUED FOR REVIEW BY REV. DATE REVISION


B Jones & Beach Engineers, Inc.

Services 603-772-4746 FAX: 603-772-0227 E-MAIL: JBE@JONESANDBEACH.COM 85 Portsmouth Ave. Civil Engineering Services
PO Box 219
Stratham, NH 03886 E-MAIL: JBE@

Plan Name;	EXISTING CONDITIONS PLAN
Project:	WADLEIGH ROAD APARTMENTS ROCHESTER, NH
Owner of Record:	SSG, LLC ATTN: FENTON GROEN 120 WASHINGTON STREET, ROCHESTER, NH 03839

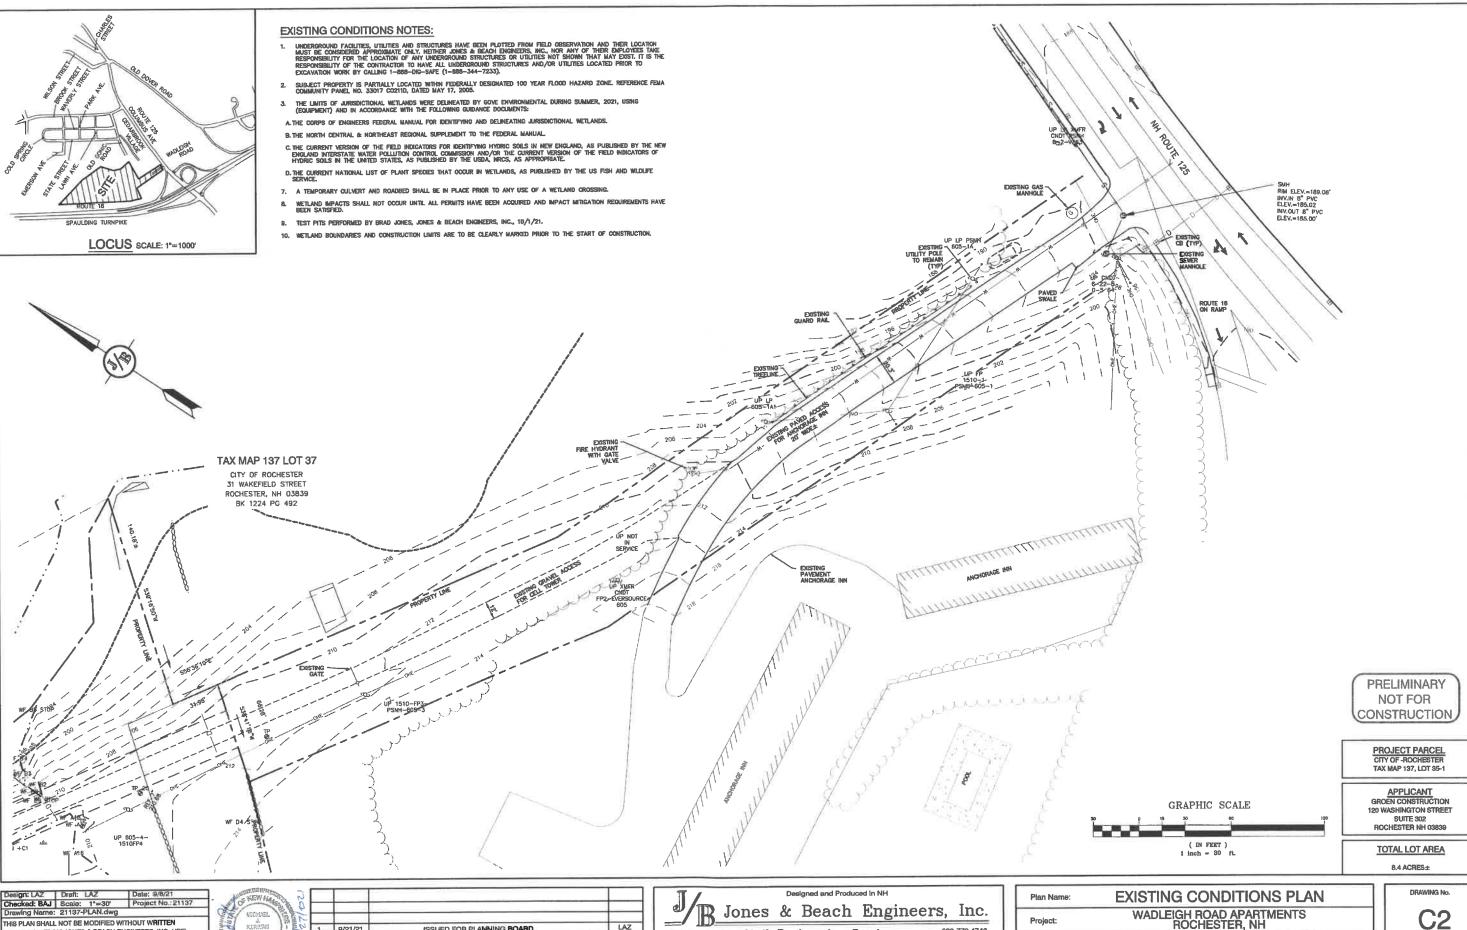

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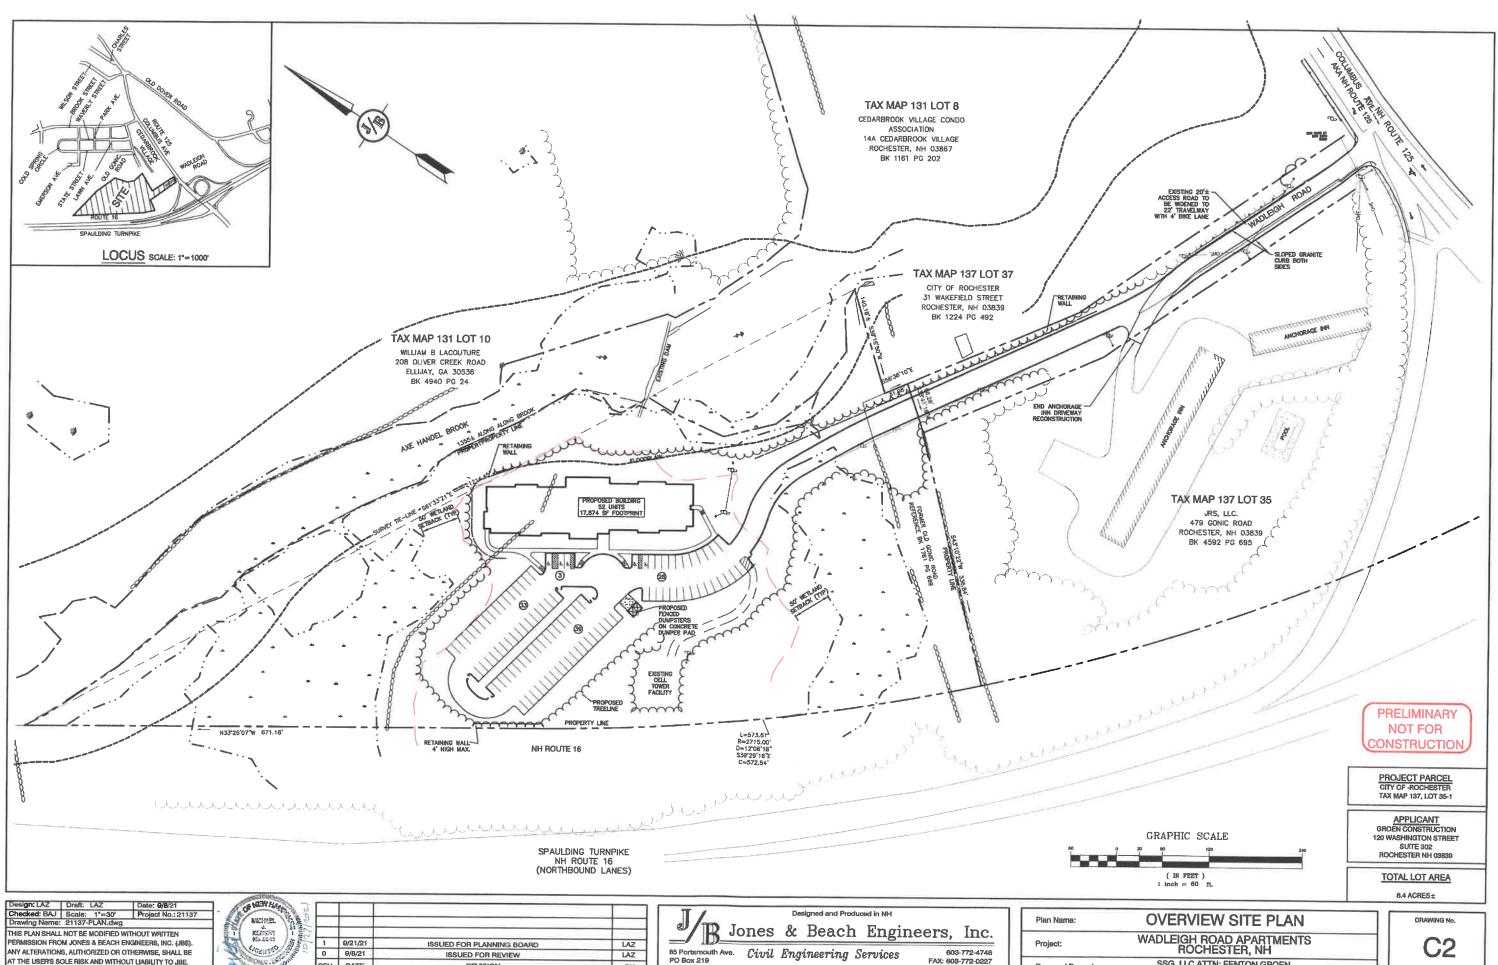
__/ 72-4748 85 Port PO Box Stratha

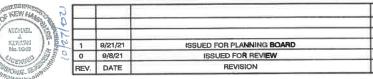rismouth Ave.	Cinnil	Engineering	Samileas	603-772-4746
ox 219	Crou	Enguieer day	Delones	FAX: 603-772-0227
			E-MAIL: JBE@JONESANDBEACH.COM	

LAZ

Plan Name:	EXISTING CONDITIONS PLAN		
Project:	WADLEIGH ROAD APARTMENTS ROCHESTER, NH		
Owner of Record:	SSG, LLC ATTN: FENTON GROEN 120 WASHINGTON STREET, ROCHESTER, NH 03839		

8HEET 4 OF 22 JBE PROJECT NO. 21137



REV. DATE

REVISION


B5 Portsmouth Ave. PO Box 219
Stratham, NH 03885

Civil Engineering Services

E-MAIL: JBE@ Services 603-772-4746 FAX: 608-772-0227 E-MAIL: JBE@JONESANDBEACH.COM Owner of Record:

WADLEIGH ROAD APARTMENTS ROCHESTER, NH SSG, LLC ATTN: FENTON GROEN 120 WASHINGTON STREET, ROCHESTER, NH 03839

SHEET 5 OF 22 JBE PROJECT NO. 21137

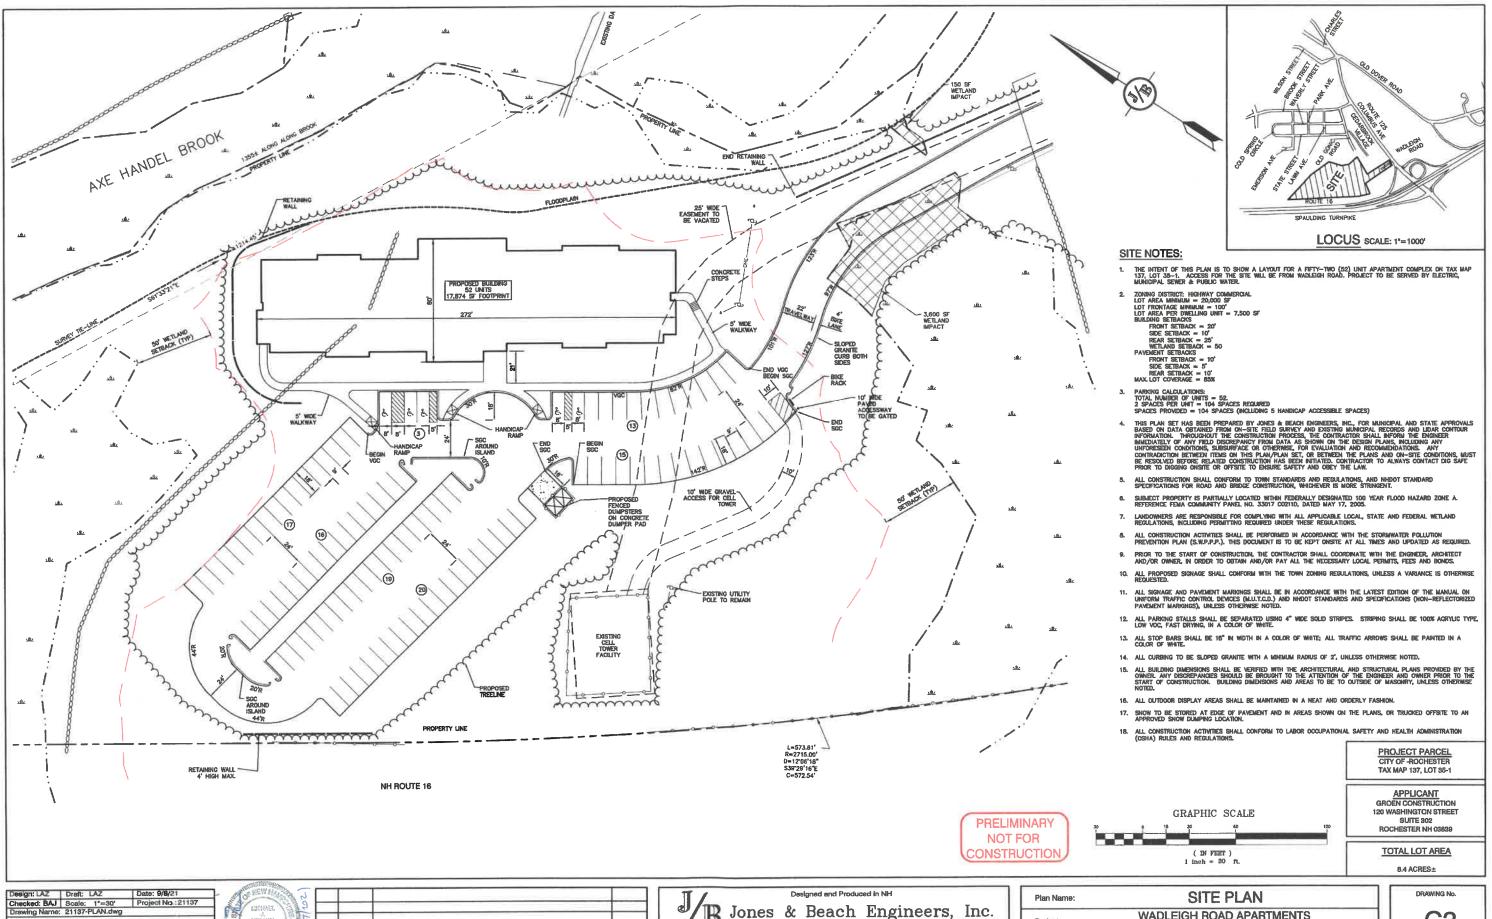

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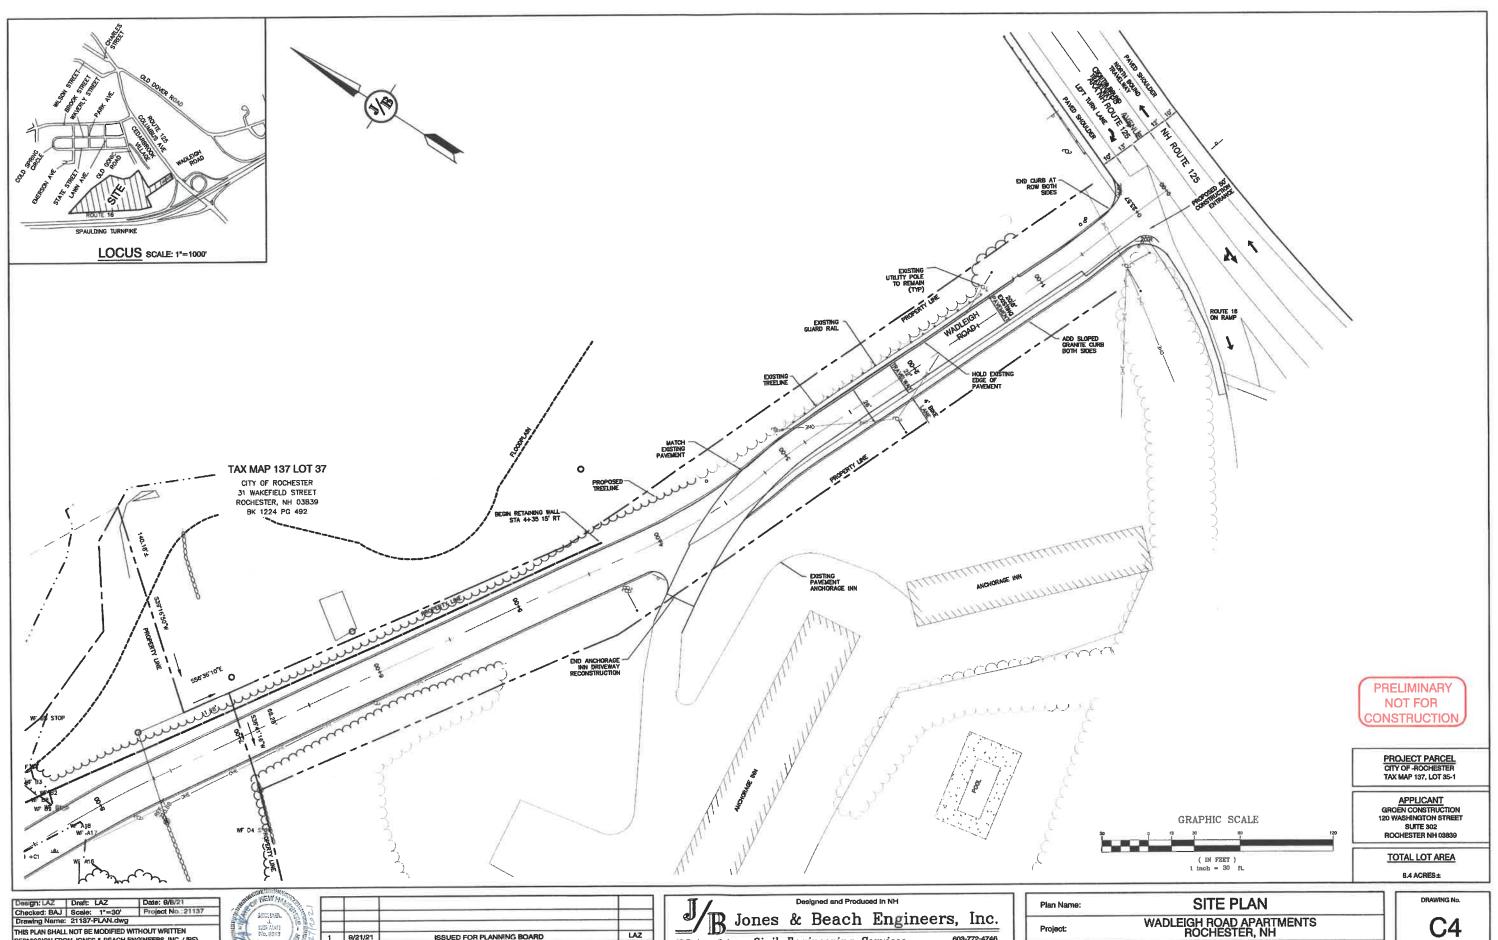
LAZ ISSUED FOR PLANNING BOARD LAZ ISSUED FOR REVIEW BY REVISION

Jones & Beach Engineers, Inc.


86 Portsmouth Ave. Civil Engineering Services FAX: 603-772-0227 E-MAIL: JBE@JONESANDBEACH.COM

Plan Name:	SITE PLAN
Project:	WADLEIGH ROAD APARTMENTS ROCHESTER, NH
Owner of Record:	SSG, LLC ATTN: FENTON GROEN 120 WASHINGTON STREET, ROCHESTER, NH 03839

SHEET 6 OF 22 JBE PROJECT NO. 21137



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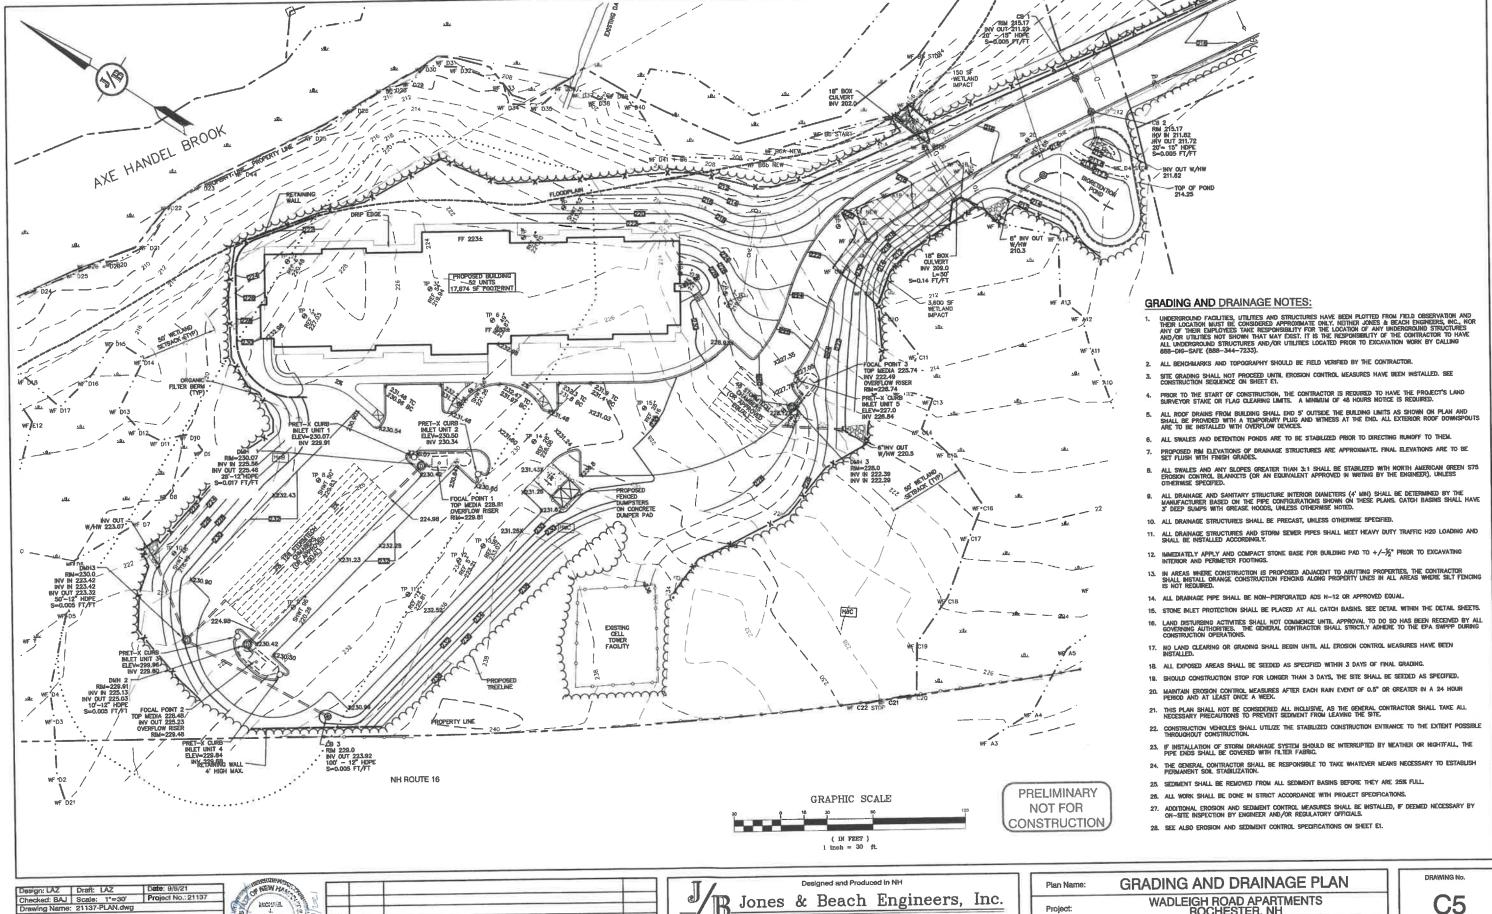
B Jones & Beach Engineers, Inc. Services 603-772-4746 FAX: 603-772-0227 E-MAIL: JBE@JONEBANDBEACH.COM 85 Portsmouth Ave. Civil Engineering Services
PO Box 219
Stratham, NH 03885
E-MAIL: JBE@

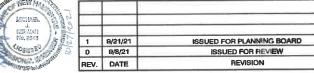LAZ


BY

Plan Name:	SITE PLAN	
Project:	WADLEIGH ROAD APARTMENTS ROCHESTER, NH	
Owner of Record:	SSG, LLC ATTN: FENTON GROEN 120 WASHINGTON STREET, ROCHESTER, NH 03839	

C4 SHEET 7 OF 22 JBE PROJECT NO. 21137



Design: LAZ	Draft: LAZ	Date; 9/8/21
Checked: BAJ	Scale: 1"=30'	Project No.: 21137
Drawing Name:	21137-PLAN.dwg	
PERMISSION FRO		NGINEERS, INC. (JBE).
ANY ALTERATION	IS, AUTHORIZED OR (OTHERWISE, SHALL BE
AT THE USER'S &	OLE RISK AND WITHO	OUT LIABILITY TO JBE.

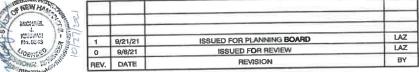


Jones & Beach Engineers, 85 Portsmouth Ave. Civil Engineering Services E-MAIL: JBE@JONESANDBE

inc.	Project:
3-772-4746	T TOJOOI.
3-772-0227 EACH.COM	Owner o

WADLEIGH ROAD APARTMENTS ROCHESTER, NH SSG, LLC ATTN: FENTON GROEN 120 WASHINGTON STREET, ROCHESTER, NH 03839

C5 SHEET 8 OF 22 JBE PROJECT NO. 21137

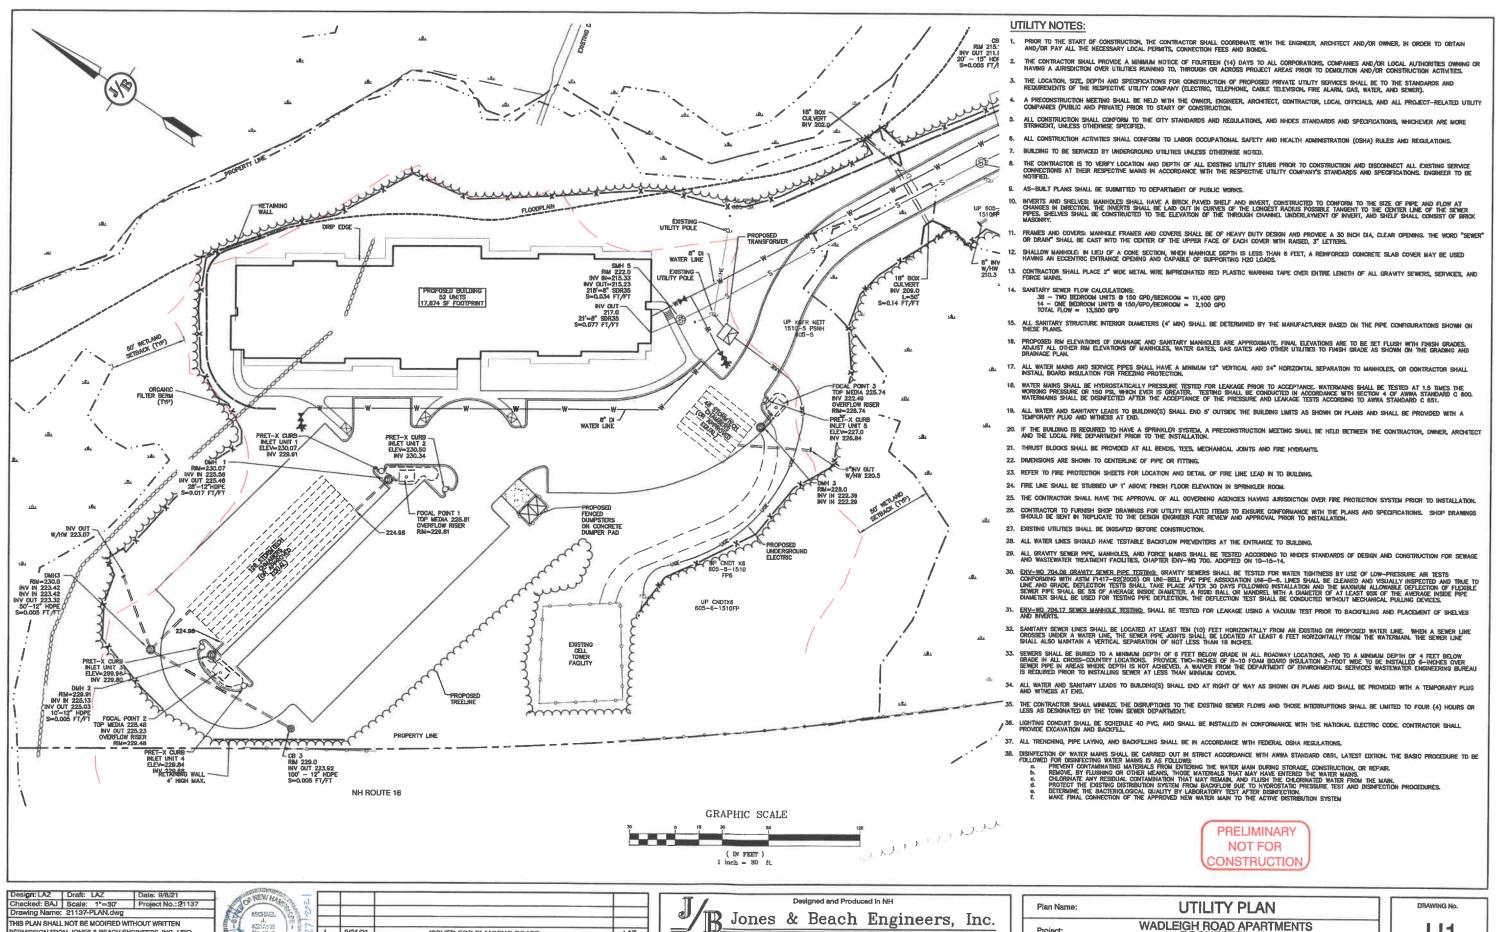

85 Portsmouth Ave. Civil Engineering Services

LAZ

LAZ

BY

PO Box 219

THIS PLAN SHALL NOT BE MODIFIED WITHOUT WRITTEN

PERMISSION FROM JONES & BEACH ENGINEERS, INC. (JBE).

ANY ALTERATIONS, AUTHORIZED OR OTHERWISE, SHALL BE

AT THE USER'S SOLE RISK AND WITHOUT LIABILITY TO JBE.

1 9/21/21

0 9/8/21

REV. DATE

ISSUED FOR PLANNING BOARD

ISSUED FOR REVIEW

REVISION

WADLEIGH ROAD APARTMENTS ROCHESTER, NH


SSG, LLC ATTN: FENTON GROEN

120 WASHINGTON STREET, ROCHESTER, NH 03839

Project:

FAX: 603-772-0227

E-MAIL: JBE@JONESANDBEACH.COM

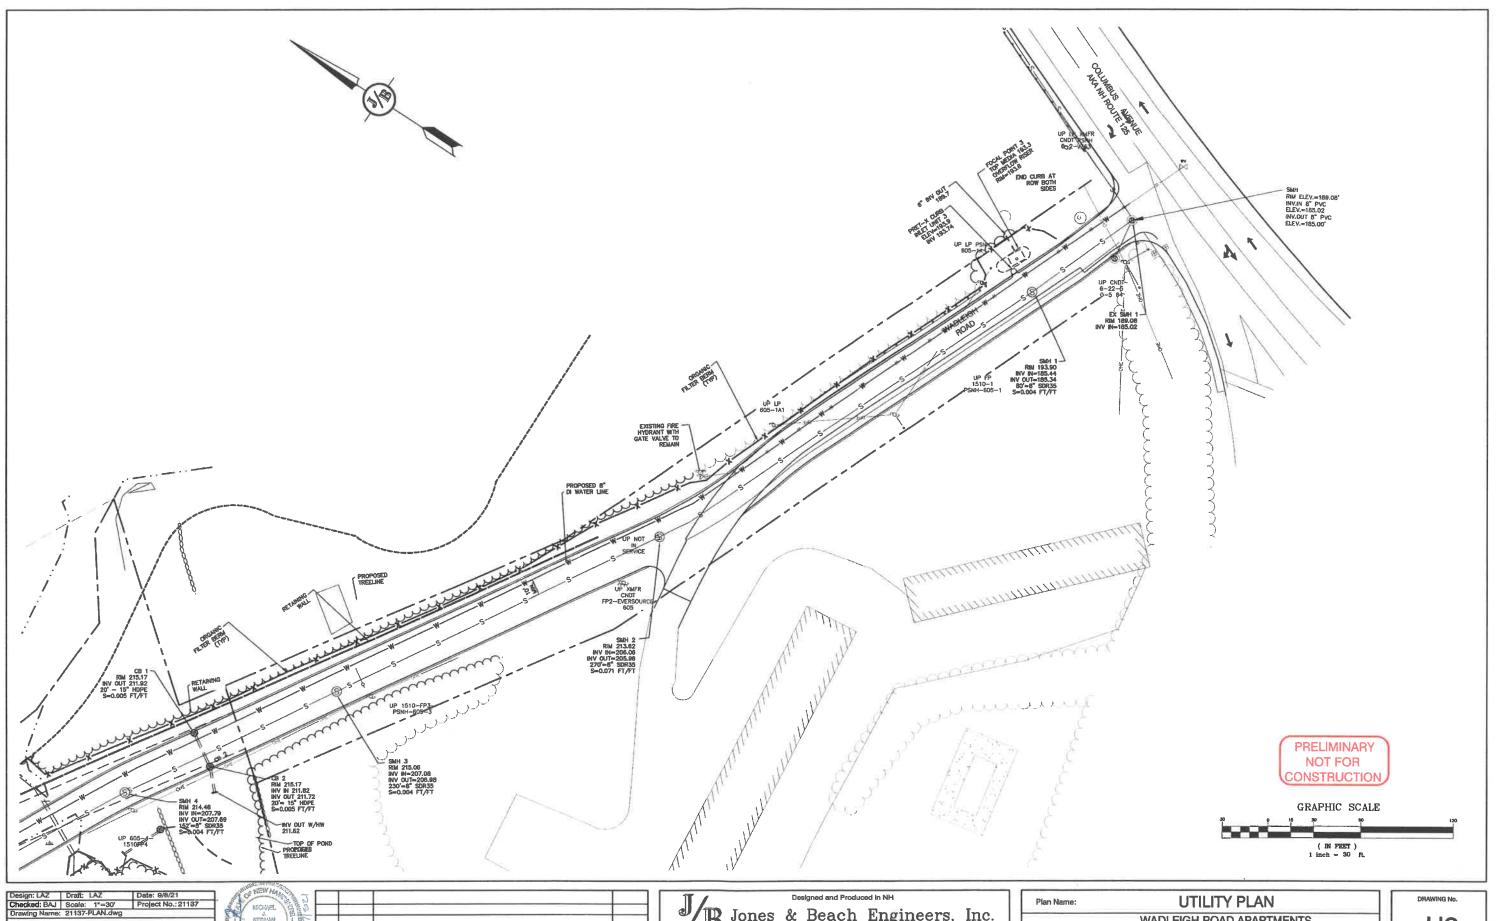

THIS PLAN SHALL NOT BE MODIFIED WITHOUT WRITTEN
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ISSUED FOR PLANNING BOARD ISSUED FOR REVIEW LAZ 1 9/21/21 0 9/8/21 REV. DATE LAZ BY REVISION


B Jones & Beach Engineers, Inc.

Services 603-772-4746 FAX: 603-772-0227 E-MAIL: JBE@JONESANDBEACH.COM 85 Portsmouth Ave. PO Box 219
Strettham, NH 03885

E-MAIL: JBE@

Plan Name:	UTILITY PLAN
Project:	WADLEIGH ROAD APARTMENTS ROCHESTER, NH
Owner of Record:	SSG, LLC ATTN: FENTON GROEN 120 WASHINGTON STREET, ROCHESTER, NH 03839



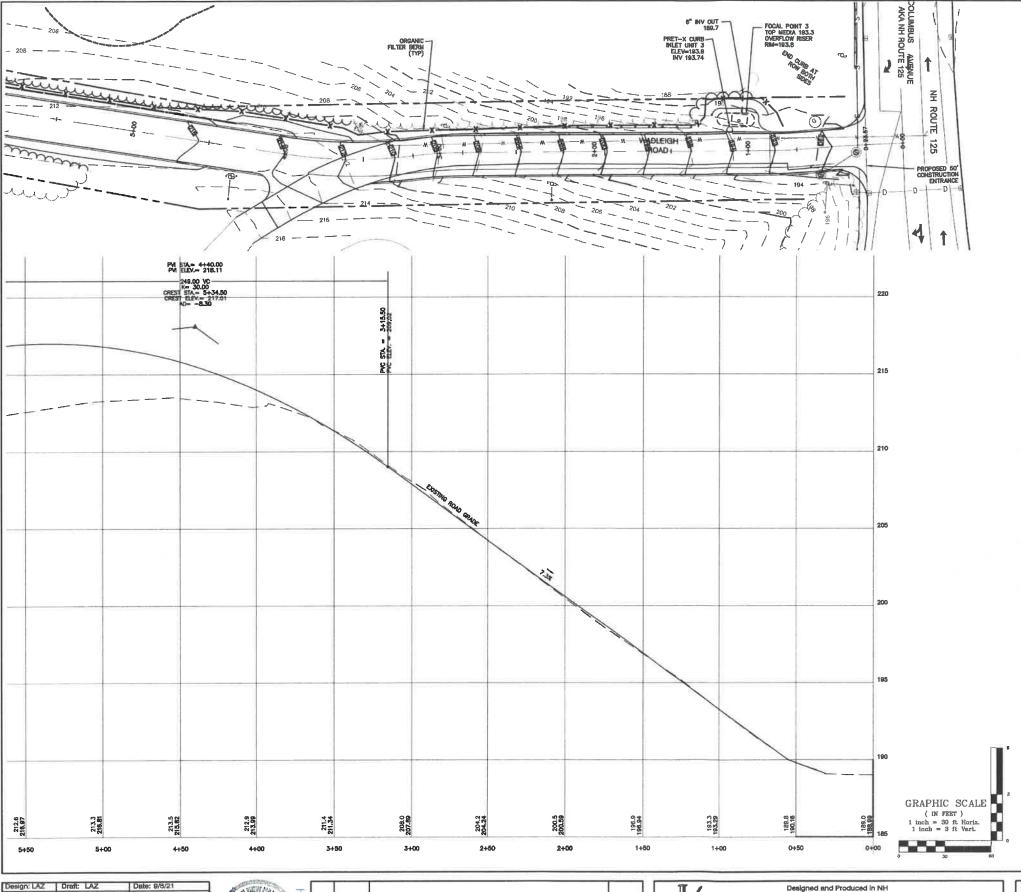

NOTES:

1. THIS STIE WILL REQUIRE A USEPA NPDES PERMIT FOR STORMWATER DISCHARGE FOR THE CONSTRUCTION STIE. THE CONSTRUCTION STIE. OPERATOR SHALL DEVELOP AND IMPERIENT A CONSTRUCTION STORM WATER POLLUTION PREVENTION PLAN (SWPPP), WHICH SHALL REMAN ON STIE AND BE MADE ACCESSIBLE TO THE PUBLIC THE CONSTRUCTION STIE OPERATOR SHALL SLIBMIT A HORICE OF INTENT (NO!) TO THE EPA REGIONAL OFFICE SEVEN DAYS PRIOR TO COMMENCEMENT OF ANY WORK ON STIE. DPA WILL POST THE NOW AT HTTE-//CPUBLE PLACOV/NDDES/STORMWATER/NO/MOSEARCH-OFM. AUTHORISMON IS GRANTED UNDER THE PREMIT ONCE THE NO! IS SHOWN IN "ACTIVE" STATUS ON THIS WEBSTIE. A COMPLETED NOTICE OF TERMINATION SHALL BE SUBMITTED TO THE NPOES PERMITTING AUTHORITY WITHIN 30 DAYS AFTER THERE OF THE FOLLOWING CONDITIONS HAVE BEEN MET:

A. PRIAL STABILIZATION HAS BEEN ACHIEVED ON ALL PORTIONS OF THE STE FOR WHICH THE PERMITTEE IS RESPONSIBLE;

ON THE NOTHER OPERATOR/PERMITTEE HAS ASSUMED CONTROL OVER ALL AREAS OF THE STE THAT HAVE NOT BEEN FINALLY STABILIZED. PROVIDE DPW WITH A COPY OF THE NOTICE OF TERMINATION (NOT).

- ALL ROAD AND DRAINAGE WORK SHALL BE CONSTRUCTED IN ACCORDANCE WITH THE STANDARD SPECIFICATIONS FOR THE CITY, AND N-HDOT SPECIFICATIONS FOR ROAD AND BRIDGE CONSTRUCTION, WHICHEVER IS MORE STRINGENT.
- DEVELOPER IS RESPONSIBLE FOR COMPLYING WITH ALL APPLICABLE LOCAL, STATE AND FEDERAL WETLAND REBULATIONS, INCLUDING ANY PERMITTING AND SETBACK REQUIREMENTS REQUIRED UNDER THESE REQUILATIONS.
- CONTRACTOR TO COORDINATE AND COMPLETE ALL WORK REQUIRED FOR THE RELOCATION AND/OR INSTALLATION OF ELECTRIC, CATV, TELEPHONE, AND FIRE ALARM PER UTILITY DESIGN AND STANDARDS, LOCATIONS SHOWN ARE APPROXIMATE. LOW PROFILE STRUCTURES SHALL BE USED TO THE GREATEST EXTENT POSSIBLE.
- 5. THIS PLAN HAS BEEN PREPARED BY JONES & BEACH ENGINEERS, INC. FOR MUNICIPAL AND STATE APPROVALS AND FOR CONSTRUCTION BASED ON DATA OBTAINED FROM ON-SITE FIELD SURVEY AND EXISTING MUNICIPAL RECORDS. THROUGHOUT THE CONSTRUCTION PROCESS, THE CONTRACTOR SHALL NEFORM THE ENGINEER INMEDIATELY OF MULTIPLED DISCORPENCY FROM DATA SHOWN ON THE DESIGN PLANS. THIS INCLUDES ANY UNFORESEEN CONDITIONS, SUBSURFACE OR OTHERWISE, FOR EVALUATION AND RECOMMENDATIONS. ANY CONTRADICTION BETWEEN TEUS OF THIS PLAN/PLAN SET, OR BETWEEN THE PLANS AND ON-SITE CONSTRUCTION HAS BEEN INITIATED.
- SILITATION AND EROSION CONTROLS SHALL BE INSTALLED PRIOR TO CONSTRUCTION, SHALL BE MAINTAINED DURING CONSTRUCTION AND SHALL REMAIN UNTIL SITE HAS BEEN STABILIZED WITH PERMANENT VEGETATION. SEE DETAIL SHEET ET FOR ADDITIONAL NOTES ON EROSION CONTROL.
- ALL DISTURBED AREAS NOT STABILIZED BY NOVEMBER 1st SHALL BE COVERED WITH AN EROSION CONTROL BLANKET. PRODUCT TO BE SPECIFIED BY THE ENGINEER.
- 8. FINAL DRAINAGE, GRADING AND EROSION PROTECTION MEASURES SHALL CONFORM TO REGULATIONS OF THE PUBLIC WORKS DEPARTMENT.
- 9. CONTRACTOR TO VERIFY EXISTING UTILITIES AND TO NOTIFY ENGINEER OF ANY DISCREPANCY IMMEDIATELY.
- 10. ROADWAY INTERSECTIONS WITH SLOPE GRANITE CURB SHALL EXTEND AROUND RADIUS WITH 6' STRAIGHT PIECE ALONG TANGENT.
- 11. RETAINING WALLS SHALL BE DESIGNED AND STAMPED BY A LICENSED PROFESSIONAL ENGINEER. CONTRACTOR SHALL COORDINATE WITH MANUFACTURER PRIOR TO INSTALLATION.
- 12. 8" PERFORATED ADS UNDER DRAIN PLACEMENT TO BE DETERMINED BY THE ENGINEER DURING TIME OF SUBGRADE (INSPECTION CONTRACTOR TO ADJUST LOCATION BI THE FELD ONLY WITH PRIOR APPROVAL OF PROJECT ENGINEER OR PUBLIC WORKS DEPARTMENT, CONTRACTOR TO INCLUDE 3000 LF in 80 PRICE.
- 13. ENGINEER TO RISTALL PERMANENT BENCHMARK (REINFORCED GRANITE MARKER) AT LOCATIONS SHOWN ON PLANS. BENCH MARKS TO BE TIED TO STATE PLANE COORDINATE SYSTEM.
- 14. DRAINAGE RISPECTION AND MAINTENANCE SCHEDULE: SILT FENCING WILL BE RISPECTED DURING AND AFTER STORM EVENTS TO ENSURE THAT THE FENCE STILL HAS INTEGRITY AND IS NOT ALLOWING SEDMENT TO PASS, SEDMENT BUILD UP IN SWALES MILL BE RELOWED IF IT IS DEFERED THAN SK INCHES, AND IS TO BE REMOVED FROM SHAMES BELOW THEAT OF CLLVETTS SEDMENHALLY, AS WELL AS FROM CATCH BASINS, FOLLOWING MAJOR STORM EVENTS, THE STACE DISCHARGE OUTLET STRUCTURES ARE TO BE RISPECTED AND ANY DEBRIS REMOVED FROM THE ORPICE, TRASH TRACK AND EMERGENCY SPILL WAY, IMPREDUENTLY, SEDMENT MAY ALSO HAVE TO BE REMOVED FROM THE ORPICE, TRASH TRACK AND EMERGENCY SPILL WAY, IMPREDUENTLY, SEDMENT
- 15. ALL DRAINAGE INFRASTRUCTURE SHALL BE INSTALLED AND STABILIZED PRIOR TO DIRECTING ANY RUNOFF TO IT.
- 16. DETENTION PONDS REQUIRE THELTY MANTENANCE AND SHOULD BE INSPECTED AFTER EVERY MAJOR STORM EVENT, AS WELL AS FREQUENTLY DURRIG THE FIRST YEAR OF OFERATION, AND ANNUALLY THEREAFTER, EVERY FIVE YEARS, THE SERVICES OF A PROFESSIONAL ENGINEER SHOULD BE RETAINED TO PERFORM A THOROUGH ANSPECTION OF THE DETENTION POND AND ITS INFRASTRUCTURE. ANY DEBRIS AND SEDMENT ACCUMULATIONS SHOULD BE REMOVED FROM THE OUTLET STRUCTURE(S) AND DEPRESED OF PROPERLY, DETENTION FOND BERMS AND ED MORE AND A LEAST ONCE ANNUALLY SO AS TO PREVENT THE STABLISHABITY OF WOODLY VOESTATION. THESE SHOULD BE WERE ALLOWED TO GROW ON A DETENTION FOND BERMS, AS THEY MAY DESTABLISHABITY OF WOODLY VOESTATION. THESE SHOULD BE WERE TO PREVENT AND SHOWN OF THE OF THE STRUCTURE AND INCREASE THE POTENTIAL FOR FALLINE, AREAS SHOWNED SIGNS OF DRIVEN ON OF THIS OF DEBRO OF DEBRO OF THE STRUCTURE AND INCREASE THE POTENTIAL FOR FALLINE, AREAS SHOWNED SIGNS OF DRIVEN OF THE PROBLEM PERSISTS.
- 17. THE DETENTION PONDS ARE TO BE CONSTRUCTED PRIMARILY THROUGH EXCAVATION. IN THOSE AREAS WHERE THE BERMS MUST BE CONSTRUCTED BY THE PLACEMENT OF FILL. THE ENTIRE EMBANGMENT AREA OF THE DETENTION PONDS SHALL BE EXCAVATED TO PROPOSED GRADE, STRIPPED FOR ALL ORGANIC MATERIALS, COMPACTED TO AT LEAST 1958 AND CARRIED PRIOR TO THE PLACEMENT OF THE EMBANGMENT MATERIAL. IN THE EVENT THE FOUNDATION MATERIAL EXPOSED DOES NOT ALLOW THE SPECIFIED COMPACTION, AN ADDITIONAL CHEFOOT (1) OF EXCAVATION AND THE PLACEMENT OF A QUE OT (1) THICK, THELVE FOOT (12) WIDE PAID OF THE MATERIAL DESCRIBED IN THE NOTE BELOW, COMPACTED TO 95% OF ASTAID 0-1557 MAY BE NECESSARY, PLACEMENT AND COMPACTION STOLD COCUR AT A MOSTUME CONTENT OF OPTIMUM PLUS OR MINUS 3%, AND NO FROZEN OR ORGANIC MATERIAL SHOULD BE PLACED WITHIN FOR ANY REASON.
- 18. EMBANKMENT MATERIAL FOR THE BERNS SHALL BE CLEAN MINERAL SOR. WITH A CLAY COMPONENT FREE OF ROOTS, ORGANIC MATTER, AND OTHER DELETERIOUS SUBSTANCES, AND SHALL CONTAIN NO ROCKS OR UMPS OVER FOUR INCHES (4") IN DIAMETER. THIS MATERIAL SHOULD BE INSTALLED IN 0" UTST AND COMPACTED TO 98% OR ASTIM D-1507, AND SHOULD MEET THE FOLLOWING SPECIFICATIONS: 4" PASSING 100%, \$4 SIEVE 25-70%, \$200 SIEVE 10-29% (M TOTAL SAMPLE).
- 19. EMBANKMENT IS TO HAVE 3:1 SIDE SLOPES (MAX.) AND IS TO BE BROUGHT TO SPECIFED GRADES PRIOR TO THE ADDITION OF LOAM (4" MINIMUM) SO AS TO ALLOW FOR THE COMPACTION OF THE STRUCTURE OVER TIME WHILE MAINTAINING THE PROPER BERM ELEVATION.
- 20. COMPACTION TESTING SERVICES (I.E. NUCLEAR DENSITY TESTS) ARE TO BE PERFORMED BY AN INDEPENDENT GEOTECHNICAL ENGINEER RETAINED BY THE CONTRACTOR FOR ROADWAY CONSTRUCTION, AND ON THE FOUNDATION OF THE BERM AND ON EVERY LIFT OF NEWLY PLACED MATERIAL.

PRELIMINARY NOT FOR CONSTRUCTION

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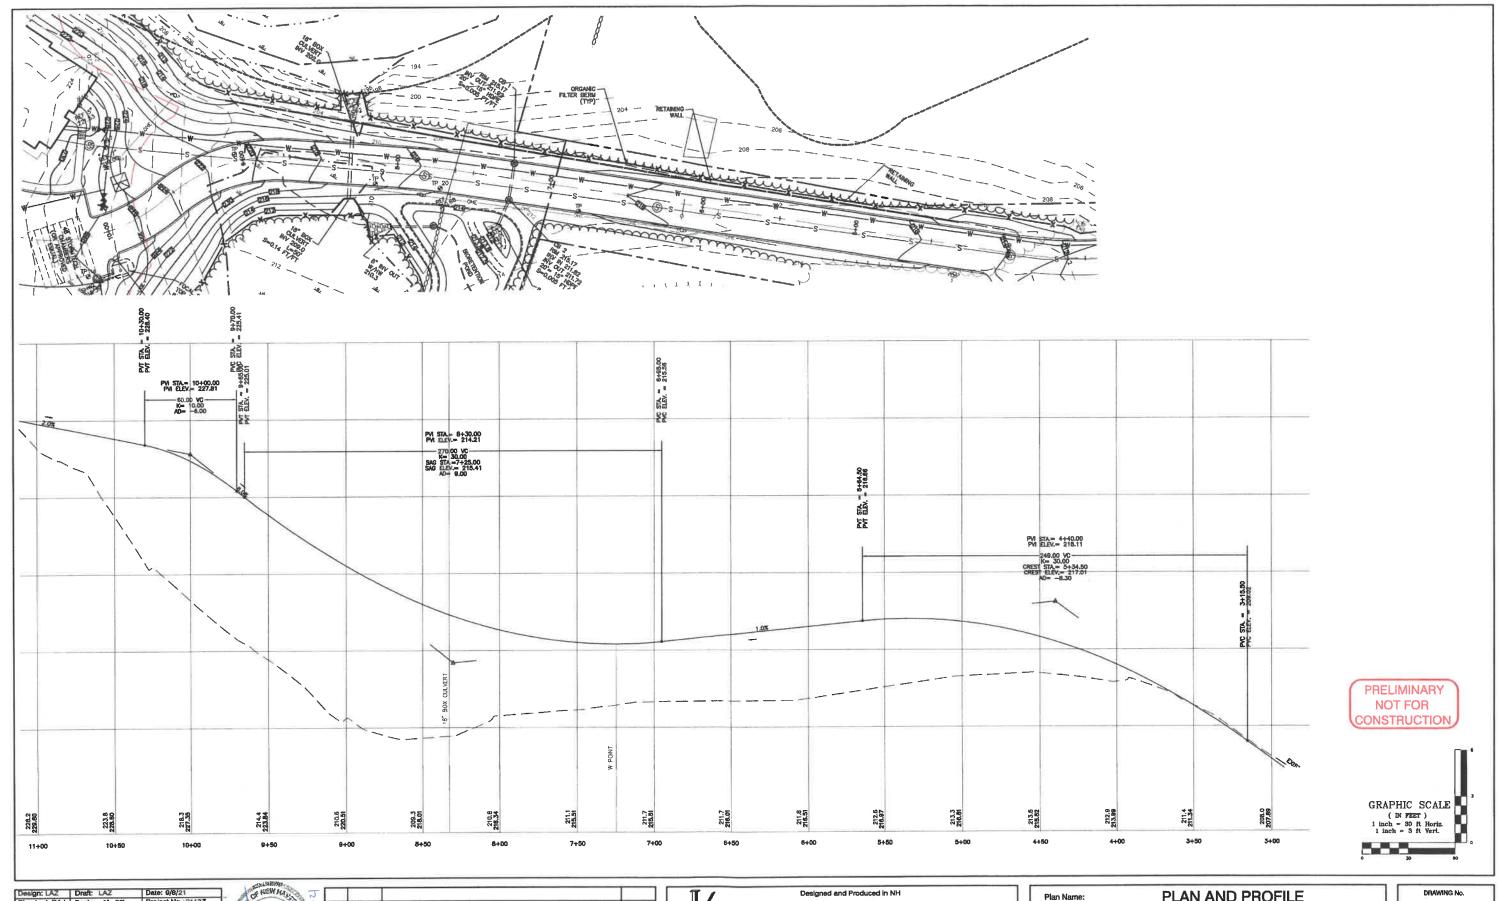
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FAX: 603-772-0227


85 Partsmouth Ave. Civil Engineering Services PO Box 219 E-MAIL: JBE@JONESANDBEACH.COM

Plan Name:	PLAN AND PROFILE
Project:	WADLEIGH ROAD APARTMENTS ROCHESTER, NH
Owner of Record:	SSG, LLC ATTN: FENTON GROEN 120 WASHINGTON STREET, ROCHESTER, NH 03839

DRAWING No




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	Jones	&	Beach	Engin	eers,	Inc.
85 Portsmouth A PO Box 219	ve. Civil	Eng	ineering !	Services		-772-4746 -772-0227

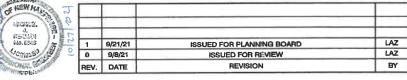Plan Name:	PLAN AND PROFILE	
Project:	WADLEIGH ROAD APARTMENTS ROCHESTER, NH	
Owner of Record:	SSG, LLC ATTN: FENTON GROEN 120 WASHINGTON STREET, ROCHESTER, NH 03839	

DRAWING No.
P2
SHEET 12 OF 22
JBE PROJECT NO.21137



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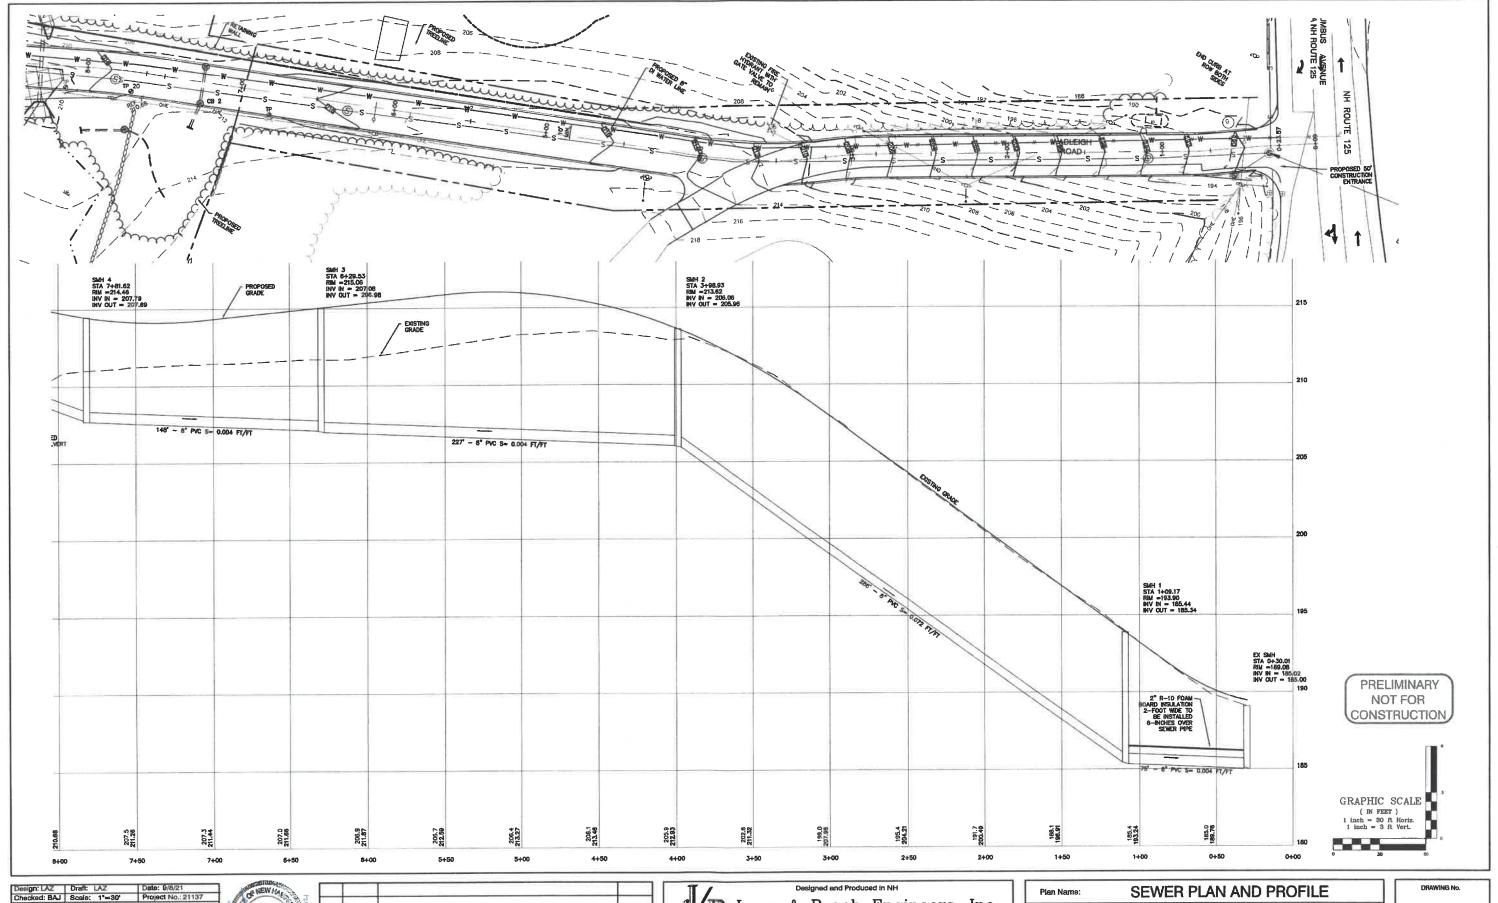
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Beach Engineers, Inc.

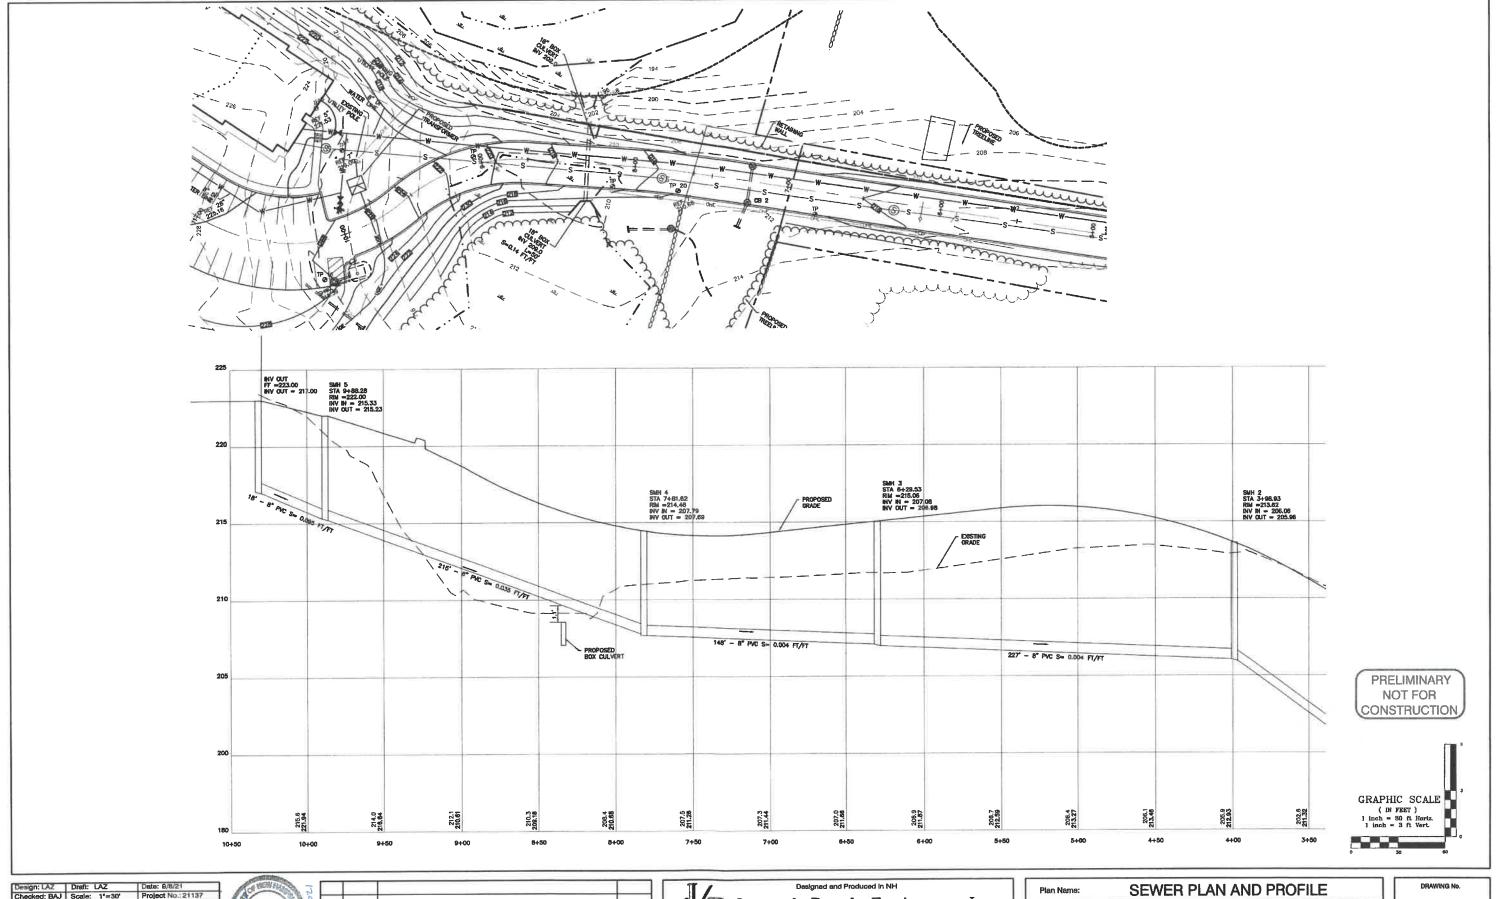603-772-4748
FAX: 803-772-0227
E-MAIL: JBE@JONESANDBEACH.COM

Plan Name:	SEWER PLAN AND PROFILE
Project:	WADLEIGH ROAD APARTMENTS ROCHESTER, NH
Owner of Record:	SSG, LLC ATTN: FENTON GROEN 120 WASHINGTON STREET, ROCHESTER, NH 03839

P3
SHEET 18 OF 22
JBE PROJECT NO. 21137



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Designed and Produced in NH

Jones & Beach Engineers, Inc.

85 Portsmouth Ave.
PO Box 219
Stratham, NH 03885

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Engineers, Inc.

603-772-4746
FAX: 603-772-0227
E-MAIL: JBE@JONESANDBEACH.COM


Plan Name:	SEWER PLAN AND PROFILE
Project:	WADLEIGH ROAD APARTMENTS ROCHESTER, NH
Owner of Record:	SSG, LLC ATTN: FENTON GROEN 120 WASHINGTON STREET, ROCHESTER, NH 03839

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P4

SHEET 14 OF 22

JBE PROJECT NO. 21137

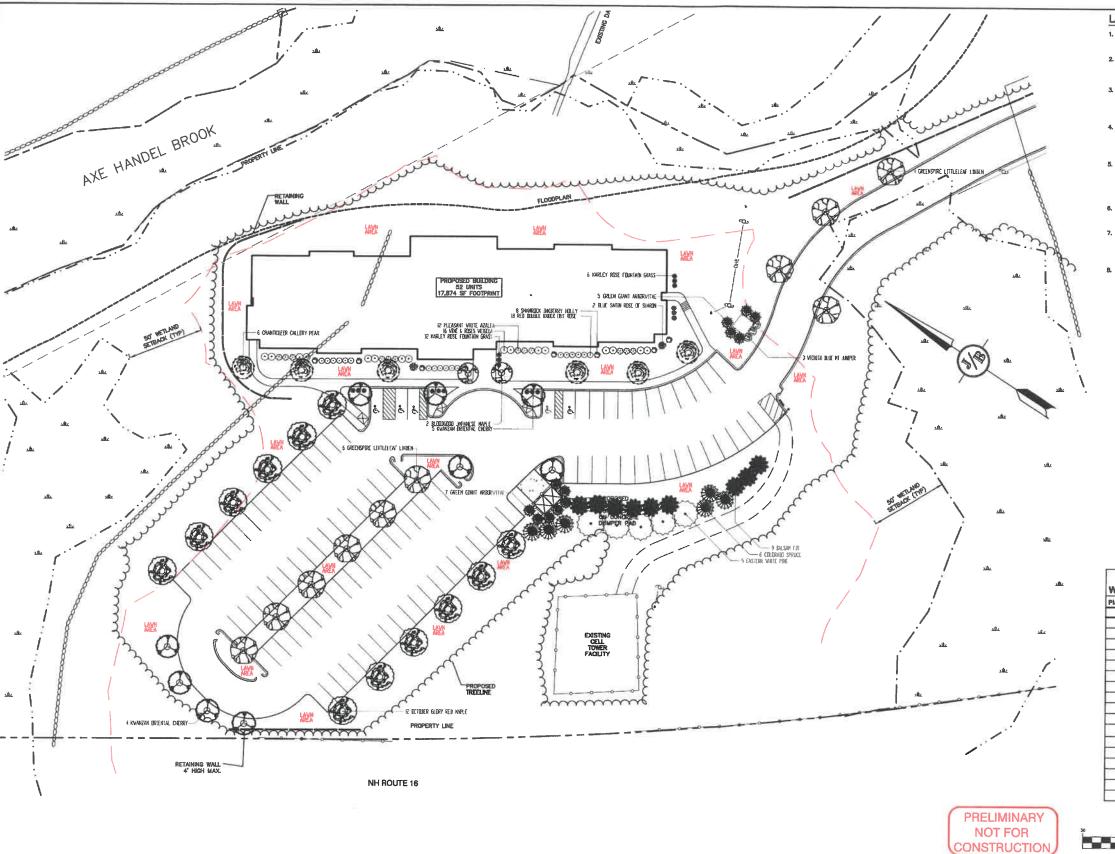


LANDSCAPE NOTES:

- THE CONTRACTOR SHALL LOCATE AND VERIFY THE EXISTENCE OF ALL UTILITIES PRIOR TO STARTING WORK.
- ALL MATERIAL SHALL CONFORM TO THE GUIDELINES ESTABLISHED BY THE CURRENT AMERICAN STANDARD FOR NURSERY STOCK PUBLISHED BY THE AMERICAN ASSOCIATION OF NURSERYMEN.
- PLANTS SHALL BE SUBJECT TO INSPECTION AND APPROVAL AT THE PLACE OF GROWTH, UPON DELIVERY OR AT THE JOB SITE WHILE WORK IS ON-CONG FOR CONFORMITY TO SPECIFIED CUALITY, SIZE AND VARIETY.

- ALL PLANTS SHALL BE WATERED THOROUGHLY TWICE DURING THE FIRST 24—HOUR PERIOD AFTER PLANTING. ALL PLANTS SHALL BE WATERED WEEKLY, OR MORE OFTEN IF NECESSARY, DURING THE FIRST GROWING SEASON.

- ALL LANDSCAPE AREAS TO BE GRASS COMMON TO REGION, EXCEPT FOR INTERIOR LANDSCAPED ISLANDS OR WHERE OTHER PLANT MATERIAL IS SPECIFIED.
- ALL TREES AND SHRUBS SHALL BE PLANTED IN MULCH BEDS WITH EDGE STRIPS TO SEPARATE TURF GRASS AREAS.
- 11. THE CONTRACTOR SHALL REMOVE WEEDS, ROCKS, CONSTRUCTION ITEMS, ETC. FROM ANY LANDSCAPE AREA SO DESIGNATED TO REMAIN, WHETHER ON OR OFF-STEL GRASS SEED OR PRE BARK MULCH SHALL BE APPLIED AS DEPICTED ON PLANS.
- 12. ALL LANDSCAPING SHALL MEET THE TOWN STANDARDS AND REGULATIONS.
- ALL LANDSCAPED AREAS SHALL HAVE SELECT MATERIALS REMOVED TO A DEPTH OF AT LEAST PS BELOW RINSH GRADE. THE RESULTING VOID IS TO BE FILLED WITH A MINIMUM OF 9" HIGH-GULLITY SCREENED LOAM AMENDED WITH 3" OF AGED GREANIC COMPOST.
- THIS PLAN IS INTERBED FOR LANDSCAPING PURPOSES ONLY. REFER TO CIVIL/SITE DRAW FOR OTHER SITE CONSTRUCTION INFORMATION.

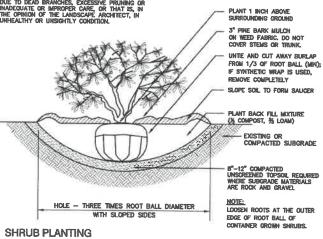

NOT TO SCALE

Plants			
Quantity	Sottenical Hame	Common Name	Sire
9	Abies balsames	BALSAM FIR	8-10 FT, HT.
2	Azer pelmatum 'Bloodgood'	BLOODGOOD JAPANESE MAPLE	15 GALLON
12	Acer rubrum 'October Glory'	OCTOBER GLORY RED MAPLE	3" CALIPER
3	Juniperus scopulorum Wichite Eliue'	WICHITA BLUE MT JUNIPER	7-8 FT. HT.
6	Pices pungens	COLORADO SPRUCE	8-10 FT, HT.
5	Pinus strobus	EASTERN WHITE PINE	10-12 FT, HT,
9	Prunus serrutata 'Kwanzan'	KWANZAN ORIENTAL CHERRY	2.5" CALIPER
6	Pyrus celleryana 'Charticlear'	CHANTICLEER CALLERY PEAR	2.5" CALIPER
12	Thuis plicate 'Green Glant'	GREEN GIANT ARBORVITAE	7-8 FT, HT,
10	Titis conteta 'Greenspire'	GREENSPIRE LITTLELEAF LINDEN	3 CAUPER
12	Azalea 'Pleasant Wivis'	PLEASANT WHITE AZALEA	3 GALLON
2	Hibiscus syriacus 'DVPszum'	BLUE SATIN ROSE OF SHARON	5 GALLON
В	Nex glatra 'Shamrock'	SHAMROCK INKBERRY HOLLY	5 GALLON
18	Pennisetum orientale 'Karley Rose'	KARLEY ROSE FOUNTAIN GRASS	2 GALLON
18	Ross 'Red Double Knock Out'	RED DOUBLE KNOCK OUT ROSE	3 GALLON
16	Weigela florida 'Alexandra'	WINE & ROSES WEIGELA	5 GALLON

GRAPHIC SCALE (IN FEET) 1 inch = 30 ft.

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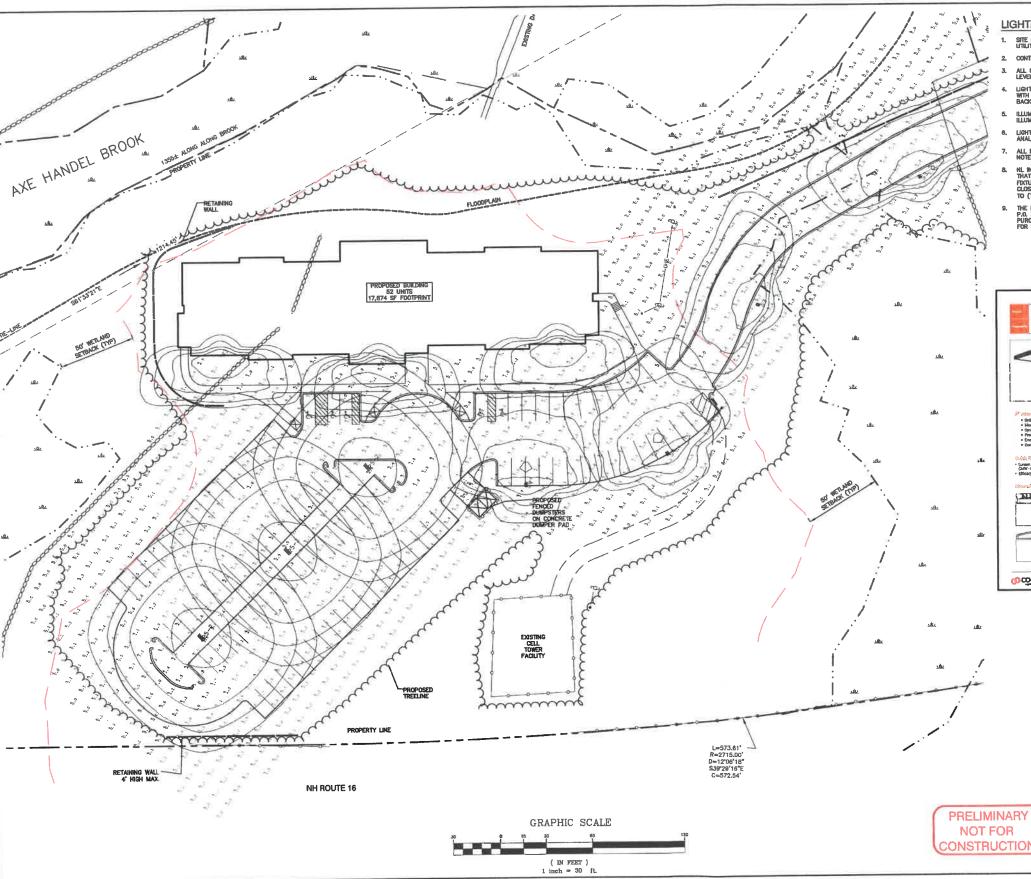
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85 Portsmouth Ave. Civil Engineering Services 603-772-4746 FAX: 603-772-0227 E-MAIL: JBE@JONESANDBEACH.COM

Plan Name:	LANDSCAPE PLAN	
Project:	WADLEIGH ROAD APARTMENTS ROCHESTER, NH	
Owner of Record:	SSG, LLC ATTN: FENTON GROEN 120 WASHINGTON STREET, ROCHESTER, NH 03839	

SHEET 15 OF 22 JBE PROJECT NO. 21137



LIGHTING AND ELECTRICAL NOTES:

- SITE ELECTRICAL CONTRACTOR SHALL COORDBIATE LOCATION OF EASEMENTS, UNDERGROUND LITELITIES AND DRAMAGE BEFORE DRILLING POLE BASES.
- CONTRACTOR SHALL INSTALL PROPOSED LIGHT POLES ACCORDING TO TOWN REGULATIONS.
- ALL OUTDOOR LIGHTING PROTEINS SHALL BE EXHEDED WITH TRIEDS TO DETRICE HALLMINATI
- LIGHTING CONDUIT SHALL BE SCHEDULE 40 PVC, AND SHALL BE INSTALLED IN CONFORMANCE WITH THE INTIONAL ELECTRICAL CODE. CONTRACTOR SHALL PROVIDE EXCAVATION AND PAYOR I.
- 5. ILLUMINATION READINGS SHOWN ARE BASED ON A TOTAL LLF OF 0.75 AT GRADE.
- 6. LIGHTING CALCULATIONS SHOWN ARE NOT A SUBSTITUTE FOR INDEPENDENT ENGINEERING
- ALL LIGHTING FIXTURES SHALL BE FULL CUT-OFF DARK-SKY COMPLIANT, UNLESS OTHERWINDS
- ML INDICATES THAT THIS LUBRINAIRE SHALL BE ON A NIGHT LIGHT CIRCUIT, FL INDICATES
 THAT THIS LUBRINAIRE SHALL BE A FLOOD LIGHT FIXTURE. MOUNTING BRACKET FOR THIS FI
 FIXTURE SHALL BE MOUNTED 25' ABOVE BOTTOM OF POLE BASE FOR ALL LIGHT POLES
 CLOSEST TO STOREFRONT. THESE DESIGNATIONS INDICATE WHAT PHASE LIGHTS ARE WIRED
 TO (1992)
- THE PROPOSED LIGHTING CALCULATIONS AND DESIGN WAS PERFORMED BY CHARGON, INC., P.O. BOX 4550, MANCHESTER, NH D3108, ATTENTION KEN SKEINEY, ALL IGHTS SHOULD BE PURCHASED FROM THIS COMPANY, OR AN EQUAL LIGHTING DESIGN SHOULD BE SUBMITTED.





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Symbol	Qty	Label	Arrangement	Description
GE	3	P5-2	Back-Back	GLEON-SAID-740-U-5WQ /
		1000		SSS4A20SFN2 (20' AFG)
FI	4	83	Single	GLEON-SA1C-740-U-SL3 /
- Second				SSS4A20SFN1 (20' AFG)
FI	2	84	Single	GLEON-SA1C-740-U-T4FT /
				SSS4A20SFN1 (20' AFG)
R	3	W3	Single	GWC-SA1A-740-U-SL3 / WALL MTD
-				15' AFG

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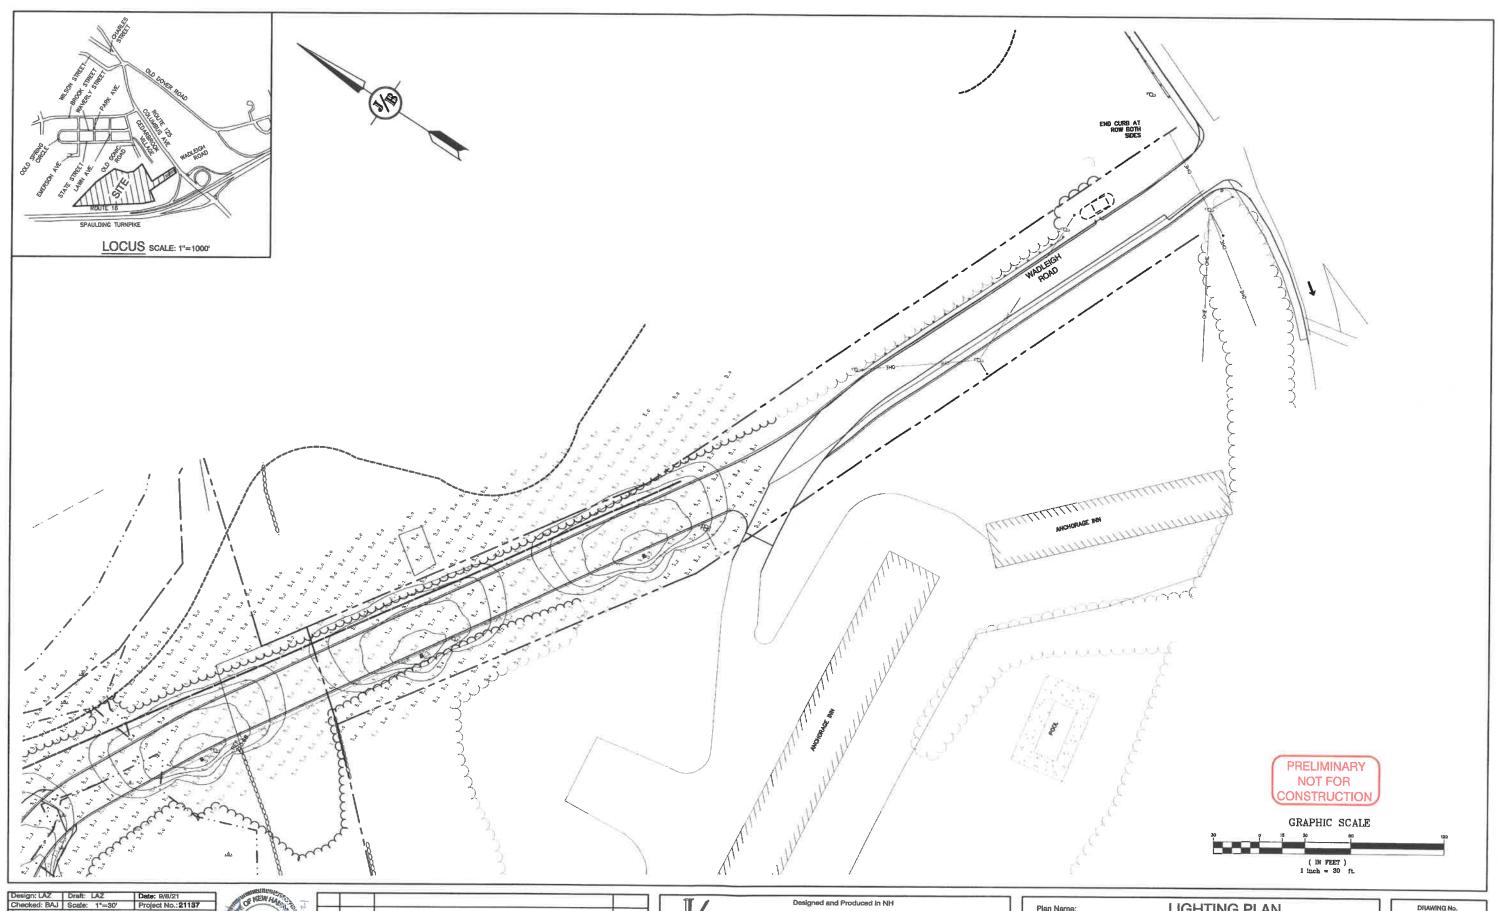
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603-772-4746
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Plan Name:	LIGHTING PLAN
roject:	WADLEIGH ROAD APARTMENTS ROCHESTER, NH
Owner of Record:	SSG, LLC ATTN: FENTON GROEN





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B5 Portsmouth Ave. Civil Engineering Services 608-772-4748
PO Box 219
Stratham, NH 03886 E-Mall: JBE@JONESANDBEACH.COM


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Project:	WADLEIGH ROAD APARTMENTS ROCHESTER, NH
Owner of Record:	SSG, LLC ATTN: FENTON GROEN 120 WASHINGTON STREET, ROCHESTER, NH 03839

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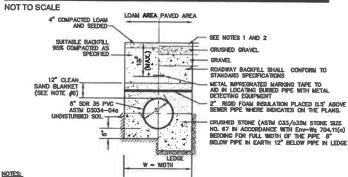
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SHEET 17 OF 22

JBE PROJECT NO. 21127




WATER SYSTEM TRENCH

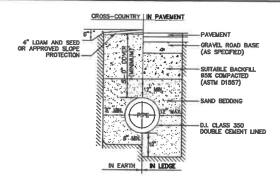

- NOTES:

 1. PAVEMENT REPAIR IN EXISTING ROADWAYS SHALL CONFORM TO PAVEMENT DETAILS.
- 2. NEW ROADWAY CONSTRUCTION SHALL CONFORM TO SUBDIVISION SPECIFICATIONS,
- TRENCH BACKFILL SHALL CONFORM WITH ENV. Wq 704.11(h) AND BE FREE OF DEBRIS, PAVEMENT, ORGANIC MATTER, TOP SOIL, WET OR SOFT MUCK, PEAT OR CLAY, EXCAVATED LEDGE OF ROCKS OVER SIX INCHES.
- 4. W- MAXIMUM ALLOWABLE TRENCH WIDTH TO A PLANE 12" INCHES ABOVE THE PIPE. FOR PIPES 15 INCHES NOMINAL DIAMETER OR LESS, WIDTH SHALL BE NO MORE THAN 36"; FOR PIPES GREATER THAN 16 INCHES NOMINAL DIAMETER, WIDTH SHALL BE 24 INCHES PLUIS PIPE C.D. WIDTH SHALL ALSO BE THE PAYMENT WIDTH FOR LEDGE EXCAVATION AND FOR ORDERED EXCAVATION BELOW GRADE.
- RIGID FOAM INSULATION TO BE PROVIDED WHERE COVER IN THE ROADWAY IS LESS THAN 6' AND CROSS COUNTRY IS LESS THAN 4', PURSUANT TO DES WAIVER BEING ISSUED.
- PIPE SAND BLANKET MATERIAL SHALL BE GRADED SAND, FREE FROM ORGANIC MATERIALS, GRADED SUCH THAT 100% PASSES A 1/2 " SIEVE AND A MAXIMUM OF 15% PASSES A #200 SIEVE IN ACCORDANCE WITH Env-Wg 704.11(b).
- 7. JOINT SEALS FOR PVC PIPE SHALL BE OIL RESISTANT COMPRESSION RINGS OF ELASTOMERIC MATERIAL AND CERTIFIED BY THE MANUFACTURER AS CONFORMING TO THE ASTM D3212 STANDARD IN EFFECT WHEN THE JOINT SEALS WERE MANUFACTURED, AND SHALL BE PUSH-ON, BELL-AND-SPIGOT TYPE PER ENV-WIG 704.05 (a).

SEWER TRENCH

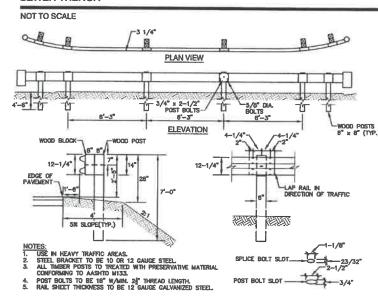

BIT. SIDEWALK W/ VERTICAL GRANITE CURB

THOT BITURINOUS
COURSE (TYPE F)


"HOT BIT. BASE
COURSE (TYPE B)

N.H.D.O.T. ITEM 304.3
4" CRUSHED GRAVEL

N.H.D.O.T. ITEM 304.2
8" BARK RUN GRAVEL (MIN.)


BITUMINOUS SIDEWALK DETAIL

NOT TO SCALE

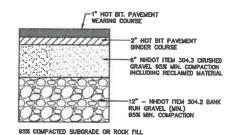

TYPICAL BITUMINOUS PAVEMENT


NOT TO SCALE

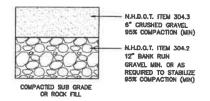

NOTE: IN AREAS OF ROCK EXCAVATION, MINIMUM 9° BANK RUN GRAVEL SHALL BE PLACED

GRAVEL SECTION


NOT TO SCALE

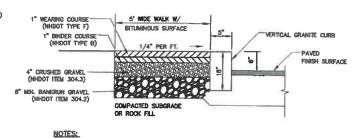

2. EDGING TO BE PLACED PRIOR TO PLACING TOP SURFACE COURSE.


1. JOINTS BETWEEN STONES SHALL BE MORTARED.

NOT TO SCALE

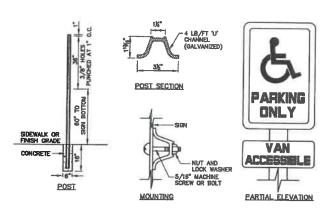


HANDICAP SIGN DETAILS

NOT TO SCALE

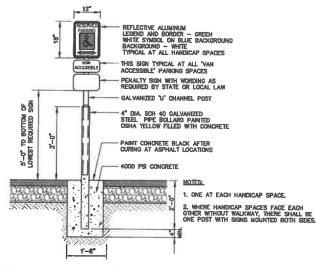


HANDICAP PARKING SIGN (R7-8)

NOT TO SCALE

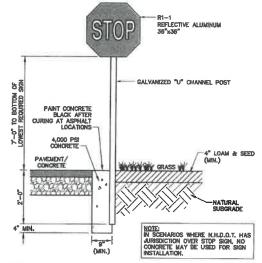

STOP SIGN (R1-1)

NOT TO SCALE

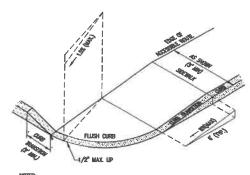

exues:

1. The invanium allowable cross slope of accessible route (sdewalt) and curb shall be 1.5%.

2. The invanium allowable slope of accessible route excliding curb ramps shall be 5%.

3. The invanium allowable slope of accessible route (sdewalt) curb ramps shall be 8%.


4. A minimum of 4 feet clear shall be mantamed) at any permanent obstacle in accessible route.

 A MANNON OF 4 FEET CLEAR SHALL BE MAINTAINED AT ANY PERMANENT OBSTACLE IN ACCES HYDRAITS, UTILY POLES, TREE WELLS, SIGNS, ETC.).
 CLEAR TREATMENT VARIES SET BILANS THE CLEAR THEATTY VARIES SET BILANS THE CLEAR THEATTY VARIES SET BILANS THE CLEAR THEATTY.

HYDRANTS, UTILITY POLES, TREE WELLS, SIGNS, ETC.).
5. CURB TREATMENT VARIES, SEE PLANS FOR CURB TYPE.
6. BASE OF RAMP SHALL BE GRADED TO PREVENT PONONN
7. SEE TYPICAL SECTION FOR RAMP CONSTRUCTION.

ACCESSIBLE CURB RAMP (TYPE 'B')

NOT TO SCALE

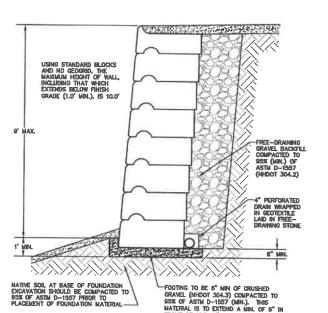

 PRE-FABRICATED WALL UNITS SHALL BE REDI-ROCK INTERNATIONAL AS PRODUCED BY A LICENSED MANUFACTURER, OR AN EQUIVALENT APPROVED IN MINIMARY BY THE CIVIL ENGINEER OF RECORD (JONES & BEACH ENGINEERS, INC.).

2. THE CONTRACTOR IS RESPONSIBLE FOR RETAINING THE SERVICES OF A LICENSED STRUCTURAL ENGINEER TO DESIGN ANY WALL THAT HAS A HEIGHT OVER 4.0". JONES & BEACH ENGINEERS, INC. DOES HOT ACCEPT ANY LIBELLY FOR THE STRUCTURAL DESIGN AND/OR INSTALLATION OF ANY FRETAINING WALL OF ANY TYPE ADVE THIS HEIGHT. THIS DETAILS IS INTERDED TO PROVIDE AN EXAMPLE OF THE RETAINING WALL OF ANY TYPE ADVE THIS HEIGHT. THIS DETAILS IS INTERDED TO PROVIDE AN EXAMPLE OF THE RETAINING WALL FOR PLANNING PURPOSES ONLY AND IS SPECIFICALLY NOT INTERDED FOR USE BY THE CONTRACTOR IN ANY CONSTRUCTION—HEALTED ACTIVITY.

 CONSTRUCTION OF THE RETAINING WALL(S) SHOULD FOLLOW THE SPECIFICATIONS OF REDI-ROCK INTERNATIONAL AND THE STRUCTURAL ENGINEER OF RECORD.

4. RETAINING WALL-RELATED CORRESPONDENCE SHOULD BE DIRECTED TO:

REDI-ROCK INTERNATIONAL 05481 SOUTH U.S. 31 CHARLEVOIX, MICHIGAN 49720

T# (231) 237-9500 F# (231) 237-9521 PRELIMINARY
NOT FOR
CONSTRUCTION


REDI-ROCK INTERNATIONAL RETAINING WALL DETAIL (STANDARD BLOCKS W/ NO GEOGRID)

NOT TO SCALE

Design: LAZ	Draft; LAZ	Date: 9/8/21
Checked: BAJ	Scale: AS NOTED	Project No.:21137
Drawing Name:	21137-PLAN.dwg	
THIS PLAN SHALL	NOT BE MODIFIED WITH	HOUT WRITTEN
PERMISSION FRO	M JONES & BEACH ENG	INEERS, INC. (JBE).
ANY ALTERATION	S, AUTHORIZED OR OTH	IERWISE, SHALL BE
	OLE RISK AND WITHOUT	

GUARD RAIL (STEEL)

NOT TO SCALE

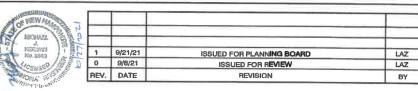

Designed and Produced in NH Jones & Beach Engineers, Inc.

85 Portsmouth Ave. Civil Engineering Services 603-772-4746
PO Box 219 FAX: 603-772-0227
Stratham, NH 03885


Pian N	ame:	DETAIL SHEET				
Project	:	WADLEIGH ROAD APARTMENTS ROCHESTER, NH				
Owner	of Record:	SSG, LLC ATTN: FENTON GROEN 120 WASHINGTON STREET, ROCHESTER, NH 03839				

DRAWING No.

D1

SHEET 18 OF 22


JBE PROJECT NO.21137

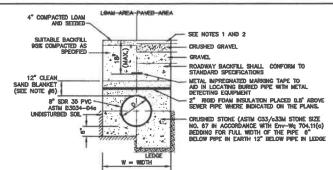

NOTES: 1. PAVEMENT REPAIR IN EXISTING ROADWAYS SHALL CONFORM TO PAVEMENT DETAILS.

- 2. NEW ROADWAY CONSTRUCTION SHALL CONFORM TO SUBDIVISION SPECIFICATIONS.
- TRENCH BACKFILL SHALL CONFORM WITH ENV. Wg 704.11(h) AND BE FREE OF DEBRIS, PAVEMENT, ORGANIC MATTER, TOP SOIL, WET OR SOFT MUCK, PEAT OR CLAY, EXCAVATED LEDGE OR ROCKS OVER SIX INCHES.
- 4. We MAXMUM ALLOWABLE TRENCH WIDTH TO A PLANE 12" INCHES ABOVE THE PIPE. FOR PIPES 15 INCHES NOMINAL DIAMETER OR LESS, WIDTH SHALL BE NO MORE THAN 36"; FOR PIPES GREATER THAN 15 INCHES NOMINAL DIAMETER, WIDTH SHALL BE 24 INCHES PLUS PIPE 0.D. WIDTH SHALL ALSO BE THE PAYMENT WIDTH FOR LEDGE EXCAVATION AND FOR ORDERED EXCAVATION BELOW GRADE.
- RIGID FOAM INSULATION TO BE PROVIDED WHERE COVER IN THE ROADWAY IS LESS THAN 8' AND CROSS COUNTRY IS LESS THAN 4', PURSUANT TO DES WAIVER BEING ISSUED.
- PIPE SAND BLANKET MATERIAL SHALL BE GRADED SAND, FREE FROM ORGANIC MATERIALS, GRADED SUCH THAT 100X
 PASSES A 1/2 " SIEVE AND A MAXIMUM OF 15% PASSES A #200 SIEVE IN ACCORDANCE WITH Env-Wig 704.11(b).
- JOINT SEALS FOR PVC PIPE SHALL BE OIL RESISTANT COMPRESSION RINGS OF ELASTOMERIC MATERIAL AND CERTIFIED BY THE MANUFACTURED AS CONFORMING TO THE ASTIN DS212 STANDARD IN EFFECT WHEN THE JOINT SEALS WERE MANUFACTURED, AND SHALL BE PUSH-ON, BELL—AND—SPICOT TYPE PER En:—WIP 704-05 (6).

SEWER TRENCH

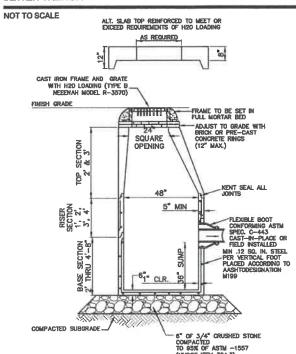


NOTES:

- 1. BASE SECTION SHALL BE MONOLITHIC WITH 48" INSIDE DIAMETER.
- 2. ALL SECTIONS SHALL BE DESIGNED FOR H20 LOADING.
- 3. CONCRETE SHALL BE COMPRESSIVE STRENGTH 4000 PSI, TYPE II CEMENT.
- 4. FRAMES AND GRATES SHALL BE HEAVY DUTY AND DESIGNED FOR H20 LOADING
- PROVIDE "V" KNOCKOUTS FOR PIPES WITH 2" MAX. CLEARANCE TO OUTSIDE OF PIPE. MORTAR ALL PIPE CONNECTIONS SO AS TO BE WATERTIGHT.
- 6. JOINT SEALANT BETWEEN PRECAST SECTIONS SHALL BE BUTYL RUBBER.
- ALL CATCH BASIN FRAMES AND GRATES SHALL BE NHDOT CATCH BASIN TYPE ALTERNATE 1 OR NEENAH R-3570 OR APPROVED EQUAL (24°424° TYPICAL).
- 8. STANDARD CATCH BASIN FRAME AND GRATE(S) SHALL BE SET IN FULL MORTAR BED. ADJUST TO GRADE WITH CLAY BRICK AND MORTAR (2 BRICK COURSES TYPICALLY, 5 BRICK COURSES MAJOMUM, BUT NO MORE THAN 12"), OR PRECAST CONCRETE DONUTS.


CATCH BASIN

NOT TO SCALE

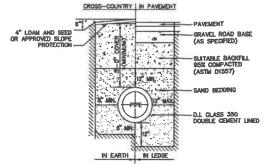


WATER SYSTEM TRENCH

NOT TO SCALE

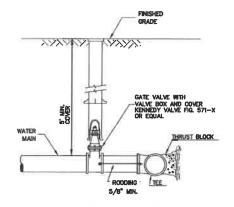

BURIED GATE VALVE DETAIL


NOT TO SCALE

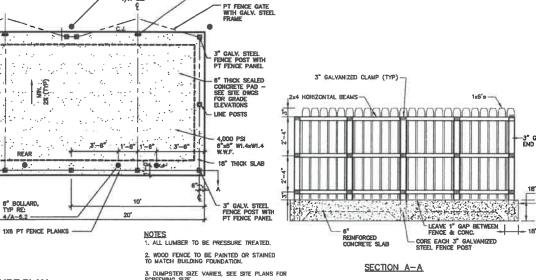

PROVIDE STL RECEIVER SLEEVE SET IN CONG AT CANE BOLTS

DUMPSTER ENCLOSURE PLAN

NOT TO SCALE

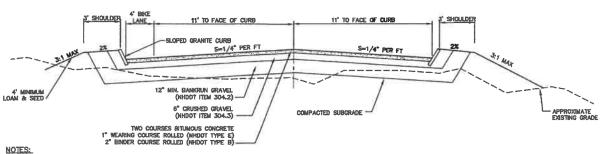


1. REMOVE ALL ORGANICS, TOPSOIL AND MATERIAL YELDING TO A 10 TON ROLLER. SUSBASE AREAS THAT CONTAIN UNSUITABLE MATERIALS MUST BE EXCAVATED TO A DEPTH NO LESS THAN 36" BELOW FINSH GRADE AND BE REPLACED WITH GRAVEL COMPACTED TO 85%.


- 2. ALL MATERIALS TO BE AS SPECIFIED PER TOWN STANDARDS AND NHDOT, WHICHEVER IS MOST STRINGENT, GRADATION AND COMPACTION TEST RESULTS (95% MIN.) SHALL BE SUBMITTED FOR
- 3. TOWN MAY REQUIRE UNDERDRAIN AND/OR ADDITIONAL DRAINAGE IF SOIL CONDITIONS
- 4. WOVEN GEOTEXTILE FABRIC SHALL BE PLACED ABOVE SUBGRADE AT ALL WETLAND CROSSINGS.

TYPICAL ROADWAY SECTION W/CURBING

NOT TO SCALE

Designed and Produced in NH Jones & Beach Engineers, Inc.

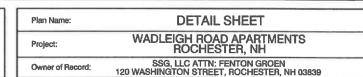


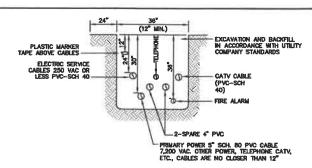

NOTE: ALL LITELITIES SHALL BE REVIEWED AND APPROVED BY APPROPRIATE LITELITY COMPANY

UTILITY TRENCH

NOT TO SCALE

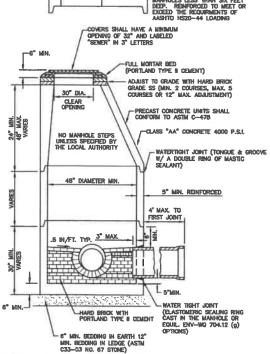

- PER NAIDES ENV-WQ 704.13(C), MORTAR USED IN MANHOLE CONSTRUCTION SHALL COMPLY WITH THE

- PER NRIDES ENV-WQ 704.13(C), MORTAR USED IN MANHOLE CONSTRUCTION SHALL COMPLY WITH THE FOLLOWING.

 A MORTAR SHALL SE COMPOSED OF TYPE II PORTLAND CEMENT AND SAND WITH OR WITHOUT YELLOWING.

 A MORTAR SHALL SE COMPOSED OF TYPE II PORTLAND CEMENT AND SAND WITH OR WITHOUT YELLOWING THE PROPERTY OF THE PRO

- HTTP: //WWW.NH.GOV/DOT/ORG/PROJECTDEVELOPMENT /HIGHWAYDESIGN/SPECIFICATIONS /INDEX.HTM
- SHELVES SHALL BE CONSTRUCTED TO THE ELEVATION OF THE HIGHEST PIPE CROWN AND SLOPED TO DRAIN TOWARD THE FLOWING THROUGH CHANNEL IN ACCORDANCE WITH ENV-WQ 704.12 (I().
- ALL MANHOLES SHALL BE TESTED FOR LEAKAGE IN ACCORDANCE WITH ENV-WQ 704.17 (a) THROUGH
- SEWER MANHOLE COVERS SHALL CONFORM TO ASTM A48/49M WITH A CASTING EQUAL TO CLASS 30 IN ACCORDANCE WITH ENV-WQ 704.13 (a) (8).
- ALL PRECAST SECTIONS SHALL BE COATED ON THE EXTERIOR WITH A BITUMINOUS DAMP—PROOFING COATING IN ACCORDANCE WITH EINY—WQ 704.12 (J).
- ALL PRECAST SECTIONS AND BASES SHALL HAVE THE DATE OF MANUFACTURE AND THE NAME OR TRADEMARK OF THE MANUFACTURER IMPRESSED OR INDELIBLY MARKED ON THE INSIDE WALL PER ENV—WO 704.12().
- 7. BRICK MASONRY SHALL CONFORM TO ASTM C32 (ENV-WQ 704.12(a)(8))

SEWER MANHOLE

NOT TO SCALE

PRELIMINARY

NOT FOR

CONSTRUCTION

Checked: BAJ Scale: AS NOTED Project No.:21137
Drawing Name: 21137-PLAN.dwg
THIS PLAN SHALL NOT BY A SCALE. LAZ 1 9/21/21 ISSUED FOR PLANNING BOARD 85 Portsmouth Ave. Civil Engineering Services LAZ 0 9/8/21 ISSUED FOR REVIEW FAX: 603-772-0227 PO Box 219 AT THE USER'S SOLE RISK AND WITHOUT LIABILITY TO JBE. REV. DATE REVISION 87 E-MAIL: JBE@JONESANDBEACH.COM


DRAWING No. SHEET 19 OF 22

THIS PLAN SHALL NOT BE MODIFIED WITHOUT WRITTEN FRMISSION FROM JONES & BEACH ENGINEERS, INC. (JBE). ANY ALTERATIONS, AUTHORIZED OR OTHERWISE, SHALL BE

ACCEPTABLE FILL MATERIALS STORMTECH SC-310 AND SC-740 CHAMBER SYSTEMS

	MATERIAL LOCATION	DESCRIPTION	AASHTO M43 DESIGNATION	AASHTO M145 DESIGNATION	COMPACTION/DENSITY REQUIREMENT
Đ	PAVEMENT SUBGRADE, DEPTH(S) PER SPECIFICATIONS	PAVEMENT SUBGRADE, MATERIALS PER SPECIFICATIONS	N/A	N/A	PREPARE PER SPECIFICATIONS AND PLANS. PAVED INSTALLATIONS HAVE STRINGENT MATERIAL AND PREPARATION REQUIREMENTS.
0	FILL MATERIAL FROM 1.50' ABOVE CHAMBERS TO BOTTOM OF PAVEMENT SUBGRADE	GRANULAR WELL-GRADED SOIL/AGGREGATE MIXTURES, <35% FINES.	3, 357, 4, 467, 5, 56, 57, 6, 67, 68, 7, 78, 8, 89, 9, 10	A-2	COMPACT IN 6" LETTS TO A MINIMUM 95' STANDARD PROCTOR DENSITY. ROLLER GROSS VEHICLE WEIGHT NOT TO EXCEED 12,000 LBS. DYNAMIC FORCE NOT TO EXCEED 20,000 LBS.
B	EMBEDMENT STONE SURROUNDING AND TO A 1.50' ELEVATION ABOVE CHAMBERS	WASHED ANGULAR STONE WITH THE MAJORITY OF PARTICLES BETWEEN % - 2 INCH	3, 357, 4, 467, 5, 56, 57	NA	NO COMPACTION REQUIRED
<u>A</u>	12 " FOUNDATION STONE BELOW CHAMBERS	WASHED ANGULAR STONE WITH THE MAJORITY OF PARTICLES BETWEEN ½ - 2 INCH	3, 367, 4, 467, 5, 56, 57	N/A	PLATE COMPACT OR ROLL TO ACHIEVE A 95% STANDARD PROCTOR DENSITY

DATIONS ONLY. THE STONE MUST ALSO BE WASHED SHED ANGULAR. FOR EXAMPLE, THE STONE MUST BE

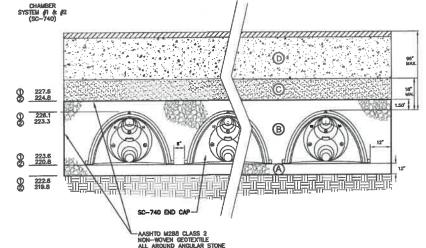

- 1. SC-740 CHAMBERS SHALL CONFORM TO THE REQUIREMENTS OF ASTM F2418 "STANDARD SPECIFICATION FOR POLYPROPYLENE (PP)
- ASTM F2787 "STANDARD PRACTICE FOR STRUCTURAL DESIGN OF THERMOPLASTIC CORRUGATED WALL STORMWATER COLLECTION
- "ACCEPTABLE FILL MATERIALS" TABLE ABOVE PROVIDES MATERIAL LOCATIONS, DESCRIPTIONS, GRADATIONS, AND COMPACTION REQUIREMENTS FOR FOUNDATION, EMBEDMENT, AND FILL
- 4. THE SITE DESIGN ENGINEER IS RESPONSIBLE FOR ASSESSING THE BEARING RESISTANCE (ALLOWABLE BEARING CAPACITY) OF THE SUBGRADE SOILS AND THE DEPTH OF FOUNDATION STONE WITH CONSIDERATION FOR THE RANGE OF EXPECTED SOIL MOISTURE CONDITIONS. PERIMETER STONE MUST BE EXTENDED HORIZONTALLY TO THE EXCAVATION WALL FOR BOTH VERTICAL AND SLOPED EXCAVATION
- IN LAYER "D' UP TO THE FINISHED GRADE, MOST PAVEMENT SUBBASE SOILS CAN BE USED TO REPLACE THE MATERIAL REQUIREMENTS OF LAYER 'C' OR 'D' AT THE SITE DESIGN

- CORRUGATED WALL STORMWATER COLLECTION CHAMBERS".

- 5. ONCE LAYER 'C' IS PLACED, ANY SOIL/MATERIAL CAN BE PLACED

STORMTECH GENERAL NOTES

NOT TO SCALE

TYPICAL SC-740 CROSS-SECTION

- BEGINNING SYSTEM INSTALLATION.


 2. STORNIECH OFFERS INSTALLATION
 CONSULTATIONS TO INSTALLING CONTRACTORS.
 CONTACT OUR BECHNICAL BERVICE DEPARTMENT
 CONTRACT OUR BECHNICAL BERVICE DEPARTMENT
 OFFERS OF BECHNICAL BUT OF SYSTEM INSTALLATION
 TO ARRANGE A PRE-INSTALLATION
 TO ARRANGE A PRE-INSTALLATION
 CONSULTATION. OUR REPRESENTATIVES CAN
 THEN ANSWER QUESTIONS OR ADDRESS
 COMMENTS ON THE STORNIECH CHAMBER
 SYSTEM AND INFORM THE INSTALLING
 CONTRACTOR OF THE MINIMUM INSTALLATION
 REQUIREMENTS BEFORE BEGINNING THE SYSTEM'S
 CONSTRUCTION. CALL BIGG-252-8188 TO
 SPAN SHAT THE HOLD SO WING STORMITCH COM
 TO RECEIVE A COPY OF OUR INSTALLATION
 INSTRUCTIONS. CONCRETE COLLAR-PAVEMENT -4" SDR35 PVC PIPE FLEXSTORM CATCH IT -W/ USE OF OPEN GRATE 3. STORMITECH'S REQUIREMENTS FOR SYSTEMS WITH PAVEMENT DESIGN (ASPHALT, CONCRETE PAVERS, ETC.). MANHAUM COVER IS 24 INCHES NOT INICIDIAND PAVEMENT, MANHAUM COVER IS 6.5 FEET INICIDIANC PAVEMENT. FOR INSTALLATIONS THAT DO NOT INCLUDE PAVEMENT, WHERE RUTTING FROM VEHICLES MAY OCCUR, MANHAUM REQUIRED COVER IS 24 INCHES, MAXMUM COVER IS 6.5 FEET. A" INSERTA TEE INSERTA TEE TO BE CENTERED IN VALLET
- TYPICAL SC-740 4" INSPECTION PORT

NOT TO SCALE

- STORMTECH LLC ("STORMTECH") REQUIRES INSTALLING CONTRACTORS TO USE AND INSTALLING CONTINUED TO SELECTION OF THE INSTALLATION INSTRUCTIONS PRIOR TO RECOMBING SYSTEM INSTALLATION.
 - 6. STONE PLACEMENT BETWEEN CHAMBERS ROWS AND AROUND PERIMETER MUST FOLLOW INSTRUCTIONS AS INDICATED IN THE MOST CUPRENT VERSION OF STORMTECH'S INSTALLATION INSTRUCTIONS.

 - DEPTHS OF COVER. THIS INFORMATION IS ALSO AVAILABLE AT STORMTECHYS WEBSITE! WWW.STORMTECH.COM. THE CONTRACTOR IS RESPONSIBLE FOR PRE-VENTING VEHICLES THAT EXCED STORMTECH'S REQUIREMENTS FROM TRAVELING ACROSS OR PARKING OVER THE STORMWATER SYSTEM. TEMPORARY FENCING, WARNING TAPE AND APPROPRIATELY LOCATED SIGNS ARE COMMONLY USED TO PREVENT UNAUTHORIZED VEHICLES FROM ENTERING SENSITIVE CONSTRUCTION AREAS.
 - THE CONTRACTOR MUST APPLY EROSION AND SEDIMENT CONTROL MEASURES TO PROTECT THE STORMMATER SYSTEM DURING ALL PHASES OF SITE CONSTRUCTION PER LOCAL CODES AND


- AASHTO M288 CLASS 2 NON-WOVEN GEOTEXTILE (FILTER FABRIC) MUST BE USED AS INDICATED IN THE PROJECT PLANS.
- BACKFILLING OVER THE CHAMBERS MUST FOLLOW REQUIREMENTS AS IMPRICATED IN THE
- THE CONTRACTOR MUST REFER TO STORMTECH'S INSTALLATION INSTRUCTIONS FOR A TABLE OF ACCEPTABLE VEHICLE LOADS AT VARIOUS DEPTHS OF COVER. THIS INFORMATION IS ALSO
- DESIGN ENGINEER'S SPECIFICATIONS
- 10. STORMTECH PRODUCT WARRANTY IS LIMITED.
 CONTACT STORMTECH FOR WARRANTY

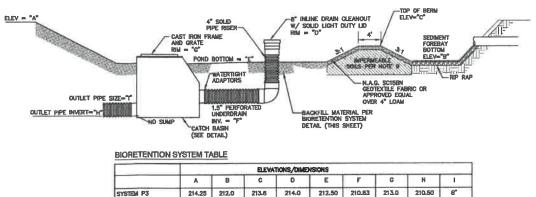

nyloplast usa inc 3130 Verana Avenue - Buford, Georgia 30518 Tel. (770) 932-2443 - Fex: (770) 932-2490

NOT TO SCALE

BIORETENTION SYSTEM SECTION

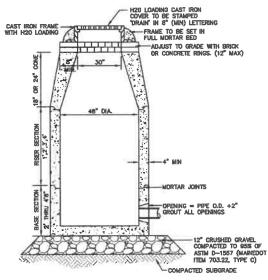

- 1. BASE SECTION SHALL BE MONOLITHIC WITH 48" INSIDE DIAMETER.
- 2. ALL SECTIONS SHALL BE DESIGNED FOR H20 LOADING
- 3. CONCRETE SHALL BE COMPRESSIVE STRENGTH 4000 PSI, TYPE II CEMENT.
- 4. FRAMES AND GRATES SHALL BE HEAVY DUTY AND DESIGNED FOR H20 LOADING. 5. PROVIDE "V" KNOCKOUTS FOR PIPES WITH 2" MAX. CLEARANCE TO OUTSIDE OF PIPE MORTAR ALL PIPE CONNECTIONS SO AS TO BE WATERTIGHT.
- B. JOINT SEALANT BETWEEN PRECAST SECTIONS SHALL BE BUTYL RUBBER.
- 7. ALL DRAIN MANHOLE FRAMES AND GRATES SHALL BE NEENAH R-1798 OR APPROVED EQUAL (30" DIA. TYPICAL).
- B. STANDARD FRAME(S) AND GRATE(S) SHALL BE SET IN FULL MORTAR BED. ADJUST TO GRADE WITH CLAY BRICK AND MORTAR (2 BRICK COURSES TYPICALLY, 5 BRICK COURSES MAXIMUM, BUT NO MORE THAN 12"), OR PRECAST CONCRETE 'DORUTS'.

DRAIN MANHOLE (4' DIAM.)

NOT TO SCALE

PRELIMINARY NOT FOR CONSTRUCTION

Plan Name


SAND SPECIFICATION SIEVE SIZE S BY WEIGHT MINIMAL CLAY CONTENT AND BETWEEN 15 TO 25% FINES BARK OR WOOD FIBER MULCH WITH LESS THAN 5% PASSING THE #200 SIEVE. TOW S 214.25 3.0' PONDING 7 -3° OF %" CLEAN PEASTONE CHOKER COURSE FOUNDE IMPERVIOUS LAYER WITH PERMEABILITY OF 1.5° PERFORATED DESIGN CONSIDERATIONS

- DO NOT PLACE BIORETENTION SYSTEMS INTO SERVICE UNTIL THE BMP HAS BEEN PLANTED AND ITS CONTRIBUTING AREAS HAVE BEEN FULLY STABILIZED.
- DO NOT DISCHARGE SEDIMENT—LADEN WATERS FROM CONSTRUCTION ACTIVITIES (RUN—OFF, WATER FROM EXCAVATIONS) TO THE BIORETENTION AREA DURING ANY STAGE OF CONSTRUCTION.
- DO NOT TRAFFIC EXPOSED SOIL SURFACE WITH CONSTRUCTION EQUIPMENT, IF FEASIBLE, PERFORM EXCAVATIONS WITH EQUIPMENT OUTSIDE THE LIMITS OF THE INFILTRATION COMPONENTS OF THE SYSTEM.

MAINTENANCE REQUIREMENTS:

- SYSTEMS SHOULD BE INSPECTED AT LEAST TWICE ANNUALLY, AND FOLLOWING ANY RAINFALL EVENT EXCEEDING 2.5 INCHES IN A 24 HOUR PERIOD, WITH MAINTENANCE OR REHABILITATION CONDUCTED AS WARRANTED BY SUCH INSPECTION.
- PRETREATMENT MEASURES SHOULD BE INSPECTED AT LEAST TWICE ANNUALLY, AND CLEANED OF ACCUMULATED SEDIMENT AS WARRANTED BY INSPECTION, BUT NO LESS THAN ONCE ANNUALLY.
- TRASH AND DEBRIS SHOULD BE REMOVED AT EACH INSPECTION.
- AT LEAST ONCE ANNUALLY, SYSTEM SHOULD BE INSPECTED FOR DRAWDOWN TIME. IF BIORETENTION SYSTEM DOES NOT DRAIN WITHIN 72 HOURS FOLLOWING A RAINFALL EVENT, THEN A QUALIFIED PROFESSIONAL SHOULD ASSESS THE CONDITION OF THE FACILITY TO DETERMINE MEASURES REQUIRED TO RESTORE FILTRATION FUNCTION OF INFILTRATION FUNCTION OF ASSESSED TO RESTORE FILTRATION FUNCTION OF INFILTRATION FUNCTION OF THE FILTRAMEDIA.
- VEGETATION SHOULD BE INSPECTED AT LEAST ANNUALLY, AND MAINTAINED IN HEALTHY CONDITION, INCLUDING PRUNING, REMOVAL AND REPLACEMENT OF DEAD OR DISEASED VEGETATION, AND REMOVAL
- 6. CLAY LINER MATERIAL SHALL BE CLEAN SILTY-CLAY BORROW FREE OF ROOTS, ORGANIC MATTER, AND OTHER DELETERIOUS SUBSTANCES, AND SHALL CONTAIN NO ROCKS OR LUMPS OVER THREE INCHES (3") IN DIAMETER. THIS MATERIAL SHALL BE INSTALLED IN 6" LIFTS COMPACTED TO 92% OF ASTM D-1957, AND SHALL MEET THE FOLLOWING SPECIFICATIONS: 6" PASSING 100%, \$4 SIEVE 95-100%, \$40 SIEVE 60-80%, \$100 SIEVE 40-80%, \$200 SIEVE 25-45% (OF THE FRACTION PASSING THE \$4 SIEVE). THE CLAY COMPONENT SHALL MAVE A PLASTICITY INDEX OF AT LEAST 8 AND A HYDRAILLIC CONDUCTIVITY OF 10 TO THE -8 CM/SEC.
- COMPACTION AND MATERIALS TESTING SERVICES SHALL BE PERFORMED BY AN INDEPENDENT GEOTECHNICAL ENGINEER RETAINED BY THE OWNER.

BIORETENTION SYSTEM (with clay bottom and pipe)

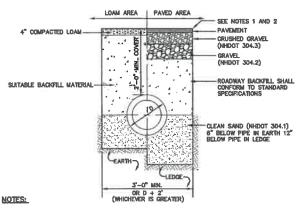

- 1. PAVEMENT REPAIR IN EXISTING ROADWAYS SHALL CONFORM TO STREET OPENING REGULATIONS.
- 2. NEW ROADWAY CONSTRUCTION SHALL CONFORM WITH PROJECT AND TOWN SPECIFICATIONS.
- 3. ALL MATERIALS ARE TO BE COMPACTED TO 95% OF ASTM D-1557. **DRAINAGE TRENCH**

NOT TO SCALE

DETAIL SHEET

WADLEIGH ROAD APARTMENTS ROCHESTER, NH Project:

SSG, LLC ATTN: FENTON GROEN 120 WASHINGTON STREET, ROCHESTER, NH 03839

DRAWING No.

JBE PROJECT NO. 21137

Design: LAZ Draft: LAZ Checked: BAJ Scale: AS NOTED Project No.: 21137 Drawing Name: 21137-PLAN.dwg PERMISSION FROM JONES & BEACH ENGINEERS, INC. (JBE). ANY ALTERATIONS, AUTHORIZED OR OTHERWISE, SHALL BE AT THE USER'S SOLE RISK AND WITHOUT LIABILITY TO JIBE.





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4. THE CONTRACTOR MUST REPORT ANY DISCREPANCIES WITH CHAMBER FOUNDATION MATERIALS BEARING CAPACITIES TO THE DESIGN ENGINEER.

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85 Portsmouth Ave. Civil Engineering Services FAX: 603-772-0227 PO Box 219 E-MAIL: JBE@JONESANDBEACH.COM



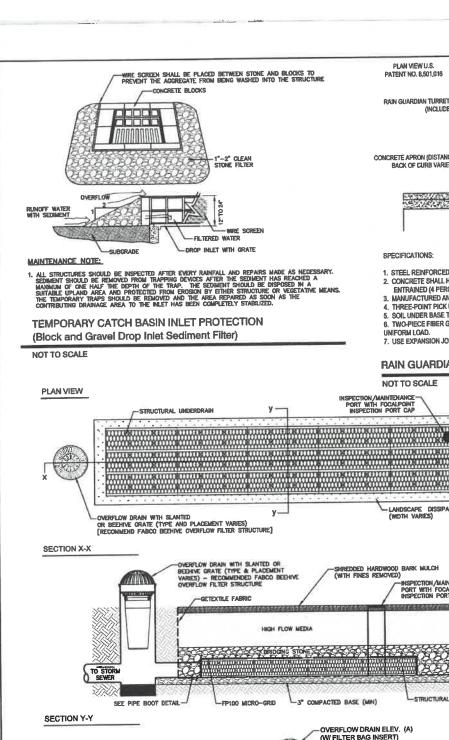



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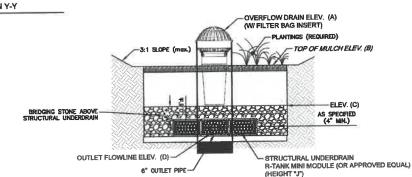
- STEEL REINFORCED, COLD JOINT SECURED MONOLITHIC CONCRETE STRUCTURE (1,030 LBS).
 CONCRETE SHALL HAVE A MINIMUM COMPRESSIVE STRENGTH OF 4,000 PSI AT 28 DAYS. CONCRETE AIR
- ENTRAINED (4 PERCENT TO 8 PERCENT BY VOLUME).
- 3 MANUFACTURED AND DESIGNED TO ASTM C858.
- THREE-POINT PICK USING RECESSED LIFTING POCKETS WITH A STANDARD HOOK.
 SOIL UNDER BASE TO BE COMPACTED TO 95 PERCENT STANDARD PROCTOR.
- 6. TWO-PIECE FIBER GLASS TOP GRATE (16 LBS/PIECE) FOR 1,706 LB CONCENTRATED LOAD OR 409 LB/SQFT
- UNIFORM LOAD.
- 7. USE EXPANSION JOINT MATERIAL BETWEEN TURRET AND BIORETENTION INLET.

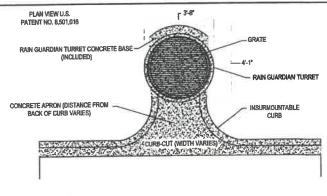RAIN GUARDIAN - TURRET - TYPICAL DETAIL - PLAN VIEW


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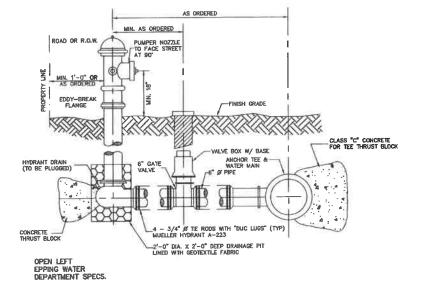




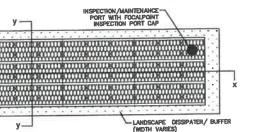

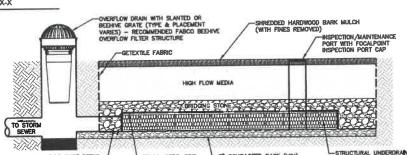FOCALPOINT BIOFILTRATION SYSTEM



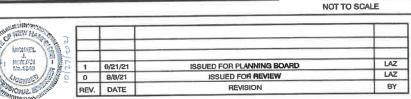


NOTES
1. ALL PIPE FITTINGS TO BE D.I. PRESSURE CLASS 350, THICKNESS CLASS 52.
1. HUDRANT TO BE PAINTED RED WITH WHITE "REFLECTOR" PAINT ON BONNET.
1. MECHANICAL JOINTS SHALL HAVE MEGALIE RETAINING GLANDS AS MADE BY EBBA OR APPROVED EQUAL.

4, STEAMER NOZZLE TO BE "STORCH" TYPE.
5. NATIONAL STANDARD THREAD.


HYDRANT INSTALLATION

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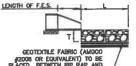


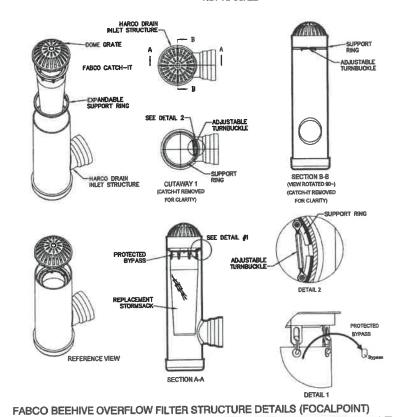PO Box 219

PRELIMINARY NOT FOR CONSTRUCTION



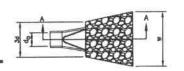





SECTION A-A PIPE OUTLET TO FLAT AREA WITH NO DEFINED CHANNEL

SECTION A-A PIPE OUTLET TO WELL-DEFINED

TABLE 7-24F	RECOMMENDED	RIP RAP GR	ADATIO	N RANGES
THICKNESS OF F	RIP RAP = 1.	5 FEET		
d50 SIZE=	0.50	FEET	6	INCHES
% of Weight Si Than the given		SIZE OF FROM	STON	E (INCHES) TO
100%		9		12
85%		8		11
50%		6		9
15%		2		3

- 1. THE SUBGRADE FOR THE GEOTEXTILE FABRIC AND RIP RAP SHALL BE PREPARED TO THE LINES AND GRADES SHOWN ON THE PLANS.
- 2. THE RIP RAP SHALL CONFORM TO THE SPECIFIED GRADATION.
- 3. GEOTEXTILE FAGRICS SHALL BE PROTECTED FROM PUNCTURE OR TEARING DURING THE PLACEMENT OF THE ROCK RP. DAMAGED AREAS IN THE FABRIC SHALL BE REPARED BY PLACING A PIECE OF FABRIC OVER THE DAMAGED AREA OR BY COMPLETE REPLACEMENT OF THE FABRIC, ALL OVERLAPS REQUIRED FOR REPAIRS OR JOINING TWO PIECES OF FABRIC SHALL BE A MINIMUM OF 12 INCHES.

- 6. MAINTENANCE: THE OUTLET PROTECTION SHOULD BE CHECKED AT LEAST ANNUALLY AND AFTER EVERY MAJOR STORM. IF THE RIP RAP HAS BEEN DISPLACED, UNDERWINED OR DAMAGED, IT SHOULD BE REPAIRED MANEDLATELY. THE CHANNEL MAINTAILEY BELOW THE OUTLET SHOULD BE CHECKED TO SEE THAT ERGSON IS NOT OCCURRING. THE DOWNSTREAM CHANNEL SHOULD BE KEPT CLEAR OF OBSTRUCTIONS SUCH AS FALLEN TREES, DEBIS, AND SEDMENT THAT COULD CHANGE FLOW PATTERNS AND/OR TALIMATER DEPTHS ON THE PIPES. REPAIRS MUST BE CARRIED OUT BIMEDIATELY TO AVOID ADDITIONAL DAMAGE TO OUTLET PROTECTION.

RIP RAP OUTLET PROTECTION APRON

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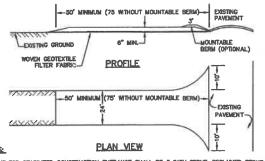
E-MAIL: JBE@JONESANDBEACH.COM

Plan Name:	DETAIL SHEET
Project:	WADLEIGH ROAD APARTMENTS ROCHESTER, NH
Owner of Record:	SSG, LLC ATTN: FENTON GROEN 120 WASHINGTON STREET, ROCHESTER, NH 03839

DRAWING No.

- TEMPORARY EROSION CONTROL NOTES

 THE SMALLEST PRACTICAL AREA OF LAND SHALL BE EXPOSED AT ANY ONE TIME. AT NO TIME SHALL AN AREA IN EXCESS OF 5 ACRES BE EXPOSED AT ANY ONE TIME BEFORE DISTURBED AREAS ARE STABILIZED.
- EROSION, SEDIMENT AND DETENTION MEASURES SHALL BE INSTALLED AS SHOWN ON THE PLANS AND AT LOCATIONS AS REQUIRED, DIRECTED BY THE ENGINEER.
- ALL DISTURBED AREAS (INCLUDING POND AREAS BELOW THE PROPOSED WATERLINE) SHALL BE RETURNED TO PROPOSED GRADES AND BLEVATIONS. DISTURBED AREAS SHALL BE LOAMED WITH A MINIMUM OF 6° OF SCHEEDED ORGANIC LOAM AND SEEDED WITH SEED MINITURE 0° AT A RATE NOT LESS THAM 1.10 POURDS OF SEED PER 1,000 S.F. OF AREA (BLBS. / ACRE).
- SLT FENCES AND OTHER BARRIERS SHALL BE REPECTED EVERY SEVEN CALENDAR DAYS AND WITHIN 24 HOURS OF A RAINFALL OF 0.5" OR GREATER. ALL DAMAGED AREAS SHALL BE REPARED, AND SEDMENT DEPOSITS SHALL PERSONICALLY BE REMOVED AND DISPOSED OF.
- AFTER ALL DISTURBED AREAS HAVE BEEN STABILIZED, THE TEMPORARY EROSION CONTROL MEASURES SHALL BE REMOVED AND THE AREA DISTURBED BY THE REMOVAL SMOOTHED AND RE-VEGETATED.
- AREAS MUST BE SEEDED AND MULCHED OR OTHERWISE PERMANENTLY STABILIZED WITHIN 3 DAYS OF FINAL GRADING, OR TEMPORARILY STABILIZED WITHIN 14 DAYS OF THE INITIAL DISTURBANCE OF SOIL. ALL AREAS SHALL BE STABILIZED WITHIN 45 DAYS OF RITHAL DISTURBANCE.
- ALL PROPOSED VEGETATED AREAS THAT DO NOT EXHIBIT A MINIMUM OF 85 PERCENT VEGETATIVE GROWTH BY OCTOBER 15, OR WHICH ARE DISTURBED AFTER OCTOBER 15, SHALL BE STABILIZED BY SEEDING AND INSTALLING NORTH AMERICAN GREEN 575 WHILT ARE DISJUNCED AFFEC OR AN EQUIVALENT APPROVED IN WRITING BY THE ENGINEER) ON SLIPES GREATER THAN 3.1, AND SEEDING AND PLACING 3 TO 4 TORS OF MULCH PER ACRE, SECURED WITH ANCHORED METTING, ELSEWHERE. THE INSTALLATION OF EROSSION CONTROL BLANKETS OR MULCH AND NETTING SHALL NOT OCCUR OVER ACCUMULATED SNOW OR ON FROZEN GROUNI AND SHALL BE COMPLETED IN ADVANCE OF THAW OR SPRING MELT EVENTS.
- ALL DITCHES OR SWALES WHICH DO NOT EXHIBIT A MINIMUM OF 85 PERCENT VEGETATIVE GROWTH BY OCTOBER 15, OR WHICH ARE DISTURBED AFTER OCTOBER 15, SHALL 86 STABLIZED TEMPORARILY WITH STONE OR EROSION CONTROL BLANKETS APPROPRIATE FOR THE DESIGN FLOW CONTINUES.
- AFTER NOVEMBER 15th, INCOMPLETE ROAD OR PARKING SURFACES, WHERE WORK HAS STOPPED FOR THE WINTER SEASON, SHALL BE PROTECTED WITH A MINIMUM OF 3° OF CRUSHED GRAVEL PER NHDOT LITEM 304.3.
- - Q. BASE COURSE GRAVELS HAVE BEEN INSTALLED IN AREAS TO BE PAVED;
 - b. A MINIMUM OF 85% VEGETATED GROWTH HAS BEEN ESTABLISHED
- FUGITIVE DUST CONTROL IS REQUIRED TO BE CONTROLLED IN ACCORDANCE WITH ENV-A 1000, AND THE PROJECT IS TO MEET THE REQUIREMENTS AND INTENT OF RSA 430:53 AND AGR 3800 RELATIVE TO INVASIVE SPECIES.
- PRIOR TO BEGINNING CONSTRUCTION, THE CONTRACTOR'S NAME, ADDRESS, AND PHONE NUMBER SHALL BE SUBMITTED TO DES VIA EMAIL (SEE BELOW).
- PRIOR TO CONSTRUCTION, A PHASING PLAN THAT DELINEATES EACH PHASE OF THE PROJECT SHALL BE SUBMITTED. ALL TEMPORARY SEDIMENT BASINS THAT WILL BE NEEDED FOR DEWATERING WORK AREAS SHALL BE LOCATED AND IDENTIFIED ON THIS PLAN.
- IN ORDER TO ENSURE THE STABILITY OF THE SITE AND EFFECTIVE IMPLEMENTATION OF THE SEDIMENT AND EROSION CONTROL MEASURES SPECIFIED IN THE PLANS FOR THE DURATION OF CONSTRUCTION, THE CONTRACTOR SHALL BE IN STRICT COMPLIANCE WITH THE FOLLOWING RISPECTION AND MAINTENANCE REQUIREMENTS IN ADDITION TO THOSE CALLED FOR IN THE SWIPPP:
 - a. A CERTIFIED PROFESSIONAL IN EROSION AND SEDMENT CONTROL OR A PROFESSIONAL ENGINEER LICENSED IN THE STATE OF NEW HAMPSHIRE ("MONITOR") SHALL BE EMPLOYED TO INSPECT THE SITE FROM THE START OF ALTERATION OF AIN ACTIVITIES UNTIL THE SITE IS IN FULL COMPLIANCE WITH THE SITE SPECIFIC PERMIT ("PERMIT").
 - b. DURING THIS PERIOD, THE MONITOR SHALL INSPECT THE SUBJECT SITE AT LEAST ONCE A WEEK, AND IF POSSIBLE, DURING ANY 1/2 NICH OR GREATER RAIN EVENT (LE. 1/2 NICH OF PRECEPITATION OR MORE WITHIN A 24 HOUR PERIOD). IF UNABLE TO BE PRESENT DURING SUCH A STORM, THE MONITOR SHALL INSPECT THE SITE WITHIN 24 HOURS OF THIS EVENT.
 - c. THE MONITOR SHALL PROVIDE TECHNICAL ASSISTANCE AND RECOMMENDATIONS TO THE CONTRACTOR ON THE APPROPRIATE BEST MANAGEMENT PRACTICES FOR EROSION AND SEDMENT CONTROLS REQUIRED TO MEET THE REQUIREMENTS OF RSA 485 A:17 AND ALL APPLICABLE DES PERMIT CONDITIONS.
 - d. WITHIN 24 HOURS OF EACH INSPECTION, THE MONITOR SHALL SUBMIT A REPORT TO DES VIA EMAIL (RIDGELY MAUCK AT: RIDGELY.MAUCK@DES.NH.GOV).
 - THE MONITOR SHALL MEET WITH DES TO DECIDE UPON A REPORT FORMAT. THE REPORT FORMAT SHALL BE REVIEWED AND APPROVED BY DES PRIOR TO THE START OF CONSTRUCTION.



STONE FOR STABILIZED CONSTRUCTION ENTRANCE SHALL BE 3 INCH STONE, RECLAMED STONE, OR RECYCLED CONCRETE EQUIVALENT.

- THE LENGTH OF THE STABILIZED ENTRANCE SHALL NOT BE LESS THAN 50 FEET, 75' WITHOUT A MOUNTABLE BERM, AND EXCEPT FOR A SINGLE RESIDENTIAL LOT WHERE A 30 FOOT MINIMUM LENGTH

- STONE AS CONDITIONS DEMAND AND REPAIR AND/OR CLEAN OUT OF ANY MEASURES USED TO TRAP SEDMENT, ALL SEDMENT SPILLED, WASHED, OR TRACKED ONTO THE PUBLIC RIGHT-OF-WAY MUST BE REMOVED PROMPILY.

STABILIZED CONSTRUCTION ENTRANCE



CONSTRUCTION SPECIFICATIONS:

-), woven fabric fence to be fastened securely to fence posts with wire ties or staples. Filter cloth shall be fastened to woven wire every 24° at 10p, and AHD Bottom and Embedded in the cround a minimum of 8° and their covered with soil.
- THE FENCE POSTS SHALL BE A MINIMUM OF 48" LONG, SPACED A MAXIMUM TO APART, AND DRIVEN A MINIMUM OF 18" INTO THE GROUND.
- 3. WHEN TWO SECTIONS OF FILTER CLOTH ADJOIN EACH OTHER, THE ENDS OF THE FABRIC SHALL BE OVERLAPPED 6°, FOLDED AND STAPLED TO PREVENT SEDIMENT FROM BY-PASSING. MAINTENANCE SHALL BE PERFORMED AS NEEDED AND SEDIMENT REMOVED AND PROPERLY DISPOSED OF WHEN IT IS 6° DEEP OR VISIBLE "BULGES" DEVELOP IN THE SILT FENCE.
- 6. SELT FENCE SHALL REMAIN IN PLACE FOR 24 MONTHS.

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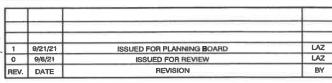
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THIS PLAN SHALL NOT BE MODIFIED WITHOUT WRITTEN

SILT FENCE

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WOLLD APPLY. 3. THIOMESS OF THE STONE FOR THE STABILIZED ENTRANCE SHALL NOT BE LESS THAN 6 INCHES. 4. THE WIDTH OF THE ENTRANCE SHALL NOT BE LESS THAN THE FULL WIDTH OF THE ENTRANCE WHERE NIGHESS OR EXPRESS COLURS, OR 10 FEET, WHICHEVER IS GREATER. 5. GEDTECTILE FILTER FABRIC SHALL BE PLACED OVER THE ENTRIE AREA PRIOR TO PLACING THE STONE. FILTER FABRIC SHOT ROUTED FOR A SINGLE FAMILY RESIDENTIAL LOT. 6. ALL SUFFACE WATER THAT IS FLOWING TO OR DIVERTED TOWARD THE CONSTRUCTION ENTRANCE SHALL BE PROD BENEATH THE ENTRANCE. IF PRIPING IS IMPRACTICAL A STONE BERGW WITH 5:1 SLOPES THAT CONSECUENT OF THE PIPPL. 7. THE ENTRANCE SHALL BE MAINTAINED IN A CONDITION THAT WILL PREVENT TRACKING OR FLOWING OF SEDIMENT ONTO THE PUBLIC RICHT-OF-WAY. THIS MAY REQUIRE PERSONIC TOP DRESSING WITH ADDITIONAL STONE OF COMMENTAGE SHALL BE DEADLED THE OPEN OF THE PIPPL.

DISTURBED AREA (UPHRLL) -MAKENDED MAXIMUM FENCING IS TO RUN WITH THE CONTOURS ACROSS A SLOPE

SILT FENCES SHALL BE REMOVED WHEN NO LONGER NEEDED AND THE SEDIMENT COLLECTED SHALL SE DISPOSED AS DIRECTED BY THE ENGINEER. THE AREA DISTURBED BY THE REMOVAL SHALL BE SMOOTHED AND REVGESTATED.

- SILT FENCES SHALL BE INSPECTED MOMEDIATELY AFTER EACH RAINFALL AND AT LEAST DAILY DURING PROLONGED RAINFALL ANY REPAIRS THAT ARE REQUIRED SHALL BE DONE MIMEDIATELY.
- If the Fabric on a slit fence should decompose or become ineffective during the expected life of the fence, the Fabric shall be replaced promptly.
- 3. SEDIMENT DEPOSITS SHOULD BE INSPECTED AFTER EVERY STORM EVENT. THE DEPOSITS SHOULD BE REMOVED WHEN THEY REACH APPROXIMATELY ONE HALF THE HEIGHT OF THE BARRIER.

SEEDING SPECIFICATIONS

- GRADING AND SHAPING
 A. SLOPES SHALL NOT BE STEEPER THAN 2:1 WITHOUT APPROPRIATE EROSION CONTROL MEASURES AS SPECIFIED ON THE PLANS (3:1 SLOPES OR FLATTER ARE PREFERRED).
 B. WHERE MOMING WILL BE DONE, 3:1 SLOPES OR FLATTER ARE RECOMMENDED.

SEDBED PREPARATION. A. SURFACE AND SEPAGE WATER SHOULD BE DRAINED OR DIVERTED FROM THE SITE TO PREVENT DROWNING OR WINTER KILLING OF THE PLANTS. B. STOKES LARGER THAN 4 NORES AND TRASH SHOULD BE REMOVED BECAUSE THEY INTERFERE WITH SEEDING AND FUTURE MAINTENANCE OF THE AREA. WHERE FEASIBLE, THE SOIL SHOULD BE TILLED TO A DEPTH OF ABOUT 4 NORES TO PREPARE A SEEDINGD AND FERTILIZER AND LIME MIXED INTO HIS SOIL. THE SEEDING AND FOR THE AREA STATEMENT OF THE AREA STATEMEN

- 3. <u>Establishing a stand</u>

 A. Line and fertilizer should be applied prior to or at the time of seeding and incorporated into the soil. Types and amounts of lime and fertilizer should be based on an evaluation of soil tests. When a soil test is not available, the following minimum amounts should be
 - APPLIED:
 AGRICULTURAL LIMESTONE, 2 TONS PER ACRE OR 100 LBS. PER 1,000 SQ.FT.
 WHTROGEN(N), 50 LBS. PER ACRE OR 1.1 LBS. PER 1,000 SQ.FT.
 PHOSPHATE(P205), 100 LBS. PER ACRE OR 2.2 LBS. PER 1,000 SQ.FT.
 - POTASH(K2O), 100 LBS. PER ACRE OR 2.2 LBS. PER 1,000 SQ.FT.
 (NOTE: THIS IS THE EQUIVALENT OF 500 LBS. PER ACRE OF 10-20-20 FERTILIZER OR 1,000 LBS. PER
- ACRE OF 3-10-10.)

 SEED SHOULD BE SPREAD UNIFORMLY BY THE METHOD MOST APPROPRIATE FOR THE SITE. METHODS NOLLDE BROADEASTING, DRILLING AND HYDROSEEDING, WHICE BROADCASTING IS USED, COVER SEED WITH ... 25 INCH OF SOIL OR LESS, BY CALIFRACKING OR RAKING.
- REFER TO THE "SEEDING GUIDE" AND "SEEDING RATES" TABLES ON THIS SHEET FOR APPROPRIATE SEED MIXTURES AND RATES OF SECONG. ALL LEGUMES (CROMN/ETCH, BROSPOOT, TREFOL AND FLATPEA)
 MUST BE INCOLULATED WITH THEIR SPECIFIC INCOLULANT PRIOR TO THEIR INTRODUCTION TO THE SITE.
 WHEN SEEDED AREAS ARE MUCHED, PLANTINGS MAY BE MADE FROM EARLY SPRING TO EARLY, OCTOBER.
 WHEN SEEDED AREAS ARE NOT MULCHED, PLANTINGS SHOULD BE MADE FROM EARLY SPRING TO MAY 20th

4. MULCH

- A. HAY, STRAW, OR OTHER MULCH, WHEN NEEDED, SHOULD BE APPLIED IMMEDIATELY AFTER SEEDING.
 B. MULCH WILL BE HELD IN PLACE USING APPROPRIATE TECHNIQUES FROM THE BEST MANAGEMENT PRACTICE.
 FOR MULCHING, HAY OR STRAW MULCH SHALL BE PLACED AT A RATE OF 90 LBS PER 1000 S.F.
- MANTENANCE TO ESTABLISH A STAND

 A. PLANTED AREAS SHOULD BE PROTECTED FROM DAMAGE BY FIRE, GRAZING, TRAFFIC, AND DENSE WEED
- GROWTH.

 B. FERTILIZATION MEEDS SHOULD BE DETERMINED BY ONSITE INSPECTIONS. SUPPLEMENTAL FERTILIZER IS USUALLY THE KEY TO FULLY COMPLETE THE ESTABLISHMENT OF THE STAND BECAUSE MOST PERDINALS TAKE 2 TO 3 YEARS TO BECOME FULLY STABLISHED.

 C. IN WATERWAYS, CHAMPLES, OR SWALES WHERE UNFORM FLOW CONDITIONS ARE ANTICIPATED, ANNUAL MOWING MAY BE NECESSARY TO CONTROL GROWTH OF WOODY VEGETATION.


USE	SEEDING MIXTURE 1/	DROUGHTY	WELL DRAINED	MODERATELY WELL DRAINED	POORLY DRAINED
STEEP CUTS AND FILLS, BORROW AND DISPOSAL	A B C	FAIR POOR POOR	GOOD GOOD	GOOD FAIR EXCELLENT	FAIR FAIR GOOD
AREAS	Đ	FAIR	EXCELLENT	EXCELLENT	POOR
WATERWAYS, EMERGENC SPILLWAYS, AND OTHER CHANNELS WITH FLOWING WATER.		600D 600D	GOOD EXCELLENT	GOOD EXCELLENT	FAIR FAIR
LIGHTLY USED PARKING LOTS, ODD AREAS, UNUSED LANDS, AND LOW INTENSITY USE RECREATION SITES.	A B C	G000 G000 G000	GOOD EXCELLENT	GOOD FAIR EXCELLENT	FAIR POOR FAIR
PLAY AREAS AND ATHLETIC FIELDS. (TOPSOIL IS ESSENTIAL FOR GOOD TURF.)	E F	FAIR FAIR	EXCELLENT	EXCELLENT	2/2
GRAVEL PIT, SEE NH-PI AND GRAVEL PITS.	4-24 IN APPEN	DIX FOR RECOM	JENDATION REGARD	ONG RECLAMATIC	N OF SAND

1/ REFER TO SEEDING MIXTURES AND RATES IN TABLE BELOW.
27 POORLY DRAINED SOILS ARE NOT DESIRABLE FOR USE AS PLAYING AREA AND ATHLETIC FIELDS.

NOTE: TEMPORARY SEED MIX FOR STABILIZATION OF TURF SHALL BE WINTER RYE OR OATS AT A RATE OF 2.5 US. PER 1000 S.F. AND SHALL BE PLACED PRIOR TO OCTOBER 15th, IF PERMANENT SEEDING NOT YET COMPUTE. SEEDING GUIDE

20 20 2	0.45 0.45
42	0.05
15	0.35
10	0.25
15	0.35
30	0.75
40 OR 55	0.95 OR 1.35
20	0.45
20	0.45
<u>B</u>	0.20
48	1,10
20	0.45
30	0.75
50	1.20
50	1.15
50	1.15
100	2.30
150	3.60
	10 10 10 40 0R 55 20 20 20 8 48 20 30 50 50

SEEDING RATES

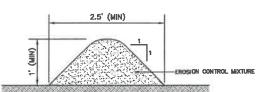

NOTES:

- 1. ORGANIC FILTER BERMS MAY BE UTILIZED IN LIEU OF SILT FENCE, UNLESS OTHERWISE SPECIFIED.
- THE EROSION CONTROL MIX USED IN THE FILTER BERMS SHALL BE A WELL-GRADED MIXTURE OF PARTICLE SIZES, MAY CONTAIN ROCKS LESS THAM 4" IN DIAMETER, STUMP GRINDINGS, SHREDDED OR COMPOSTED BARK, OR ACCEPTABLE MANUFACTURED PRODUCTS, AND SHALL BE FREE OF REFUSE, PHYSICAL CONTAMBNANTS, AND MATERIAL TOXIC TO PLANT GROWTH, AND SHALL MEET THE FOLLOWING STANDARDS:
- a) THE ORGANIC CONTENT SHALL BE 80-100% OF DRY WEIGHT.
 b) PARTICLE SIZE BY WEIGHT SHALL BE 100% PASSING A 6" SCREEN, AND 70-85% PASSING A 0.75" SCREEN.
 C) THE ORGANIC PORTION SHALL BE FIBROUS AND ELONGATED.
 d) LARGE PORTIONS OF SILTS, CLAYS, OR FINE SANDS SHALL NOT BE INCLIDED IN THE MIXTURE.

- a) SOLUBLE SALTS CONTENT SHALL BE >4.0mmhos/cm.
 f) THE pH SHALL BE BETWEEN 5.0 AND 8.0.
- 4. ON SLOPES LESS THAN 5%, OR AT THE BOTTOM OF SLOPES STEEPER THAN 3-1, UP TO 20' LONG, THE BERN SHALL BE A MINIMUM OF 12" HIGH (AS MEASURED ON THE UPHILL SIDE), AND A MINIMUM OF 36" WIDE. ON LONGER OR STEEPER SLOPES, THE BERM SHALL BE WIDER TO ACCOMMISCIATE THE POTENTIAL ADDITIONAL RUNOFF.
- FROZEN GROUND, OUTCROPS OF BEDROCK, AND VERY ROOTED FORESTED AREAS PRESENT THE MOST PRACTICAL AND EFFECTIVE LOCATIONS FOR GREANIC FILTER BENNES. OTHER BIP'S SHOULD BE USED AT LOW POINTS OF CONCENTRATE RUNDET, BELOW CULVERT OUTLET ARRONS, AROUND CATCH BASINS, AND AT THE BOTTOM OF STEEP PERMETER SLOPES THAT HAVE A LARGE CONTRIBUTING AREA.
- SEDBHENT SHALL BE REMOVED FROM BEHIND THE STRUCTURES WHEN IT HAS ACCUMULATED TO ONE HALF THE ORIGINAL HEIGHT OF THE STRUCTURE.
- 7. STRUCTURES MAY BE LEFT IN PLACE ONCE THE SITE IS STABILIZED

ORGANIC FILTER BERM

- CONSTRUCTION SEQUENCE

 1. PRIOR TO THE START OF ANY ACTIVITY, IT IS THE RESPONSIBILITY OF THE SITE'S SITE DEVELOPER (OR OWNER) TO FILE A NOTICE OF MITENT (NOT) FORM WATER DISCHARGES FROM CONSTRUCTION AGENCY (EPA) IN ORDER TO GAIN COVERAGE UNDER THE INPOES GENERAL PERMIT FOR STORM WATER DISCHARGES FROM CONSTRUCTION ACTIVITIES. A PRE CONSTRUCTION MEETING IS TO BE HELD WITH ALL DEPARTMENT HEADS PRIOR TO THE START OF CONSTRUCTION.
- WETLAND BOUNDARIES ARE TO BE CLEARLY MARKED PRIOR TO THE START OF CONSTRUCTION. AT LEAST A TEMPORARY CULVERY OR ROADBED TO BE IN PLACE PRIOR TO THE START OF CONSTRUCTION.
- 3. CUT AND REMOVE TREES IN CONSTRUCTION AREA AS REQUIRED OR DIR
- INSTALL SILT FENCING, HAY BALES AND CONSTRUCTION ENTRANCES PRIOR TO THE START OF CONSTRUCTION. THESE ARE TO BE MAINTAINED UNTIL THE FINAL PAVEMENT SURFACING AND LANDSCAPING AREAS ARE ESTABLISHED.
- 5. CLEAR, CUT, GRUB AND DISPOSE OF DEBRIS IN APPROVED FACILITIES. THIS INCLUDES ANY REQUIRED DEMOLITION OF EXISTING STRUCTURES, UTILITIES, ETC.
- CONSTRUCT AND/OR INSTALL TEMPORARY OR PERMANENT SEDIMENT AND/OR DETENTION BASIN(S) AS REQUIRED. THESE FACILITIES SHALL BE INSTALLED AND STABILIZED PRIOR TO DIRECTING RUN—OFF TO THEM.
- STRIP LOAM AND PAVEMENT, OR RECLAIM EXISTING PAVEMENT WITHIN LIMITS OF WORK PER THE RECOMMENDATIONS OF THE PROJECT ENGINEER AND STOCKPILE EXCESS MATERIAL. STABILIZE STOCKPILE AS NECESSARY.
- 8. PERFORM PREJUMNARY SITE GRADING IN ACCORDANCE WITH THE PLANS, INCLUDING THE CONSTRUCTION OF ANY RETAINING WALLS.

 AND SOUND WALLS.
- 9. PREPARE BUILDING PAD(S) TO ENABLE BUILDING CONSTRUCTION TO BEGIN.
- 10. INSTALL THE SEWER AND ORAMAGE SYSTEMS FIRST, THEN ANY DITHER UTILITIES IN ACCORDANCE WITH THE PLAN AND DETAILS. ANY CONFLICTS BETWEEN UTILITIES ARE TO BE RESOLVED WITH THE INVOLVEMENT AND APPROVAL OF THE ENGINEER.
- 11. INSTALL INLET PROTECTION AT ALL CATCH BASINS AS THEY ARE CONSTRUCTED IN ACCORDANCE WITH DETAILS
- 12. ALL SWALES AND ORAINAGE STRUCTURES ARE TO BE CONSTRUCTED AND STABILIZED PRIOR TO HAVING RUN-OFF DIRECTED TO THEM.
- DALY, OR AS REQUIRED, CONSTRUCT TEMPORARY BERMS, DRAINAGE DITCHES, CHECK DAMS, SEDIMENT TRAPS, ETC., TO PREVENT EROSION ON THE SITE AND PREVENT ANY SILITATION OF ABUTTING WATERS AND/OR PROPERTY.
- 14. PERFORM FINAL FINE GRADING, INCLUDING PLACEMENT OF "SELECT" SUBGRADE MATERIALS
- 15. PAVE ALL PARKING LOTS AND ROADWAYS WITH INITIAL BASE COURSE
- 16. PERFORM ALL REMAINING SITE CONSTRUCTION (Le. BUILDING, CURBING, UTILITY CONNECTIONS, ETC.).
- LOAM AND SEED ALL DISTURBED AREAS AND INSTALL ANY REQUIRED SEDIMENT AND EROSION CONTROL FACILITIES (Lo. RIP RAP, EROSION CONTROL BLANCETS, ETC.).
- 18. FINISH PAYING ALL ROADWAYS AND PARKING AREAS WITH 'FINISH' COURSE
- 20. ALL CUT AND FILL SLOPES SHALL BE SEEDED/LOAMED WITHIN 72 HOURS OF ACHIEVING FINISHED GRADE
- REMOVE TEMPORARY EROSION CONTROL MEASURES AFTER SEEDING AREAS HAVE BEEN 75%-85% ESTABLISHED AND SITE IMPROVEMENTS ARE COMPLETE. SMOOTH AND RE-VEGETATE ALL DISTURBED AREAS.
- 23. CLEAN SITE AND ALL DRAINAGE STRUCTURES, PIPES AND SUMPS OF ALL SILT AND DEBRIS
- 24. INSTALL ALL PAINTED PAVEMENT MARKINGS AND SIGNAGE PER THE PLANS AND DETAILS.
- 25. ALL EROSION CONTROLS SHALL BE INSPECTED WEEKLY AND AFTER EVERY HALF-INCH OF RAINFALL
- 26. Upon completion of construction, it is the responsibility of the contractor to notify any relevant permitting agencies that the construction has been finished in a satisfactory manner.

PRELIMINARY NOT FOR CONSTRUCTION

EROSION AND SEDIMENT CONTROL DETAILS

WADLEIGH ROAD APARTMENTS ROCHESTER, NH Project: SSG, LLC ATTN: FENTON GROEN 120 WASHINGTON STREET, ROCHESTER, NH 03839

Owner of Record:

SHEET 22 OF 22 JBE PROJECT NO.21137

DRAWING No

Designed and Produced in NH

Jones & Beach Engineers, Inc.

85 Portsmouth Ave. Civil Engineering Services PO Box 219 E-MAIL: JBE@JONESANDBEACH.COM