
OCTOBER 2020


SHEET INDEX

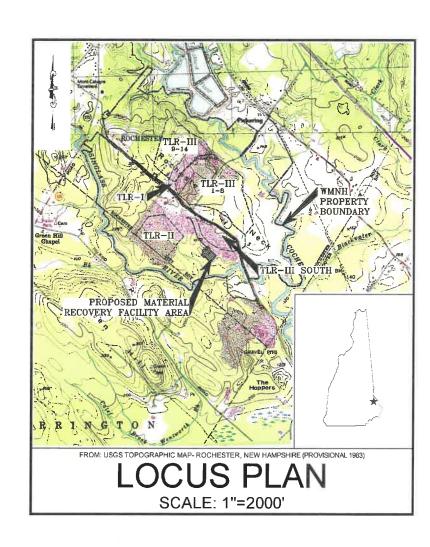

S	HEET NO.	TITLE
<u> </u>	1	NOTES, ABBREVIATIONS, AND LEGEND
	2	OVERALL SITE PLAN
	3	EXISTING CONDITIONS PLAN
	4	SITE DEVELOPMENT PLAN
<u> </u>	5	EROSION AND SEDIMENT CONTROL AND DEMOLITION PLAN
	6	CIRCULATION, PARKING, AND SIGNAGE PLAN
Æ	7	OVERHEAD ELECTRIC AND WATER DISTRIBUTION PLAN AND PROFILE
	8	STORMWATER, UTILITIES, AND LIGHTING PLAN
	9	EAST STORMWATER BASIN MAINTENANCE PLAN
	10	TRUCK SCALE PLAN
	11	RETAINING WALL A PLAN AND PROFILE
É	12	BUILDING FLOOR PLAN
È	13-14	BUILDING ELEVATIONS
Â	15	EROSION AND SEDIMENT CONTROL NOTES AND DETAILS
	16-18	STORMWATER INFRASTRUCTURE DETAILS
	19	ROOF DRAIN PLAN AND DETAILS
Æ	20	WATER SUPPLY AND FIRE HYDRANT DETAILS
	21-24	MISCELLANEOUS DETAILS, SECTIONS, AND PROFILES
Â	25	POTENTIAL THREATENED OR ENDANGERED SPECIES FLYERS



	REVISION TABLE					
4	03/19/21	RESPONSE TO SITE PLAN COMMENTS AND	LCT			
		FINALIZED BUILDING LAYOUT				
Δ\	2/05/21	REVISED TO ADDRESS NH FISH AND GAME COMMENTS	DJD			
δ\ c	11/09/20	ISSUED FOR SITE PLAN APPROVAL	APM			
₽.	11/03/20	ISSUED FOR NHDES PERMITTING.	APM			
Á	10/23/20	ISSUED FOR BIDDING.	DND			
10.	DATE	DESCRIPTION	BY			

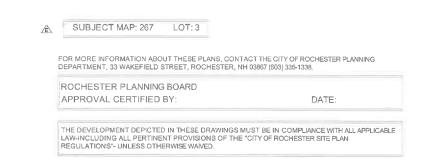

SEE THE NATURAL RESOURCES NOTES ON SHEETS 1 AND 5 FOR INFORMATION REGARDING THREATENED AND **ENDANGERED WILDLIFE**





WASTE MANAGEMENT OF NEW HAMPSHIRE, INC.

14 TAYLOR AVENUE, ROCHESTER, NEW HAMPSHIRE

WASTE MANAGEMENT

PREPARED FOR:

20 FOUNDRY STREET, CONCORD, NEW HAMPSHIRE 03301 (603) 229-1900 FAX (603) 229-1919

 EXISTING TOPOGRAPHY AND SITE FEATURES WERE PROVIDED TO SANBORN HEAD IN ELECTRONIC FILES
TITLED, "TREE19-01.DWG" "THROUGH" ITREE19-12.DWG" COMPILED USING PHOTOGRAMMETRIC METHODS BY
QUANTUM SPATIAL OF DULLES, VIRGINIA FOR WASTE MANAGEMENT OF NEW HAPPHIRE, INC. (WMNH) USING AERIAL PHOTOGRAPHY DATED MAY 25, 2019 AT AN ORIGINAL SCALE OF 1" = 100' AND CONTOUR INTERVAL OF 2

3. VERTICAL DATUM IS BASED ON NGVD 1929. GRID IS BASED ON NEW HAMPSHIRE STATE PLANE COORDINATE

WETLANDS ADJACENT TO THE PROJECT AREA WERE DELINEATED BY GOVE ENVIRONMENTAL SERVICES, INC. IN

WE ILANDS ADJACENT TO THE PROJECT AREA WERE DELINEATED BY GOVE ENVIRONMENTAL SERVICES, INC. IN OCTOBER OF 2019 AND APRIL OF 2020 UTILIZING THE FOLLOWING STANDARDS:
 REGIONAL SUPPLEMENT TO THE CORPS OF ENGINEERS WETLAND DELINEATION MANUAL: NORTHCENTRAL AND NORTHEAST REGION, (VERSION 2.0) JANUARY 2012, U.S. ARMY CORPS OF ENGINEERS.
 FIELD INDICATORS OF HYDRIC SOILS IN THE UNITED STATES, A GUIDE FOR IDENTIFYING AND DELINEATING HYDRIC SOILS, VERSION 8.0. UNITED STATES DEPARTMENT OF AGRICULTURE (2016).
 C. NEW ENGLAND HYDRIC SOILS TECHNICAL COMMITTEE, 2018 VERSION 4, FIELD INDICATORS FOR IDENTIFYING

HYDRIC SOILS IN NEW ENGLAND. NEW ENGLAND INTERSTATE WATER POLLUTION CONTROL COMMISSION,

LOWELL, MA. NATIONAL WETLAND PLANT LIST, VERSION 3.2 (2016).

E. CLASSIFICATION OF WETLANDS AND DEEPWATER HABITATS OF THE UNITED STATES. USFW MANUAL

5. WETLANDS NOT IMMEDIATELY ADJACENT TO THE PROJECT AREA REPRESENT A COMPILATION OF INFORMATION OBTAINED USING EXISTING AERIAL PHOTOGRAPHY, SOILS INFORMATION, U.S.F.W.S. NATIONAL WETLAND INVENTORY MAPS, AND DELINEATIONS PERFORMED IN OCTOBER AND DECEMBER 2014 AND SUPPLEMENTED WITH ADDITIONAL DELINEATIONS PERFORMED BETWEEN SEPTEMBER 2000 AND JUNE 2015 BY BARRY H, KETH, NH CWS #087, IN ACCORDANCE WITH NHWB ADMINISTRATIVE RULE WT 301.01 (A-C) USING THE METHODS OUTLINED IN THE CORPS OF ENGINEERS WETLAND DELINEATION MANUAL, TECHNICAL REPORTY-87-1 (JANUARY 1987) AND FIELD IDENTIFYING HYDRIC SOILS IN NEW ENGLAND (VERSION II) PUBLISHED BY THE NE. INTERSTATE WATER POLLUTION CONTROL COMMISSION. WETLAND AREAS WERE CLASSIFIED IN ACCORDANCE WITH NHWB ADMINISTRATIVE RULE WT 301.02 USING THE USFWS/OBS-79/31 MANUAL CLASSIFICATION OF WETLANDS AND DEEPWATER HABITATS OF THE UNITED STATES (COWARDIN ET AL, 1979).

THE 100-YEAR AND 500-YEAR FLOODPLAINS ARE BASED ON INFORMATION PROVIDED ON THE FEDERAL EMERGENCY MANAGEMENT AGENCY (FEMA) "FLOOD INSURANCE RATE MAP, STRAFFORD COUNTY, NEW HAMPSHIRE" PANEL 302 OF 405, LAST REVISED ON SEPTEMBER 30, 2015.

7. PROPERTY LINE INFORMATION WAS TAKEN FROM THE FOLLOWING:
A. A PLAN TITLED, "BOUNDARY COMPILATION AND FOOTPRINT COMPILATION OF TLR-I AND TLR-III, ROCHESTER NECK ROAD, ROCHESTER, NEW HAMPSHIRE" PREPARED FOR WASTE MANAGEMENT OF NEW HAMPSHIRE, INC. BY CHAS. H. SELLS, INC. OF NASHUA, NEW HAMPSHIRE DATED JANUARY 29, 2002 AT A SCALE OF 1" = 300.

B. A PLAN TITLED, "PLAN OF LAND, 36 ROCHESTER NECK ROAD, ROCHESTER, NEW HAMPSHIRE (MAP 262, LOT 23)"

PREPARED BY WSP USA, INC. OF NASHUA, NEW HAMPSHIRE DATED OCTOBER 2, 2018 AT A SCALE OF 1"=80".

C. ELECTRONIC (AUTOCAD) TAX MAP FILES CREATED BY CAI TECHNOLOGIES OF LITTLETON, NEW HAMPSHIRE,

D. PLANS TITLED "ROCHESTER NECK ROAD DISCONTINUANCE PLAN" AND "ROCHESTER NECK ROAD RELOCATION," BOTH DATED SEPTEMBER 29, 2020, PREPARED FOR WMNH BY WSP USA, INC. OF MERRIMACK

E. A PLAN TITLED "PROPOSED CONDITIONS PLAN, PARCELS 267-3 & 267-4 LOT LINE REVISION," DATED AUGUST 2020 AND REVISED OCTOBER 2020, PREPARED FOR WMNH BY SANBORN HEAD.

8. ZONING INFORMATION IS BASED ON A PLAN TITLED "CITY OF ROCHESTER, ZONING MAP" ADOPTED APRIL 14, 2014 AND LAST AMENDED FEBRUARY 6, 2018.

9. THE EXISTING UTILITIES SHOWN ON THESE PLANS DO NOT REPRESENT A COMPLETE COMPILATION OF ALL UTILITIES INSTALLED AT THE SITE. THE CONTRACTOR SHALL COORDINATE WITH WMNH TO REVIEW ALL AS-BUILT DRAWINGS PRIOR TO EXCAVATING WILL BE REPAIRED PROMPTLY BY THE CONTRACTOR AT NO COST TO WMNH.

DESIGN NOTES

THE CONTRACTOR IS RESPONSIBLE FOR CONTACTING DIG SAFE PRIOR TO INITIATING EXCAVATION

THE CONTRACTOR SHALL COORDINATE WITH WMNH TO REVIEW ALL AS-BUILT DRAWINGS TO LOCATE EXISTING UTILITIES PRIOR TO EXCAVATING. DAMAGE CAUSED TO EXISTING UTILITIES DURING CONSTRUCTION WILL BE REPAIRED PROMPTLY BY THE CONTRACTOR AT NO COST TO WMNH.

THE CONTRACTOR IS RESPONSIBLE FOR OBTAINING ALL REQUIRED CONSTRUCTION PERMITS NOT ALREADY

NATURAL RESOURCES NOTES (COMPLIES WITH ENV-WQ 1503.19 (H))

1. AVOID TREE CLEARING FROM JUNE 1 TO JUNE 30.

WELDED PLASTIC OR "BIODEGRADABLE PLASTIC" NETTING OR THREAD (e.g., POLYPROPYLENE) IN EROSION CONTROL MATTING SHALL NOT BE USED. THE USE OF EROSION CONTROL BERM, WHITE FILTREXX DEGRADABLE WOVEN SILT SOCK OR WOVEN ORGANIC MATERIALS (e.g. CCCO OR JUTE MATTING SUCH AS NORTH AMERICAN GREEN SC150BN) SHALL BE USED, SEE SHEET 15 FOR DETAILS.

CONTRACTOR SHALL BE AWARE OF THE POTENTIAL FOR THREATENED AND ENDANGERED SPECIES WITHIN THE PROJECT AREA, SPECIFICALLY THE NORTHERN BLACK RACER SNAKE AND WOOD TURTLES. SEE SHEET 25 FOR ADDITIONAL INFORMATION ON IDENTIFICATION. OBSERVATION OF THESE THREATENED OR ENDANGERED SPECIES SHALL BE REPORTED TO NHEG VIA EMAIL TO RAAPP@WILDLIFE.NH GOV AND MELISSA.DOPERSLSKI@WILDLIFE.NH.GOV. EMAIL SUBJECT LINE ROCHESTER MATERIALS RECOVERY FACILITY NHB20-1358, PHOTOGRAPHS SHALL BE PROVIDED FOR VERIFICATION AS FEASIBLE, NHEG SHALL BE CONTACTED IMMEDIATELY IF ANY SPECIES ARE OBSERVED TO BE NESTING OR MAY POSSIBLY BE NESTING.

IF ANY THREATENED OR ENDANGERED SPECIES ARE OBSERVED WITHIN THE DISTURBANCE AREA AND IT IS SAFE TO DO SO, MOVE TO THE CLOSEST LOCATION IN THE DIRECTION THE WERE HEADING AND CONTACT NHFG MELISSA DOPERALSKI TEXT OR PHONE 603-479-1129 OR CONTACT THE NHFG WILDLIFE ADMINISTRATOR AT 603-271-2461, INCLUDE PHOTOGRAPH AS FEASIBLE.

5. NHFG SHALL HAVE ACCESS TO THE PROPERTY DURING THE TERM OF THE PERMIT

6. NO PESTICIDES SHALL BE USED IN LANDSCAPING

FOR MORE INFORMATION ABOUT THESE PLANS, CONTACT THE CITY OF ROCHESTER PLANNING DEPARTMENT, 33 WAKEFIELD STREET, ROCHESTER, NH 03867 (603) 335-1338.

ROCHESTER PLANNING BOARD APPROVAL CERTIFIED BY

DATE

CONSTRUCTION SEQUENCE

THE FOLLOWING SCHEDULE IS NOT INTENDED TO PRESENT A DETAILED REPRESENTATION OF THE WORK TO BE PERFORMED BY THE CONTRACTOR. THE FOLLOWING SCHEDULE OUTLINES THE SIGNIFICANT ASPECTS OF THE PROJECT IN AN ORDER THAT SHOULD BE CONSIDERED BY THE CONTRACTOR WHEN SCHEDULING THE WORK. THE ACTUAL SCHEDULE AND ORDER OF WORK SHALL BE DEVELOPED BY THE CONTRACTOR AND SUBMITTED TO THE ENGINEER AND WMNH FOR REVIEW AND APPROVAL. THE SCHEDULE SHALL BE BASED ON THE PROJECT COMPONENTS, AS DEFINED IN THE DRAWINGS AND SPECIFICATIONS AND INTENDED TO COMPLY WITH ALLLOCAL, STATE, AND FEDERAL REQUIREMENTS.

1. MOBILIZE TO SITE AND ESTABLISH VERTICAL AND HORIZONTAL CONTROL FOR THE PROJECT

2. INSTALL EROSION AND SEDIMENT CONTROL MEASURES.

3. PERFORM MAINTENANCE ACTIVITIES FOR THE EAST BASIN

4. CLEAR AND GRUB, STRIP AND STOCKPILE TOPSOIL, AND RECLAIM PAVEMENT AND GRAVELS.

5. INSTALL WATER MAIN FROM THE TURBINE PLANT

6. CUT EXISTING SOIL AND PLACE SOIL TO ESTABLISH SUBGRADE. CONSTRUCT RETAINING WALLS. INSTALL SUBSURFACE UTILITIES.

7. INSTALL GRAVELS AND PAVEMENTS

8. INSTALL SCALE, GUARDRAIL, FENCE, AND LITTER FENCE.

REMOVE EROSION CONTROLS ONCE SLOPES ARE STABILIZED

10. PREPARE AS-BUILT DRAWINGS.

11. DEMOBILIZE FROM THE SITE

ABBREVIATIONS

Ø	DIAMETER	MRF	MATERIALS RECOVERY FACILITY
%	PERCENT	N	NORTHING, NORTH
ASS'Y	ASSEMBLY	OD	OUTER DIAMETER
CB	CATCH BASIN	OZ/YD	OUNCE PER SQUARE YARD
CMP	CORRUGATED METAL PIPE	PSI	POUNDS PER SQUARE INCH
CPP	CORRUGATED POLYETHYLENE PIPE	PVC	POLYVINYL CHLORIDE
DMH	DRAIN MANHOLE	REQ'D	REQUIRED
DPW	DEPARTMENT OF PUBLIC WORKS	SCH	SCHEDULE
Е	EASTING, EAST	S	SOUTH .
EL.	ELEVATION	STA	STATION
GA.	GAUGE	SQ	SQUARE
HDPE	HIGH DENSITY POLYETHYLENE	SY	SQUARE YARD
INV	INVERT	TLR	TURNKEY LANDFILL OF ROCHESTER
MAX	MAXIMUM	TYP	TYPICAL
MIN	MINIMUM	W	WEST

LEGEND

EXISTING CONDITIONS

	LIMIT OF WASTE CONTAINMENT
	PROPERTY LINE
• • • • • • • • • • • • • • • • • • • •	TLR-I LIMIT OF WASTE CONTAINME
	2-FOOT ELEVATION CONTOUR
180	10-FOOT ELEVATION CONTOUR
	EDGE OF ROAD
	UNPAVED ROAD
_ · _ ·	LIMIT OF WETLANDS
	EDGE OF WATER
x x	FENCE
AVANCANANANA	TREE LINE
	GUARDRAIL
NG NG	NATURAL GAS LINE
OE	OVERHEAD ELECTRIC
	DRAINAGE CULVERT
(////////	WETLAND AREA
	RIPRAP-LINED SWALE
	PAVEMENT
1/2	UTILITY POLE
	POST
5	MISC. OBJECT
	SIGN
2	LIGHT POST

PROPOSED CONDITIONS

	LIMIT OF DISTURBANCE
	SLOPE BREAK
182	2-FOOT ELEVATION CONTOUR
180	10-FOOT ELEVATION CONTOUR
	EDGE OF GRAVEL
- c — c — c — c — c —	SEDIMENT FILTER LOG
	GUARDRAIL
x x x x x	FENCE
w w	WATER MAIN
OE OE	OVERHEAD ELECTRIC (BY OTHERS
UE UE	UNDERGROUND ELECTRIC
D D	DRAINAGE CULVERT
Ø·······	LITTER FENCE
—— FO —— FO ——	FIBER OPTICS CABLE
~~~~~~~~~~~~~~~~~~~~~~~~~~~~~~~~~~~~~~~	TREE LINE
C-1	DRAINAGE CULVERT DESIGNATION
	PAVEMENT
	RIPRAP
<del>-8</del> -	LIGHT
2.0%	SLOPE AND DIRECTION
× 159.00	SPOT ELEVATION

SUBJECT MAP: 267

SANBORN HEAD

SCALE: AS NOTED

REVISED TO ADDRESS NH FISH AND GAME COMMENTS DJD APM 11/09/20 ISSUED FOR SITE PLAN APPROVAL 11/03/20 ISSUED FOR NHDES PERMITTING APM 10/23/20 ISSUED FOR BIDDING APM

DRAWN BY: D. DOMBROWSKY DESIGNED BY: A. MATTHEWS REVIEWED BY: E. STEINHAUSER

PROJECT MGR: L. DAMIANO PIC: E. STEINHAUSER DATE: OCTOBER 2020


CONSTRUCTION DRAWINGS ROCHESTER MATERIALS RECOVERY FACILITY WASTE MANAGEMENT OF NEW HAMPSHIRE, INC. ROCHESTER, NEW HAMPSHIRE


PROJECT NUMBER 4694.00


LOT: 3


NOTES, ABBREVIATIONS, AND LEGEND


SHEET NUMBER: 1 OF 25

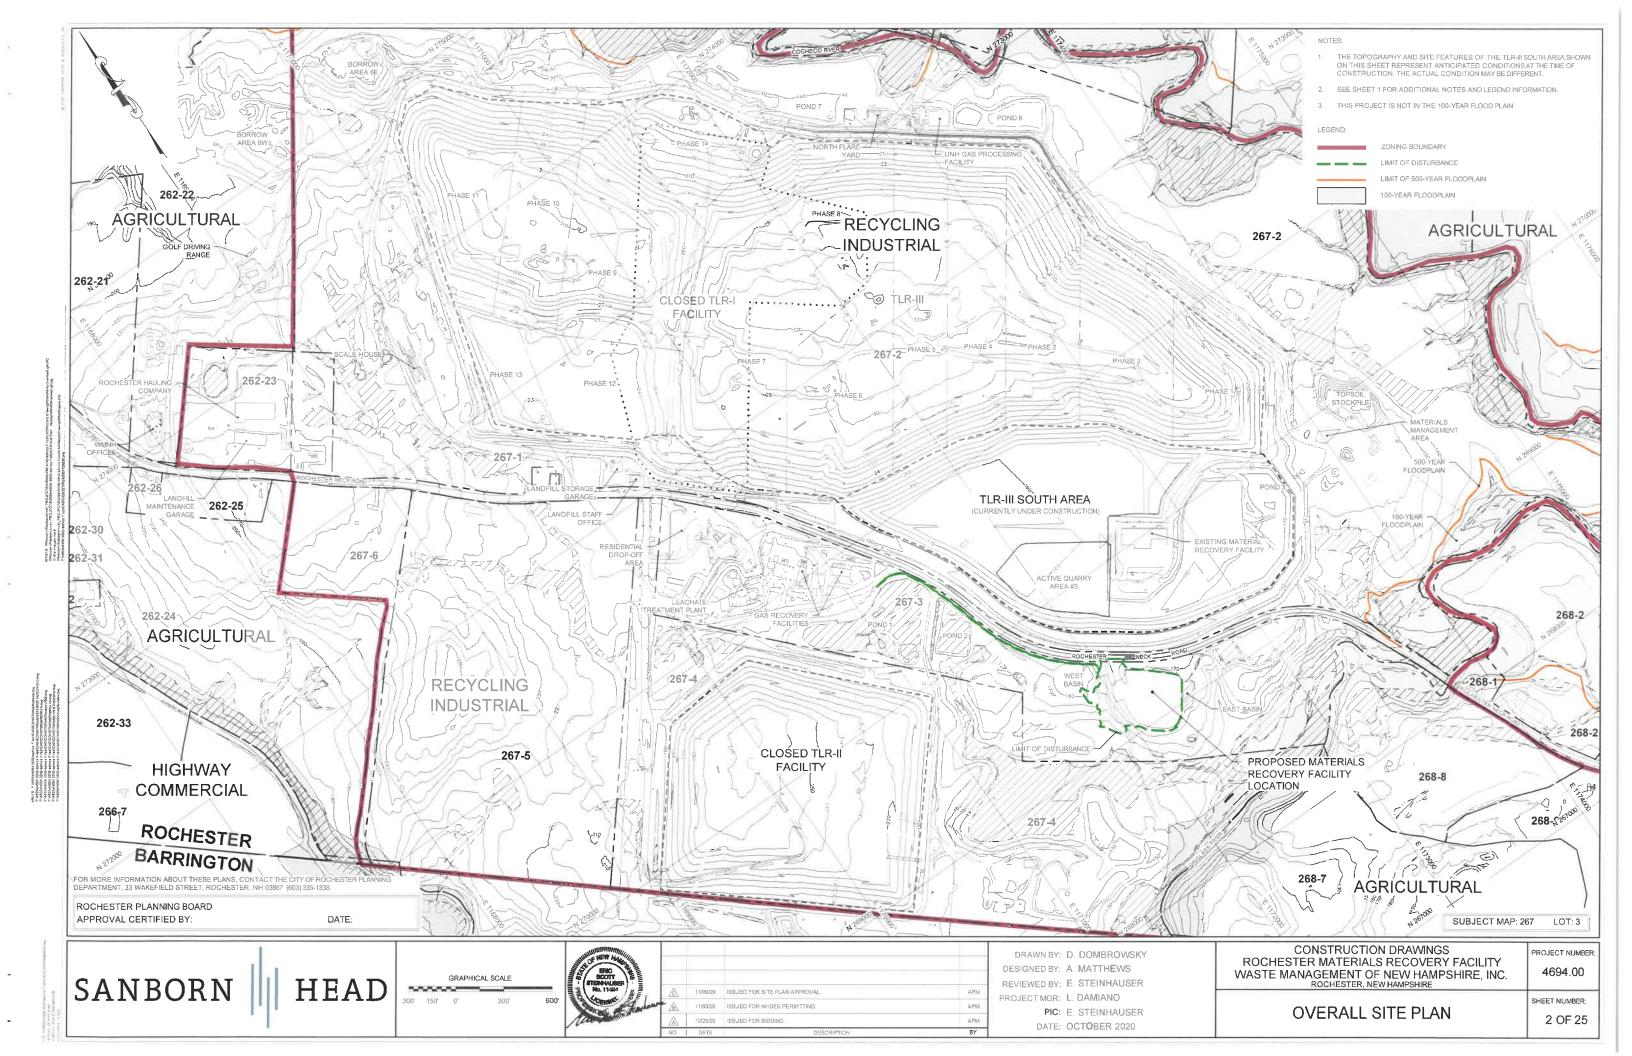


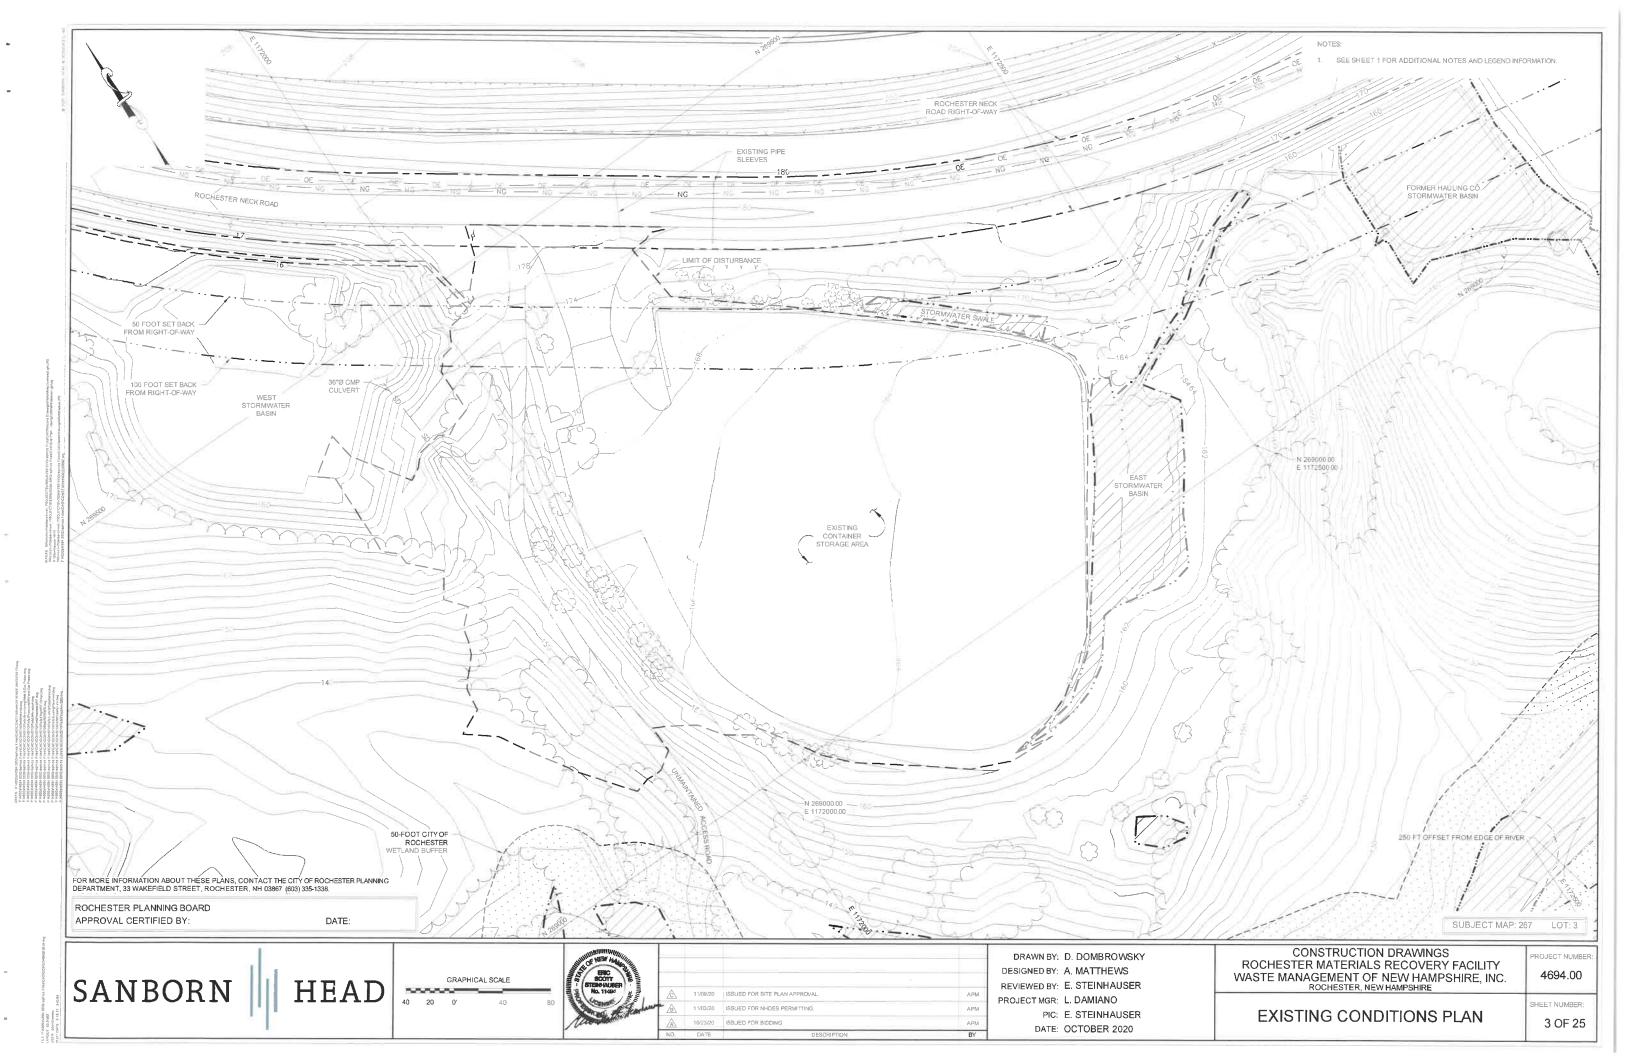


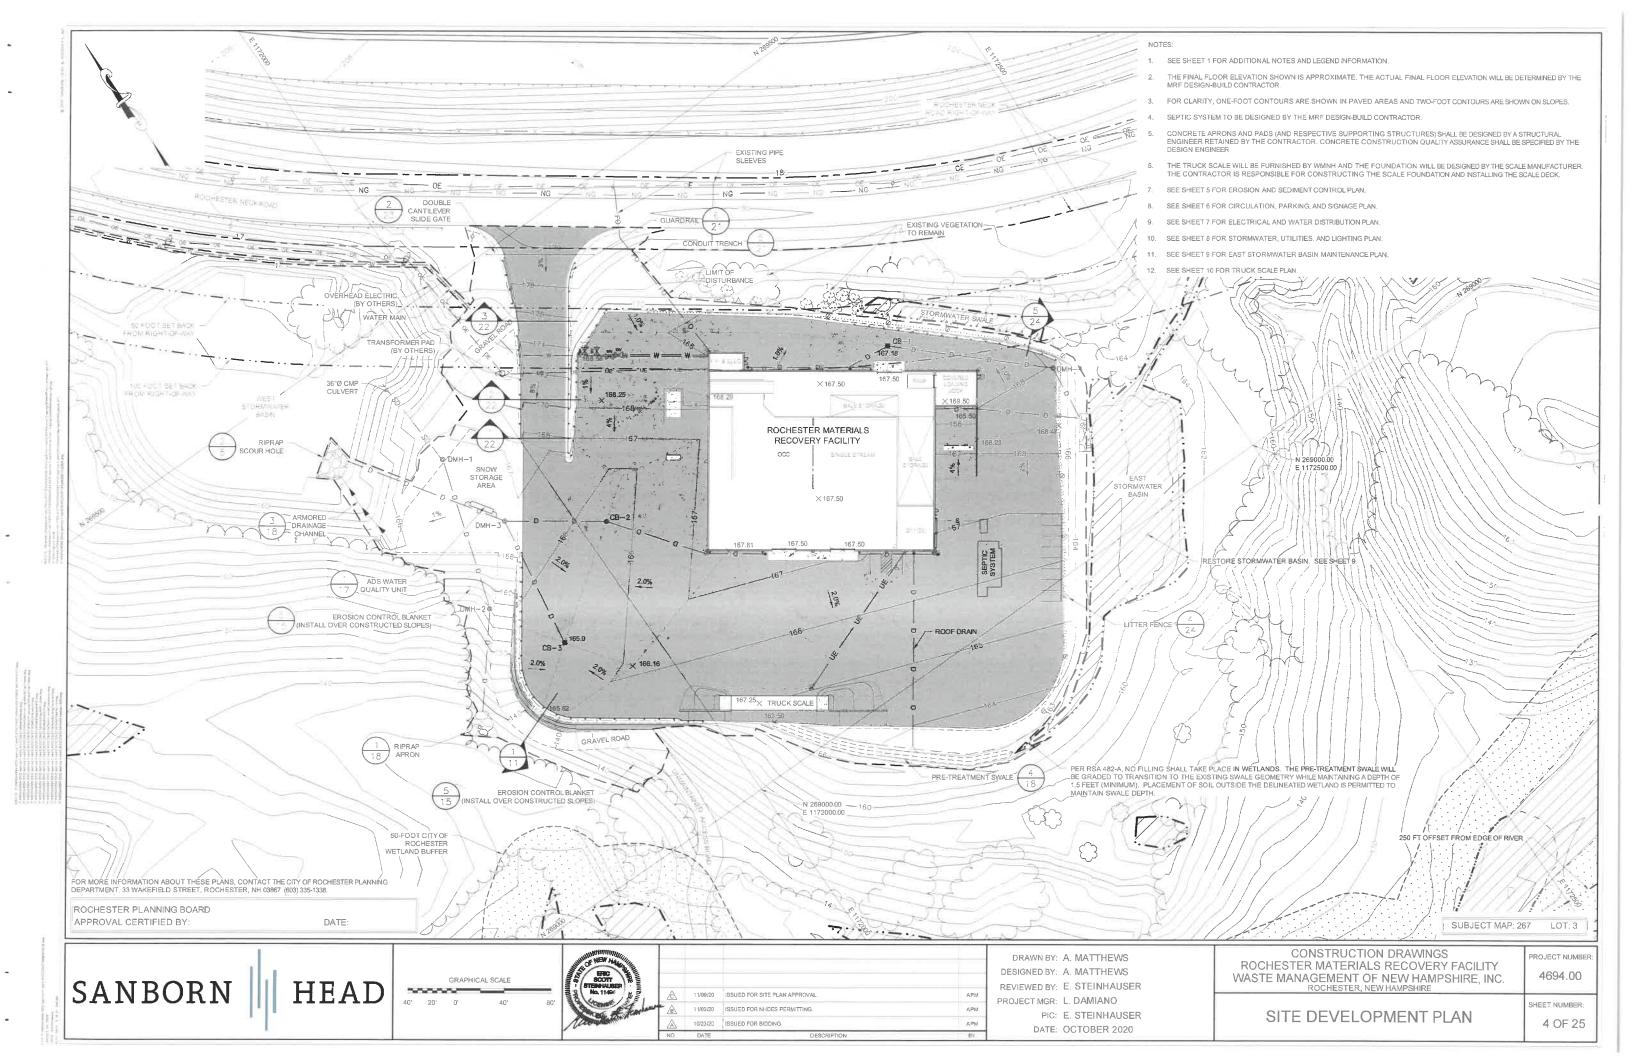


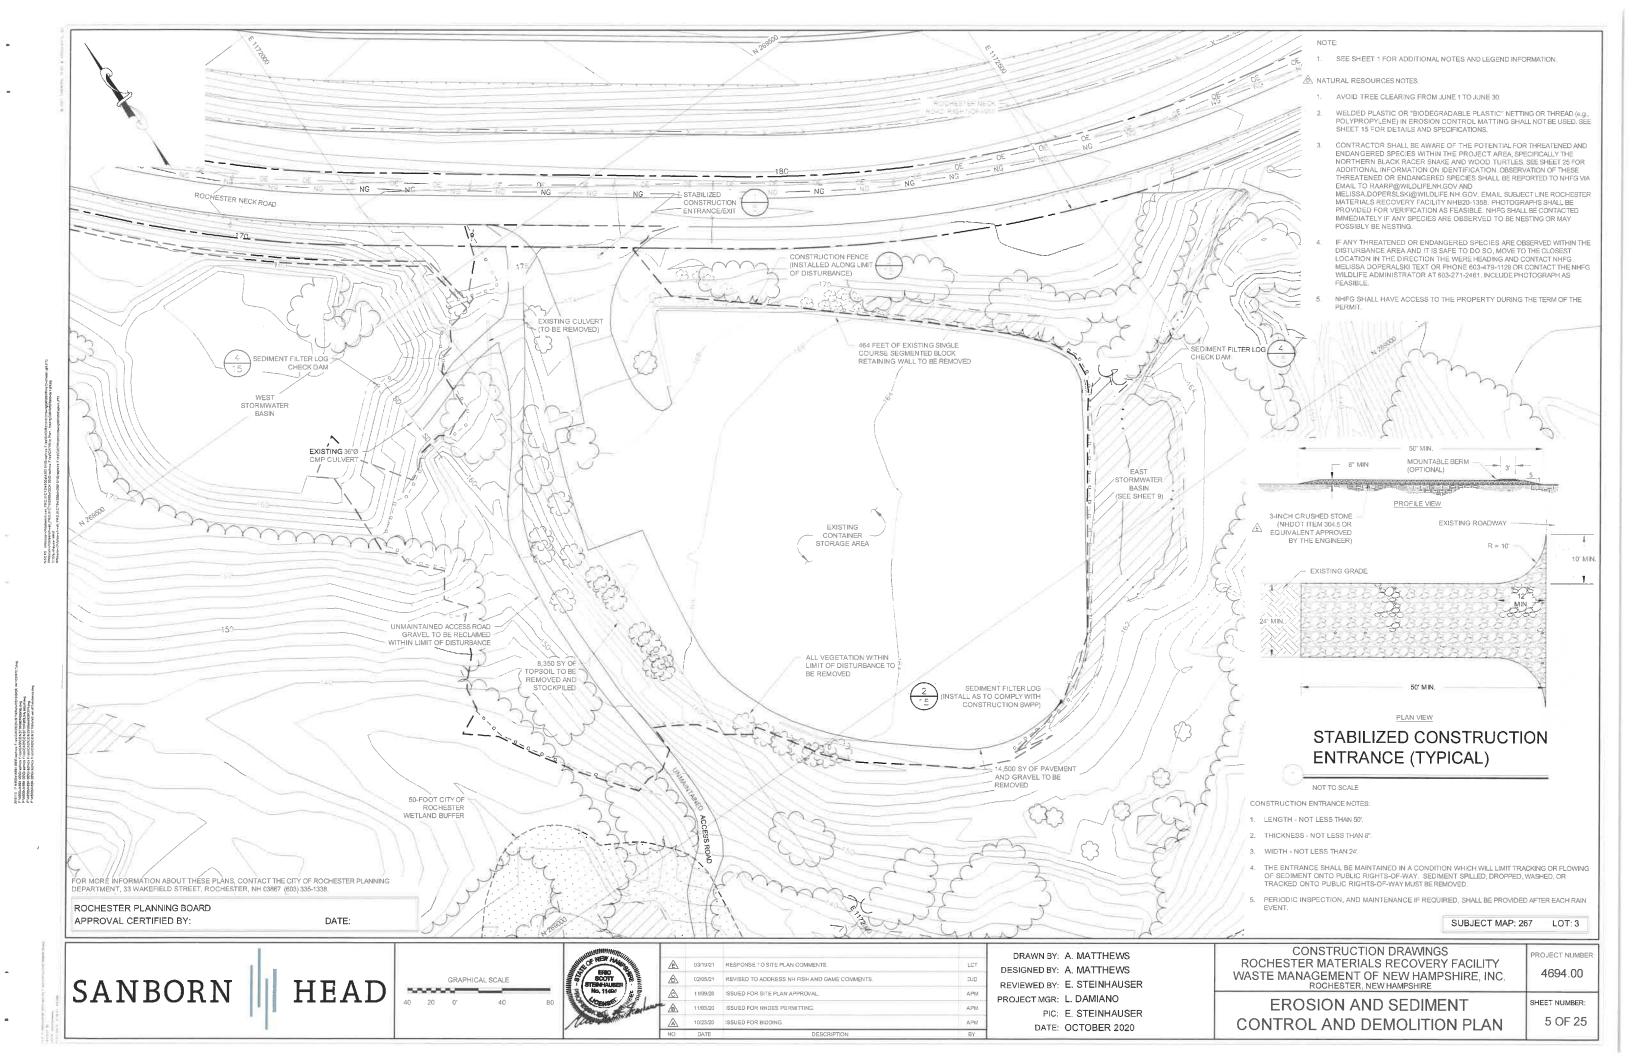


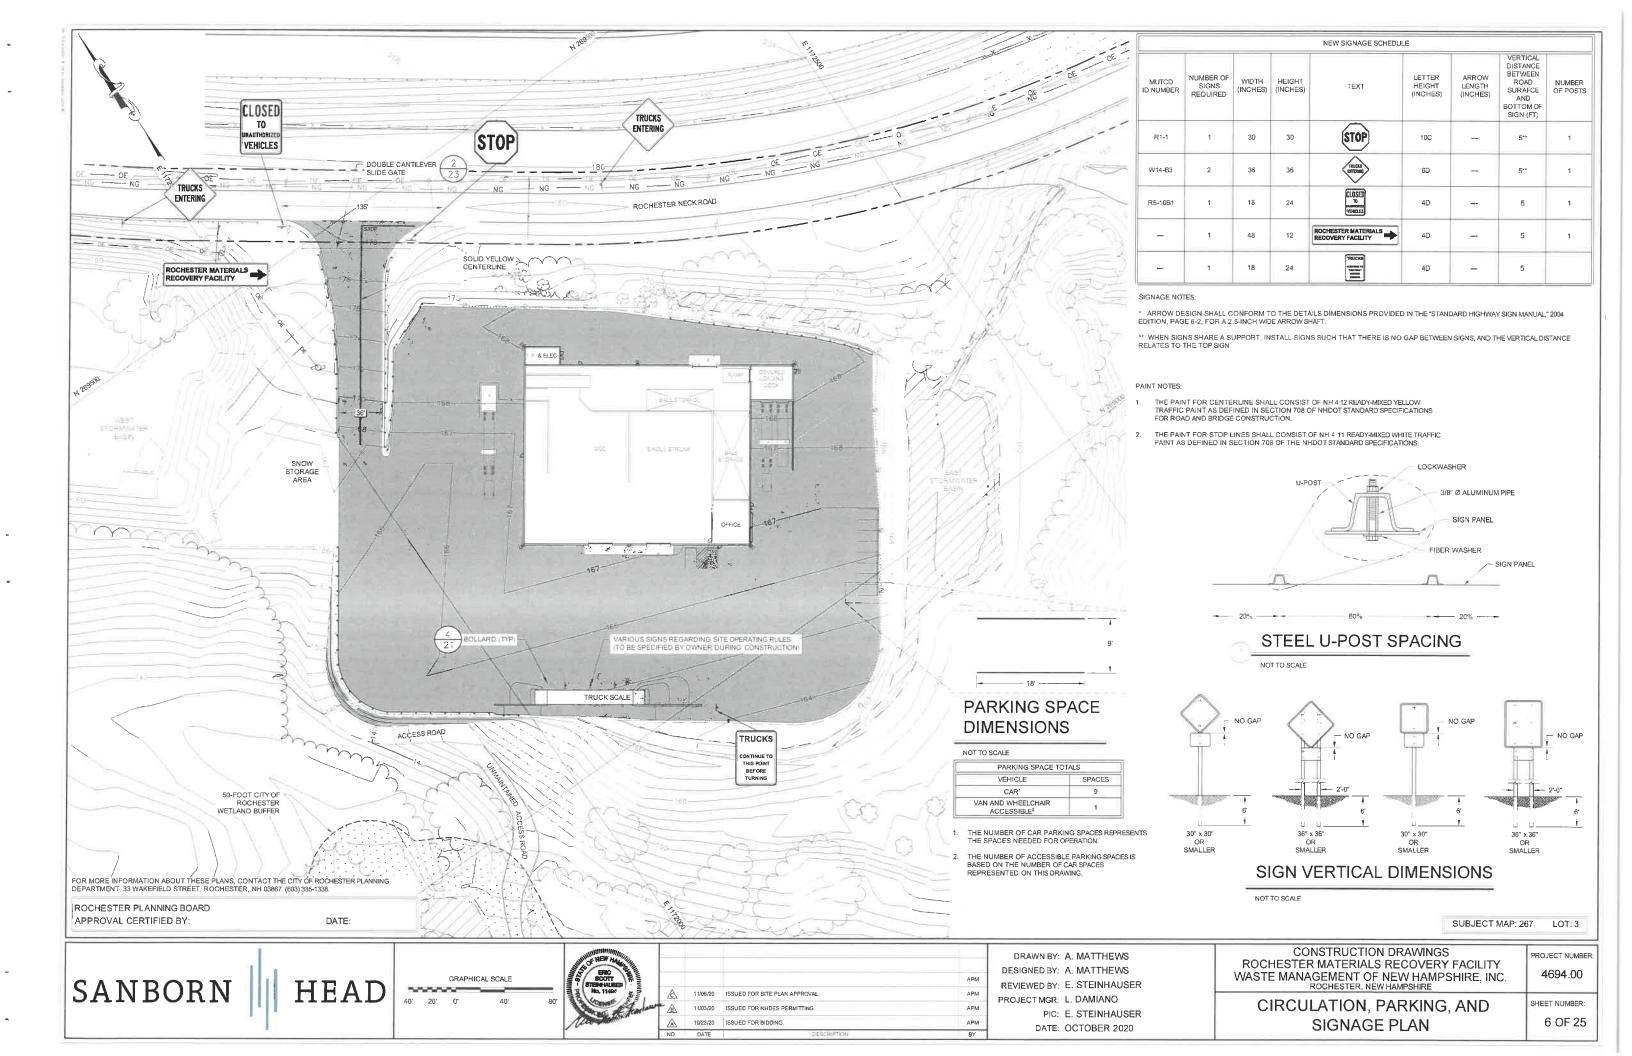


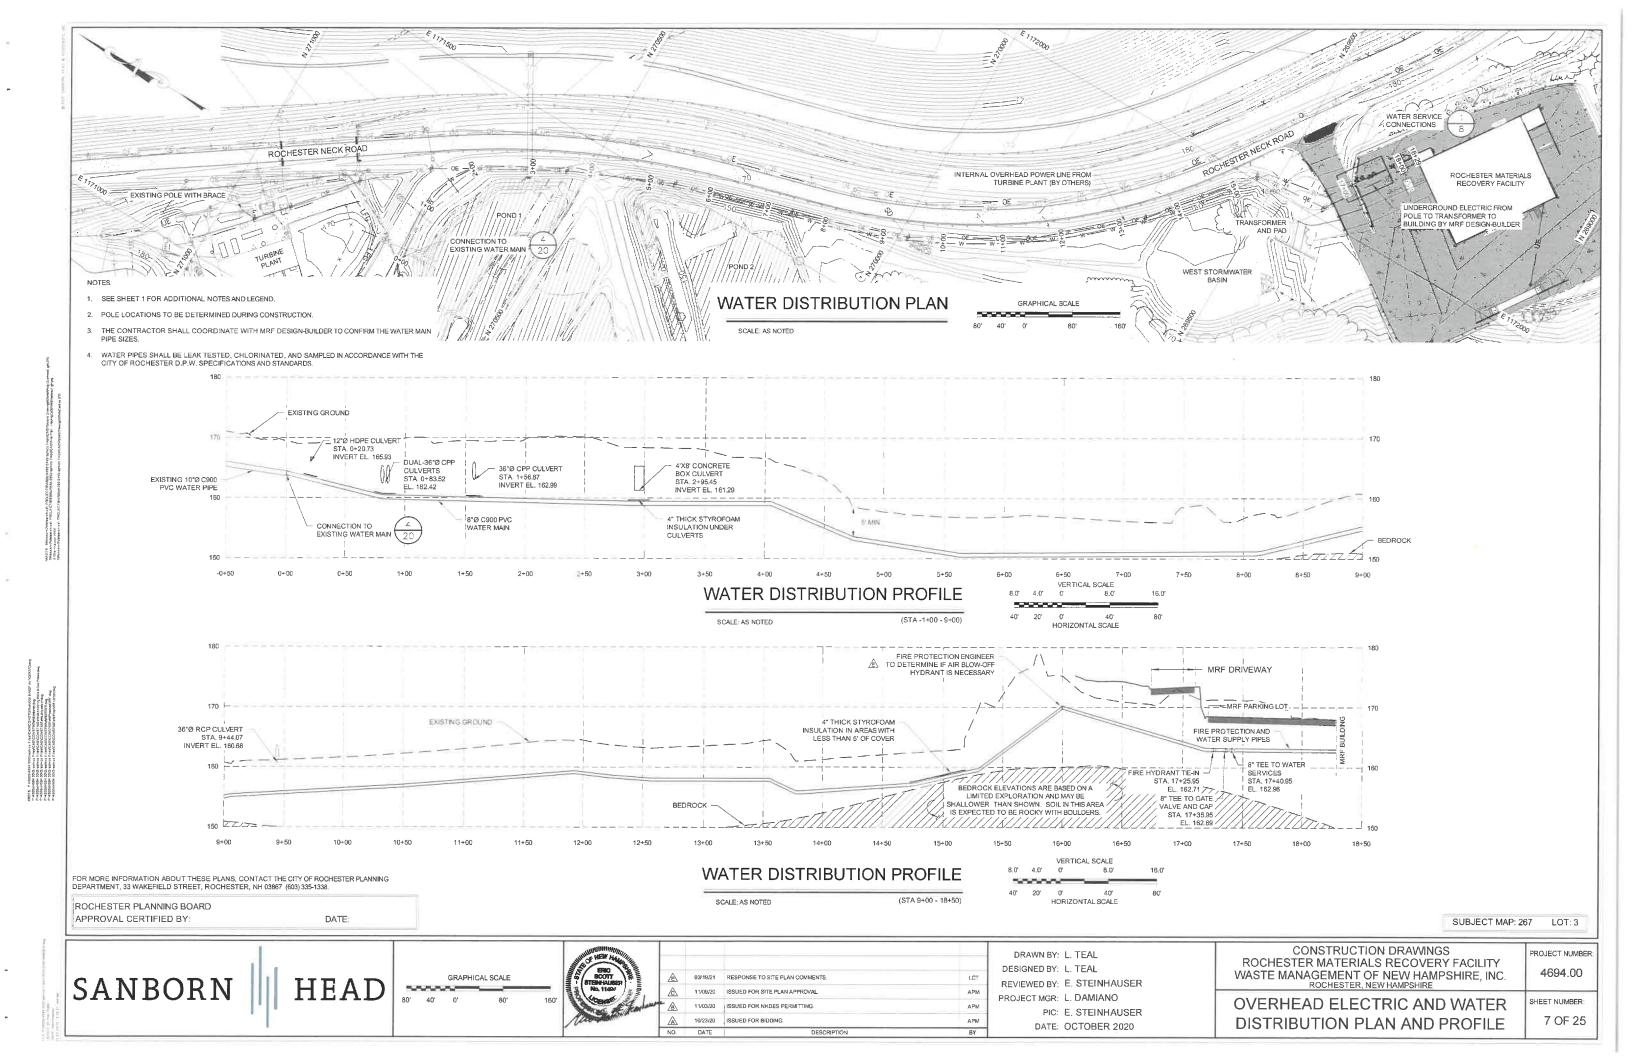


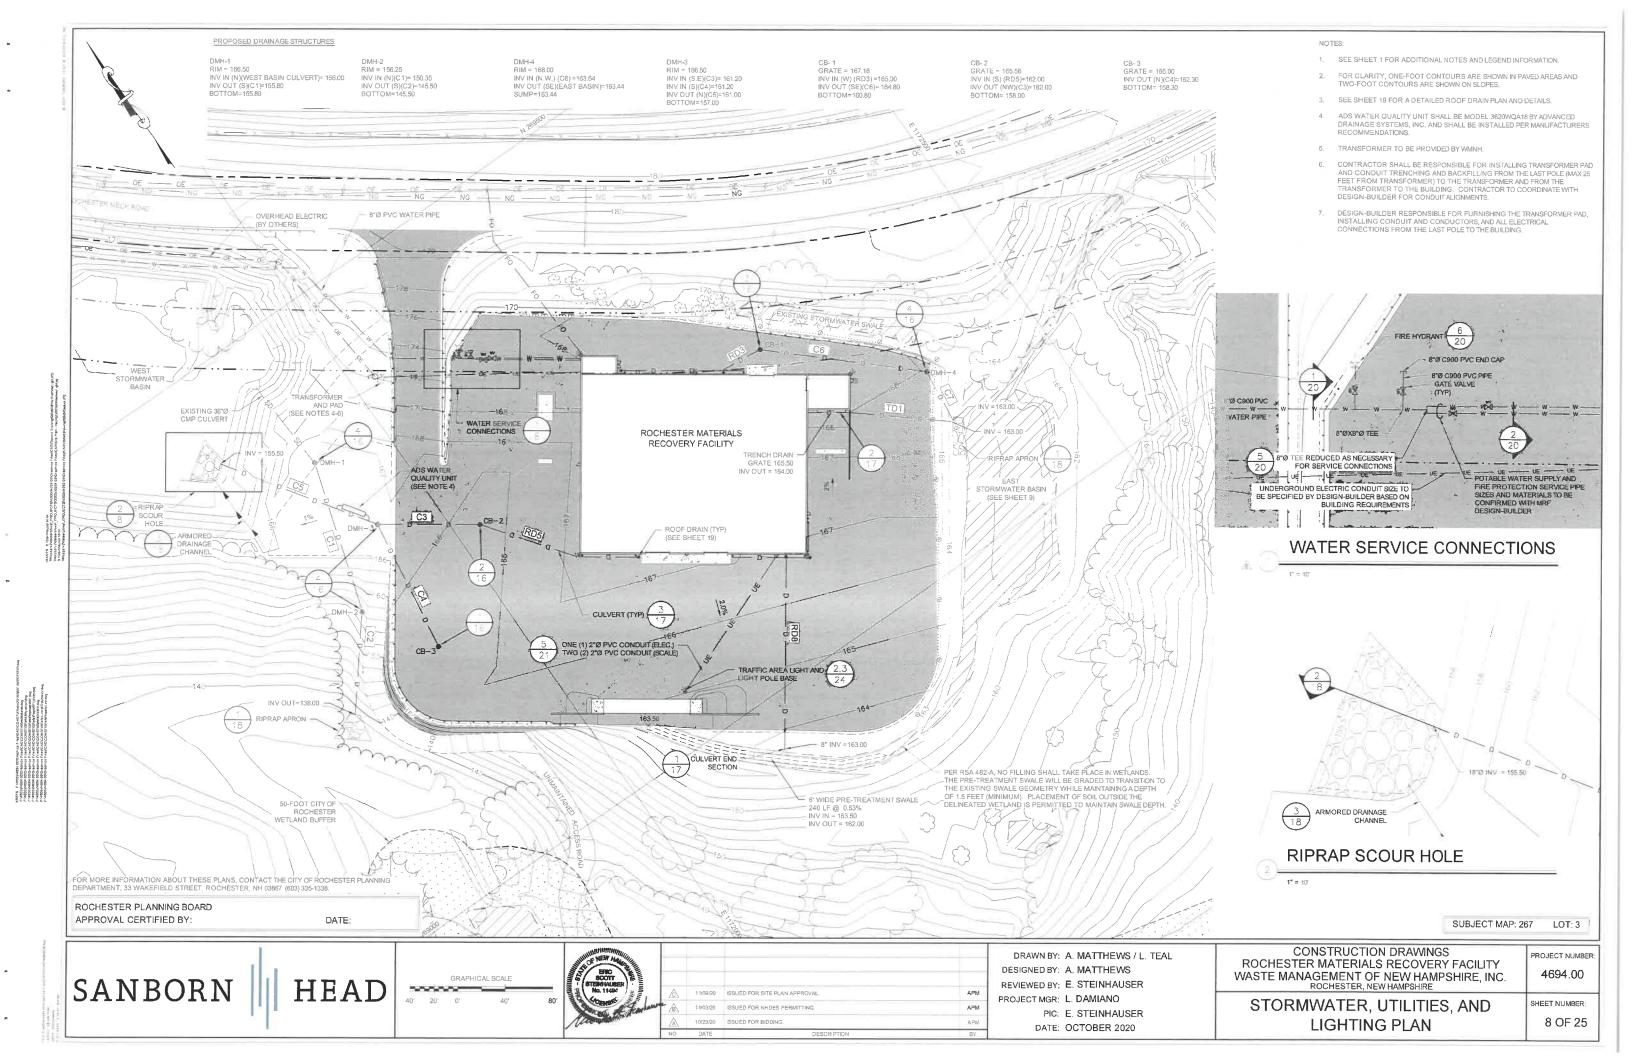

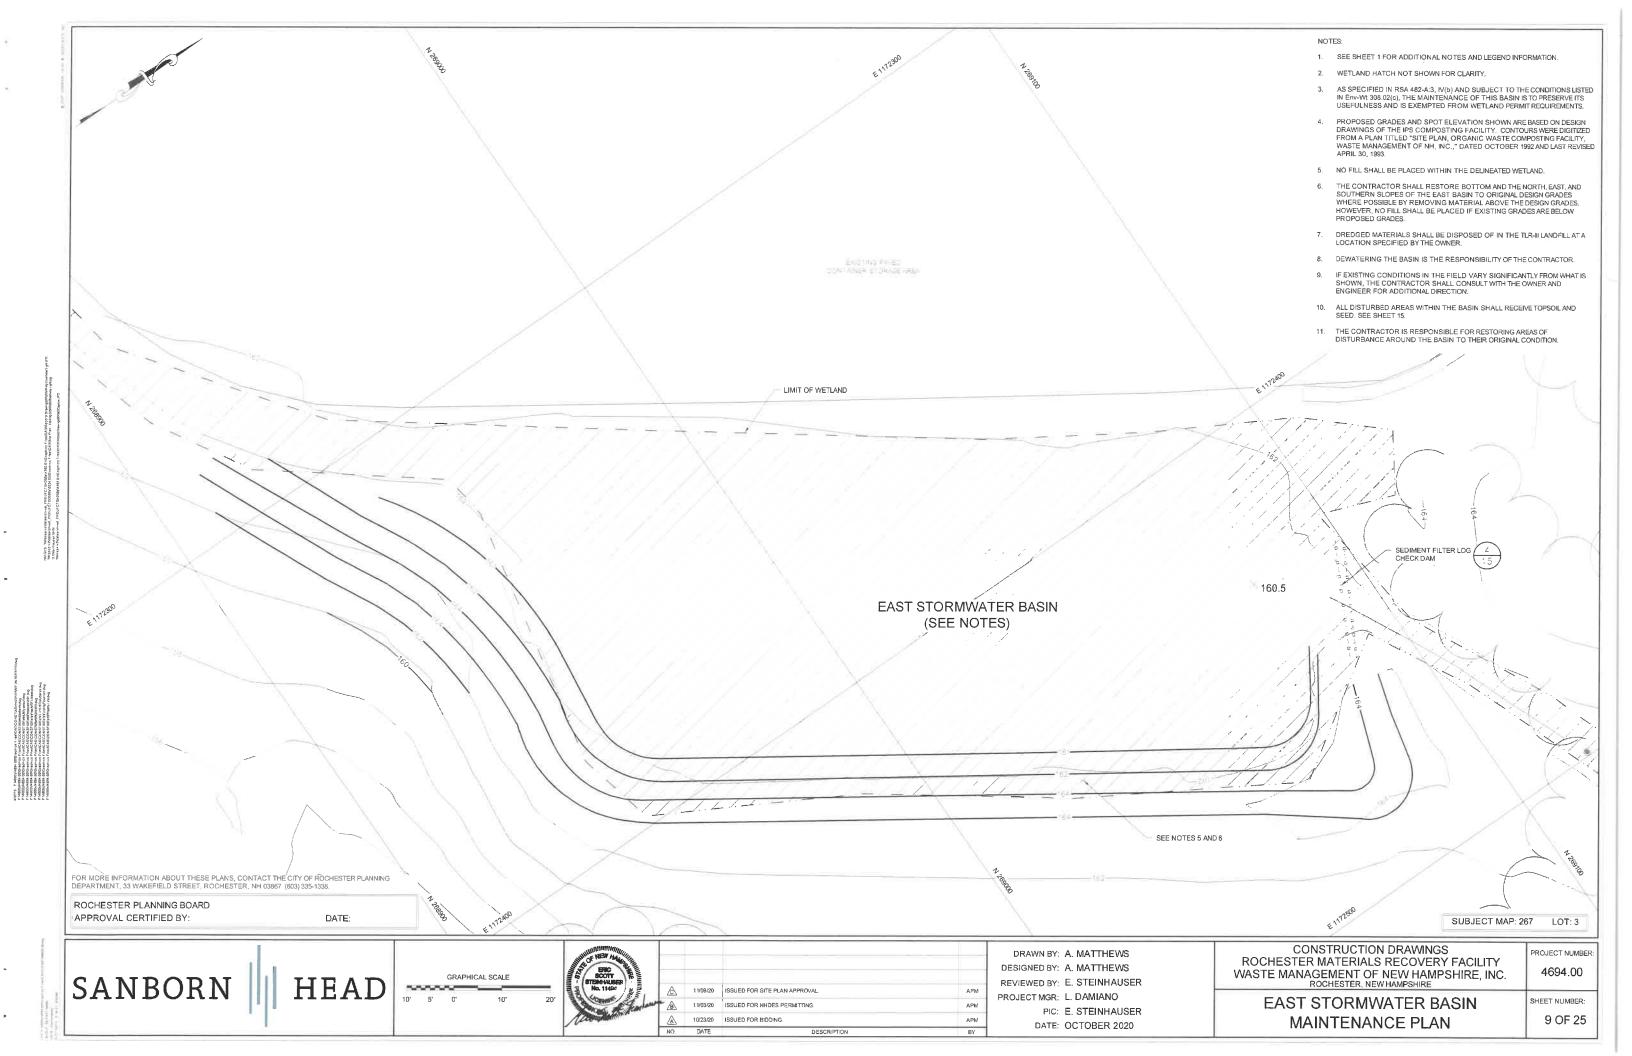

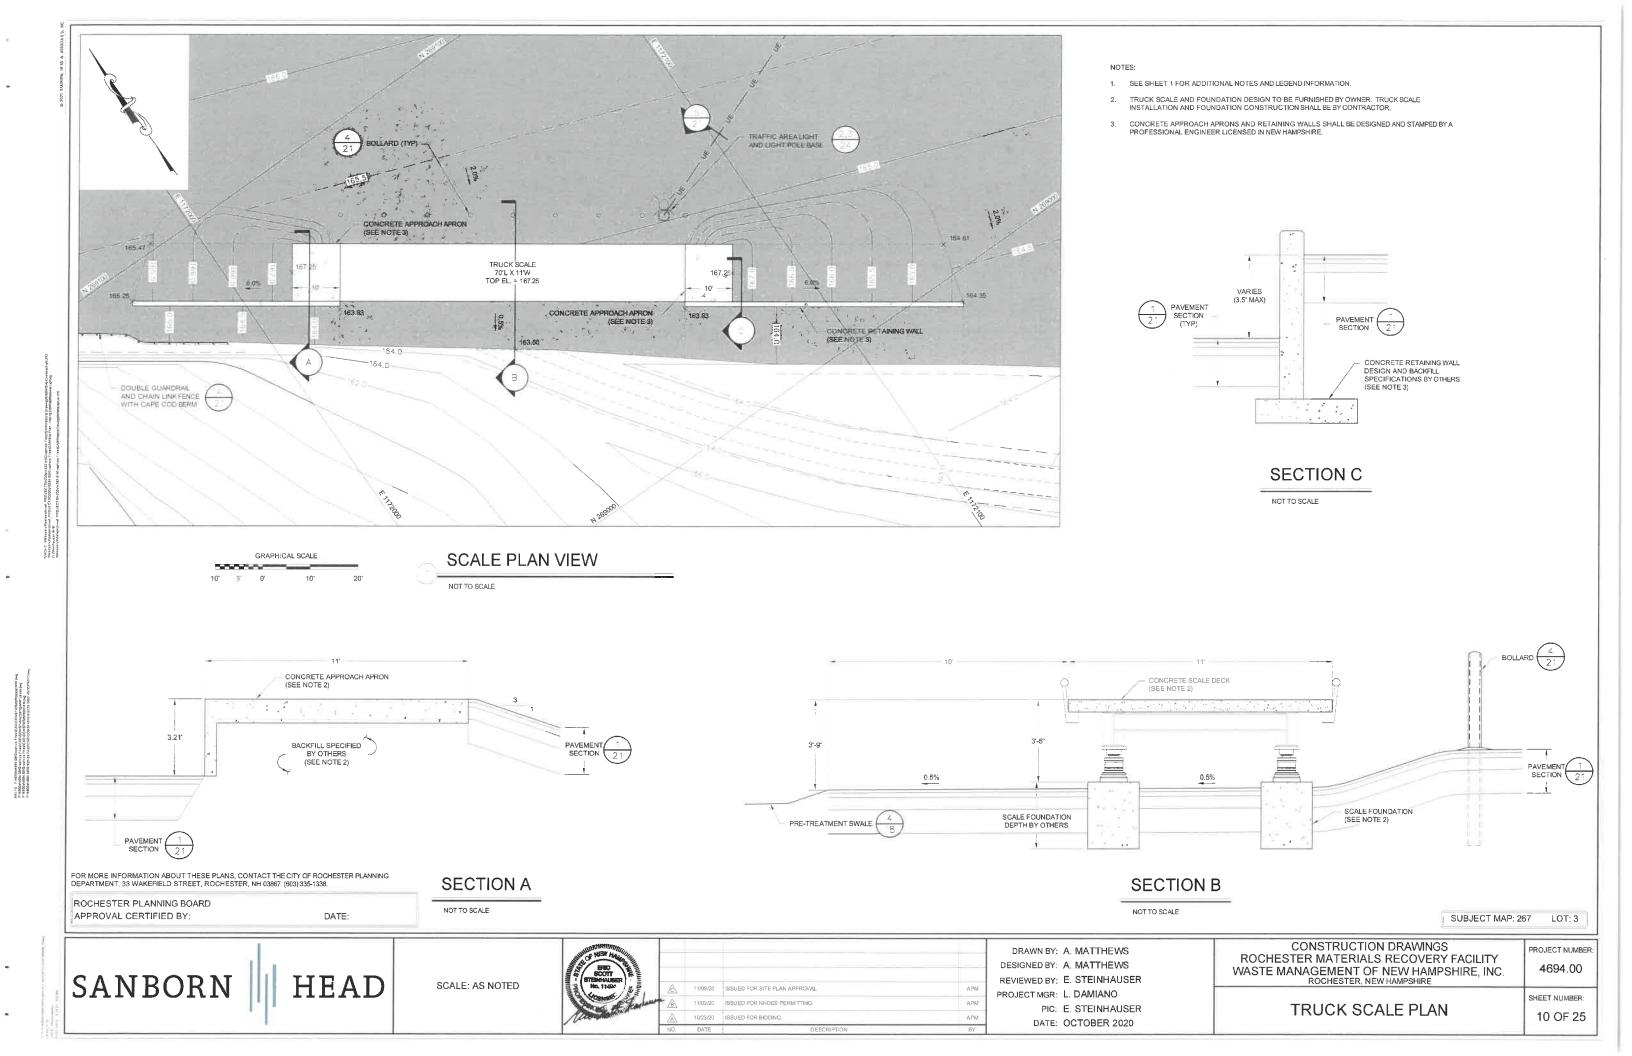

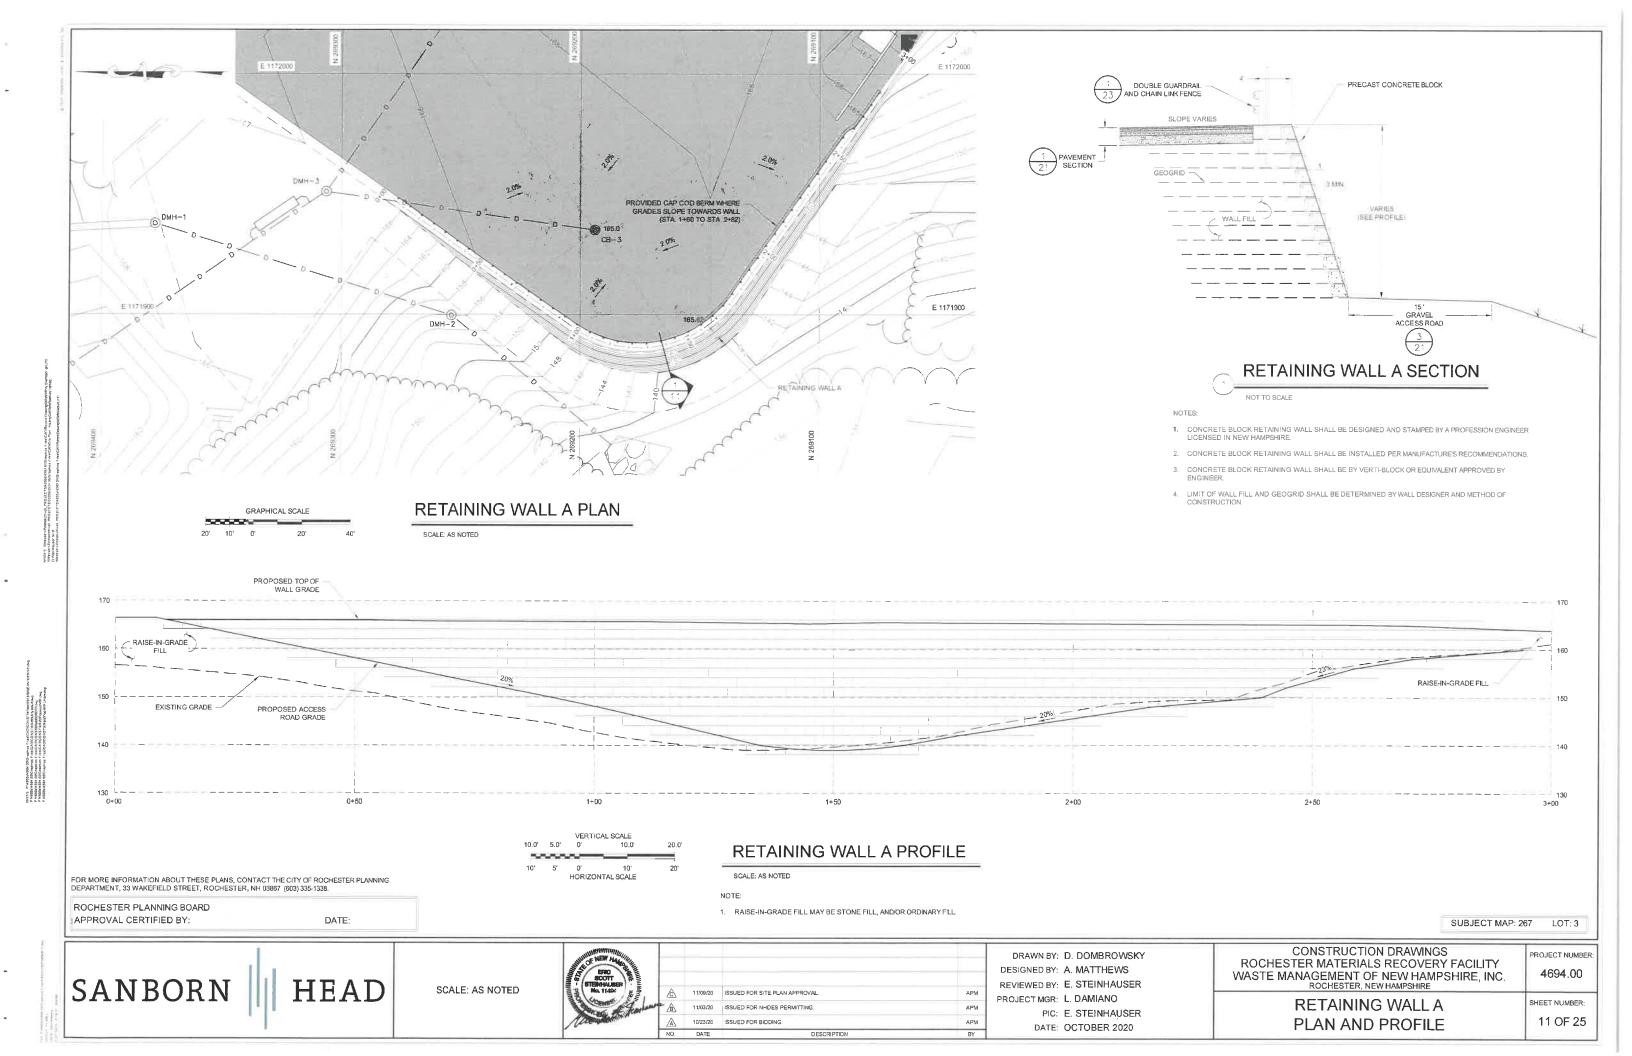

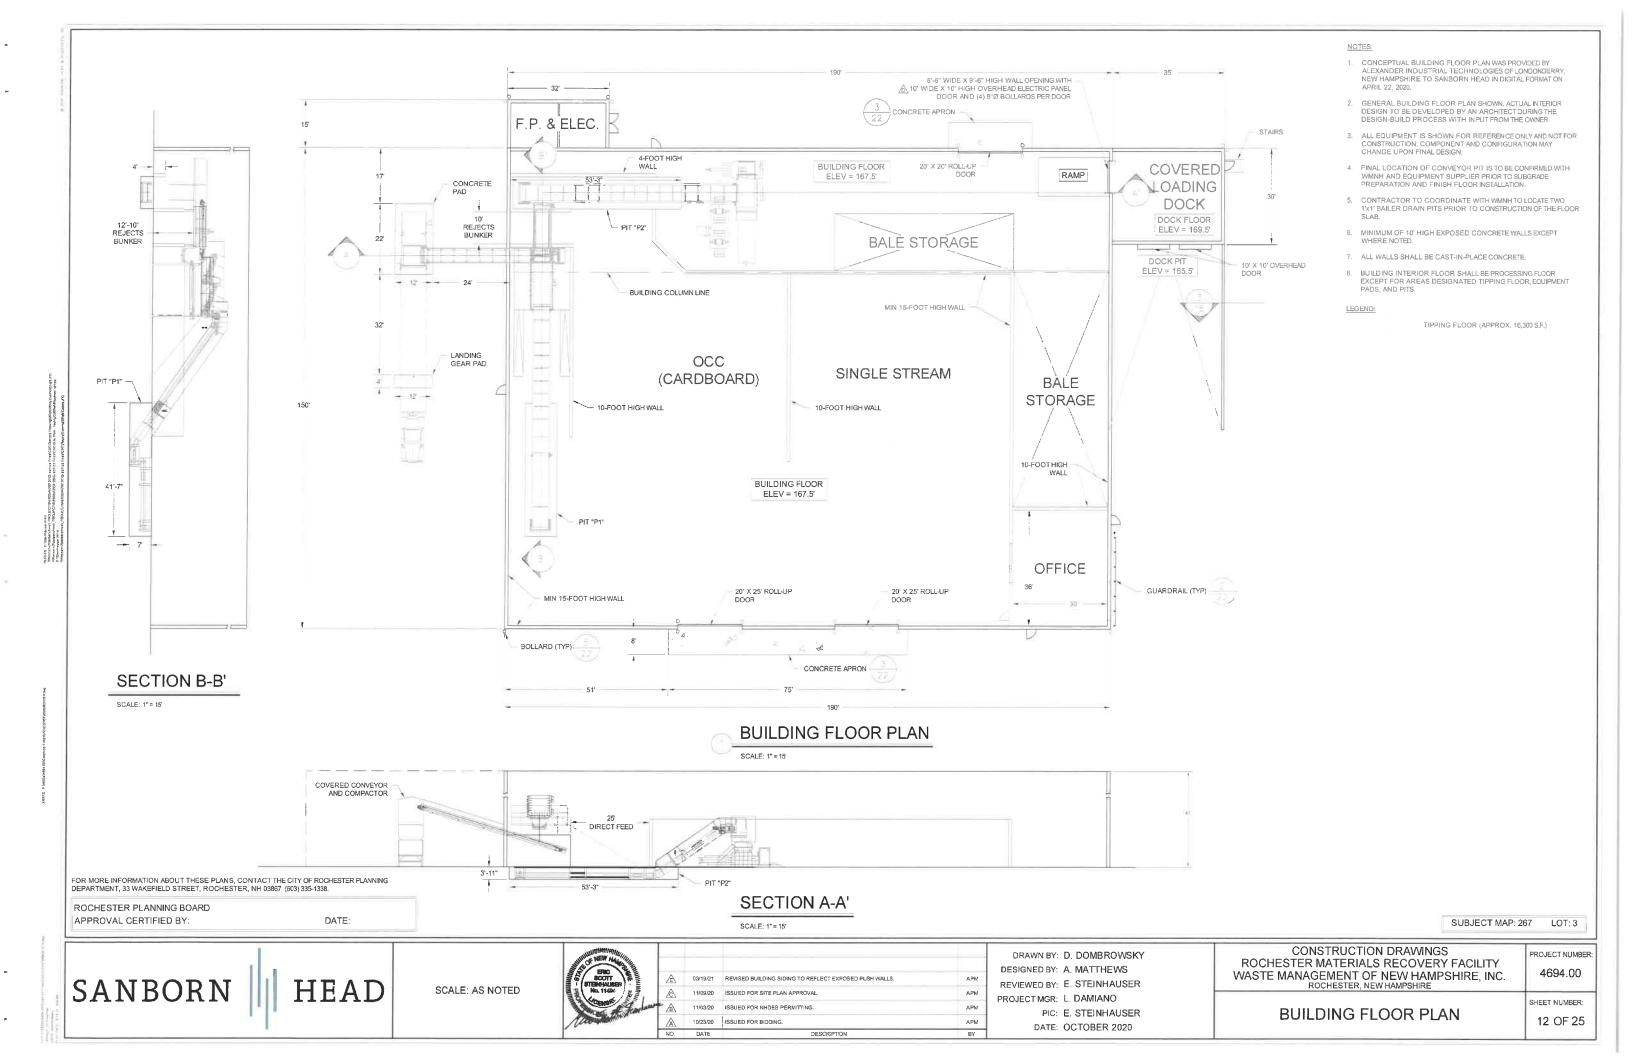





# NORTH WALL BUILDING ELEVATION

£ 39' 30' € 10' X 10' OVERHEAD DOOR LOADING DOCK BUMPERS 🛆 BOLLARD —
(TYP) A MAN DOOR (TYP) INTERNAL LOADING DOCK DOOR SOUTH WALL BUILDING ELEVATION GROUND -ELEVATION LOADING DOCK ELEVATION FOR MORE INFORMATION ABOUT THESE PLANS, CONTACT THE CITY OF ROCHESTER PLANNING DEPARTMENT, 33 WAKEFIELD STREET, ROCHESTER, NH 03867 (603) 335-1338. AS NOTED ROCHESTER PLANNING BOARD APPROVAL CERTIFIED BY: DATE: SUBJECT MAP: 267 LOT: 3



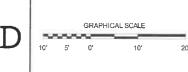

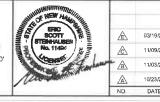

APA
APM
APN


DRAWN BY: D. DOMBROWSKY DESIGNED BY: A. MATTHEWS REVIEWED BY: E. STEINHAUSER PROJECT MGR: L. DAMIANO

PIC: E. STEINHAUSER DATE: OCTOBER 2020

CONSTRUCTION DRAWINGS ROCHESTER MATERIALS RECOVERY FACILITY WASTE MANAGEMENT OF NEW HAMPSHIRE, INC. ROCHESTER, NEW HAMPSHIRE

PROJECT NUMBER: 4694.00

SHEET NUMBER: **BUILDING ELEVATIONS** 13 OF 25

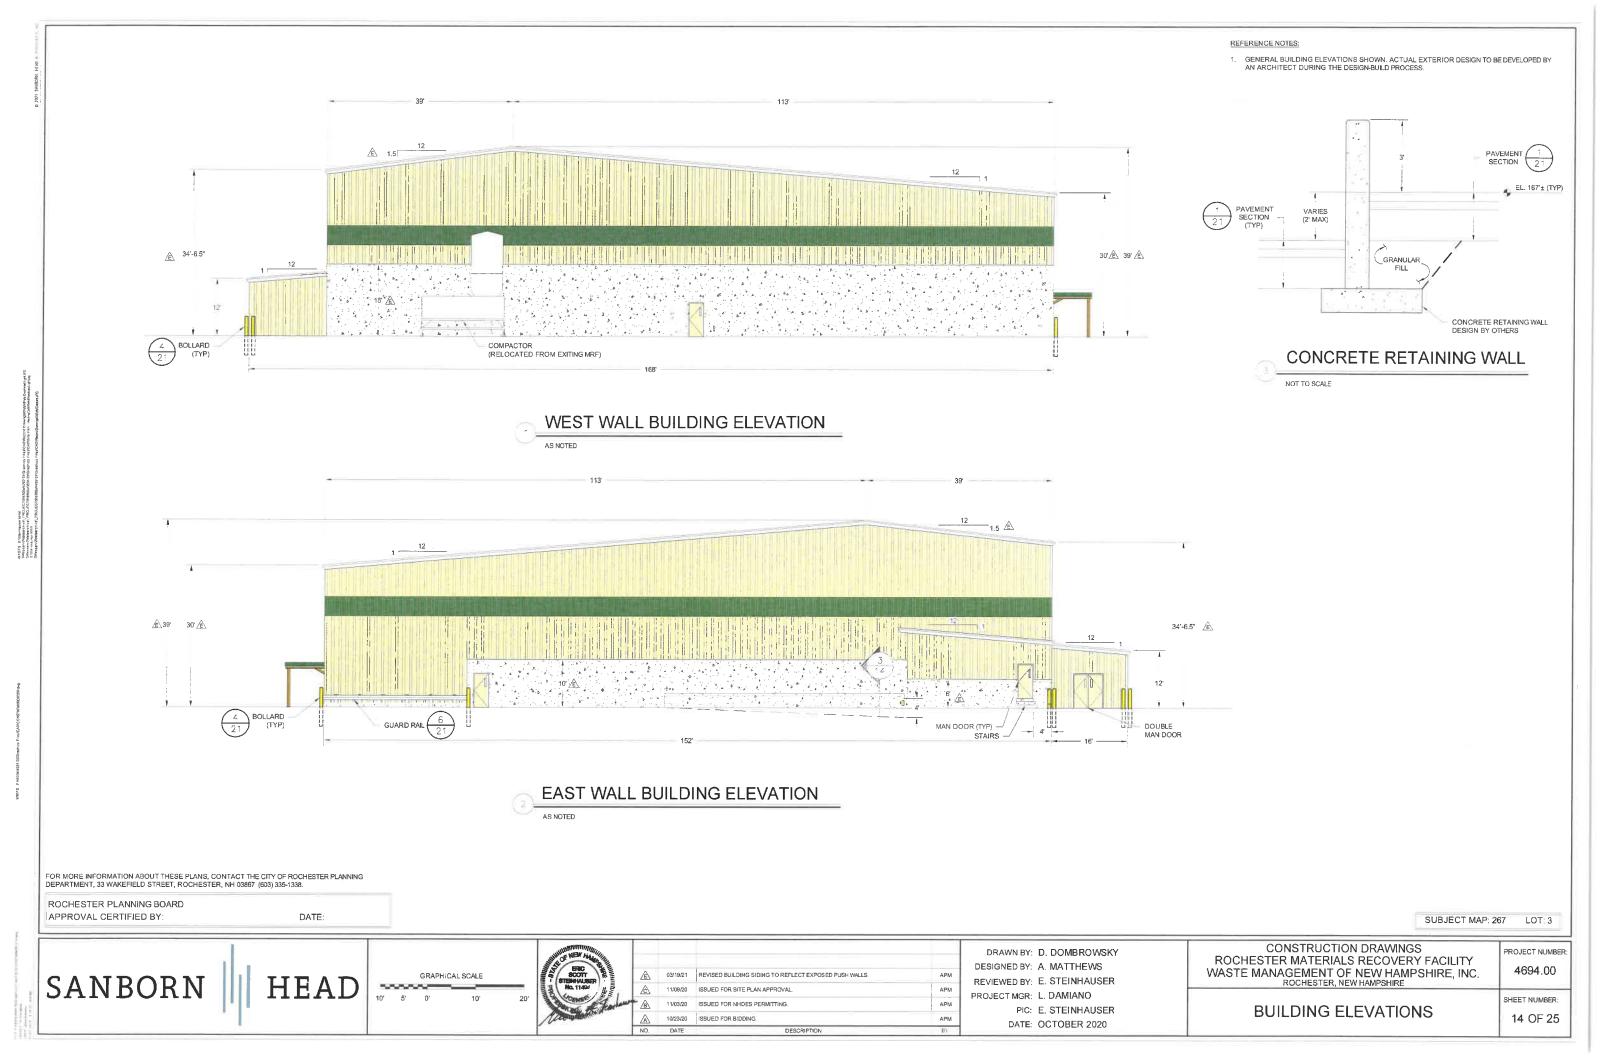


- BASE COURSE GRAVELS HAVE BEEN INSTALLED IN AREAS TO BE PAVED;
- A MINIMUM OF 85% VEGETATED GROWTH HAS BEEN ESTABLISHED;
  A MINIMUM OF 3 INCHES OF NON-EROSIVE MATERIAL SUCH AS STONE RIPRAP HAS BEEN INSTALLED; OR EROSION CONTROL BLANKETS HAVE BEEN PROPERLY INSTALLED.
- APPLY SEED, LIME, FERTILIZER, AND HAY MULCH TO DISTURBED AREAS, NEWLY-PLACED FILL SLOPES, AND GRASS-LINED SWALES WITHIN 14 CALENDAR DAYS AFTER THE PERMANENT OR TEMPORARY (i.e., CONSTRUCTION ACTIVITIES WILL BE INACTIVE FOR 14 OR MORE CALENDAR DAYS) CESSATION OF EARTHWORK ACTIVITIES. ALSO APPLY SEED AND HAY MULCH TO THOSE AREAS THAT WILL NOT BE RE-DISTURBED FOR A PERIOD OF 30 DAYS OR MORE. HAY MULCH SHALL BE APPLIED AT THE RATE OF 1.5 TO 2 TONS PER
- EROSION CONTROL STRUCTURES SHALL BE INSTALLED PRIOR TO FARTH MOVING OPERATIONS AND AT THE DISCRETION OF THE ENGINEER AND OWNER. SEDIMENT FILTER LOGS SHALL BE INSTALLED ALONG THE CONTOUR AS SHOWN ON THE DRAWING OR DIRECTED BY THE OWNER. EROSION CONTROL FEATURES ARE TO BE MAINTAINED AND CLEANED UNTIL VEGETATIVE COVER IS
- ALL EROSION CONTROLS SUCH AS SEDIMENT FILTER LOGS SHALL BE INSPECTED WEEKLY DURING THE LIFE OF THE PROJECT AND AFTER EACH STORM EVENT THAT PRODUCES 0.25 INCHES OF RAINFALL. ALL DAMAGED SEDIMENT FILTER LOGS SHALL BE
- TRACK UP AND DOWN REGRADED SLOPES (GROUSER TRACKS PERPENDICULAR TO THE SLOPE) WITH A BULLDOZER TO LIMIT EROSION.
- REMOVE SEDIMENT RESULTING FROM CONSTRUCTION ACTIVITY AS NEEDED FROM DETENTION PONDS TO MAINTAIN STORAGE CAPACITY AND AT THE DIRECTION OF THE ENGINEER OF OWNER. DISPOSE SEDIMENT IN A SECURE LOCATION SO AS TO PREVENT
- REMOVE SEDIMENT BUILD UP FROM BEHIND EROSION AND SEDIMENT CONTROL DEVICES. MAINTAIN TEMPORARY EROSION AND SEDIMENT CONTROL DEVICES UNTIL FULL ESTABLISHMENT OF PERMANENT GROUND COVER.
- DITCHES, SWALES, AND PONDS SHALL BE INSTALLED EARLY ON IN THE CONSTRUCTION SEQUENCE (BEFORE ROUGH GRADING OF THE SITE) AND STABILIZED BEFORE RUNOFF IS DIRECTED TO THEM.
- PERFORM SOIL BORROW EXCAVATION ACTIVITIES IN SUCH A MANNER THAT ALL RUNOFF FROM THE EXCAVATION AREAS IS CONTAINED WITHIN THE EXCAVATION.
- THE PROJECT SHALL BE MANAGED IN A MANNER THAT MEETS THE REQUIREMENTS AND INTENT OF RSA 430:53 AND CHAPTER AGR 3800 RELATIVE TO INVASIVE SPECIES.
- ALL ROADWAYS AND PARKING LOTS SHALL BE STABILIZED WITHIN 72 HOURS OF ACHIEVING FINISH GRADE.
- 12. ALL CUT AND FILL SLOPES SHALL BE SEEDED/LOAMED WITHIN 72 HOURS OF ACHIEVING FINISH GRADE
- MUST INSTALL AND MAINTAIN ORANGE CONSTRUCTION FENCING (OR OTHER APPROPRIATE DEVICE) ALONG OUTER EDGE OF THE CONSTRUCTION ZONE, WHERE THERE ARE TREES, SHRUBS, OR OTHER RESOURCES WORTHY OF PROTECTION AND AROUND
- 14. ALL STRIPPED TOPSOIL FROM SITE SHALL BE RETAINED, STABILIZED IN ACCORDANCE WITH NHDES STANDARDS, AND STOCKPILED ON SITE FOR REUSE ON SITE LATER, UNLESS OTHERWISE APPROVED.

#### SPECIFICATIONS:


- TOPSOIL SHALL BE FERTILE SOIL CAPABLE OF SUSTAINING VIGOROUS PLANT GROWTH, FREE FROM ROOTS, STICKS, PEAT, WEEDS, AND SOD. IT SHALL NOT CONTAIN MATERIAL HARMFUL TO PLANT GROWTH.
- GRASS SEED SHALL BE FROM THE SAME OR PREVIOUS YEAR'S CROP; EACH VARIETY OF SEED SHALL HAVE A PERCENTAGE OF GERMINATION NOT LESS THAN NINETY (90), A PERCENTAGE OF PURITY NOT LESS THAN EIGHTY-FIVE (85), AND SHALL HAVE NOT MORE THAN ONE PERCENT (1%) WEED CONTENT.
- MULCH SHALL CONSIST OF DRY HAY OR STRAW AND BE FREE OF NOXIOUS WEEDS OR MOLD.
- APPLICATION OF FERTILIZER, LIME, SEED, AND MULCH SHALL ONLY BE PERFORMED DURING THOSE PERIODS WITHIN THE SEASONS WHICH ARE NORMAL FOR SUCH WORK AS DETERMINED BY THE WEATHER AND LOCALLY ACCEPTED PRACTICE, AND AS
- ANY PART OF THE SEEDED AREA THAT FAILS TO YIELD AN ACCEPTABLE STAND OF GRASS AS DETERMINED BY THE ENGINEER OR OWNER SHALL BE RETREATED WITH ADDITIONAL SEED, FERTILIZER, AND MULCH.
- SEED MIX SHALL BE NEW ENGLAND CONSERVATION/WILDLIFE MIX BY NEW ENGLAND WETLAND PLANT, INC. OR EQUIVALENT APPROVED BY THE ENGINEER AND SHALL BE APPLIED AT A RATE OF 25 POUNDS PER ACRE.

- ALL PROPOSED VEGETATED AREAS THAT DO NOT EXHIBIT A MINIMUM OF 85% VEGETATIVE GROWTH BY OCTOBER 15TH, OR THAT ARE DISTURBED AFTER OCTOBER 15TH, SHALL BE STABILIZED BY SEEDING AND INSTALLING EROSION CONTROL BLANKETS ON SLOPES GREATER THAN 3:1, AND SEEDING AND PLACING 3 TO 4 TONS OF MULCH APPER ACRE, SECURED WITH ANCHORED NETTING, ELSEWHERE. THE INSTALLATION OF EROSION CONTROL BLANKETS OR MULCH AND RETRING SHALL NOT OCCUP OVER ACCUMULATED SNOW OR ON FROZEN GROUND AND SHALL BE COMPLETED IN ADVANCE OF THAW OR SPRING MELT EVENTS;
- ALL DITCHES OR SWALES THAT DO NOT EXHIBIT A MINIMUM OF 85% VEGETATIVE GROWTH BY OCTOBER 15TH, OR THAT ARE DISTURBED AFTER OCTOBER 15TH, SHALL BE STABILIZED TEMPORARILY WITH STONE OR EROSION CONTROL BLANKETS APPROPRIATE FOR THE DESIGN FLOW CONDITIONS; AND
- AFTER NOVEMBER 15TH, INCOMPLETE ROAD OR PARKING SURFACES, WHERE WORK HAS STOPPED FOR THE WINTER SEASON, SHALL BE PROTECTED WITH A LAYER OF AT LEAST 3 INCHES THICK CRUSHED GRAVEL PER NHDOT ITEM 304.3.

DATE

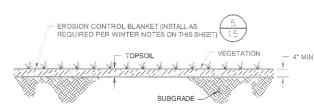


#### **TOPSOIL AND SEED**

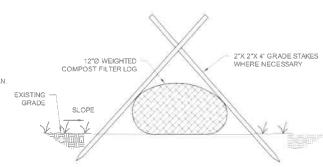

- EDIMENT FILTER LOG SHALL BE SILTSOXX NATURAL PLUS BY FILTREXX, OR AND EQUIVALENT RODUCT MADE OF WOVEN ORGANIC MATERIALS APPROVED BY THE ENGINEER.
- SEDIMENT FILTER LOGS SHALL BE A COMPOST-FILLED BIO- OR PHOTO-DEGRADABLE TUBULAR MESH PRODUCT CAPLE OF TRAPPING SEDIMENT BEFORE OR WITHIN THE DEVICE WHILE ALLOWING STORMWATER RUNOFT TO PASS THROUGH.
- THE MESH SHALL BE OF NATURAL BIODEGRADABLE MATERIALS TO AVOID PROBLEMS WITH THE SOCK TRAPPING ENDANGERED SNAKES OR LIZARDS, SUCH AS BIODEGRADABLE JUTE, SISAL, BURLAP, OR COIR FIBER FABRIC.
- THE MESH FABRIC SHALL BE CLEAN, EVENLY WOVEN, AND FREE OF ENCRUSTED CONCRETE OR OTHER CONTAMINATING MATERIALS AND FREE FROM CUTS, TEARS, BROKEN OR MISSING YARNS AND THIN, OPEN OR WEAK PLACES.
- EACH SEDIMENT FILTER LOG SHALL HAVE A DIAMETER OF NO LESS THAN 8 INCHES.
- THE MESH OPENING SHALL BE NO SMALLER THE 1/8 INCH.
- THE COMPOST SHALL BE DERIVED FROM GREEN MATERIAL CONSISTING OF CHIPPED, SHREDDED, OR GROUND VEGETATION, OR CLEAN RECYCLED WOOD PRODUCTS, AND BE REASONABLY FREE OF VISIBLE CONTAMINANTS, IT SHALL NOT BE DERIVED FROM MIXED MUNICIPAL SOLID WASTE AND SHALL NOT CONTAIN PAINT, PETROLEUM PRODUCTS, PESTICIDES, OR ANY OTHER CHEMICAL RESIDUES HARMFUL TO ANIMAL LIFE OR PLANT GROWTH. THE COMPOST SHALL NOT POSSESS OBJECTIONABLE ODORS.
- THE SEDIMENT FILTER LOG MUST HAVE A MINIMUM DURABILITY OF ONE YEAR AFTER
- STUMP GRINDINGS EROSION CONTROL BERMS MAY BE USED IN PLACE OF SEDIMENT FILTER LOG.

# SEDIMENT FILTER LOG

NOT TO SCALE

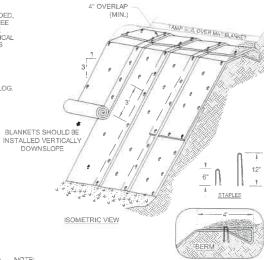

#### A NOTE:

EROSION CONTROL BLANKETS SHALL BE ROLLMAX BIONET SC150BM BY NORTH AMERICAN GREEN, OR EQUIVALENT PRODUCT MADE OF WOVEN ORGANIC MATERIALS APPROVED BY THE ENGINEER.

#### SLOPE INSTALLATION

#### SLOPE INSTALLATION NOTES

SEDIMENT ELLTER LOG

- DIMENSIONS GIVEN IN THE DRAWINGS ARE EXAMPLES; MATERIAL SHOULD BE INSTALLED PER MANUFACTURER'S SPECIFICATIONS.
- SLOPE SURFACE SHALL BE FREE OF ROCKS, CLODS, STICKS AND GRASS, MATS/BLANKETS SHALL HAVE GOOD SOIL CONTACT.
- APPLY PERMANENT SEEDING BEFORE PLACING BLANKETS.
- LAY BLANKETS LOOSELY AND STAKE OR STAPLE TO MAINTAIN DIRECT CONTACT WITH THE SOIL DO NOT STRETCH.

SOURCE: "NEW HAMPSHIRE STORMWATER MANUAL, VOLUME 3 EROSION AND SEDIMENT CONTROLS DURING CONSTRUCTION" REVISION 1.0, DECEMBER 2008, PAGE 74.

# **EROSION CONTROL BLANKET INSTALLATION**

**ANCHORING** 

NOT TO SCALE

TWO (2) 2"x2" STAKES

WHERE NECESSARY

SUBJECT MAP: 267 LOT: 3

FENCE

NETTING

(SEE NOTE 2)

1. INSTALL CONSTRUCTION FENCE ALONG THE LIMIT OF DISTURBANCE CONSTRUCTION FENCE SHALL BE ORANGE HEAVY-DUTY DIAMOND GRID CONSTRUCTION SNOW/BARRIER FENCE.

CONSTRUCTION FENCE SHALL BE INSTALLED ON TEMPORARY STAKES INSTALLED 6-FOOT ON CENTER.

CONSTRUCTION FENCE

SEDIMENT FILTER LOG CHECK DAM

EXISTING SOIL

NOT TO SCALE

FLOW

INSTALLATION

SANBORN HEAD

FOR MORE INFORMATION ABOUT THESE PLANS, CONTACT THE CITY OF ROCHESTER PLANNING

DEPARTMENT, 33 WAKEFIELD STREET, ROCHESTER, NH 03867 (603) 335-1338

ROCHESTER PLANNING BOARD APPROVAL CERTIFIED BY:

SCALE: AS NOTED



FLOW

SEDIMENT FILTER LOG

lame B	11/09/20 11/03/20 10/23/20	ISSUED FOR SITE PLAN APPROVAL ISSUED FOR NHDES PERMITTING. ISSUED FOR BIDDING.	APM APM APM
Lacores A			
. 🛕	11/09/20	ISSUED FOR SITE PLAN APPROVAL.	APM
A	2/05/21	REVISED TO ADDRESS NH FISH AND GAME COMMENTS	DJD

DRAWN BY: S. SANTIAGO / A. MATTHEWS DESIGNED BY: A. MATTHEWS REVIEWED BY: E. STEINHAUSER

PROJECT MGR: L. DAMIANO PIC: E. STEINHAUSER

DATE: OCTOBER 2020

CONSTRUCTION DRAWINGS ROCHESTER MATERIALS RECOVERY FACILITY WASTE MANAGEMENT OF NEW HAMPSHIRE, INC.


EROSION AND SEDIMENT CONTROL

4694.00 SHEET NUMBER:


PROJECT NUMBER

**NOTES AND DETAILS** 

15 OF 25

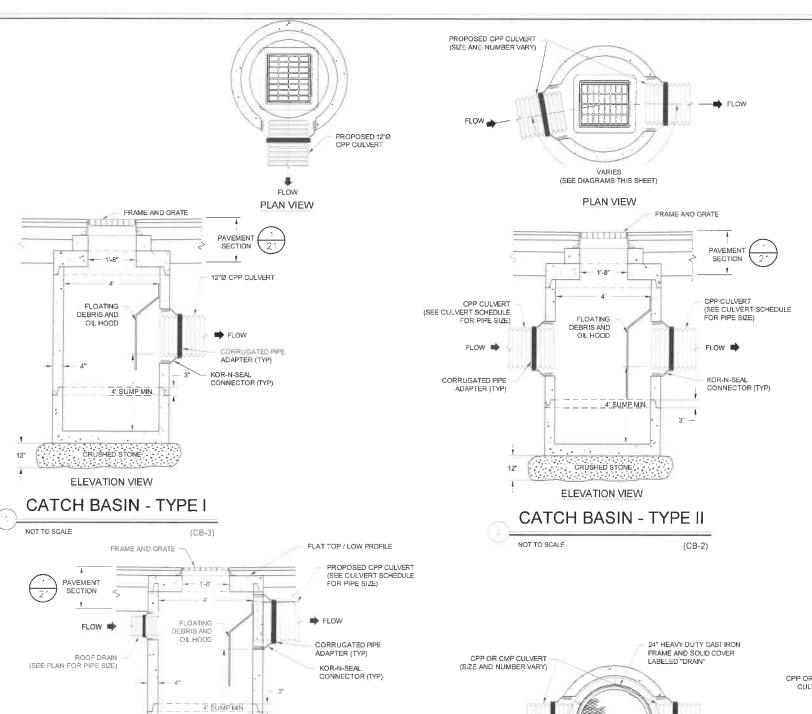

DRAINAGE STRUCTURE SCHEDULE SIZE INLET C-1 C-2 DMH-3 C-4 DMH-4 4'0 C-6 C-7 CB-1 4'0 GRATE / RD CB-2 GRATE / RD CB-3 4'0 DMH-1 CB-2 CB-1

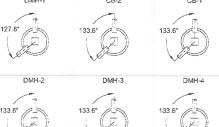

CULVERT SCHEDULE DIAMETER LENGTH SLOPE CULVERT (LF) (FT/FT) END DMH-1 FES CB-2 DMH-3 CB-3 DMH-3 C-5 .0397 DMH-3 C-6 0.008 CB-1 DMH-4 C-7 0.01 DMH-4 TD1 CPP 0.019

#### CULVERT NOTES:

- 1. THE CULVERT INVERT ELEVATIONS SHOWN ON SHEET 8 REPRESENT ELEVATIONS BASED ON DESIGN OR EXISTING SWALE INVERT ELEVATIONS INTERPOLATED FROM ARRIAL TOPOGRAPHY. THE INTENT IS THAT THE CULVERTS SHALL BE INSTALLED WITH THE PROPOSED SLOPE AND ELEVATIONS AT THE INVERTS OF CORRESPONDING EXISTING SWALES OR CHANNELS. IF THE ACTUAL SWALE INVERT ELEVATIONS DIFFER DURING INSTALLATION FROM THOSE INDICATED, OBTAIN APPROVAL FROM ENGINEER PRIOR TO BACKFILLING OVER THE PIPES. GRADES SHALL BE CONFIRMED FOR SHOP DRAWING APPROVAL BY ENGINEER.
- 2. THE LIST BELOW CONTAINS ABBREVIATIONS SHOWN SPECIFICALLY IN THIS SCHEDULE.

CB=CATCH BASIN
CPP = CORRUGATED POLYETHYLENE PIPE
PROJ = PROJECTING
DMH = DRAINAGE MANHOLE DI = DROP INLET EW = ENDWALL
FES = FLARED END SECTION EX. PIPE = EXISTING PIPE HDPE = HIGH DENSITY POLYETHYLENE RD = ROOF DRAIN LF = LINEAR FOOT

#### DRAINAGE STRUCTURE PARTS LIST:

SEALANT

NEENAH FOUNDRY CO. MODEL 3570-A OR EQUIVALENT APPROVED BY THE

EZ-STIK JOINT

BUTYL-RUBBER-BASED PREFORMED FLEXIBLE SEALANT: EZ-STICK, MANUFACTURED BY PRESS-SEAL GASKET CORP. OF FORT WAYNE, INDIANA, OR EQUIVALENT APPROVED BY ENGINEER

KOR-N-SEAL KOR-N-SEAL CONNECTOR BY TRELLEBORG PIPE SEALS MILFORD OR EQUIVALENT APPROVED BY ENGINEER CONNECTOR


CORRUGATED PIPE WATERTIGHT CORRUGATED PIPE ADAPTER BY ADAPTER

TRELLEBORG PIPE SEALS, MILFORD, NH OR EQUIVALENT APPROVED BY

#### DRAINAGE STRUCTURE NOTES

- PROVIDE FRAME AND SOLID COVER ON DRAIN MANHOLES AND FRAME AND GRATE ON CATCH BASINS. SEE DRAINAGE STRUCTURE PARTS LIST.
- 2. CONCRETE SHALL MEET OR EXCEED REQUIREMENTS OF SPECIFICATIONS SECTION 03400.
- 3. WALL THICKNESSES SHOWN ARE FOR REFERENCE ONLY. ACTUAL WALL THICKNESSES SHALL BE DETERMINED BY THE PRECAST CONCRETE MANUFACTURER AT TIME OF CONSTRUCTION. CONTRACTOR SHALL PROVIDE SHOP DRAWINGS TO THE ENGINEER FOR REVIEW IN ACCORDANCE WITH SPECIFICATION SECTION 01340.

(SEE DIAGRAMS THIS SHEET) PLAN VIEW

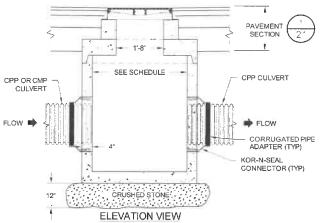

# DRAIN MANHOLE

NOT TO SCALE

SUBJECT MAP: 267

PROJECT NUMBER 4694.00

LOT: 3

SANBORN HEAD

FOR MORE INFORMATION ABOUT THESE PLANS, CONTACT THE CITY OF ROCHESTER PLANNING

DEPARTMENT, 33 WAKEFIELD STREET, ROCHESTER, NH 03867 (603) 335-1338.

ROCHESTER PLANNING BOARD

APPROVAL CERTIFIED BY:

CRUSHED STONE

**ELEVATION VIEW** 

CATCH BASIN - TYPE III (LOW PROFILE)

DATE:

SCALE: AS NOTED

(CB-1)




DRAWN BY: J. ABESAMRA DESIGNED BY: A. MATTHEWS REVIEWED BY: E. STEINHAUSER PROJECT MGR: L. DAMIANO

PIC: E. STEINHAUSER DATE: OCTOBER 2020

CONSTRUCTION DRAWINGS ROCHESTER MATERIALS RECOVERY FACILITY WASTE MANAGEMENT OF NEW HAMPSHIRE, INC ROCHESTER, NEW HAMPSHIRE


STORMWATER INFRASTRUCTURE **DETAILS** 

SHEET NUMBER: 16 OF 25

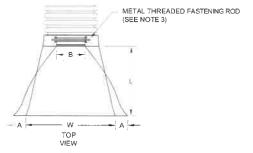


CULVERT END SECTION NOTES:

- THE INVERT OF THE PIPE AND THE END SECTION SHALL BE INSTALLED AT THE SAME ELEVATION.
- THE FLARED END SECTION SHALL BE MANUFACTURED BY ADVANCED DRAINAGE SYSTEMS AND CONSIST OF HIGH DENSITY POLYETHYLENE MEETING ASTM D 3550 MINIMUM CELL CLASSIFICATION 213320C OR EQUIVALENT APPROVED BY THE
- 3. METAL THREADED FASTENING ROD SHALL BE STAINLESS STEEL.

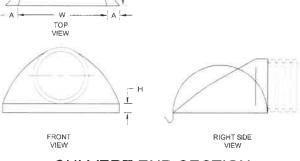

## **CULVERT END SECTION**

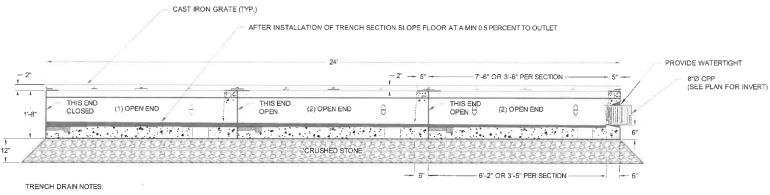

SCALE: AS NOTED

- 1. CONCRETE SHALL MEET OR EXCEED REQUIREMENTS OF SPECIFICATIONS SECTION 03400.
- 2. WALL THICKNESSES SHOWN ARE FOR REFERENCE ONLY. ACTUAL WALL THICKNESSES SHALL BE DETERMINED BY THE PRECAST CONCRETE MANUFACTURER AT TIME OF CONSTRUCTION. CONTRACTOR SHALL PROVIDE SHOP DRAWINGS TO THE ENGINEER FOR REVIEW IN ACCORDANCE WITH SPECIFICATION SECTION 01340.

# TRENCH DRAIN NOT TO SCALE

FOR MORE INFORMATION ABOUT THESE PLANS, CONTACT THE CITY OF ROCHESTER PLANNING DEPARTMENT, 33 WAKEFIELD STREET, ROCHESTER, NH 03867 (603) 335-1338.

ROCHESTER PLANNING BOARD APPROVAL CERTIFIED BY:

DATE:

PAVED AREAS GRASSED AREAS TOPSOIL AND SEED SECTION FILL GRANULAR SOIL (PIPE SIZE VAIRES, REFER TO CULVERT SCHEDULE ON SHEET 15) - PIPE DIA. + 12" MIN --

# CULVERT SECTION

NOT TO SCALE

SUBJECT MAP: 267 LOT: 3

SANBORN HEAD



DRAWN BY: J. ABESAMRA DESIGNED BY: A. MATTHEWS

REVIEWED BY: E. STEINHAUSER

DATE: OCTOBER 2020

PROJECT MGR: L. DAMIANO PIC: E. STEINHAUSER

CONSTRUCTION DRAWINGS


ROCHESTER MATERIALS RECOVERY FACILITY

WASTE MANAGEMENT OF NEW HAMPSHIRE, INC. ROCHESTER, NEW HAMPSHIRE

PROJECT NUMBER 4694.00


STORMWATER INFRASTRUCTURE **DETAILS** 

SHEET NUMBER: 17 OF 25

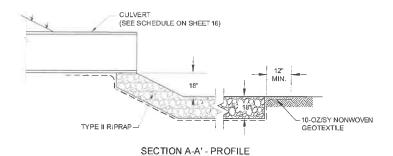

# RIPRAP APRON

NOT TO SCALE

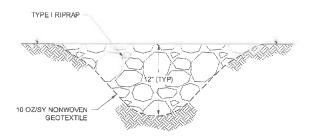

# ARMORED DRAINAGE CHANNEL

SCALE: AS NOTED

NOT TO SCALE

FOR MORE INFORMATION ABOUT THESE PLANS, CONTACT THE CITY OF ROCHESTER PLANNING DEPARTMENT, 33 WAKEFIELD STREET, ROCHESTER, NH 03867 (603) 335-1338.


ROCHESTER PLANNING BOARD APPROVAL CERTIFIED BY:

DATE:

CULVERT (C5) BOTTOM OF SCOUR HOLE EL. = 155.5' 10-OZ/SY NONWOVEN GEOTEXTILE

# RIPRAP SCOUR HOLE

NOT TO SCALE

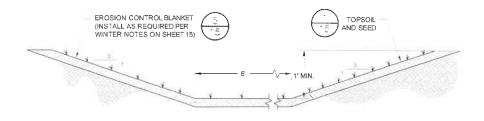

# PRE-TREATMENT SWALE

NOT TO SCALE

SUBJECT MAP: 267 LOT: 3

SANBORN HEAD

11/09/20 ISSUED FOR SITE PLAN APPROVAL APM APM 11/03/20 ISSUED FOR NHDES PERMITTING. 10/23/20 ISSUED FOR BIDDING APM DRAWN BY: L. TEAL

DESIGNED BY: A. MATTHEWS REVIEWED BY: E. STEINHAUSER

PROJECT MGR: L. DAMIANO

PIC: E. STEINHAUSER DATE: OCTOBER 2020


CONSTRUCTION DRAWINGS ROCHESTER MATERIALS RECOVERY FACILITY WASTE MANAGEMENT OF NEW HAMPSHIRE, INC. ROCHESTER, NEW HAMPSHIRE

4694.00

STORMWATER INFRASTRUCTURE **DETAILS** 

SHEET NUMBER: 18 OF 25

PROJECT NUMBER

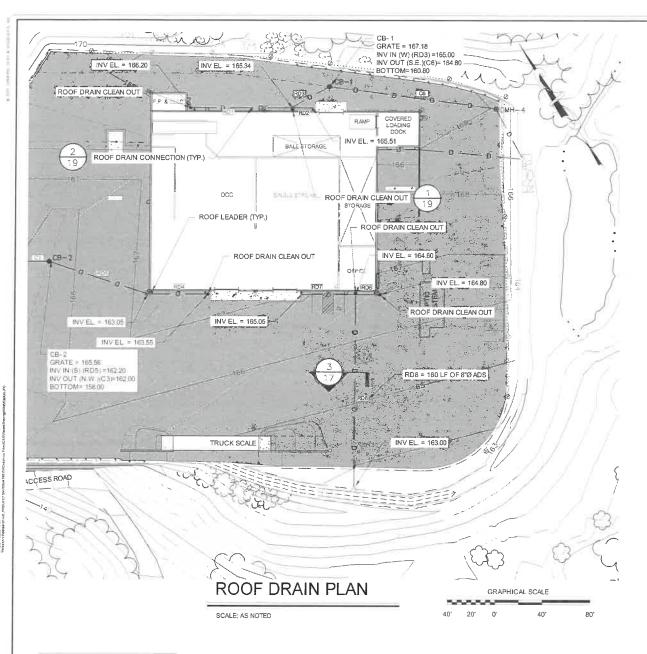

 ROOF DRAIN PIPE SCHEDULE

 PIPE ID
 DIAMETER (IN.)
 LENGTH (FT)

 RD1
 8
 86

 RD2
 8
 17

 RD3
 8
 34

 RD4
 8
 50

 RD5
 8
 85

 RD6
 8
 20

 RD7
 8
 45

 RD8
 8
 160


NOTE:

1. ACTUAL LOCATION OF DOWN SPOUTS WILL BE DETERMINED BY THE MRF DESIGN BUILDER.

FOR MORE INFORMATION ABOUT THESE PLANS, CONTACT THE CITY OF ROCHESTER PLANNING DEPARTMENT, 33 WAKEFIELD STREET, ROCHESTER, NH 03867 (603) 335-1338.


ROCHESTER PLANNING BOARD APPROVAL CERTIFIED BY:


DATE:

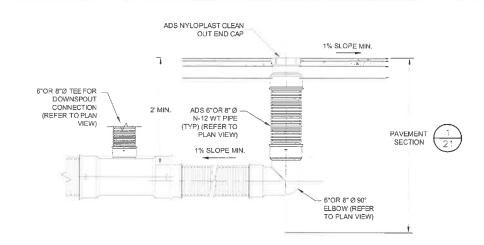

#### ROOF DRAIN CLEANOUT (TYP)

NOT TO SCALE

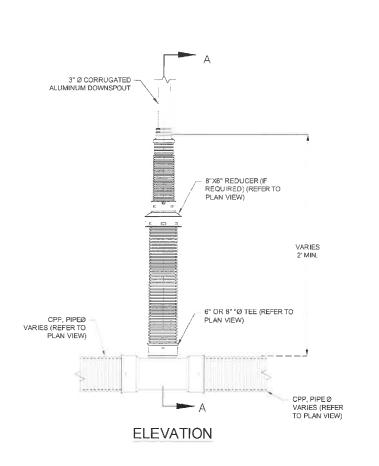

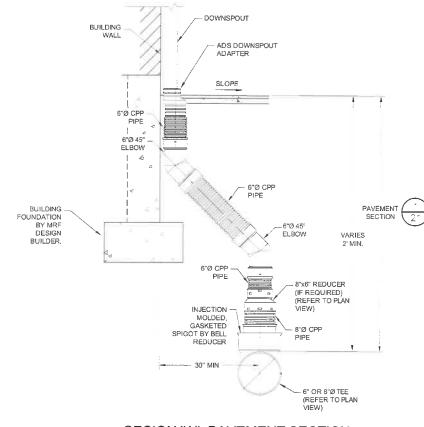

SECION "A", PAVEMENT SECTION


# **ROOF DRAIN CONNECTION (TYP)**

NOT TO SCALE

SUBJECT MAP: 267 LOT: 3

SANBORN | HEAD

SCALE: AS NOTED

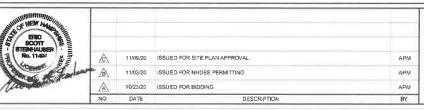

DRAWN BY: J. ABESAMRA
DESIGNED BY: A. MATTHEWS
REVIEWED BY: E. STEINHAUSER
PROJECT MGR: L. DAMIANO


PROJECT MGR: L. DAMIANO
PIC: E. STEINHAUSER
DATE: OCTOBER 2020


CONSTRUCTION DRAWINGS ROCHESTER MATERIALS RECOVERY FACILITY WASTE MANAGEMENT OF NEW HAMPSHIRE, INC. ROCHESTER, NEW HAMPSHIRE

PROJECT NUMBER: 4694.00

ROOF DRAIN PLAN AND DETAILS

19 OF 25

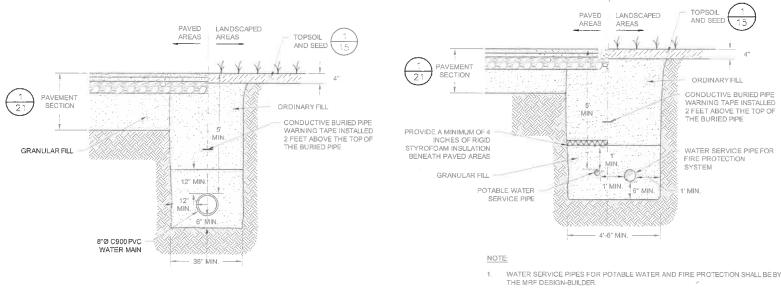

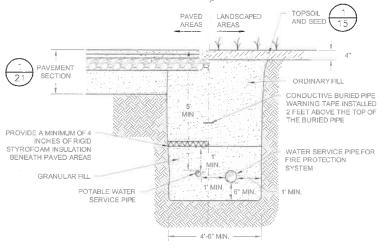

**PLUGS** PLAN & ELEVATION

**TEES** 

CONCRETE

D (ELEVATION VIEW) B (PLAN VIEW) THRUST BLOCK DIMENSIONS (IN FT) 45° 2.5 2.0 11 4 1.5

VALVE BOX

- WATER LINE

GATE STEM FOR "T" WRENCH GATE VALVE/BUTTERFLY VALVE (OPEN RIGHT)

**BENDS** 

BENDS & TEES

**ELEVATION** 

- SUFFICIENT CLEARANCE SHALL BE PROVIDED BETWEEN CONCRETE THRUST BLOCKS AND FLANGE BOLTS TO ALLOW FUTURE DISCONNECTION OF FLANGE BOLTS
- CONCRETE FOR THRUST BLOCKS SHALL HAVE A 28-DAY COMPRESSIVE STRENGTH OF 3,000 PSI.


UNDISTURBED EARTH

PLAN

PIPE BÉDDING


# THRUST BLOCK



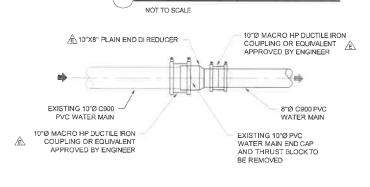

WATER PIPE TRENCH

### CONNECTION TO EXISTING WATER LINE

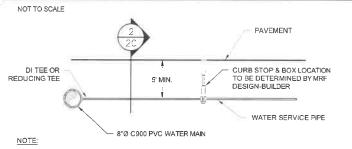

WATER SERVICE PIPES FOR POTABLE WATER AND FIRE PROTECTION SHALL BE BY THE MRF DESIGN-BUILDER. CONTRACTOR SHALL COORDINATE WITH MRF DESIGN-BUILDER TO PROVIDE A STUB FOR THE MRF DESIGN-BUILDER TO CONNECT


### SERVICE CONNECTION


NOT TO SCALE


FOR MORE INFORMATION ABOUT THESE PLANS, CONTACT THE CITY OF ROCHESTER PLANNING DEPARTMENT, 33 WAKEFIELD STREET, ROCHESTER, NH 03867 (603) 335-1338.

ROCHESTER PLANNING BOARD APPROVAL CERTIFIED BY:

DATE

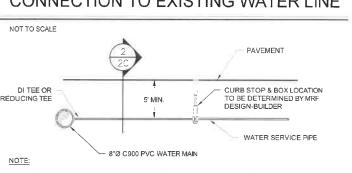

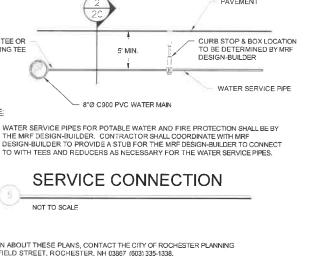

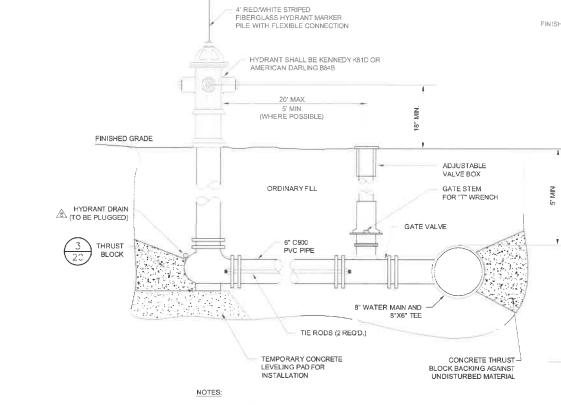

- ALL HYDRANTS SHALL HAVE RETAINER GLANDS.
- CONCRETE BASE AND BLOCKING MATERIAL SHALL NOT BLOCK OR OBSTRUCT HYDRANT DRAIN.
- HYDRANTS AND GATE VALVES SHALL CONFORM TO THE CITY OF ROCHESTER D.P.W. SPECIFICATIONS AND STANDARDS.

# FIRE HYDRANT

ALL GATE VALVES AND FITTINGS SHALL CONFORM TO CITY OF ROCHESTER D.P.W. SPECIFICATIONS AND STANDARDS.

SLEEVE

NOTES:

SUBJECT MAP: 267 LOT: 3

3/4" ROD COUPLING.

SANBORN HEAD

SCALE: AS NOTED

THE OF REEL PROPERTY.				
SCOTT STENGHAUSER	Æ	03/19/21	RESPONSE TO SITE PLAN COMMENTS.	LCT
No. 11404	<u>A</u>	11/09/20	ISSUED FOR SITE PLAN APPROVAL.	APM
CONTRACT OF THE PARTY OF THE PA	B	11/03/20	ISSUED FOR NHDES PERMITTING.	APM
Zeonyment	A	10/23/20	ISSUED FOR BIDDING	АРМ
	NO.	DATE	DESCRIPTION	BY

DRAWN BY: D. DOMBROWSKY DESIGNED BY: A. MATTHEWS REVIEWED BY: E. STEINHAUSER

NOT TO SCALE

PROJECT MGR: L. DAMIANO PIC: E. STEINHAUSER DATE: OCTOBER 2020

CONSTRUCTION DRAWINGS ROCHESTER MATERIALS RECOVERY FACILITY WASTE MANAGEMENT OF NEW HAMPSHIRE, INC. ROCHESTER, NEW HAMPSHIRE

GATE VALVE


WATER SUPPLY AND FIRE HYDRANT DETAILS PROJECT NUMBER: 4694.00

GATE VALVE

SHEET NUMBER: 20 OF 25


TIE ROD

MEGA-LUG RETAINER GLANDS IN ACCORDANCE WITH CITY OF ROCHESTER D.P.W. SPECIFICATIONS SHALL BE USED ON ALL GATE VALVES.

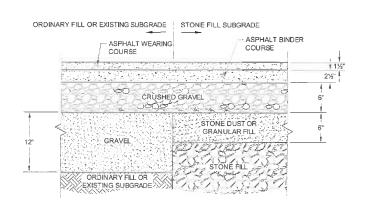


### PAVEMENT SECTION

NOT TO SCALE

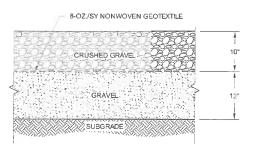

# **SNOW STORAGE AREA CRUSHED GRAVEL SECTION**


NOT TO SCALE

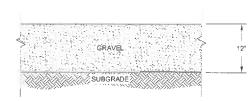

#### **GRAVEL ACCESS ROAD SECTION**

STEEL POST & SYNTHETIC


NOT TO SCALE

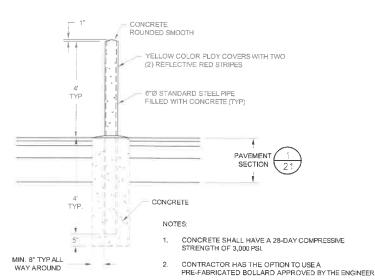

8 ½ ---

# **BOLLARD**

NOT TO SCALE

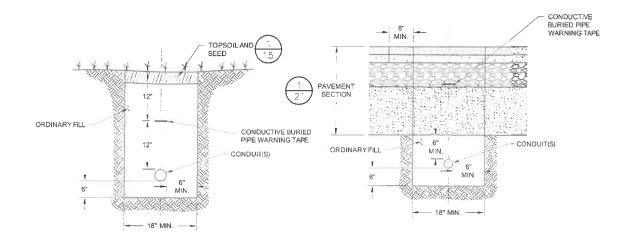

**CONDUIT TRENCH SECTIONS** 

#### WITHIN UNPAVED AREAS

WITHIN PAVED AREAS

NOTE:

NOT TO SCALE

1. CENTER CONDUIT(S) IN TRENCH.

# 6'-3"

8" -

SECTION A-A'

TYPICAL SIDE VIEW

(SHOWN WITH FASTENERS)

7 ½ " 5 ½ "

SECTION B-B' LINE POST ELEVATION VIEW AT **BEAM SPLICE** 

(SHOWN WITHOUT FASTENERS)

# PROVIDE TERMINAL **PLAN VIEW**

POST BOLT SLOT

SPLICE BOLT SLOT

SHOULDER GRADE AT EDGE OF ROAD SURFACE

1. GUARDRAIL SHALL MEET NHDOT REQUIREMENTS FOR STANDARD NO. GR-1.

**GUARDRAIL** 

NOT TO SCALE

SUBJECT MAP: 267 LOT: 3

NOTE: LAP RAIL IN DIRECTION OF TRAFFIC

FOR MORE INFORMATION ABOUT THESE PLANS, CONTACT THE CITY OF ROCHESTER PLANNING DEPARTMENT, 33 WAKEFIELD STREET, ROCHESTER, NH 03867 (803) 335-1338.

ROCHESTER PLANNING BOARD APPROVAL CERTIFIED BY:

DATE:

SANBORN HEAD

SCALE: AS NOTED



DRAWN BY: D. DOMBROWSKY DESIGNED BY: A. MATTHEWS REVIEWED BY: E. STEINHAUSER

PROJECT MGR: L. DAMIANO PIC: E. STEINHAUSER DATE: OCTOBER 2020

ROCHESTER MATERIALS RECOVERY FACILITY WASTE MANAGEMENT OF NEW HAMPSHIRE, INC. ROCHESTER, NEW HAMPSHIRE


CONSTRUCTION DRAWINGS


MISCELLANEOUS DETAILS, SECTIONS, **AND PROFILES** 

SHEET NUMBER: 21 OF 25

PROJECT NUMBER

4694.00

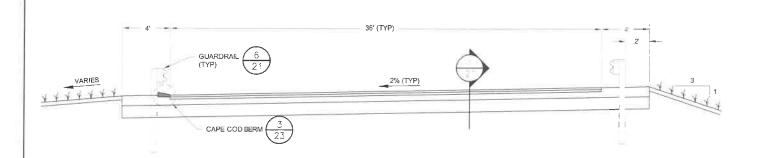

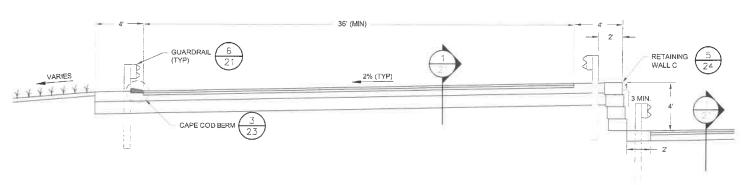


**DRIVEWAY SECTION** 

NOT TO SCALE

**DRIVEWAY SECTION** 

NOT TO SCALE

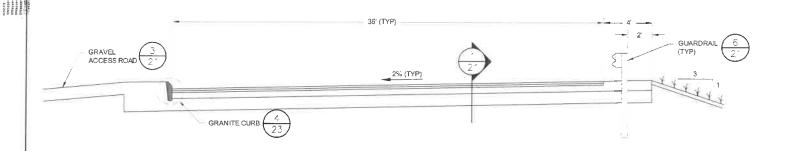

**DRIVEWAY SECTION** 

SCALE: AS NOTED

NOT TO SCALE

FOR MORE INFORMATION ABOUT THESE PLANS, CONTACT THE CITY OF ROCHESTER PLANNING DEPARTMENT, 33 WAKEFIELD STREET, ROCHESTER, NH 03867 (603) 335-1338.

ROCHESTER PLANNING BOARD APPROVAL CERTIFIED BY:

DATE:

SUBJECT MAP: 267 LOT: 3

SANBORN HEAD

APM 10/23/20 ISSUED FOR BIDDING. APM

DRAWN BY: D. DÖMBROWSKY DESIGNED BY: A. MATTHEWS REVIEWED BY: E. STEINHAUSER

PROJECT MGR: L. DAMIANO PIC: E. STEINHAUSER

DATE: OCTOBER 2020


CONSTRUCTION DRAWINGS ROCHESTER MATERIALS RECOVERY FACILITY WASTE MANAGEMENT OF NEW HAMPSHIRE, INC. ROCHESTER, NEW HAMPSHIRE MISCELLANEOUS DETAILS, SECTIONS,


AND PROFILES

SHEET NUMBER: 22 OF 25

PROJECT NUMBER

4694.00

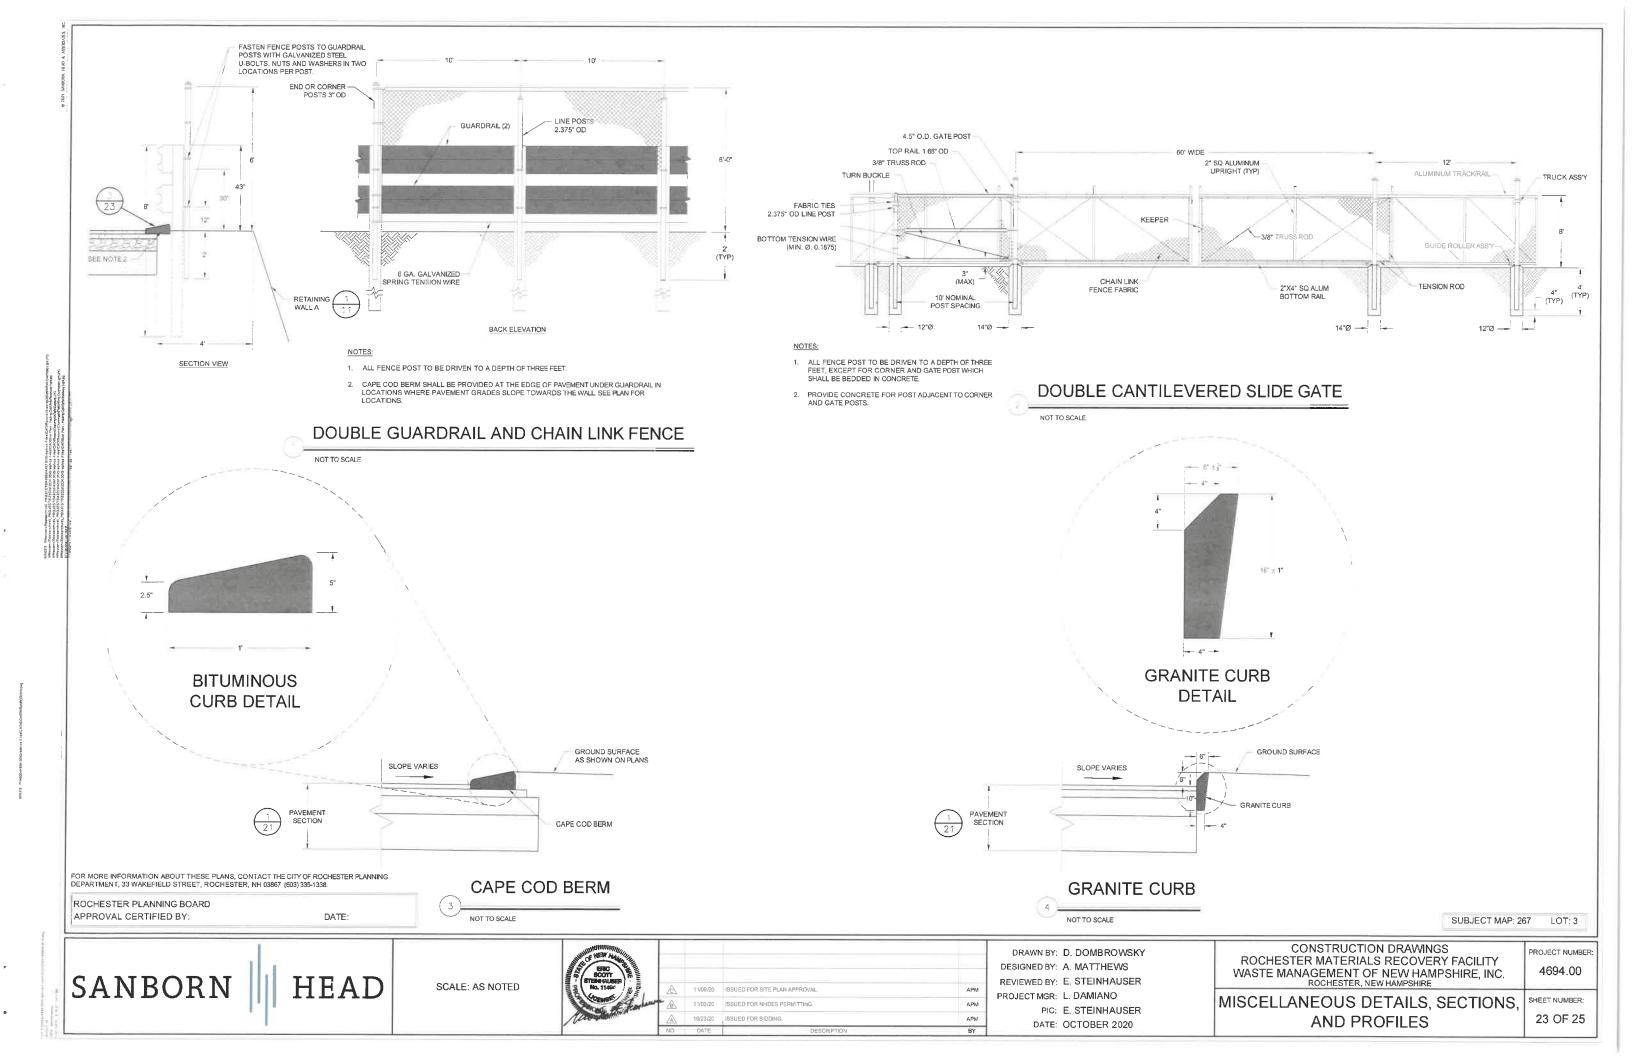

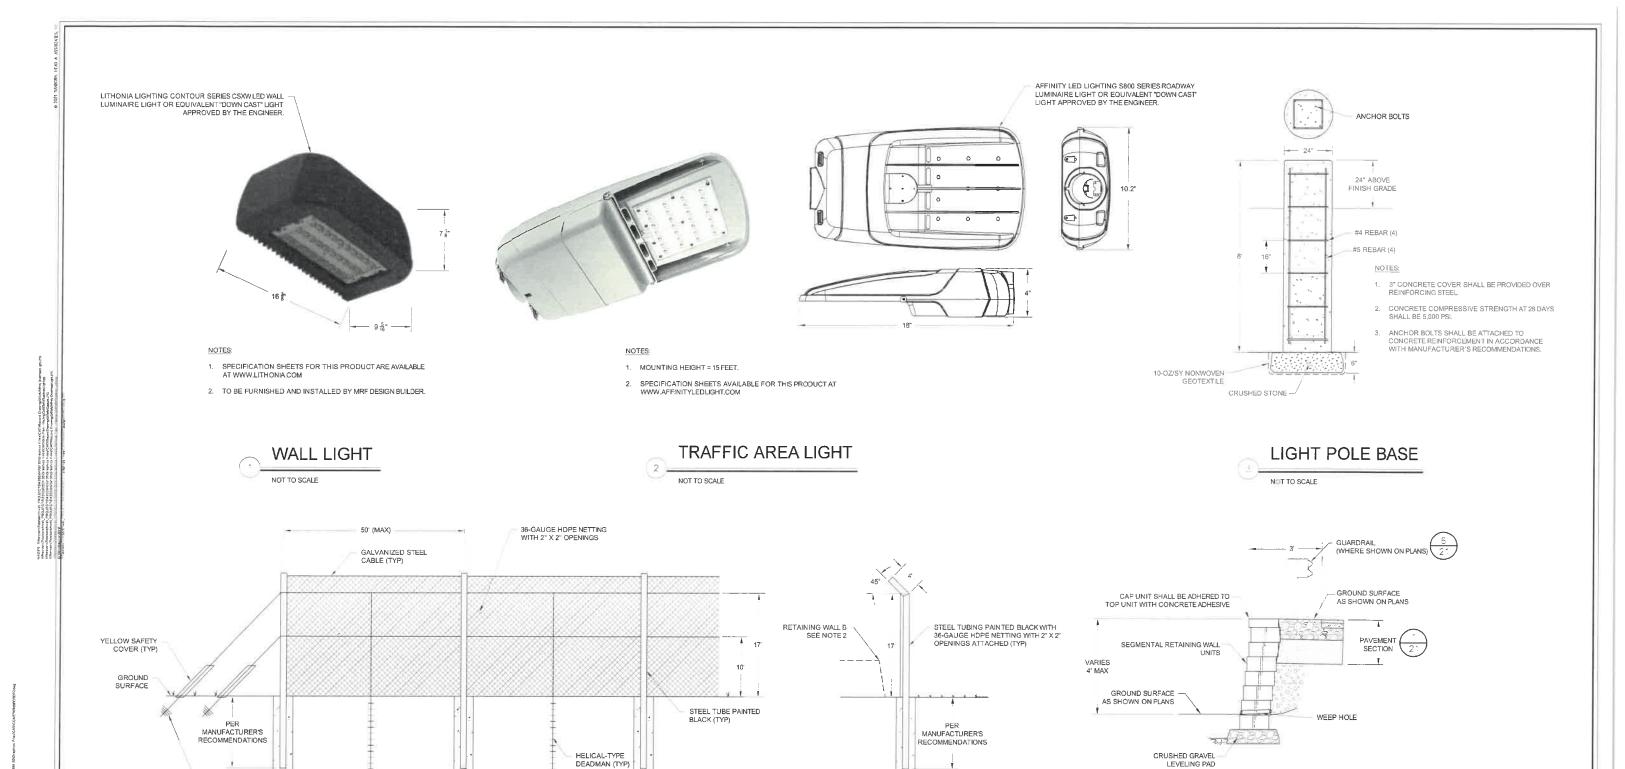

SECTION VIEW

SEGMENTAL RETAINING WALL SYSTEM (INCLUDING WALL BACKFILL) SHALL BE DESIGNED BY A NEW HAMPSHIRE LICENSED PROFESSIONAL ENGINEER.

# **RETAINING WALLS B & C SECTION**

NOT TO SCALE

SUBJECT MAP: 267 LOT: 3

SANBORN HEAD

FOR MORE INFORMATION ABOUT THESE PLANS, CONTACT THE CITY OF ROCHESTER PLANNING

DEPARTMENT, 33 WAKEFIELD STREET, ROCHESTER, NH 03867 (603) 335-1338.

ROCHESTER PLANNING BOARD APPROVAL CERTIFIED BY:

GALVANIZED STEEL CABLE TO BE ANCHORED

DATE:


INTO GROUND PER MANUFACTURER'S RECOMMENDATIONS (TYP)

SCALE: AS NOTED

ELEVATION

NOT TO SCALE

LITTER FENCE

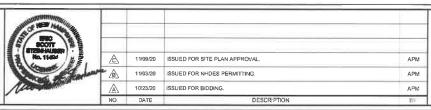

1. ALL FENCE SECTIONS NEED TO BE EXTENDED TO GROUND SURFACE

WHERE A RETAINING WALL IS ADJACENT TO THE PROPOSED LITTER FENCE ALIGNMENT, THE HEIGHT OF THE LITTER FENCE SHALL BE EXTENDED BY APPROXIMATELY THE HEIGHT OF THE WALL ADJACENT TO THE LITTER FENCE.

LITTER FENCE NOTES:

EXCEPT WHERE NOTED.

DRAWN BY: D. DOMBROWSKY DESIGNED BY: A. MATTHEWS REVIEWED BY: E. STEINHAUSER

PROJECT MGR: L. DAMIANO

PIC: E. STEINHAUSER DATE: OCTOBER 2020

CONSTRUCTION DRAWINGS ROCHESTER MATERIALS RECOVERY FACILITY WASTE MANAGEMENT OF NEW HAMPSHIRE, INC. ROCHESTER, NEW HAMPSHIRE

PROJECT NUMBER 4694.00

MISCELLANEOUS DETAILS, SECTIONS, **AND PROFILES** 

SHEET NUMBER: 24 OF 25



- Neck and forelimbs are
- Characterized by its highly sculpted shell with each large scute taking on an irregular pyramidal shape.
- Adults can be 5-8 inches





Please report sightings to NH Fish and Game at RAARP@wildlife.nh.gov or at 603-271-2461. Photo documentation, location, and date/time of observation is helpful.

NOTE: It is illegal to remove a wood turtle from the wild (RSA 207:1, FIS 804.02).

# **Northern Black Racer**

(New Hampshire state threatened species)





- Solid black with a white throat
- Slender with glossy scales, 3-6 ft.
- Hatchlings are very small and




Immediately report sightings to NH Fish and Game Melissa Doperalski (603-419-1129) or **Brendan Clifford (603-944-0885)** Please report promptly, noting specific location and date Photographs strongly encouraged



FOR MORE INFORMATION ABOUT THESE PLANS, CONTACT THE CITY OF ROCHESTER PLANNING DEPARTMENT, 33 WAKEFIELD STREET, ROCHESTER, NH 03867 (603) 335-1338.

ROCHESTER PLANNING BOARD APPROVAL CERTIFIED BY:

HEAD

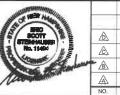

Commence	$\overline{}$			
A PARTILLE				
SEC SCOTT	A	2/05/21	ADDED SHEET PER NH FISH AND GAME COMMENTS	DJD
No. 11484	A	11/09/20	ISSUED FOR SITE PLAN APPROVAL.	APN
	B	1 1/03/20	ISSUED FOR NHDES PERMITTING.	APA
Day of the Park	A	10/23/20	ISSUED FOR BIDDING.	APM
	NO.	DATE	DESCRIPTION	BY

DRAWN BY: D. DOMBROWSKY

DESIGNED BY: A. MATTHEWS REVIEWED BY: E. STEINHAUSER

PROJECT MGR: L. DAMIANO

PIC: E. STEINHAUSER DATE: OCTOBER 2020

SUBJECT MAP: 267 LOT: 3 CONSTRUCTION DRAWINGS ROCHESTER MATERIALS RECOVERY FACILITY WASTE MANAGEMENT OF NEW HAMPSHIRE, INC. ROCHESTER, NEW HAMPSHIRE

POTENTIAL THREATENED OR **ENDANGERED SPECIES FLYERS**  SHEET NUMBER: 25 OF 25

4694.00