



Revised 1/7/2019

Modification to Approved Project By

City of Rochester, New Hampshire

Case #	216-11-GRD-14	_ Property Address	127 Marketplace Blvd; Suite 3	
Type of project:	Site PlanX_;	Subdivision;	Line Adjustment; Other	
Project name _	The Ridge Mark	ketplace		
Date of original Planning Board approval: May 5, 2014				
Description of modification: Construction of a drive-thru lane for Tropical Smoothie within an existing parking lot. Modifications to the parking lot consist of eliminating seven (7) parking spaces to allow for a drive-thru lane that provides a queue for seven (7) cars.				
Name of applicant or agent filling out this form:Tighe & Bond (Patrick Crimmins)				
Mailing Address: 177 Corporate Drive, Portsmouth, NH 03801				
Phone Number: 603-433-8818 Email Address: PMCrimmins@TigheBond.com				
Please check box: Applicant Agent				
Signature of person completing form: Date: 8 31 20				
Signature of prop	erty owner (if differ	ent):	Date:	
Please note: Modifications are reviewed by the Planning Board but no public hearing is held and no notices are required. (In contrast, projects, which are considered to have a potential impact upon abutters, are considered amendments for which notice and a public hearing is required.) There is a \$125.00 fee for a modification. For very simple matters ("administrative modifications") approved by staff, there is no fee.				


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THE RIDGE MARKETPLACE

FARMINGTON ROAD (ROUTE 11) ROCHESTER, NEW HAMPSHIRE PERMIT DRAWINGS OCTOBER 5, 2020



	LIST OF DRAWINGS	
SHEET NO.	SHEET TITLE	LAST REVISED
	COVER SHEET	10/05/2020
C-101.1	OVERALL EXISTING CONDITIONS PLAN 10/05/20	
C-101.2	EXISTING CONDITIONS / DEMOLITION PLAN	10/05/2020
C-102.1	OVERALL SITE PLAN 10/05/202	
C-102.2	SITE PLAN 10/05/2020	
C-103	GRADING, DRAINAGE & EROSION CONTROL PLAN 10/05/2020	
C-104	C-104 UTILITY PLAN 10/05/2020	
C-501	EROSION CONTROL NOTES & DETAILS SHEET	10/05/2020
C-502	502 DETAILS SHEET 10/05/202	

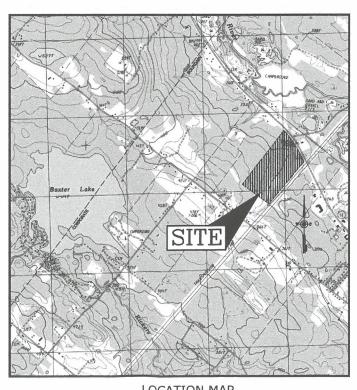

LOCATION MAP

PREPARED BY:




OWNER:


Waterstone Rochester, LLC 322 Reservoir Street Needham, MA 02494








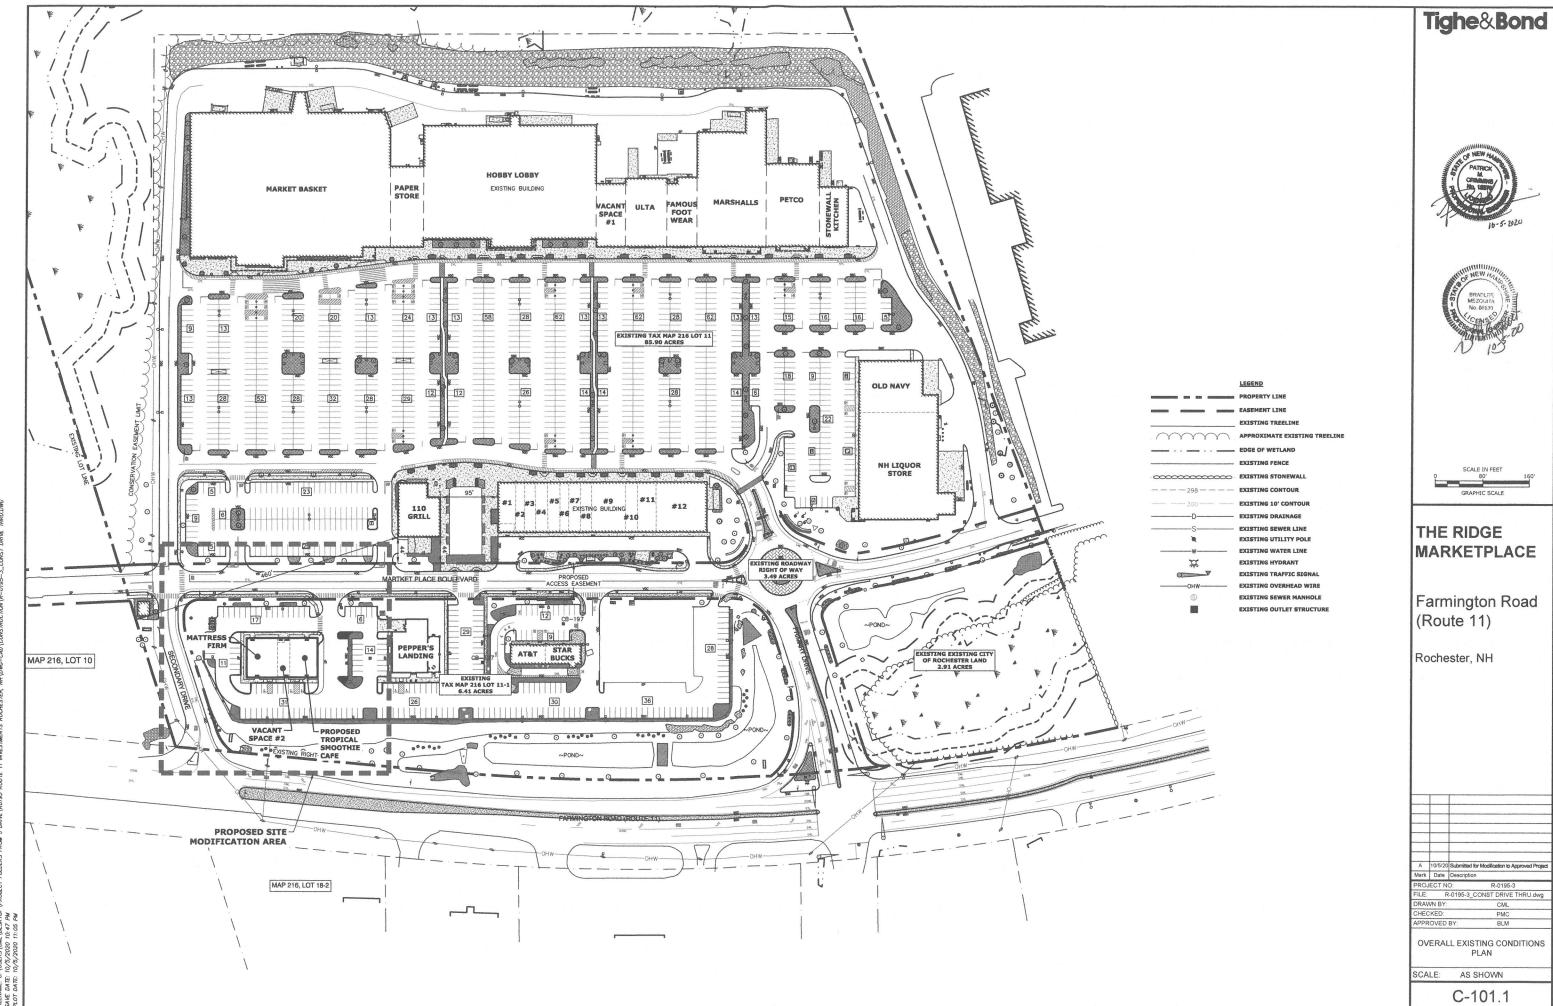

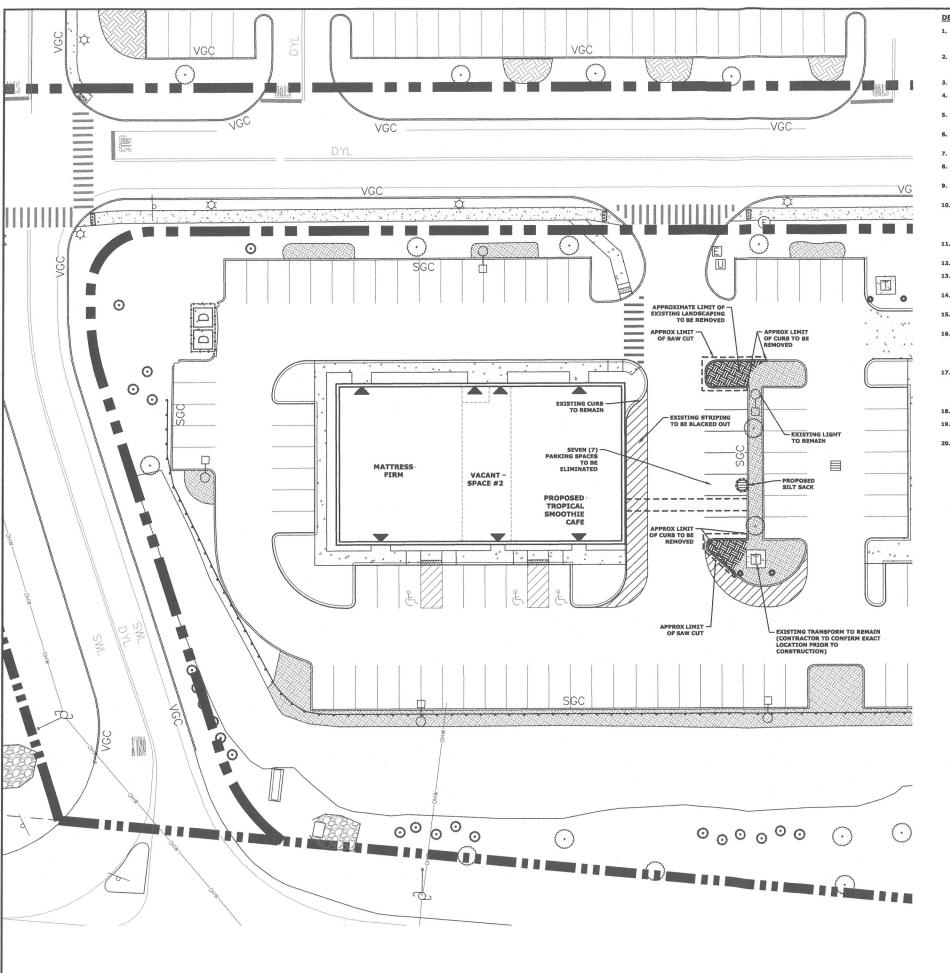

DEMOLITION NOTES:

- THE LOCATIONS OF UNDERGROUND UTILITIES ARE APPROXIMATE AND THE LOCATIONS ARE NOT GUARANTEED BY THE OWNER OR THE ENGINEER. IT 15 THE CONTRACTOR'S RESPONSIBILITY TO LOCATE ALL UTILITIES, ANTICIPATE CONFLICTS, REPAIR EXISTING UTILITIES AND RELOCATE EXISTING UTILITIES REQUIRED TO COMPLETE THE WORK.
- ALL MATERIALS SCHEDULED TO BE REMOVED SHALL BECOME THE PROPERTY OF THE CONTRACTOR UNLESS OTHERWISE SPECIFIED. THE
 CONTRACTOR SHALL DISPOSE OF ALL MATERIALS OFF-SITE IN ACCORDANCE WITH ALL FEDERAL, STATE, AND LOCAL REGULATIONS,
 ORDINANCES AND CODES.
- 3. COORDINATE REMOVAL, RELOCATION, DISPOSAL OR SALVAGE OF UTILITIES WITH THE OWNER AND APPROPRIATE UTILITY COMPANY.
- ANY EXISTING WORK OR PROPERTY DAMAGED OR DISRUPTED BY CONSTRUCTION/ DEMOLITION ACTIVITIES SHALL BE REPLACED O
 REPAIRED TO MATCH ORIGINAL EXISTING CONDITIONS BY THE CONTRACTOR AT NO ADDITIONAL COST TO THE OWNER.
- 5. THE CONTRACTOR SHALL VERIFY LOCATION OF ALL EXISTING UTILITIES. CALL DIG SAFE AT LEAST 72 HOURS PRIOR TO THE COMMENCEMENT OF ANY DEMOLITION/CONSTRUCTION ACTIVITIES.
- SAWCUT AND REMOVE PAVEMENT ONE FOOT OFF PROPOSED EDGE OF PAVEMENT OR EXISTING CURB LINE IN ALL AREAS WHERE PAVEMENT TO BE REMOVED ABUTS EXISTING PAVEMENT OR CONCRETE TO REMAIN.
- 7. IT IS THE CONTRACTOR'S RESPONSIBILITY TO FAMILIARIZE THEMSELVES WITH THE CONDITIONS OF ALL OF THE PERMIT APPROVALS.
- 8. THE CONTRACTOR SHALL OBTAIN AND PAY FOR ADDITIONAL PERMITS, NOTICES AND FEES NECESSARY TO COMPLETE THE WORK AND ARRANGE FOR AND PAY FOR NECESSARY INSPECTIONS AND APPROVALS FROM THE AUTHORITIES HAVING JURISDICTION.
- THE CONTRACTOR SHALL BE RESPONSIBLE FOR ALL DEMOLITION AND OFF-SITE DISPOSAL OF MATERIALS REQUIRED TO COMPLETE THE WORK, EXCEPT FOR WORK NOTED TO BE COMPLETED BY OTHERS.
- 10. UTILITIES SHALL BE TERMINATED AT THE MAIN LINE PER UTILITY COMPANY STANDARDS. THE CONTRACTOR SHALL REMOVE ALL ABANDONED UTILITIES LOCATED WITHIN THE LIMITS OF WORK. CONTRACTOR SHALL VERIFY ORIGIN OF ALL DRAINS AND UTILITIES PRIOR TO REMOVAL/TERMINATION TO DETERMINE IF DRAINS OR UTILITY IS ACTIVE AND SENCES ANY ON OFF-STIE STRUCTURE TO REMAIN. CONTRACTOR SHALL NOTIFY ENGINEER IMMEDIATELY OF ANY SUCH UTILITY FOUND AND SHALL MAINTAIN THESE UTILITIES UNTIL PERMANENT SOLUTION IS IN PLACE.
- 11. PAVEMENT REMOVAL LIMITS ARE SHOWN FOR CONTRACTOR'S CONVENIENCE. ADDITIONAL PAVEMENT REMOVAL MAY BE REQUIRED DEPENDING ON THE CONTRACTOR'S OPERATION. CONTRACTOR TO VERIFY FULL LIMITS OF PAVEMENT REMOVAL PRIOR TO BID.
- 12. THE CONTRACTOR SHALL REMOVE AND DISPOSE OF ALL EXISTING UTILITIES AND PAVEMENT WITHIN THE WORK LIMITS SHOWN.
- 13. COORDINATE ALL WORK WITHIN THE PUBLIC RIGHT OF WAYS WITH THE CITY OF ROCHESTER AND THE NEW HAMPSHIRE DEPARTMENT OF TRANSPORTATION.
- 14. REMOVE TREES AND BRUSH AS REQUIRED FOR COMPLETION OF WORK. CONTRACTOR SHALL GRUB AND REMOVE ALL STUMPS WITHIN LIMITS OF WORK AND DISPOSE OF OFF SITE IN ACCORDANCE WITH FEDERAL, STATE, AND LOCAL LAWS AND REGULATIONS.
- 15. CONTRACTOR SHALL PROTECT ALL PROPERTY MONUMENTATION THROUGHOUT DEMOLITION AND CONSTRUCTION OPERATIONS. SHOULD ANY MONUMENTATION BE DISTURBED BY BY THE CONTRACTOR, HE SHALL EMPLOY A LICENSED SURVEYOR TO REPLACE IT.
- 16. PROVIDE INLET PROTECTION BARRIERS AT ALL CATCH BASINS WITHIN CONSTRUCTION LIMITS AND MAINTAIN FOR THE DURATION OF THE PROJECT. INLET PROTECTION BARRIERS SHALL BE "HIGH FLOW SILT SACK" BY ACF ENVIRONMENTAL OR APPROVED EQUAL. INSPECT BARRIERS WEEKLY AND AFTER EACH RAIN OF 0.25 INCHES OR REFATER. CONTRACTOR SHALL COMPLETE A MAINTENANCE INSPECTION REPORT AFTER EACH XINSPECTION. SEDIMENT DEPOSITS SHALL BE REMOVED AFTER EACH STORM EVENT OR MORE OFTEN IF THE FABRIC BECOMES CLOGGED.
- 17. THE CONTRACTOR SHALL PHASE DEMOLITION AND CONSTRUCTION AS REQUIRED TO PROVIDE CONTINUOUS SERVICE TO EXISTING BUSINESSES AND HOMES THROUGHOUT THE CONSTRUCTION PERIOD. EXISTING BUSINESS AND HOME SERVICES INCLUDE, BUT ARE NOT LIMITED TO ELECTRICAL, COMMUNICATION, FIRE PROTECTION, DOMESTIC WATER AND SEWER SERVICES. TEMPORARY SERVICES, IF REQUIRED, SHALL COMPLY WITH ALL FEDERAL, STATE, LOCAL AND UTILITY COMPANY STANDARDS. CONTRACTOR SHALL PROVIDE DETAILED CONSTRUCTION SCHEDULE TO OWNER PRIOR TO ANY DEMOLITION/CONSTRUCTION ACTIVITIES.
- 18. EROSION CONTROL MEASURES SHALL BE INSTALLED PRIOR TO THE START OF ANY CLEARING OR DEMOLITION ACTIVITIES.
- 19. THE CONTRACTOR SHALL PAY ALL COSTS NECESSARY FOR TEMPORARY PARTITIONING, BARRICADING, FENCING, SECURITY AND SAFETY DEVICES REQUIRED FOR THE MAINTENANCE OF A CLEAN AND SAFE CONSTRUCTION SITE.
- 20. SAWCUT AND REMOVE PAVEMENT AND CONSTRUCT PAVEMENT TRENCH PATCH FOR ALL UTILITIES TO BE REMOVED AND PROPOSED UTILITIES LOCATED IN EXISTING PAVEMENT AREAS TO REMAIN.

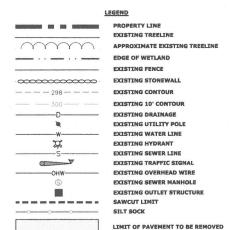









THE RIDGE MARKETPLACE

Farmington Road (Route 11)


Rochester, NH


A 10/5/20 Submitted for Modification to Approved Project
Mark Date Description
PROJECT NO: R-0195-3
FILE: R-0195-3_CONST DRIVE THRU dwg
DRAWN BY: CML
CHECKED: PMC
APPROVED BY: BLM

EXISTING CONDITIONS / DEMOLITION PLAN

SCALE: AS SHOWN

C-101.2

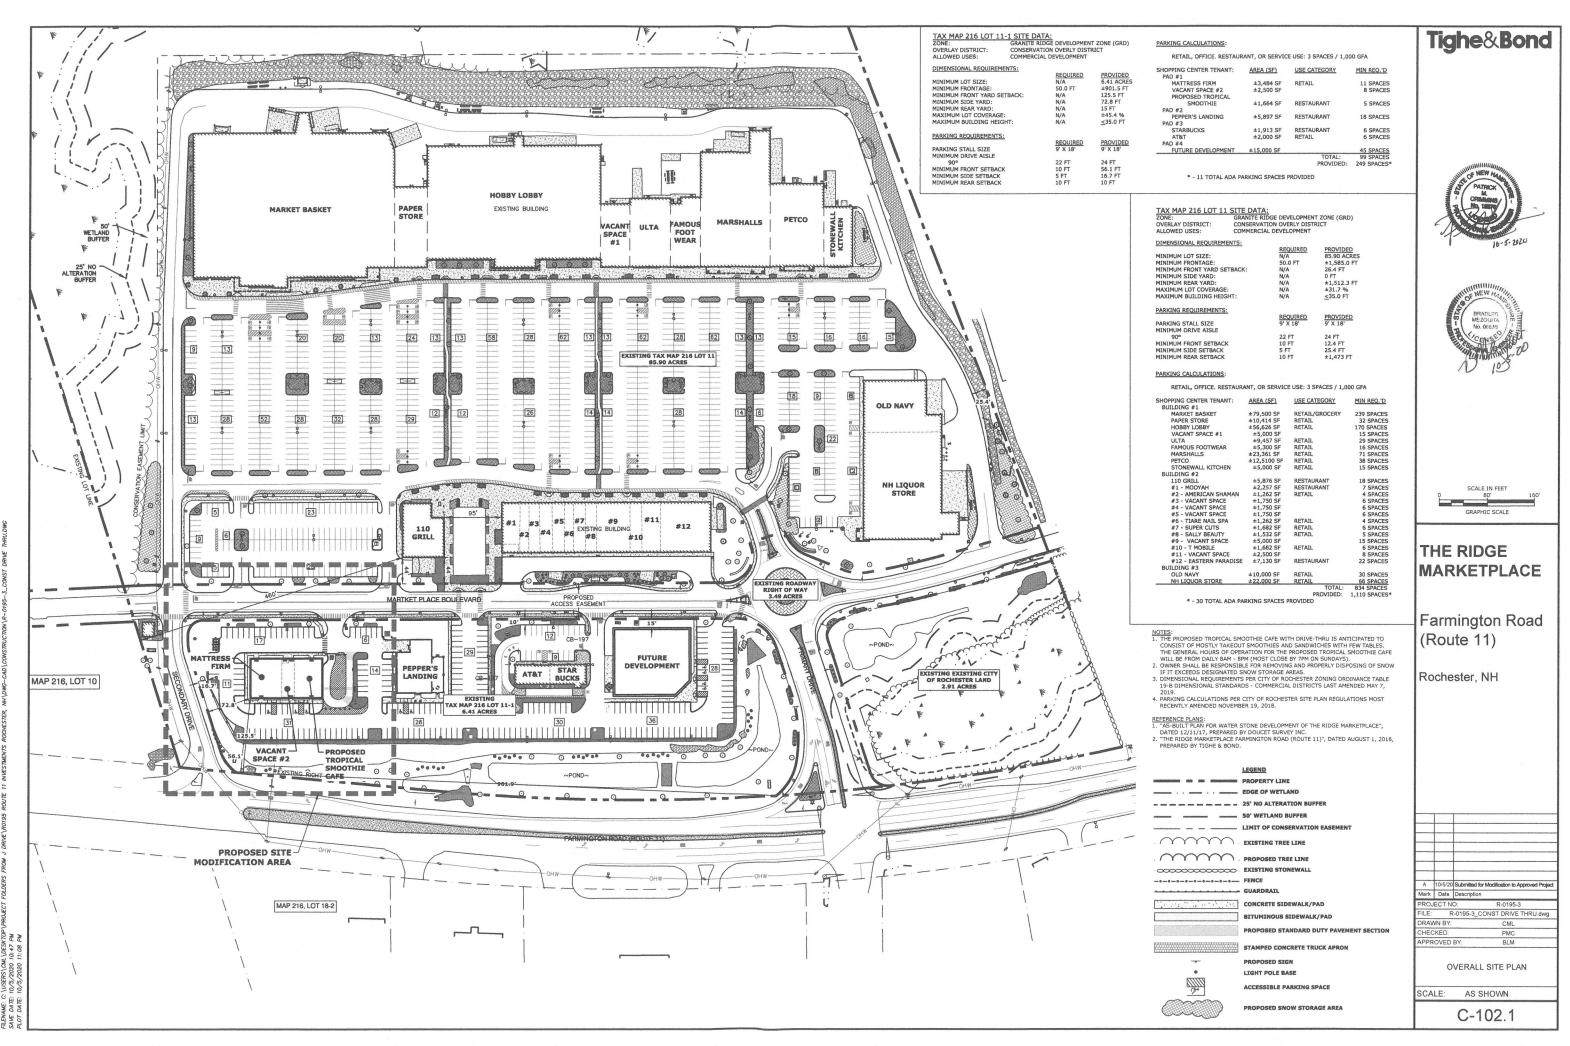

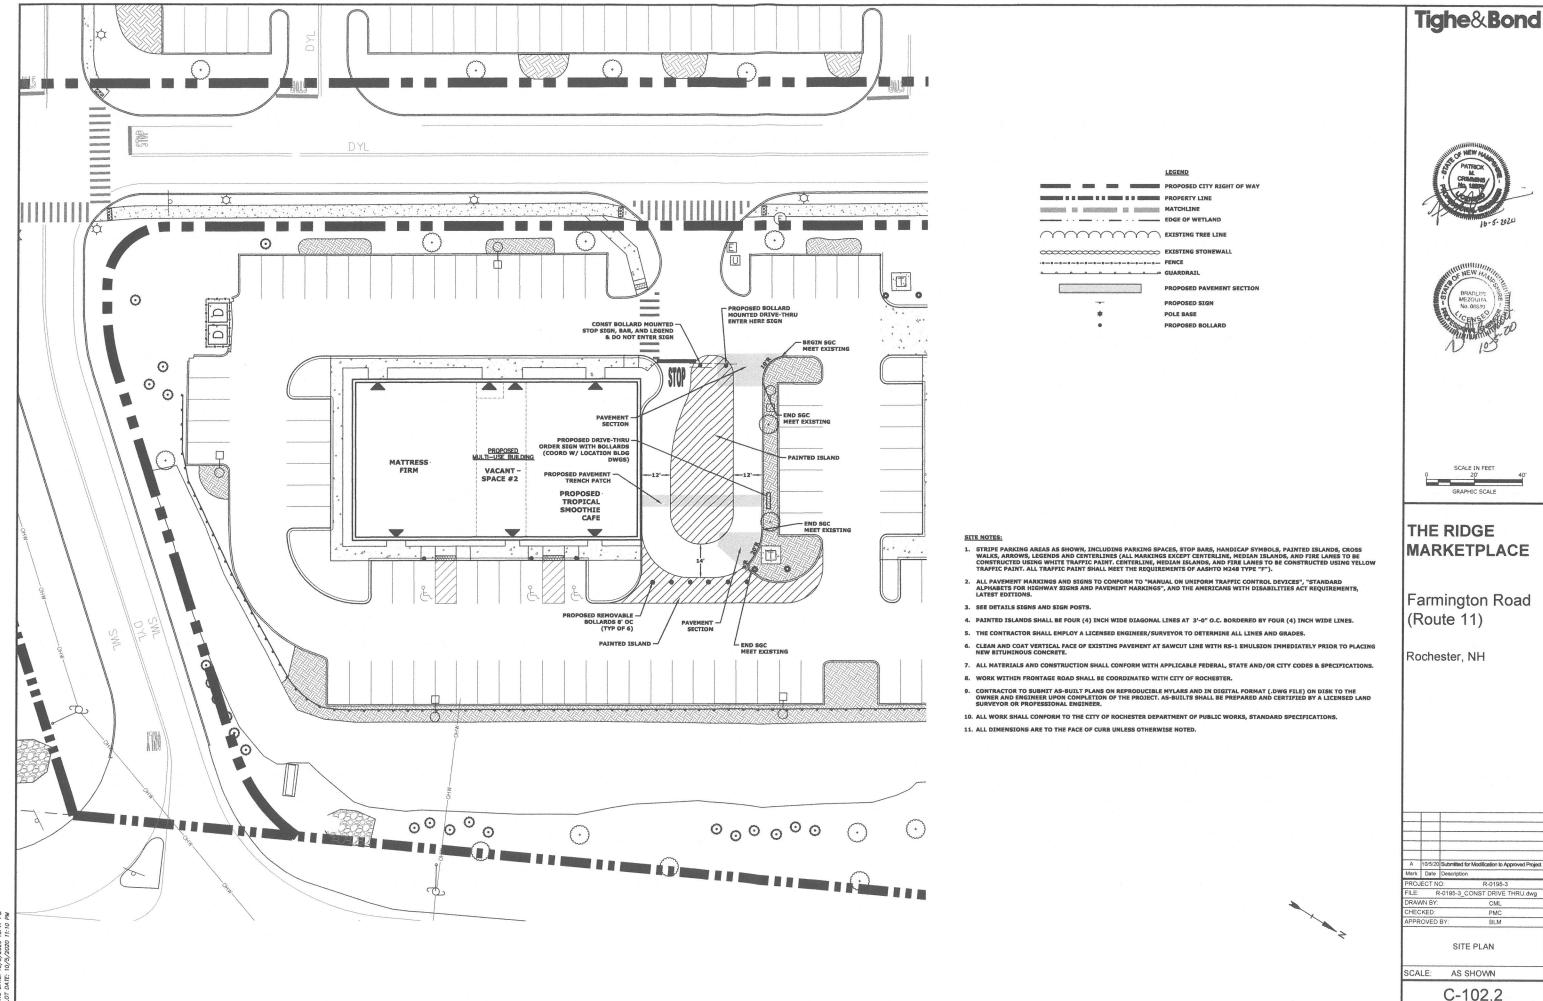

FILENAME: C. (USERS)CMI, DESKTOP/PROJECT FOLDERS FROM J DRIVE\R0195 ROUTE 11 INVESTMENTS ROCHESTER, MH\DING-CAD) SAWF DATE: 1075/2020 104.37 BM

GRADING AND DRAINAGE NOTES:

COMPACTION REQUIREMENTS BELOW PAVED OR CONCRETE AREAS

TRENCH BEDDING MATERIAL AND SAND BLANKET BACKFILL

BELOW LOAM AND SEED AREAS 90%

*ALL PERCENTAGES OF COMPACTION SHALL BE OF THE MAXIMUM DRY DENSITY AT THE OPTIMUM MOISTURE CONTENT AS DETERMINED AND CONTROLLED IN ACCORDANCE WITH ASTM D-1557, METHOD C FIELD DENSITY TESTS SHALL BE MADE IN ACCORDANCE WITH ASTM D-1556 OR ASTM-2922.

- ALL STORM DRAINAGE PIPES SHALL BE HIGH DENSITY POLYETHYLENE (HANCOR HI-Q, ADS N-12 OR APPROVED EQUAL) OR RCP CLASS IV, UNLESS OTHERWISE SPECIFIED.
- 3. ADJUST ALL MANHOLES, CATCHBASINS, CURB BOXES, ETC. WITHIN LIMITS OF WORK TO FINISH GRADE.
- CONTRACTOR SHALL PROVIDE A FINISHED PAVEMENT SURFACE AND LAWN AREAS FREE OF LOW SPOTS AND PONDING AREAS. CRITICAL AREAS INCLUDE BUILDING ENTRANCES, EXITS, RAMPS AND LOADING DOCK AREAS ADJACENT TO THE BUILDING.
- 5. CONTRACTOR SHALL THOROUGHLY CLEAN ALL CATCHBASINS AND DRAIN LINES, WITHIN THE LIMIT OF WORK, OF SEDIMENT IMMEDIATELY UPON COMPLETION OF CONSTRUCTION.
- ALL MATERIALS AND CONSTRUCTION SHALL CONFORM WITH APPLICABLE FEDERAL, STATE AND LOCAL CODES.

EROSION CONTROL NOTES:

- 1. INSTALL EROSION CONTROL BARRIERS AS SHOWN AS FIRST ORDER OF WORK.
- 2. SEE GENERAL EROSION CONTROL NOTES ON EROSION CONTROL NOTES SHEET
- 3. PROVIDE SILT SACK INLET PROTECTION WITHIN ALL EXISTING AND PROPOSED CATCH BASIN INLETS WITHIN THE WORK LIMITS. MAINTAIN FOR THE DURATION OF THE PROJECT UNTIL PAVEMENT HAS BEEN INSTALLED.
- 4. INSTALL STABILIZED CONSTRUCTION ENTRANCES/EXITS.
- INSPECT INLET PROTECTION AND SILT SOCKS WEEKLY AND AFTER EACH RAIN STORM OF 0.25 INCH OR GREATER. REPAIR/MODIFY PROTECTION AS NECESSARY TO MAXIMIZE EFFICIENCY OF FILTER. REPLACE ALL FILTERS WHEN SEDIMENT IS 1/3 THE FILTER HEIGHT.
- 6. ALL DISTURBED AREAS NOT OTHERWISE BEING TREATED SHALL RECEIVE 4" LOAM, SEED, AND FERTILIZER OR 3" PERMANENT MULCH AND SEED.
- 7. CONSTRUCT EXCELSIOR MAT ON ALL SLOPES STEEPER THAN 3:1.
- 8. PRIOR TO ANY WORK OR SOIL DISTURBANCE COMMENCING ON THE SUBJECT PROPERTY, INCLUDING MOVING OF EARTH, THE APPLICANT SHALL INSTALL ALL EROSION AND SILTATION MITIGATION AND CONTROL MEASURES AS REQUIRED BY STATE AND LOCAL PERMITS AND APPROVALS.
- CONTRACTOR SHALL BE RESPONSIBLE TO CONTROL DUST AND WIND EROSION THROUGHOUT THE CONSTRUCTION PERIOD. DUST CONTROL MEASURES SHALL INCLUDE, BUT NOT LIMITED TO, SPRINKLING WATER ON UNSTABLE SOILS SUBJECT TO ARID CONDITIONS.
- 10. THE CONTRACTOR SHALL REMOVE AND PROPERLY DISPOSE OF ALL TEMPORARY EROSION CONTROL DEVICES UPON COMPLETION OF CONSTRUCTION.
- 11. TEMPORARY SOIL STOCKPILE SHALL BE SURROUNDED BY SILT SOCK AND SHALL BE STABILIZED BY TEMPORARY EROSION CONTROL SEEDING, STOCKPILE AREAS TO BE LOCATED AS PAR AS POSSIBLE FROM THE DELINEATED EDGE OF WETLAND.
- 12. SAFETY FENCING SHALL BE PROVIDED AROUND STOCKPILES OVER 10 FT.
- 13. THE ALTERATION OF TERRAIN PERMIT HOLDER MUST SUBMIT TO THE NEW HAMPSHIRE DEPARTMENT OF ENVIRONMENTAL SERVICES A WRITTEN UPDATE OF THE PROJECT AND REVISED PLANS DOCUMENTING THE PROJECT EVERY FIVE YEARS FROM THE DATE OF THE PERMIT.

	LEGEND
	PROPERTY LINE
	EDGE OF WETLAND
- 0000000000000000	EXISTING STONEWALL
	EXISTING CONTOUR
	EXISTING 10' CONTOUR
261	FINISHED GRADE
	EXISTING DRAINAGE
PD	PROPOSED DRAINAGE
	PROPOSED DRAINAGE W/INSULATION (LESS THEN 4' OF COVER)
	CATCH BASIN
0	DRAIN MANHOLE
•	YARD DRAIN
×271.6	PROPOSED SPOT GRADE
TYP.	TYPICAL
CONST.	CONSTRUCT
	PROPOSED SILT SOCK
0	INLET PROTECTION BARRIER









THE RIDGE **MARKETPLACE**

Farmington Road (Route 11)

Rochester, NH

R-0195-3 CONST DRIVE THRU dv

GRADING, DRAINAGE, AND

AS SHOWN

C-103

DATE DATE

- SEE SITE PLAN FOR PAVEMENT WIDTH AND LOCATION.
 SEE GRADING, DRAINAGE AND EROSION CONTROL PLAN FOR
 PAVEMENT SLOPE AND CROSS-SLOPE.
 A TACK COAT SHALL BE PLACED ON TOP OF BINDER COURSE.
 PAVEMENT PRIOR TO PLACING WEARING COURSE.
 THIS DETAIL SF FOR PLANNING PURPOSES ONLY. FINAL
 PAVEMENT DESIGN SHOULD BE BASED ON THE
 RECOMMENDATIONS OF A GEOTECHNICAL ENGINEER AFTER A
 SITE INVESTIGATION.

STANDARD DUTY PAVEMENT SECTION

GRANITE CURB STRAIGHT OR CURVED 1:1 SLOPE RADIUS LENGTH ISE CURVED CURB USE RADIAL JOINTS NOTES:

1. SEE STEP PLAN FOR LIMITS OF CURBING.

2. ADJOINING STONES OF STRAIGHT CURB LAID ON CURVES.

3. ADJOINING STONES OF STRAIGHT CURB LAID ON CURVES.

3. MINIMUM LENGTH OF STRAIGHT CURB STONES = 18 INCHES.

4. MAXIMUM LENGTH OF STRAIGHT CURB STONES = 6 FEET.


5. MAXIMUM LENGTH OF STRAIGHT CURB STONES LAID ON CURVES - SEE CHART.

6. JOINTS BETWEEN STONES SHALL BE MORTARED.

> SLOPED GRANITE CURB NOT TO SCALE

8" DIA. SCH 40 GALVANIZED STEEL PIPE, 8.5' LONG FILLED WITH 3000psi CONCRETE. 000psi CONCRETE (5' DEEP X 2' DIAMETER)

BOLLARD DETAIL

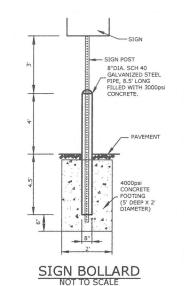

NOTE:


1. ALL PAINT SHALL BE FAST
DRYING TRAFFIC PAINT, MEETING
THE REQUIREMENTS OF AASHTO
M248-TYPE F. PAINT SHALL BE
APPLIED AS SPECIFIED BY
MANUFACTURER.


PAINTED ISLAND

Tighe&Bond





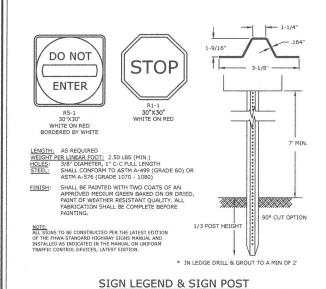

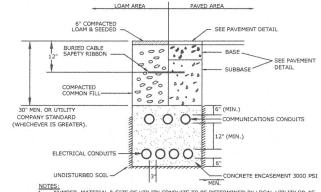

UNUIS JUNEES SOIL — 37 — CONCRETE ENCASEMENT 3000 PSI
NOTES:

1. NUMBER, MATERIAL & SIZE OF UTILITY CONDUITS TO BE DETERMINED BY LOCAL UTILITY OR AS
SHOWN ON ELECTRICAL DRAWINGS, CONTRACTOR TO PROVIDE ONE SPARE CONDUIT FOR EACH
UTILITY TO BUILDING. CONDUITS TO BE ENCASED IN CONCRETE.

2. DIMENSIONS SHOWN REPRESENT OWNERS MINIMUM REQUIREMENTS. ACTUAL DIMENSIONS MAY
BE GREATER BASED ON UTILITY COMPANY STANDARDS, BUT SHALL NOT BE LESS THAN THOSE
SHOWN.

3. NO CONDUIT REFORM THE EXCEED 360 DEGREES IN TOTAL BENDS.


4. A SULTABLE PULLING STRING, CAPABLE OF 200 POUNDS OF PULL, MUST BE INSTALLED IN THE
CONDUIT BEFORE UTILITY COMPANY IS NOTHINED TO INSTALL CASE. THE STRING SHOULD
THE CONDUIT FOR THE RUN IS ASSEMBLED TO AVOID BONDING THE STRING TO
THE CONDUIT.


5. UTILITY COMPANY MUST BE GIVEN THE OPPORTUNITY TO INSPECT THE CONDUIT PRIOR TO
BACKFULL, THE CONTRACTOR IS RESPONSIBLE FOR ALL REPAIRS SHOULD THE UTILITY COMPANY
BACKFULL, THE CONTRACTOR IS RESPONSIBLE FOR ALL REPAIRS SHOULD THE UTILITY COMPANY

UTILITY COMPANY MUST BE GIVEN THE OPPORTUNITY TO INSPECT THE CONDUIT PRIOR TO BACKFILL. THE CONTRACTOR IS RESPONSIBLE FOR ALL REPAIRS SHOULD THE UTILITY COMPANY BE UNABLE TO INSTALL ITS CABLE IN A SUITABLE MANNER.
ALL CONDUIT INSTALLATIONS MUST COMPONIT TO THE CURRENT EDITION OF THE NATIONAL ELECTRIC SAFETY CODE, STATE AND LOCAL CODES AND ORDINANCES, AND WHERE APPLICABLE, THE NATIONAL ELECTRIC CODE.


ALL 90° SWEEPS WILL BE MADE USING RIGID GALVANIZED STEEL. SWEEPS WITH A 36 TO 48 INCH RADIUS.

TYPICAL ELECTRICAL AND COMMUNICATION CONDUIT NOT TO SCALE

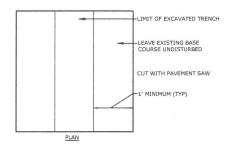

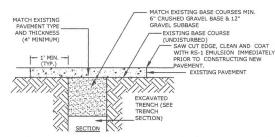

PAVEMENT TRENCH PATCH

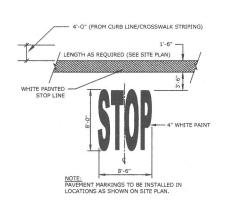

STOP BAR AND LEGEND

THE RIDGE **MARKETPLACE**

Farmington Road (Route 11)

Rochester, NH

R-0195-3_drive thru details.dw RAWN BY CML BLM

SCALE: AS SHOWN

C-502

DETAILS SHEET