



NONRESIDENTIAL SITE PLAN APPLICATION

City of Rochester, New Hampshire

	[office use only. Ch	eck#	Amount \$	Da	ate paid]
Date: <u>2/18/19</u>	ls a conditional (If so, we encou				Unclear: soon as possible.)
Property inform	ation				
Tax map #: 125	; Lot #('s):_203	; Zoning	district: D	owntown	Commercial
Property address/lo	cation: 83 South Main	Street			
Name of project (if a	applicable): <u>Service Cre</u>	dit Union Bra	nch	i eynek	
Size of site: 0.54	_acres; overlay zoning	district(s)? H	istoric Distri	ct Overla	У
Property owner					
Name (include nam	e of individual): <u>George E</u>	E. Ireland Rev	<u>ı. Trust, Tru</u>	stee Geo	rge Ireland
Mailing address: 1	411 Torrey Pines Drive,	Lady Lake, F	L 32159-22	275	
Telephone #:		Email:			
	oper (if different from prope of individual): Service		, Michael Be	ergeron	
Mailing address: 3	003 Lafayette Road, Por	rtsmouth, NH	03801-590	4	
Telephone #: (603)	422-8314	Email	: <u>mbergero</u> ı	n@servic	ecu.org
Engineer/desigr	ier				
Name (include name	e of individual): Norway	Plains Assoc	iates, Inc.; s	Scott A. L	awler, PE
Mailing address: PC	Box 249, Rochester, N	H 03866			
Telephone #: (603)	335-3948	Fax #:			
Email address: slaw	ler@norwayplains.com	Profe	essional lice	nse#:	PE 10026
Proposed activi	ty (check all that apply)				
New building(s):	Site development	(other structu	ures, parkin	g, utilities	, etc.):X
Addition(s) onto exis	sting building(s):	Demolition:	3-2 1 1	Change o	of use: X

Page 1 (of 3 pages)

(Continued Nonresidential Site Plan application Tax Map: 125 Lot: 203 Zone DC
Describe proposed activity/use: Service Credit Union branch
Describe existing conditions/use (vacant land?): The existing building is the former D'Angelo's fast food restaurant and vacant retail store.
Utility information City water? yes X no; How far is City water from the site?
City sewer? yes X no; How far is City sewer from the site?
If City water, what are the estimated total daily needs?gallons per day
If City water, is it proposed for anything other than domestic purposes? yes No X
If City sewer, do you plan to discharge anything other than domestic waste? yes no _X_
Where will stormwater be discharged? Into an underground infiltration practice
Building information Type of building(s): Existing Building
Building height: Finished floor elevation: 227.3'
Other information
parking spaces: existing: 17_total proposed: 16_; Are there pertinent covenants? No
Wetlands: Is any fill proposed? No ; area to be filled:; buffer impact?

Proposed <u>post-development</u> disposi	tion of site (should tot	al 100%)
and the second s	Square footage	% overall site
Building footprint(s) – give for each building	3,095	13.2
Parking and vehicle circulation	11,175	47.5
Planted/landscaped areas (excluding drainage)	1,255	5.3
Natural/undisturbed areas (excluding wetlands)	3,310	14.1
Wetlands	0	0
Other – drainage structures, outside storage, etc.	4,687	19.9

Page 2 (of 3 pages)

(Continued Nonresidential Site Plan application	Tax Map: <u>125</u>	Lot:_203	Zone_DC)
Comments			
Please feel free to add any comments,	additional info	rmation, or requests	for waivers here:
Submission of application This application must be signed by the property owner), and/or the agent.	property owner	r, applicant/develope	r (if different from
I(we) hereby submit this Site Plan application pursuant to the <u>City of Rochester Site Plans</u> knowledge all of the information on this materials and documentation is true and property owner)/as agent, I attest that I a	lan Regulation application for I accurate. As	s and attest that to to m and in the accomp applicant/developer	he best of my panying application (if different from
Signature of property owner:			
Signature of applicant/developer:		Date:	CHAEL P. BERGERON CE PRESIDENT - LOGISTICS
Signature of agent:	Laulen_	•	
		Date: 02/22/19	
Authorization to enter subject prolifereby authorize members of the Roche Conservation Commission, Planning Deput boards and agencies to enter my propertional including performing any appropriate inspectionally to those particular individuals inspecting this specific application/project reasonable care, courtesy, and diligence	ester Planning partment, and by for the purposections during and occupant legitimately in the literature.	Board, Zoning Boar other pertinent City of ose of evaluating this g the application phace of the phase. This authors out that these individuals	departments, application se, review phase, orization applies reviewing, or
signature of property owner:			
		Date:	

Page 3 (of 3 pages)



Conditional Use Permit Application City of Rochester, New Hampshire

Date: <u>2/18/19</u>
Property information
Tax map #: _125; Lot #('s): _203 ; Zoning district: _Downtown Commercial and Historical District Overlay
Property address/location: _83 South Main Street
Name of project (if applicable): Service Credit Union Branch
Property owner
Name (include name of individual): George E. Ireland Rev. Trust, George Ireland, Trustee
Mailing address: 1411 Torrey Pines Drive, Lady Lake, FL 32159-2275
Telephone #: Fax
Applicant/developer (if different from property owner) Name (include name of individual): Service Credit Union, Michael Bergeron Mailing address: 3003 Lafayette Road, Portsmouth, NH 03801-5904
Telephone #:(603) 422-8314 Fax #:
Engineer/designer Name (include name of individual): Norway Plains Associates, Inc; Scott A. Lawler, PE Mailing address: PO Box 249, Rochester, NH 03866-0249
Telephone #: <u>(603) 335-3948</u> Fax #: <u>(603) 332-0098</u>
Email address: <u>slawler@norwayplains.com</u> Professional license #: <u>PE 10026</u>
Proposed Project Please describe the proposed project:The proposed project is to convert an existing fast-food restaurant into a Service Credit Union branch with drive-up teller window.

Please describe the existing conditions: The existing building is the former D'Angelo's
fast food restaurant and vacant retail store.
Submission of application
This application must be signed by the property owner, applicant/developer (if different from property owner), and/or the agent.
I(we) hereby submit this Conditional Use application to the City of Rochester Planning Board pursuant to the <u>City of Rochester Zoning Ordinance</u> and attest that to the best of me knowledge all of the information on this application form and in the accompanying application materials and documentation is true and accurate. As applicant/developer (if different from property owner)/as agent, I attest that I am duly authorized to act in this capacity.
Signature of property owner:
Signature of applicant/developer: Date: MICHAEL P. BERGERON VICE PRESIDENT - LOGISTICS Date: 3/1/30/9
Signature of agent:
Date: <u>02/22/19</u>

NORWAY PLAINS ASSOCIATES, INC.

LAND SURVEYORS • SEPTIC SYSTEM DESIGNERS • CIVIL ENGINEERS

P.O. Box 249 Continental Blvd. (03867) Rochester, NH 03866-0249 Fax (603)332-0098 Phone (603) 335-3948 / (800) 479-3948 slawler@norwayplains.com



P. O. Box 268
31 Mooney St.
Alton, NH 03809
Phone & Fax (603) 875-3948
www.norwayplains.com
rtetreault@norwayplains.com

March 4, 2019

Seth Creighton, Chief Planner
Department of Planning and Development
Second Floor, City Hall
31 Wakefield Street
Rochester, NH 03867-1917

Re: Proposed Site Plan for Service Credit Union - 83 South Main Street, Map 125 Lot 203.

Dear Mr. Creighton:

On behalf of Service Credit Union, we hereby submit plans, Non-residential Site Plan Review Application and Conditional Use Application for a proposed credit union branch. Service Credit Union will be purchasing the property currently owned by George E. Ireland Revocable Trust. The property, known as Tax Map 125, Lot 203 on the City of Rochester Tax Assessing maps, is located at 83 South Main Street.

The 0.54-acre parcel is located in the Downtown Commercial Zoning District and Historic District Overlay. The building was previously occupied with a D'Angelo's eat-in and take-out restaurant and a past postal center.

The applicant is proposing to move their customer branch from 90 South Main Street. This new location will provide a better customer access as well as a drive-up teller window. The existing location will become more corporate offices and will continue to be the location of their drive-up ATM. The hours of operation at this location will be 8:30 am to 6:00 pm; Monday through Friday and 8:30 am to 1:00 pm on Saturday. There will be around 8-10 employees at the office.

The existing building will undergo major renovations on the inside to covert the building from two separate units to a single unit. Exteriorly, new windows will be installed along the northern wall and the old windows on the front and east elevations will be reframed. The old bay window on the east will be removed and a new drive-up teller window installed under a new overhang. A walk-up ATM will be placed near the new front entrance under a new overhang. The existing brick side will be kept as well as the existing metal fascia at the top of the structure. This fascia will continue to hide the existing roof mounted mechanical systems.

Access to the site will be the same as currently exist. The existing parking lot will be painted to indicate flow to the drive-thru and one parking space will be added for a total of 18 parking spaces. Signage will be installed to promote a one-way flow around the building and parking lot. The rear driveway around the building will be reconstructed to provide stacking for the drive-up teller and create a by-pass lane. A

Service Credit Union Site Plan Narrative

Page | 2

grass island will be installed at the rear of the building with an area drain to collect stormwater from the existing roof.

The new pavement in the rear will be graded in such a manner that the storm water will flow into the catch basins located in the existing grassed area at the back of the property. As such, there will be a closed drainage system constructed to direct the roof runoff and rear pavement into an underground infiltration system. The system is designed to handle a 50-year storm event.

The site will continue to be serviced by City water and City sewer. There are no proposed changes to the landscaping at this time, although the applicant will be dressing up the existing planting this spring. Snow storage will to be located at the back of the building in the grassed area or will be hauled off site when necessary.

As stated above, this parcel is located within the Historical District Overlay. As such, an application for review is hereby submitted to the Historical District Commission. With this application, the architect, Michael J. Keane Architects, PLLC, has prepared floor plans, proposed building elevations, existing and proposed building photos and renderings. Furthermore, they have included a photo of the existing signage for the site across South Main Street, which will be utilized at this location as well.

The lighting on the site will be updated with LED fixtures and two new light poles will be installed to provide better illumination in the rear of the building. There will be wall mounted lights installed on each side of the building for illumination and provide for a safe environment. The existing pylon sign will be removed and replaced in the same location.

Since the parcel is located within the Downtown Commercial Zone, a Conditional Use Permit Application is also included within this packet. Pursuant to section 42.6.c.3.a.ii of the Zoning Ordinance, a CUP is necessary to allow for a drive through facilities in this zone. This section states that the drive through facilities shall be in the rear of the building or in the side of the building only if location at the rear is not practical. Access to the parcel is via a shared driveway with the City of Rochester municipal parking lot. It is not practical to place the drive-up teller window in the rear of the building, as vehicles waiting for the drive-up teller window would likely restrict access to the parking lot. Placement of the drive through facility on the side would allow for ample stacking of vehicles.

We look forward to discussing this project with staff and the Planning Board. Thank you for your consideration

Sincerely,

NORWAY PLAINS ASSOCIATES, INC.

Бу

Scott A. Lawler, PE, Project Engineer

cc:

Service Credit Union George Ireland

SOUTH MAIN STREET


PROPOSED SERVICE CREDIT UNION BRANCH

83 SOUTH MAIN STREET

PREPARED FOR

SERVICE CREDIT UNION FEBRUARY 2019



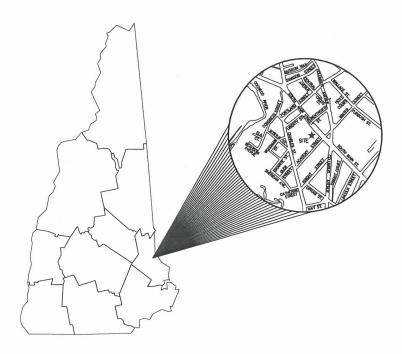



CIVIL ENGINEERS

NORWAY PLAINS ASSOCIATES, INC. 2 CONTINENTAL BOULEVARD ROCHESTER, NEW HAMPSHIRE 03867 (603) 335-3948

FILE NO. 317 PLAN NO. C-2963/SP-

DWG. NO. 19024

ARCHITECTS

mjk, MICHAEL J. KEANE ARCHITECTS, PLLC 101 KENT PLACE NEWMARKET, NH 03857 (603) 292-1400

CAREFULLY REVIEW ALL SHEETS OF THIS PACKAGE TO INSURE PROPER CONSTRUCTION. SPECIFIC SITE CONDITIONS SHOULD BE EXPLORED PRIOR TO CONSTRUCTION. CONTACT BOTH THE DESIGN ENGINEER AND THE PROJECT OWNER FOR ANY AVAILABLE GEOTECHNICAL OR HYDROGEOLOGICAL INFORMATION AVAILABLE BUT NOT CONTAINED WITH IN THE PLAN SET. IF THERE ARE ANY QUESTIONS WITH THE DESIGN PRESENTED IN THIS PLAN SET PLEASE CONTACT THE ENGINEERING STAFF AT NORWAY PLAINS ASSOCIATES, INC. (603)—335—3948.

OWNER OF RECORD TAX MAP 125, LOT 203
GEORGE E. IRELAND REVOCABLE TRUST
1411 TORREY PINES DRIVE
LADY LAKE, FL 32159-2275
SCRD BOOK 4337, PAGE 22

APPLICANT

SERVICE CREDIT UNION 3003 LAFAYETTE ROAD PORTSMOUTH, NH 03801-5904 (603) 422-8314

NATIONAL POLLUTANT DISCHARGE ELIMINATION SYSTEM (NPDES):
NPDES PERMITS ARE ONLY REQUIRED FOR PROJECTS MEETING THE DISTURBED AREA
CRITERIA BELOW AMU HAMING A POINT SOURCE STORMWAITER DISCHARGE FROM THE
SITE TO AN ADJACENT WEITAND OR WATER BODY (I.E. CULVERT, SWALE, ETC.
CUTLETING TO A WEITAND, CREEK, STREAM OR RIVER).

NOT REQUIRED

NPDES PERMITS CONSIST OF A NOTICE OF INTENT (NOI) FILED WITH THE ENVIRONMENTAL PROTECTION AGENCY AT LEAST 14 DAYS PRIOR TO CONSTRUCTION COMMENCING, AND A STORMWATER POLLUTION PREVENTION PLAN (SWPPP) BEING PREPARED, KEPT ON SITE AND FOLLOWED BY THE CONTRACTOR.

FOR STATUS OF THIS PERMIT, CONTACT THE PROJECT GENERAL CONTRACTOR.

FINAL APPROVAL BY ROCHESTER PLANNING BOARD

SHEET INDEX SHEET E-1 SHEET C-1 SHEET C-2 SHEET C-3 SHEET C-4 SHEET C-5 SHEET L-1 EXISTING FEATURES OVERALL SITE PLAN SITE LAYOUT PLAN 1" = 10' 1" = 20' 1" = 10' 1" = 10' GRADING AND DRAINAGE PLAN CONSTRUCTION DETAILS STORMTECH DRAINAGE DETAILS LIGHTING PLAN AND DETAILS 1" = 10'


CERTIFIED BY:


OVERALL SITE 1" = 40'


31 Mooney Street, Alton, N.H. 603-875-3948


NORWAY PLAINS ASSOCIATES, INC.


2 Continental Blvd., Rochester, N.H. 603-335-3948

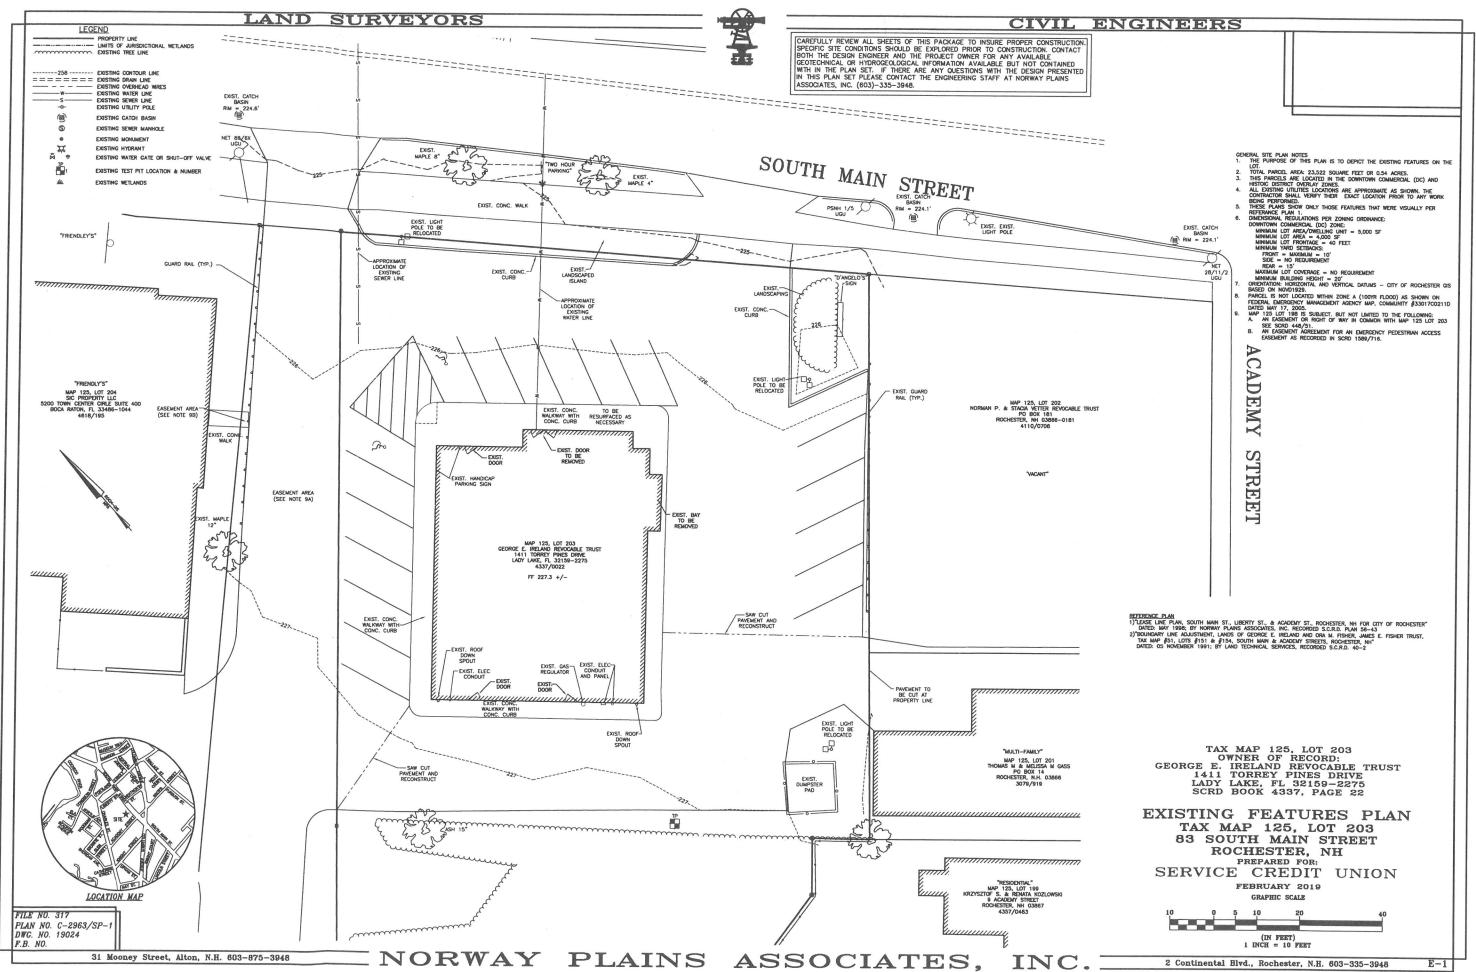

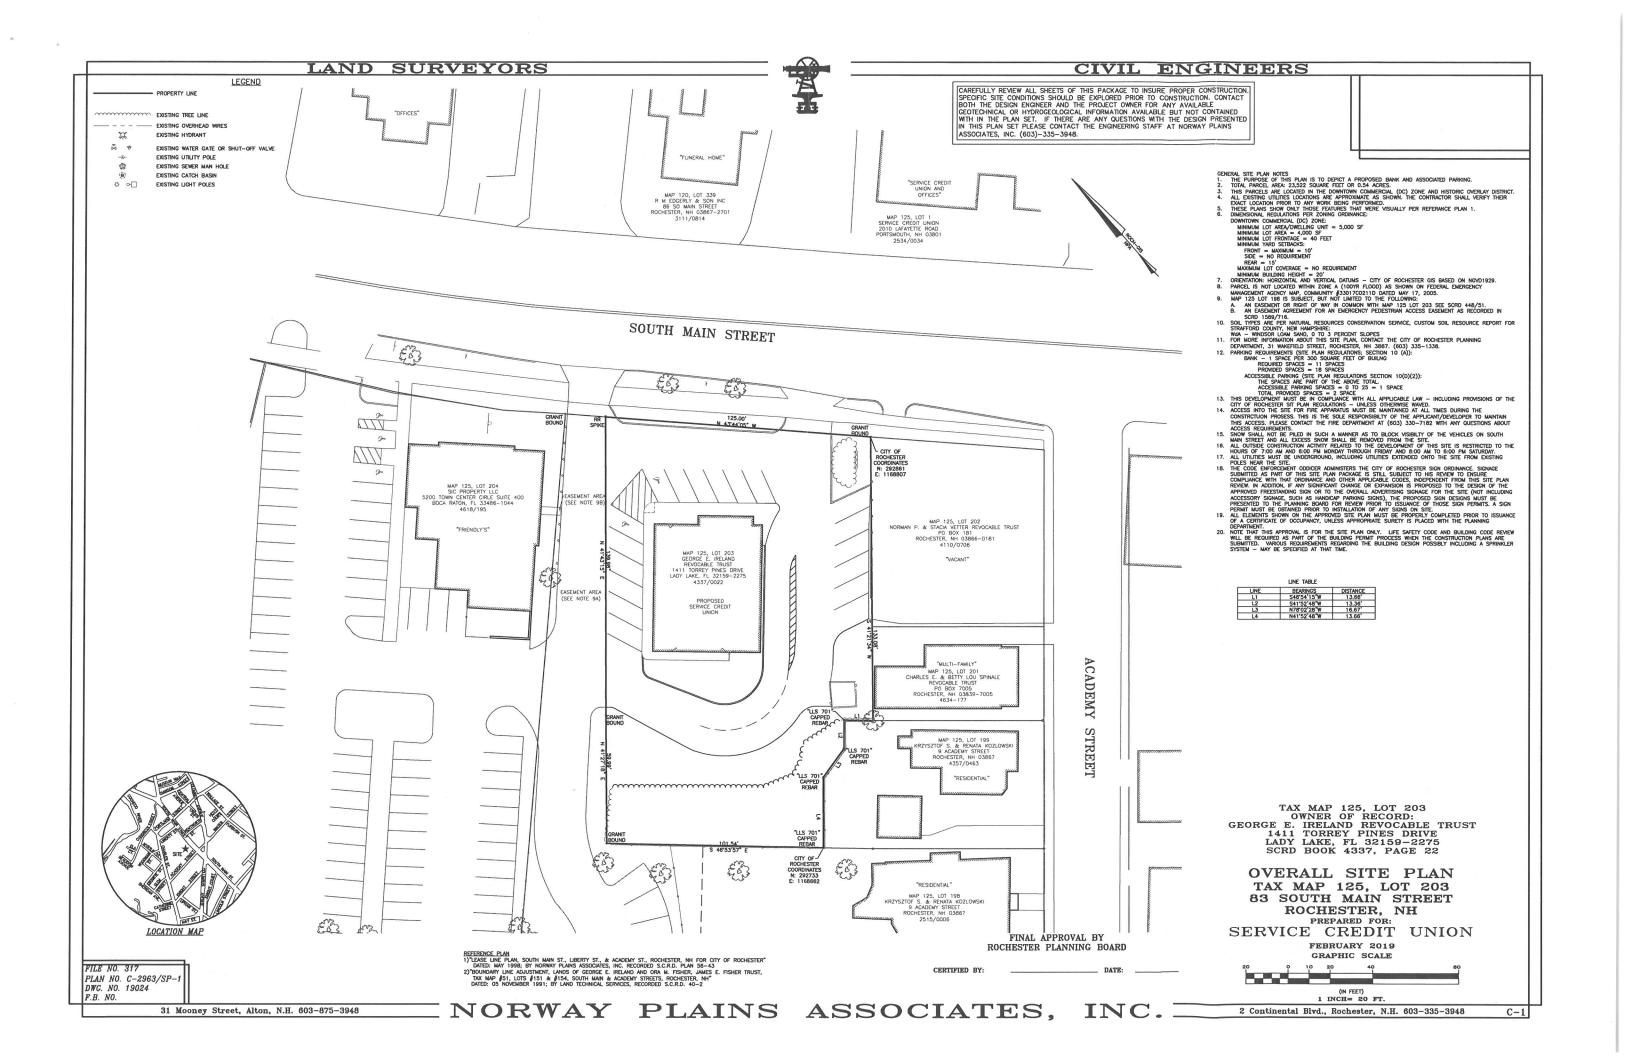

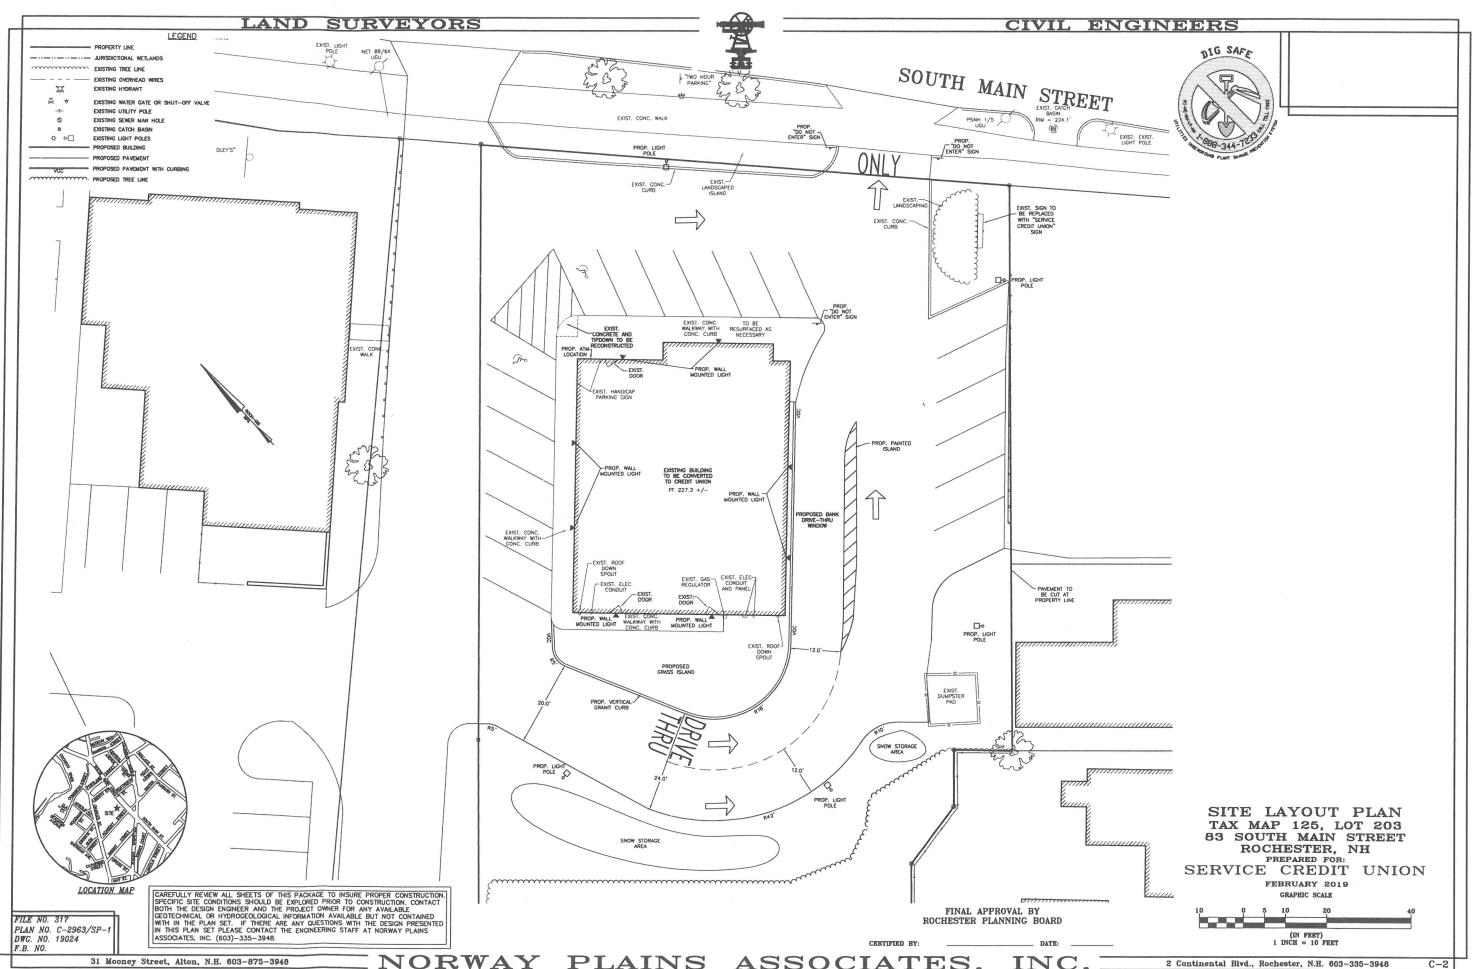

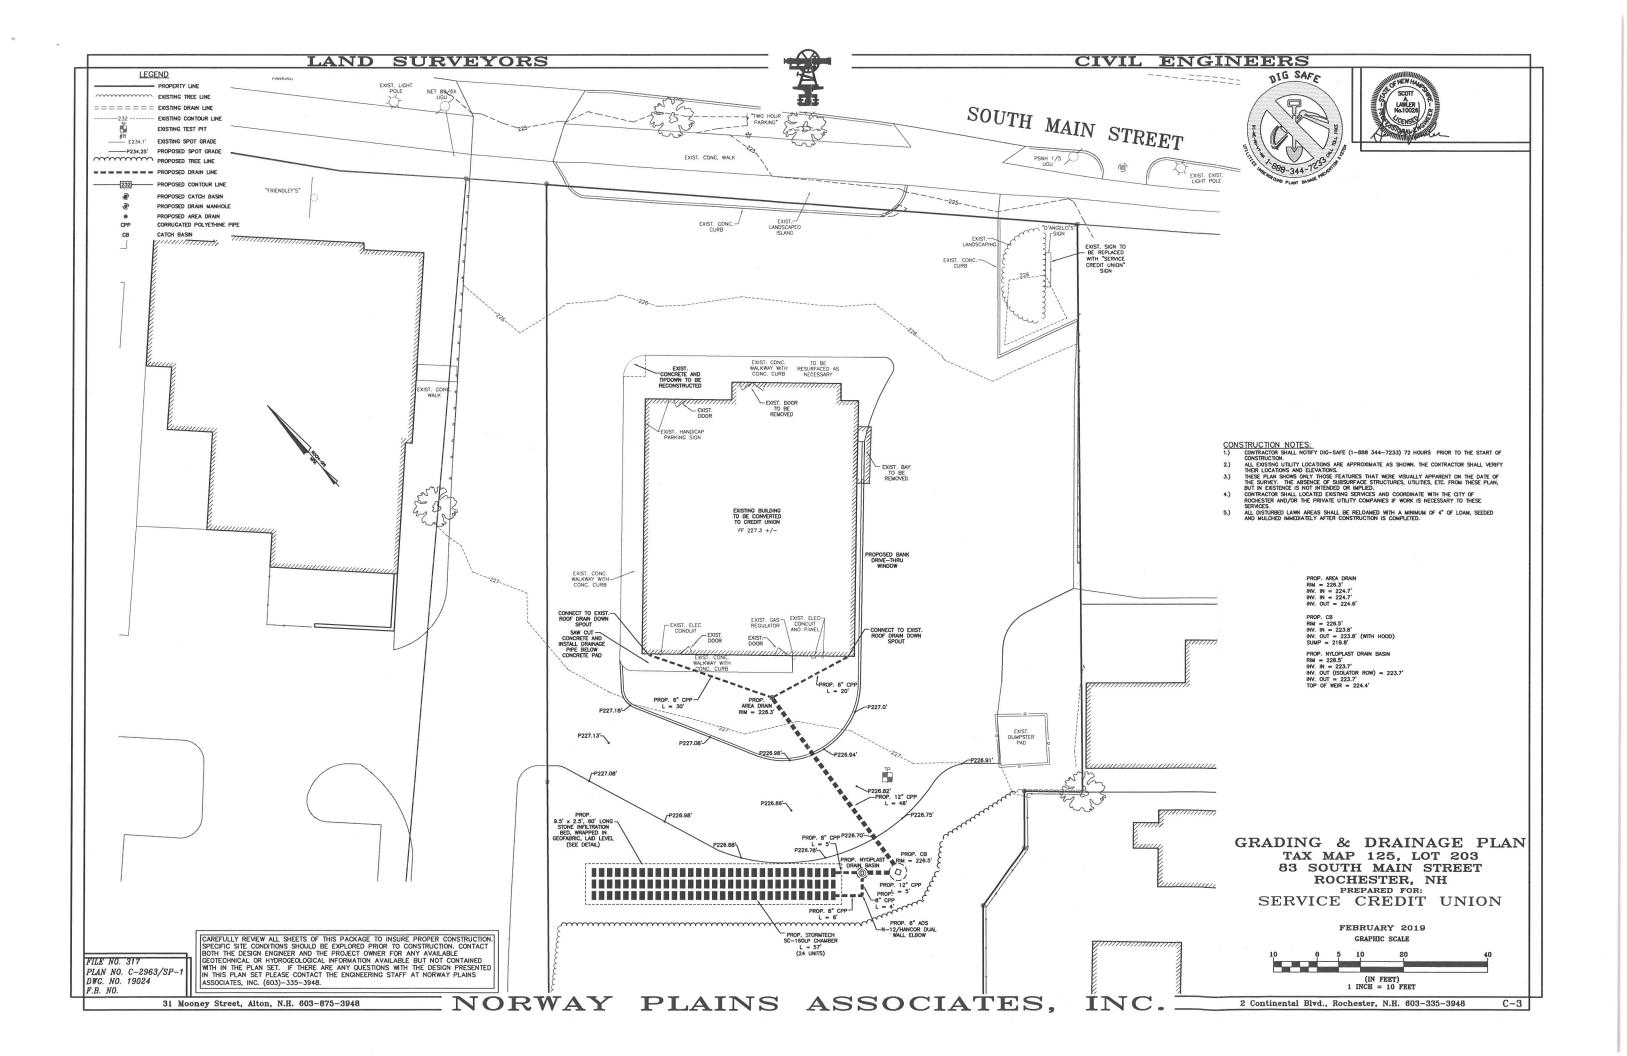

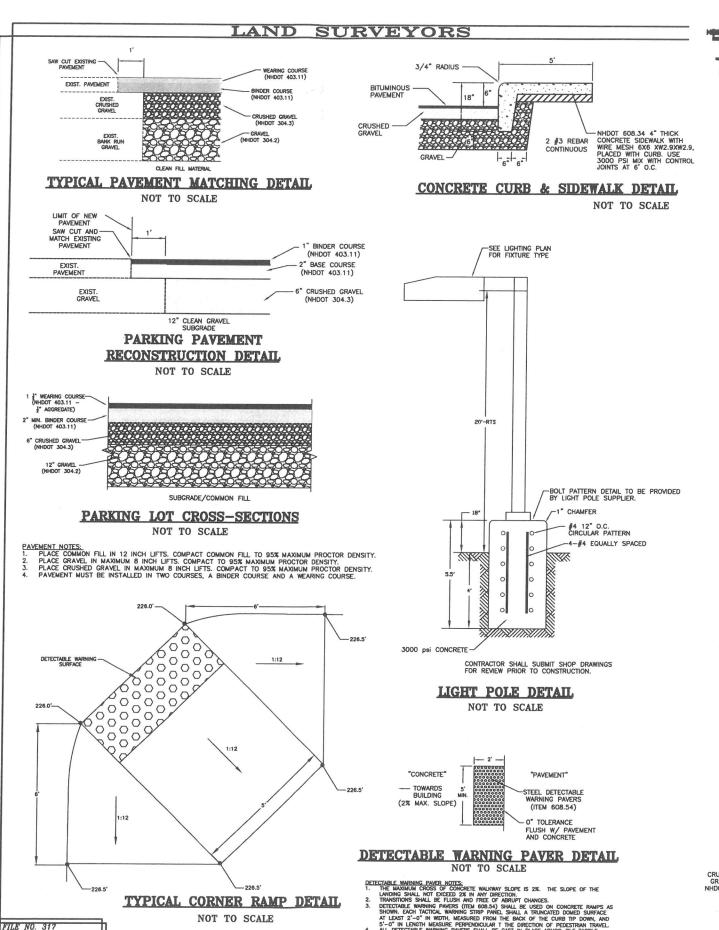

PLAN NO. C-2963/SP-DWG. NO. 19024

F.B. NO.

NOTES:
1. SPOT ELEVATIONS SHALL MATCH EXISTING GRADE.

31 Mooney Street, Alton, N.H. 603-875-3948




CIVIL ENGINEERS

CAREFULLY REVIEW ALL SHEETS OF THIS PACKAGE TO INSURE PROPER CONSTRUCTION. CAREFULLY REVIEW ALL SHEETS OF THIS PACKAGE TO INSURE PROPER CONSTRUCTION.
SPECIFIC SITE CONDITIONS SHOULD BE EXPLORED PRIOR TO CONSTRUCTION. CONTACT
BOTH THE DESIGN ENGINEER AND THE PROJECT OWNER FOR ANY AVAILABLE
GEOTECHNICAL OR HYDROGEOLOGICAL INFORMATION AVAILABLE BUT NOT CONTAINED
WITH IN THE PLAN SET. IF THERE ARE ANY QUESTIONS WITH THE DESIGN PRESENTED
IN THIS PLAN SET PLASE CONTACT THE ENGINEERING STAFF AT NORWAY PLAINS
ASSOCIATES, INC. (603)—335—3948.

6' 42"




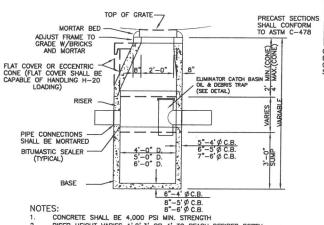

RISER HEIGHT VARIES 1',2',3' OR 4' TO REACH DESIRED DEPTH
CATCH BASIN RIMS SHALL ONLY BE ADJUSTED TO GRADE WITH BRICK AND MORTAR
TO A HEIGHT OF 12". HEIGHTS GREATER THAN 12" SHALL BE ADJUSTED USING A
PRECAST CONCRETE RING OR A COMBINATION OF A PRECAST RING AND BRICK AND
MORTAR.

PRE-CAST REINFORCED CATCH BASIN WITH HOODED OUTLET

NOT TO SCALE

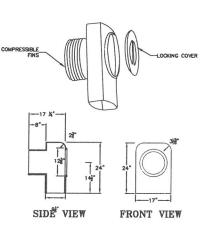


ELIMINATOR CATCH BASIN OIL AND DEBRIS TRAP DETAIL

NOT TO SCALE


NOTES:

1. HOOD SHALL BE "THE ELIMINATOR" OIL & FLOATING DEBRIS TRAP AS MANUFACTURED BY GROUND WATER RESCUE, INC., QUINCY, MA., TEL. 617—773—1128 ON THE WEB @ WWW.KLEANSTREAM.COM

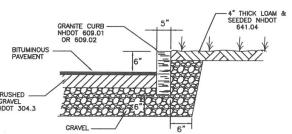

GRANITE VERTICAL CURB DETAIL

NOT TO SCALE

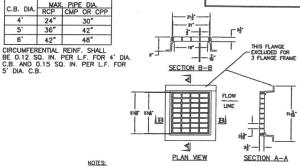

NOTES:


1. FRAME AND GRATE SHALL BE CAST IRON. FRAME AND GRATE SHALL BE I
2. USE 3 FLANCE FRAME IF INSTALLED ADJACENT TO GRANITE CURB.

CATCH BASIN TYPE 'B' FRAME AND GRATE DETAIL

NOT TO SCALE

CONSTRUCTION NOTES:

- CONTRACTOR SHALL NOTIFY DIG-SAFE (1-888 344-7233) 72 HOURS PRIOR TO THE START OF CONSTRUCTION.
- TO THE START OF CONSTRUCTION.
 ALL ENSTRING UTILITY LOCATIONS ARE APPROXIMATE AS SHOWN. THE
 CONTRACTOR SHALL VERIEY THEIR LOCATIONS AND ELEVATIONS.
 THESE PLAN SHOWS ONLY THOSE FEATURES THAT WERE VISUALLY APPARENT
 ON THE DATE OF THE SURVEY. THE ABSENCE OF SUBSURFACE STRUCTURES,
 UTILITIES, ETC. FROM THESE PLAN, BUT IN EXISTENCE IS NOT INTENDED OR
 IMPLED.
 CONTRACTOR SHALL LOCATED EXISTING SERVICES AND COORDINATE WITH THE
 CITY OF ROCHESTER AND/OR THE PRIVATE UTILITY COMPANIES IF WORK IS
 NECESSARY TO THESE SERVICES.
 ALL DISTURBED LAWN ARFAS SHALL BE DELOAMED WITH A MINIMUM OF THE
- ALL DISTURBED LAWN AREAS SHALL BE RELOAMED WITH A MINIMUM OF 4"
 OF LOAM, SEEDED AND MULCHED IMMEDIATELY AFTER CONSTRUCTION IS

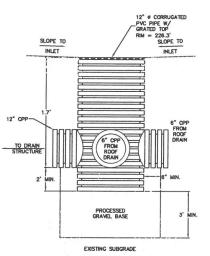

NOIES:

1. AREA DRAINS TO BE ADS PIPE TEE & RISER SECTIONS WITH

1. AREA DRAINS OF EQUAL.

2. AREA DRAINS SHALL BE SET ON 3 FT OF PROCESSED GRAVEL

BASE, COMPACTED TO 93% PROCTOR DENSITY.

3. USE DITHER CLEAN GRAVILAR FILL OR NINDO CRUSHED

CRAVEL FOR THE PROCESSED GRAVEL BASE (SEC 05).

AREA DRAIN DETAIL

NOT TO SCALE

CONSTRUCTION DETAILS TAX MAP 125, LOT 203 83 SOUTH MAIN STREET ROCHESTER, NH PREPARED FOR: SERVICE CREDIT UNION FEBRUARY 2019

NORWAY PLAINS ASSOCIATES, INC.


2 Continental Blvd., Rochester, N.H. 603-335-3948

LAND SURVEYORS

ACCEPTABLE FILL MATERIALS: STORMTECH SC-160LP CHAMBER SYSTEMS

	MATERIAL LOCATION	DESCRIPTION	AASHTO MATERIAL CLASSIFICATIONS	COMPACTION / DENSITY REQUIREMENT
D	FINAL FILL: FILL MATERIAL FOR LAYER 'D' STARTS FROM THE TOP OF THE 'C' LAYER TO THE BOTTOM OF FLEXIBLE PAVEMENT OR UNPAVED FINISHED GRADE ABOVE. NOTE THAT PAVEMENT SUBBASE MAY BE PART OF THE 'D' LAYER	ANY SOIL/ROCK MATERIALS, NATIVE SOILS, OR PER ENGINEER'S PLANS. CHECK PLANS FOR PAVEMENT SUBGRADE REQUIREMENTS.	N/A	PREPARE PER SITE DESIGN ENGINEER'S PLANS. PAVED INSTALLATIONS MAY HAVE STRINGENT MATERIAL AND PREPARATION REQUIREMENTS.
С	INITIAL FILL: FILL MATERIAL FOR LAYER 'C' START'S FROM THE TOP OF THE EMBEDMENT STONE (B' LAYER) TO 'A' (355 mm) ABOVE THE TOP OF THE CHAMBER NOTE THAT PAVEMENT SUBBASE MAY BE A PART OF THE 'C' LAYER.	GRANULAR WELL-GRADED SOIL/AGGREGATE MIXTURES. <39% FINES OR PROCESSED AGGREGATE. MOST PAVEMENT SUBBASE MATERIALS CAN BE USED IN LIEU OF THIS LAYER	57, 6, 67, 68, 7, 78, 8, 89, 9, 10	ROLLER GROSS VEHICLE WEIGHT NOT TO EXCEEL 12,000 bs (63 kH) DYMAMIC FORCE NOT TO EXCEED 20,000 bs (89 kH).
В	EMBEDMENT STONE: FILL SURROUNDING THE CHAMBERS FROM THE FOUNDATION STONE ('A' LAYER) TO THE 'C' LAYER ABOVE.	CLEAN, CRUSHED, ANGULAR STONE	AASHTO M43 ⁵ 3, 357, 4, 467, 5, 56, 57	NO COMPACTION REQUIRED.
Α	FOUNDATION STONE: FILL BELOW CHAMBERS FROM THE SUBGRADE UP TO THE FOOT (BOTTOM) OF THE CHAMBER.	CLEAN, CRUSHED, ANGULAR STONE	AASHTO M43 ¹ 3, 357, 4, 467, 5, 56, 57	PLATE COMPACT OR ROLL TO ACHIEVE A FLAT SURFACE. ? ?

- EASE NOTE:
 THE LISTED ANSHTO DESIGNATIONS ARE FOR GRADATIONS ONLY. THE STONE MUST ALSO BE CLEAN, CRUSHED, ANGULAR, FOR EXAMPLE, A SPECIFICATION FOR \$4 STONE WOULD STATE:
 TCLEAN, CRUSHED, ANGULAR NO. 4 (AMSHTO MAS) STONE)
 STONMETED COMPACTION REQUIREDWITS ARE MET FOR "A" LOCATION MATERIALS WHEN PLACED AND COMPACTED IN 6" (150 mm) (MAX) LIFTS USING TWO FULL COVERAGES WITH A
 WHERE INFLITATION SURFACES MAY BE COMPROMISED BY COMPACTION, FOR STANDARD DESIGN LOAD CONDITIONS, A FLAT SURFACE MAY BE ACHIEVED BY RAKING OR DRAGGING WITHOUT
 COMPACTION GUIREDHT. FOR SPECIAL LOAD DESIGNS, CONTACT STONEMECH FOR COMPACTION REQUIREMENTS.

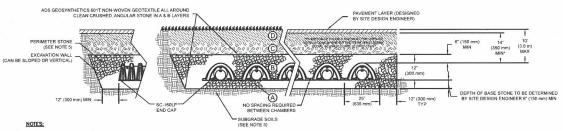

30" DRAIN BASIN BODY

- 1. SC-160LP CHAMBERS SHALL BE DESIGNED IN ACCORDANCE WITH ASTM F2787 "STANDARD PRACTICE FOR STRUCTURAL DESIGN OF THERMOPLASTIC CORRUGATED WALL
- 1. SC-160LP CHAMBER'S SHALL BE LIESTANCE IN THE CONTROL THE TABLE 12.0

 2. "ACCEPTABLE FILL MATERIALS" TABLE ABOVE PROVIDES MATERIAL LOCATIONS, DESCRIPTIONS, GRADATIONS, AND COMPACTION REQUIREMENTS FOR FOUNDATION, EMBEDMENT, AND FILL MATERIALS.

 3. THE SITE DESIGN ENGINEER IS RESPONSIBLE FOR ASSESSING THE BEARING RESISTANCE (ALLOWABLE BEARING CAPACITY) OF THE SUBGRADE SOILS AND THE DEPTH OF FOUNDATION STONE WITH CONSIDERATION FOR THE RANGE OF EXPECTED SOIL MOISTICE CONDITIONS.

 4. PERMIETER STONE MUST BE EXTENDED HORIZONTALLY TO THE EXCAVATION MALL FOR BOTH VERTICAL AND SLOPED EXCAVATION WALLS.

 5. ONCE LAYER "O'S PALCED, ANY SOIL/MATERIAL CAN BE PLACED IN LAYER" O'UP TO THE FINISHED GRADE. MOST PAYEMENT SUBBASE SOILS CAN BE USED TO REPLACE THE MATERIAL REQUIREMENTS OF LAYER "C' OR "D' AT THE SITE DESIGN ENGINEER'S DISCRETION.

- ORMITECH. CHAMBER. SPECIFICATIONS

 CHAMBERS SHALL BE INAUTOURED FROM WRGIN POLYPROPYED EQUAL

 CHAMBERS SHALL BE ENDRINGTONED FROM WRGIN POLYPROPYED.

 CHAMBERS SHALL BE ENDRINGTURED FROM WRGIN POLYPROPYED.

 PARISES THAT WOULD IMPEDE FLOW OR LIMIT ACCESS FOR INSPECTION.

 THE STRUCTURAL DESIGN OF THE CHAMBERS, THE STRUCTURAL BACKFILL, AND THE INSTALLATION REQUIREMENTS

 SHALL ENSURE THAT THE LOAD FACTORS SPECIFIED IN THE AMSHTO LIRTD BRIDGE DESIGN SPECIFICATIONS,

 SECTION 12.12, ARE MET FOR: 1) LONG-DURATION DEAD LOADS AND 2) SHORT-DURATION LIVE LOADS, BASED

 ON THE AMSHTO DESIGN TRUCK WITH CONSIDERATION FOR IMPACT AND MULTIFLE VEHICLE PRESENCES.

 OF HAMBERS SHALL MEET HAND SHIP OF METHOD HAS NOT AND MULTIFLE VEHICLE PRESENCES.

 CHAMBERS SHALL BE DESIGNED AND ALLOWED HER HAS STRUCTURED.

 SCHOOL PCHAMBER CLASSIFICATION HAS NOT YET BEEN ADDED TO THE ASTIN F2418 STANDARD)

 CHAMBERS SHALL BE DESIGNED AND ALLOWABLE LOADS DETERMINED IN ACCORDANCE WITH ASTIN F2787,

 "STANDARD PRACTICE FOR STRUCTURAL DESIGN OF THERMOPLASTIC CORRUCATED WALL STORMWITER COLLECTION CHAMBERS".

- BIERS*. (*CHAMBERS THAT ARE APPROVED BY THE SITE DESIGN ENGINEER WILL BE ALLOWED. THE CHAMBER PLACEMERS SHALL SUBBILT THE FOLLOWING UPON REQUEST TO THE SITE DESIGN ENGINEER FOR APPROVAL RE DELINERING CHAMBERS TO THE FROLECT SITE THAT THE SAFETY FACTORS ARE GREATER THAN OR EQUAL TO 1.95 FOR DEAD LOAD AND 1.75 FOR LIVE LOAD, THE MINIMUM REQUIRED BY ASTM F2787 AND BY ASTM F2787 AND BY STRUCTURAL CROSS SECTION DETAIL ON WHICH THE STRUCTURAL EVALUATION IS BASED.

- <u>RITANT NOTES FOR THE BIDDING AND INSTALLATION OF THE SC-160LP SYSTEM</u>

 STORMITECH SC-160LP CHAMBERS SHALL NOT BE INSTALLED UNTIL THE MANUFACTURER'S REPRESENTATIVE HAS COMPLETED A PRE-CONSTRUCTION MEETING WITH THE INSTALLERS.

 STORMITECH SC-108LP CHAMBERS SHALL BE INSTALLED IN ACCORDANCE WITH THE "STORMITECH SC-160LP CONSTRUCTION"

- A PHE-LUCISIOUNT MILLERIAN MILLER AND LIBERATED IN ACCORDANCE WITH THE "STORMTECH SC-160LP CONSTRUCTION CUDIC."

 STORMTECH SC-106LP CHAMBERS SHALL BE INSTALLED IN ACCORDANCE WITH THE "STORMTECH SC-160LP CONSTRUCTION CUDIC."

 ANSATION AS 3,53.57, 4.467, 5.56, 07.57, 17

FILE NO. 317

DWG. NO. 19024

PLAN NO. C-2963/SP-

- NOTES FOR CONSTRUCTION EQUIPMENT

 1. THE USE OF CONSTRUCTION EQUIPMENT

 4. NO EQUIPMENT IS ALLOWED ON BARE CHAMBERS.

 5. NO RUBBER THEEL LOGBERS, DUMP TRUCKS, OR EXCAVATORS ARE ALLOWED UNTIL PROPER FILL DEPTHS ARE

 REACHED IN ACCORDANCE WITH THE "STORMECH SC-160LP CONSTRUCTION QUIDE".

 5. WEIGHT LIMITS FOR CONSTRUCTION EQUIPMENT CAN BE FOUND IN THE "STORMECH SC-160LP CONSTRUCTION QUIDE".

 5. FULL 36" (400 mm) OF STABILIZED COVER MATERIALS OVER THE CHAMBERS IS REQUIRED FOR DUMP TRUCK TRAVEL OR

USE OF A DOZER TO PUSH EMBEDMENT STONE BETWEEN THE ROWS OF CHAMBERS MAY CAUSE DAMAGE TO THE CHAMBERS AND IS NOT AN ACCEPTABLE BACKFILL METHOD. ANY CHAMBERS DAMAGED BY THE "DUMP AND PUSH" METHOD ARE NOT COVERED UNDER THE STORMIECH STANDARD WARRANTY.

CONTACT STORMTECH AT 1-888-892-2694 WITH ANY QUESTIONS ON INSTALLATION REQUIREMENTS OR WEIGHT LIMITS FOR

CAREFULLY REVIEW ALL SHEETS OF THIS PACKAGE TO INSURE PROPER CONSTRUCTION. SPECIFIC SITE CONDITIONS SHOULD BE EXPLORED PRIOR TO CONSTRUCTION. CONTACT BOTH THE DESIGN ENGINEER AND THE PROJECT OWNER FOR ANY AVAILABLE GEOTECHNICAL OR HYDROGEOLOGICAL INFORMATION AVAILABLE BUT NOT CONTAINED WITH IN THE PLAN SET. IF THERE ARE ANY QUESTIONS WITH THE DESIGN PRESENTED IN THIS PLAN SET PLEASE CONTACT THE ENGINEERING STAFF AT NORWAY PLAINS ASSOCIATES, INC. (603)—335—3948.



SIDE SECTION VIEW

12" INLET PIPE (1)


NYLOPLAST DRAIN BASIN WITH OUTLET WEIR

NOT TO SCALE




TOP VIEW W/ FRAME &
COVER REMOVED

- INVERT ELEVATIONS & LOCATIONS TO BE FERMINED BY ENGINEER. - HEGHT OF WERT TO BE DETERMINED BY SINEER. WERR HEIGHT CANNOT EXCEED 84" DUE TO UPFACTURING AND SHIPPING RESTRICTIONS. - WERR MANUFACTURED TO MINIMIZE LOSS OF LET PIPE OPEN AREA.

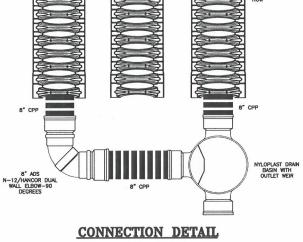





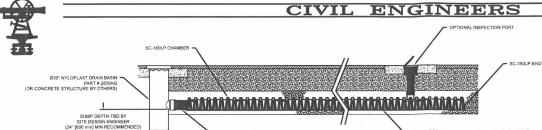

SC-160LP ISOLATOR ROW DETAIL

INSPECTION & MAINTENANCE
STEP 1) INSPECT ISOLATOR ROW FOR SEDIMENT NOT TO SCALE

- INSPECTION PORTS (IF PRESENTED IN INTER IF INSTALLED IN INFO CLEAN FLOSTORIA FILTER INFO CLEAN FLOSTORIA FLOSTORIA FILTER INFO CLEAN FLOSTORIA FLOSTORIA FILTER INFO CLEAN FLOSTORIA FLO
- A.5. IF SEDIMENT IS AT, OR ABOVE, 3" (80 mm) PROCEED TO STEP 2. IF NOT, PROCEED TO STEP 3.

 B. ALL SOULTOR ROWS

 B. 2. USING A FLASHUCHT, INSPECT DOWN THE ISOLATOR ROW THROUGH OUTLET PIPE) MIRRORS ON POLES

 B. 2. USING A FLASHUCHT, INSPECT DOWN THE ISOLATOR ROW THROUGH OUTLET PIPE) MIRRORS ON POLES

 CONTINED SPACE ENTRY IF ENTERING MANHOLE

 B.3. IF SEDIMENT IS AT, OR ABOVE, 3" (80 mm) PROCEED TO STEP 2. IF NOT, PROCEED TO STEP 3.

 2. OLEM OUT ISOLATOR ROW USING THE JETING PROCESS

 A A FIXED CULVERT CLEANING NOZIZE WITH REAR FACING SPREAD OF 45" (1.1 m) OR MORE IS PREFERRED

 B. APPLY MULTIPLE PASSES OF SETING UNITE BACKFLUSH WATER IS CLEAN


 C. VACUUM STRUCTURE SUMP AS REQUISED. LOSS RECORD GESETRATIONS AND ACTIONS.

 P 4) INSPECT AND CLEAN BASINS AND MANHOLES UPSTREAM OF THE STORMTECH SYSTEM.

NOTES


1. INSPECT EVERY 6 MONTHS DURING THE FIRST YEAR OF OPERATION. ADJUST THE INSPECTION INTERVAL BASED ON PREVIOUS DESERVATIONS OF SEDIMENT ACCUMULATION AND HIGH WATER ELEVATIONS.".]

2. CONDUCT JETTING AND VACTORING ANNUALLY OR WHEN INSPECTION SHOWS THAT MAINTENANCE IS NECESSARY.

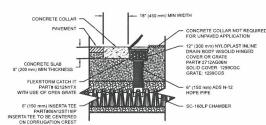

SC-160LP 6" INSPECTION PORT DETAIL

NOT TO SCALE

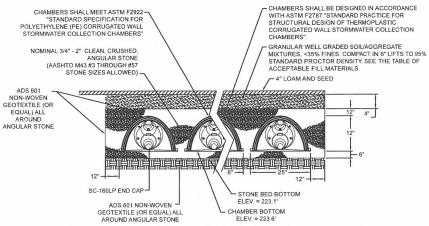









PART #	STUB	Α
DC460IEDD	6" (150 mm)	0.66" (16 mm)
SC160IEPP	8" (200 mm)	0.80" (20 mm)
SC160IEPP08	8" (200 mm)	0.96" (24 mm)

NOTE: ALL DIMENSIONS ARE NOMINAL

SC-160LP CHAMBER DETAIL NOT TO SCALE

STORMTECH DRAINAGE DETAILS TAX MAP 125, LOT 203 83 SOUTH MAIN STREET ROCHESTER, NH PREPARED FOR:


SERVICE CREDIT UNION


FEBRUARY 2019

2 Continental Blvd., Rochester, N.H. 603-335-3948

31 Mooney Street, Alton, N.H. 603-875-3948

NORWAY PLAINS ASSOCIATES, INC.

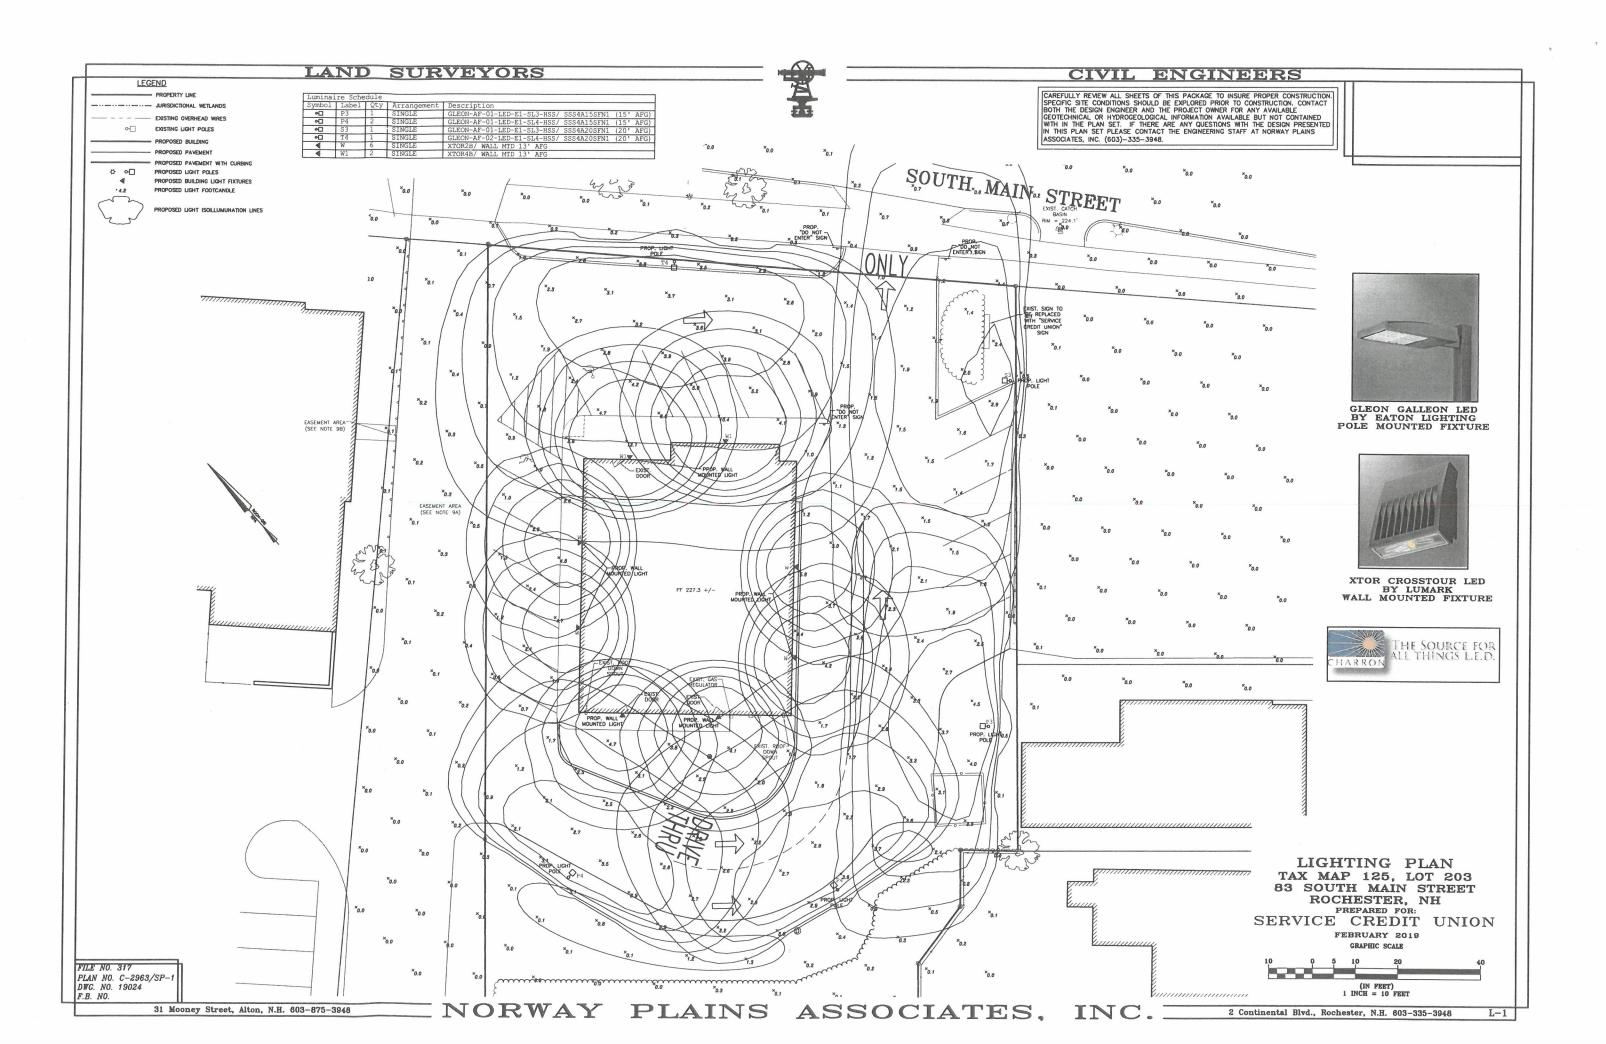

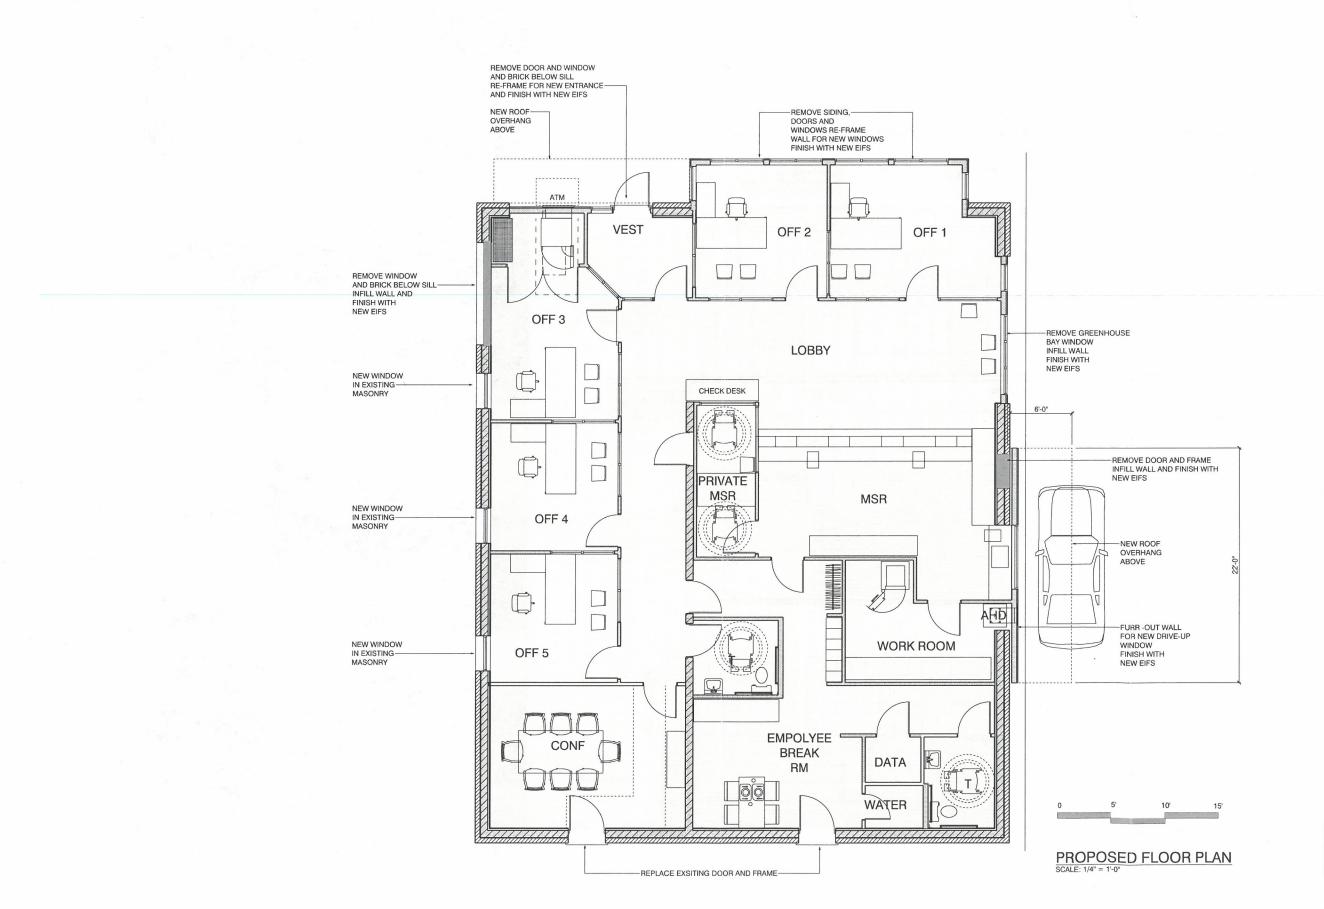

mjk

Michael J. Keane Architects, PLLC

ARCHITECTURE
PLANNING
DESIGN
101 Kent Place
Newmarket, NH
03857

603-292-1400 mjkarchitects.com

All drawings and written materials appearing herein constitution of microscopic and unpublished work of Michael J. Keane Architects, PL and may not be duplicated, used, or disclosed without the written consent of Michael J. Keane Architects, PLLC, Newmarket, NH. © 2018

CONSULTANTS

REVISIONS

APPROVALS

Accept only original stamp and signature

PROJECT PROPOSED

SERVICE CREDIT UNION BRANCH 83 South Main Street Rochester, NH

FOR:

SERVICE CREDIT UNION

3003 LAFAYETTE RD PORTSMOUTH, NH

03801

PROPOSED PLAN


NOT FOR CONSTRUCTION 3/3/2019


DRAWN BY: CHECKED BY:


DATE:

DRAWING NO.


A1

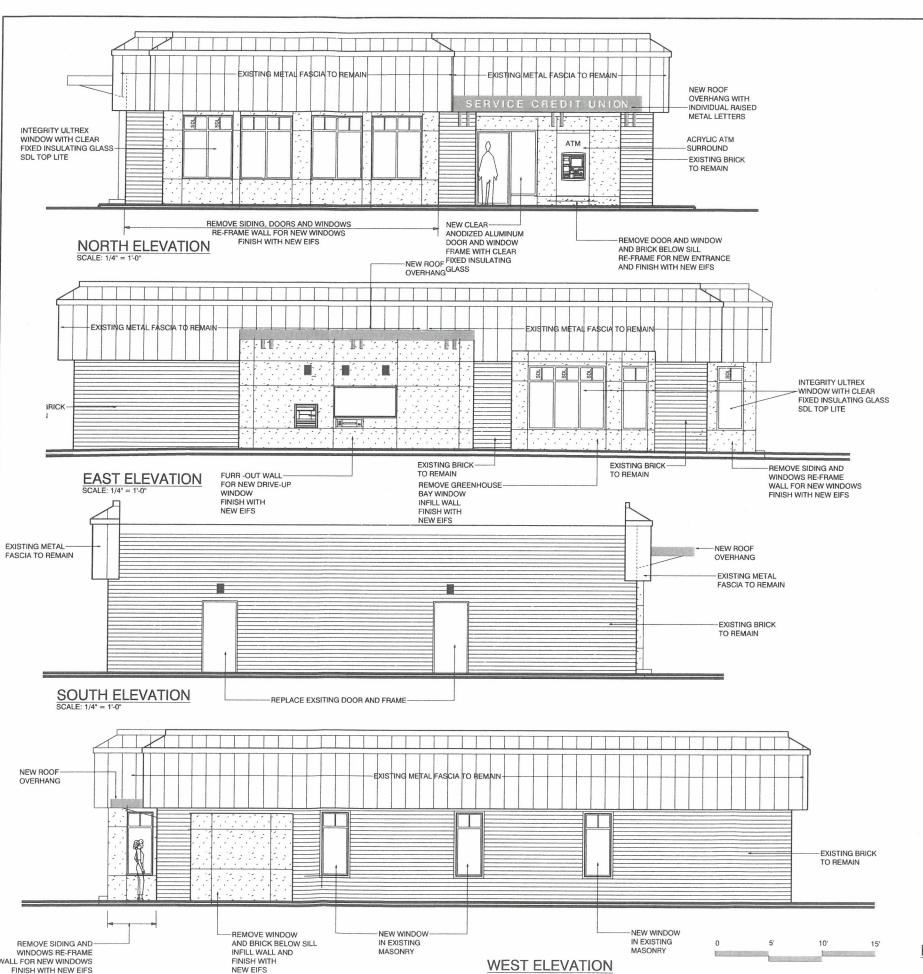

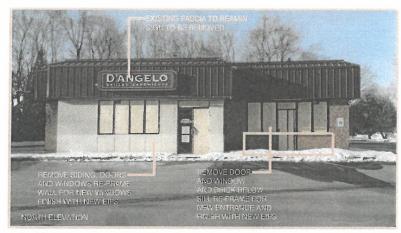

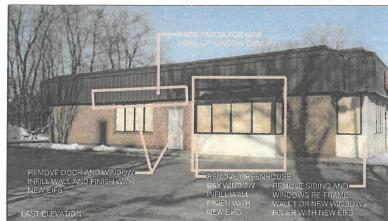



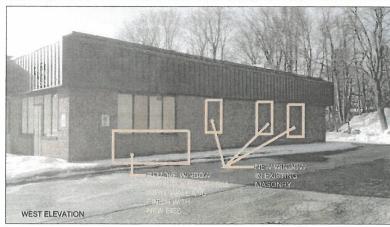

EXISTING PHOTOS

Michael J. Keane Architects, PLLC

ARCHITECTURE PLANNING DESIGN 101 Kent Place Newmarket, NH 03857

603-292-1400 mjkarchitects.com

Ill drawings and written materials appearing herein const riginal unpublished work of Michael J. Keane Architects, and may not be duplicated, used, or disclosed without ti written consent of Michael J. Keane Architects, PLLC, Newmarket, NH.

2018

CONSULTANTS

REVISIO	NS

PROJECT PROPOSED SERVICE CREDIT UNION BRANCH 83 SOUTH MAIN STREET

ROCHESTER, NH

SERVICE CREDIT UNION

3003 LAFAYETTE RD

03801

TITLE

PORTSMOUTH, NH

PROPOSED ELEVATIONS


NOT FOR CONSTRUCTION 3/3/2019


A2







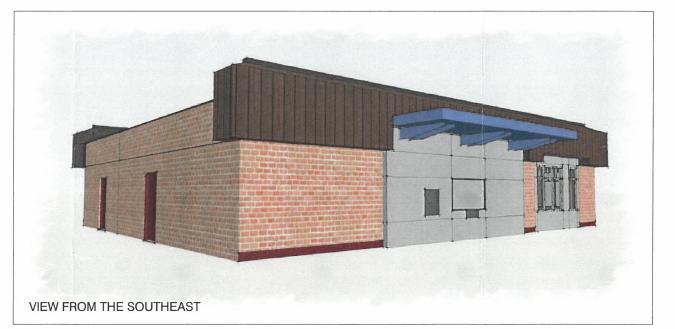

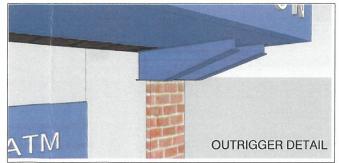



mjk Michael J. Keane Architects, PLLC

ARCHITECTURE
PLANNING
DESIGN
101 Kent Place
Newmarket, NH
03857

03857 603-292-1400 mjkarchitects.com

All drawings and written materials appearing herein constituoriginal unpublished work of Michael J. Keane Architects, PLI and may not be duplicated, used, or disclosed without the written consent of Michael J. Keane Architects, PLLC,

CONSULTANTS

REVISIONS

APPROVALS

Accept only original stamp and signature

PROJECT PROPOSED SERVICE CREDIT UNION BRANCH 83 SOUTH MAIN STREET ROCHESTER, NH

FOR:

SERVICE CREDIT UNION

03801

3003 LAFAYETTE RD PORTSMOUTH, NH

RENDERINGS AND SIGNS

NOT FOR CONSTRUCTION 3/3/2019

DRAWN BY: CHECKED BY:

DATE: SCALE: AS NO

DRAWING NO.

A3