


PROPOSED SITE PLAN 72 OLD MILTON ROAD, ROCHESTER, NH PREPARED FOR FIELDING'S OIL COMPANY, INC. DECEMBER 2018

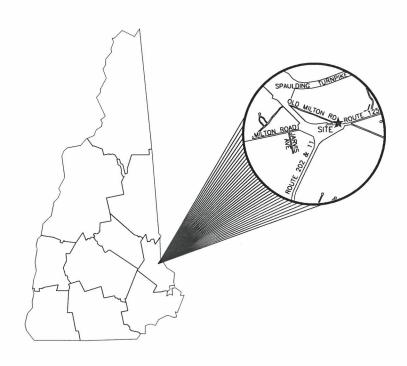



CIVIL ENGINEERS


NORWAY PLAINS ASSOCIATES, INC. 2 CONTINENTAL BOULEVARD ROCHESTER, NEW HAMPSHIRE 03867 (603) 335-3948

CAREFULLY REVIEW ALL SHEETS OF THIS PACKAGE TO INSURE PROPER CONSTRUCTION. SPECIFIC SITE CONDITIONS SHOULD BE EXPLORED PRIOR TO CONSTRUCTION. CONTACT BOTH THE DESIGN ENGINEER AND THE PROJECT OWNER FOR ANY AVAILABLE GEOTECHNICAL OR HYDROGEOLOGICAL INFORMATION AVAILABLE BUT NOT CONTAINED WITH IN THE PLAN SET. IF THERE ARE ANY QUESTIONS WITH THE DESIGN PRESENTED IN THIS PLAN SET PLEASE CONTACT THE ENGINEERING STAFF AT NORWAY PLAINS ASSOCIATES, INC. (603)—335–3948.

OWNER OF RECORD
TAX MAP 215-LOT 50
OWNER OF RECORD: BLANCHETTE/HURLEY REALTY, LLC 490 GONIC ROAD ROCHESTER, NH 03839 SCRD 3979/208

APPLICANT

FIELDING'S OIL COMPANY PO BOX 470 SCARBOROUGH, ME 04070 (207) 318-4020

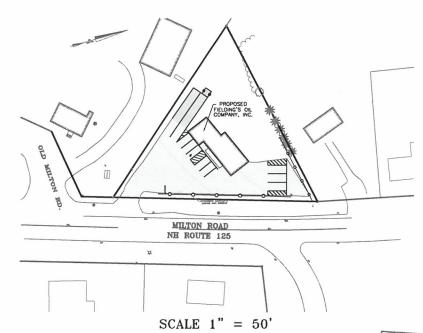

FINAL APPROVAL BY ROCHESTER PLANNING BOARD

SHEET INDEX

COVER EXISTING FEATURES OVERALL SITE PLAN DETAILED SITE PLAN CONSTRUCTION DETAILS E-1 C-1 C-2 C-3


1" = 20' 1" = 20' 1" = 20' AS SHOWN


FILE NO.147 PLAN NO.C-2949 DWG NO.18236\SP-


31 Mooney Street, Alton, N.H. 603-875-3948

NORWAY PLAINS ASSOCIATES.


2 Continental Blvd., Rochester, N.H. 603-335-3948

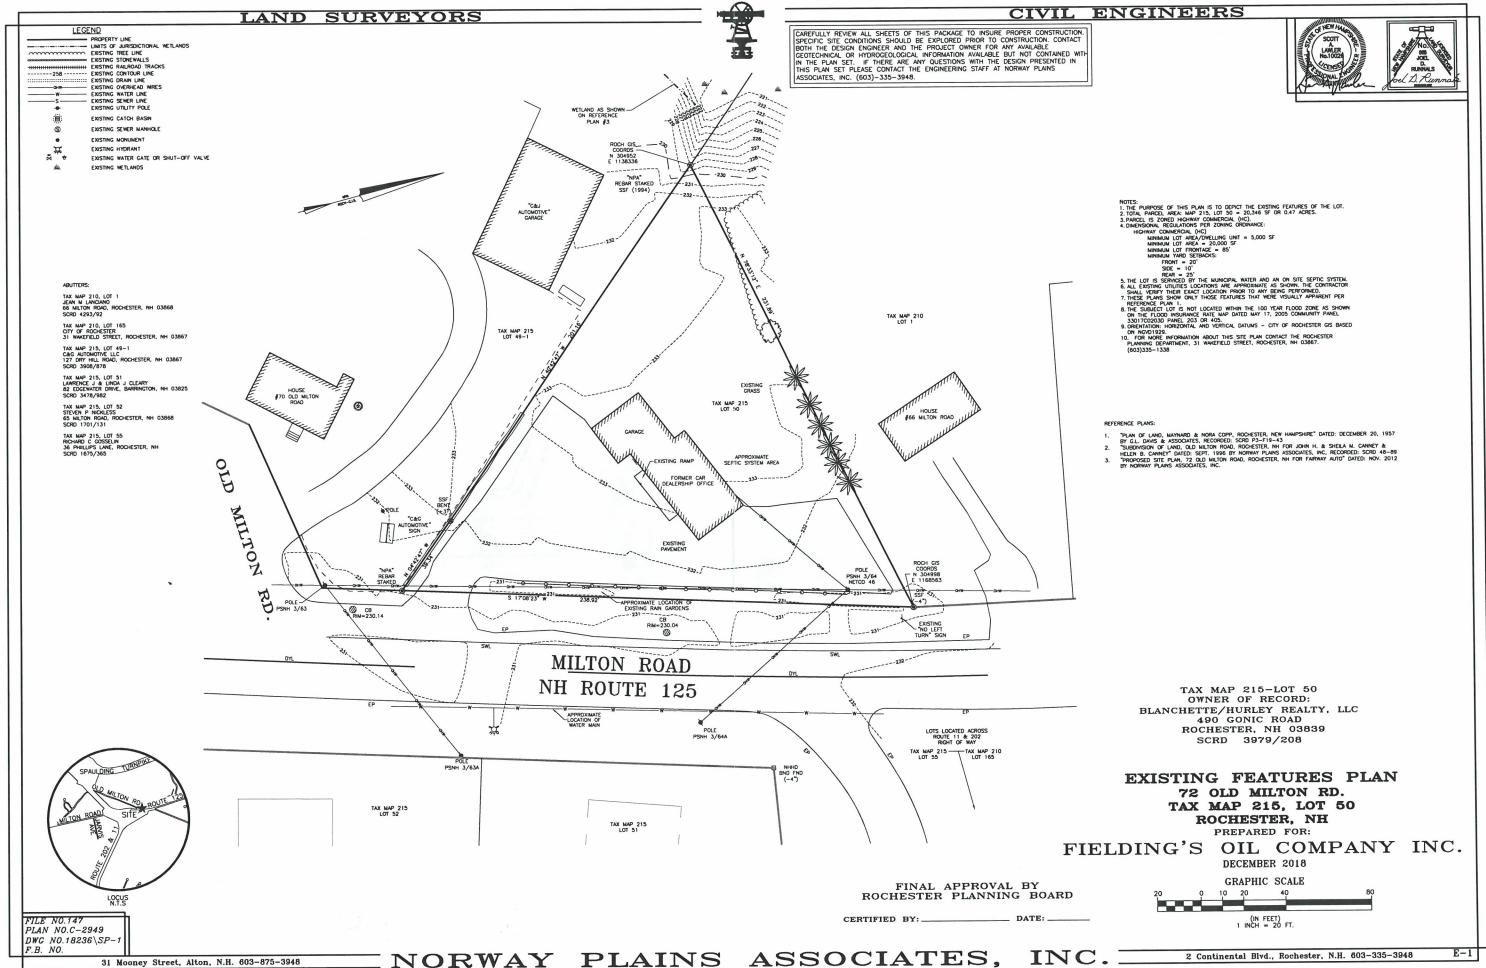


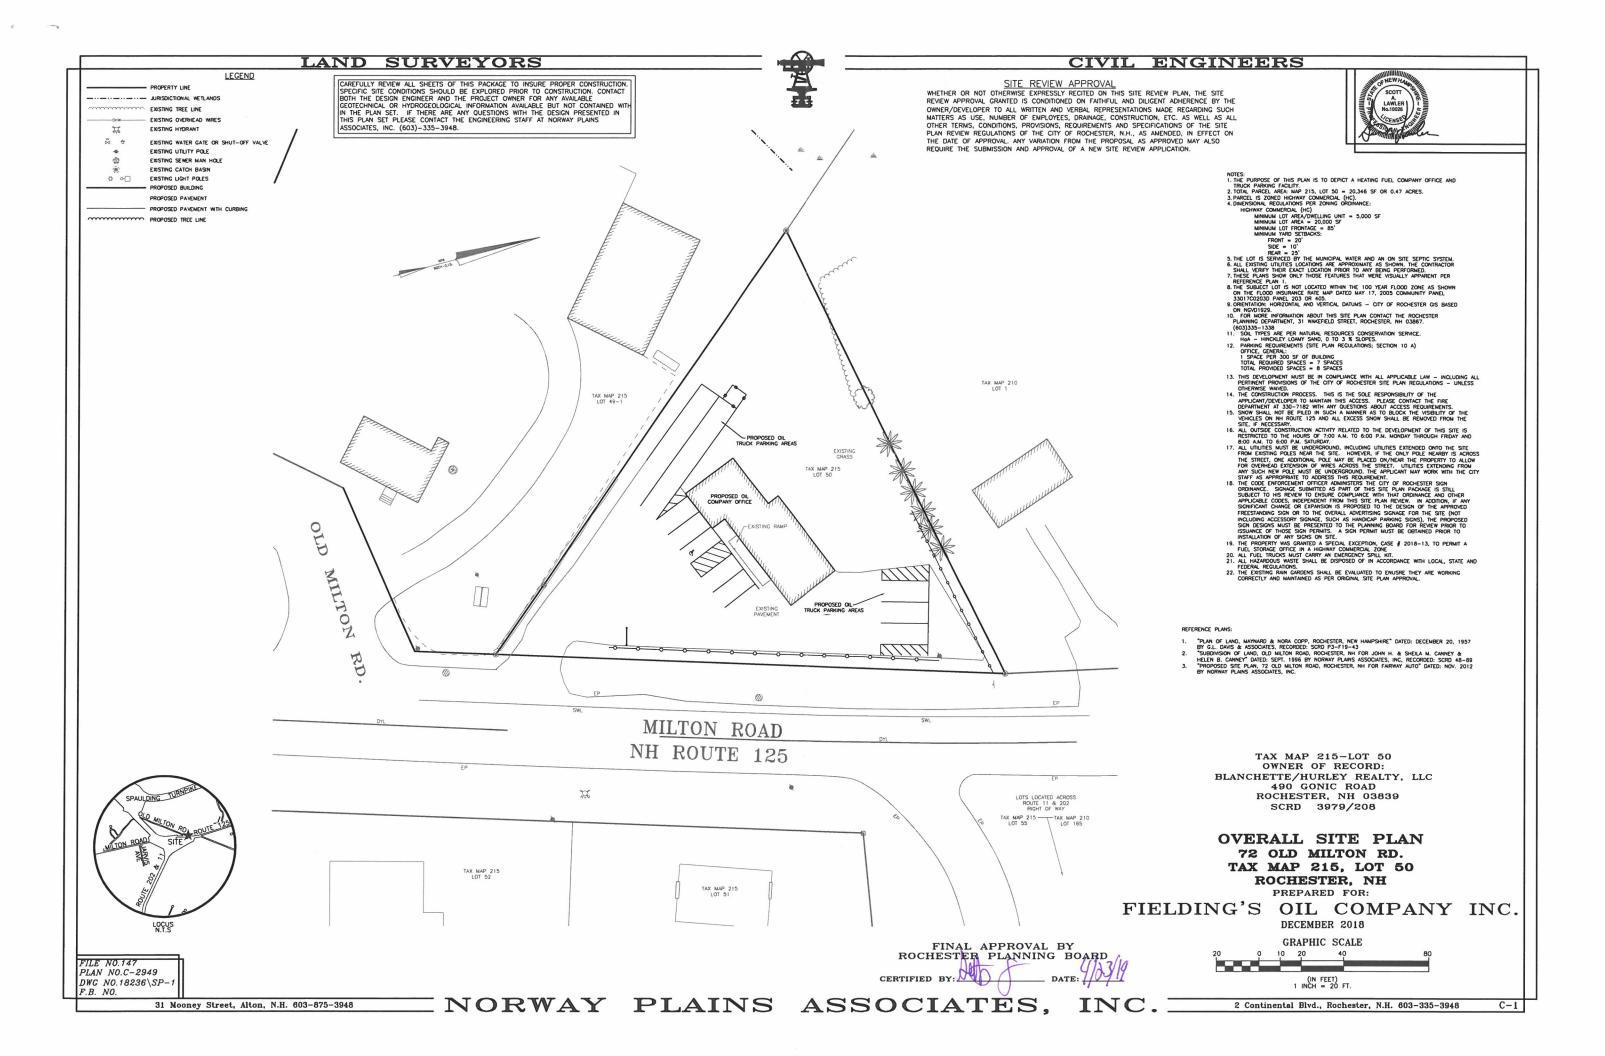

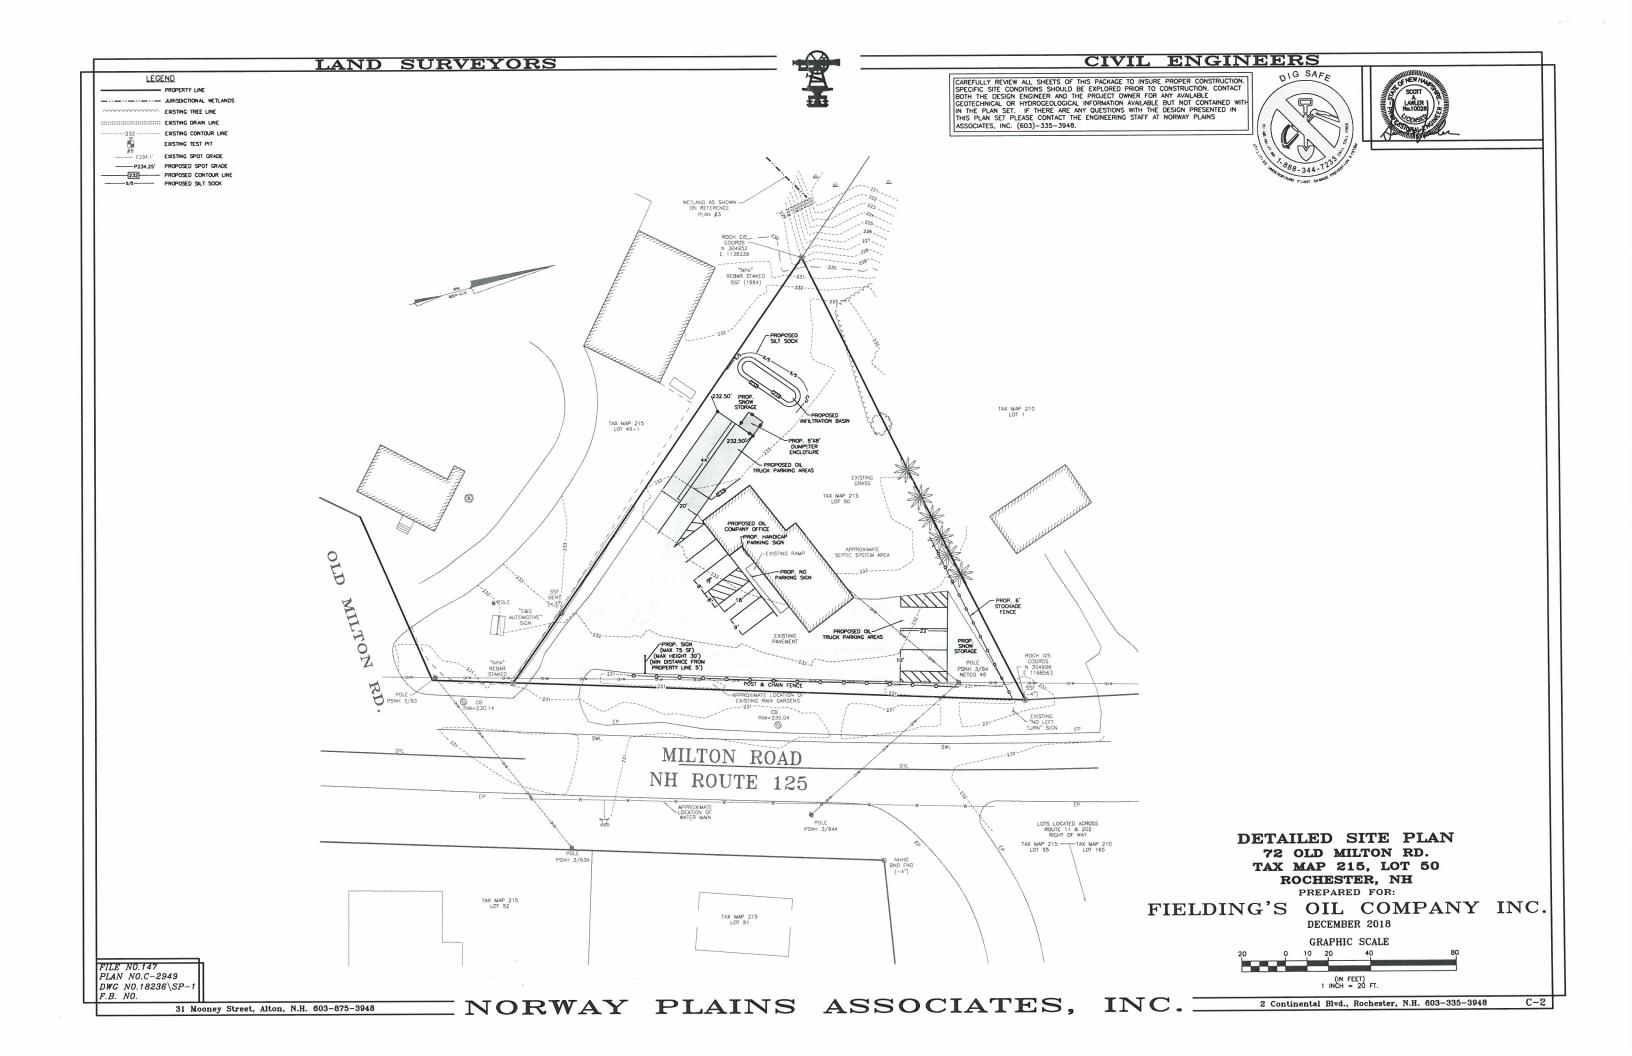

LAND SURVEYORS

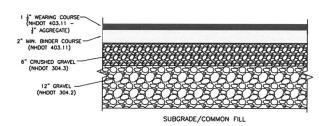

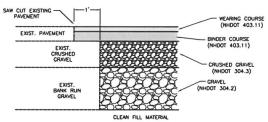

PARKING LOT CROSS-SECTIONS

NOT TO SCALE

TYPICAL PAVEMENT MATCHING DETAIL

NOT TO SCALE


PAYSEMENT NOTES:

1. PLACE COMMON FILL IN 12 INCH LIFTS, COMPACT COMMON FILL TO 93% MAXIMUM PROCTOR DENSITY.


2. PLACE GRAVEL IN MAXIMUM 8 INCH LIFTS, COMPACT TO 93% MAXIMUM PROCTOR DENSITY

3. PLACE GRAVEL IN MAXIMUM BOOLOGY DENSITY.

4. PAYEMENT MUST BE INSTALLED IN TWO COURSES, A BINDER COURSE AND A WEARING COURSE.

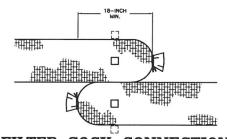

FILTER SOCK CONNECTION PLAN VIEW

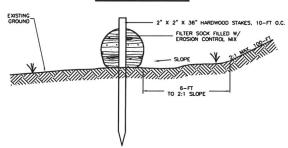

FILTER SOCK CROSS-SECTION

<u>ntenance requirements;</u> Filter sock maintenance shall follow the same schedule as erosion control hix berms

- ONSTRUCTION SPECIFICATIONS.

 COMPOSITION OF THE EROSON CONTROL MIX SHALL EITHER BE THE SAME AS EROSION CONTROL MIX BERN
 MATERIAL OR AS SPECIFIED BY THE FILTER SOCK MANUFACTURER.


 THE BARRIER MUST BE PLACED ALONG A RELITIVELY LEVEL CONTROL.

 IT MAY BE NECESSARY TO CUT TALL GRASSES AND WOODLY ECETATION TO AVOID CREATING VOIDS AND
 BRIDGES IN THE BARRIER THAT WOULD ENABLE FINEST OWASH UNDER THE BARRIER THROUGH THE GRASS
 BLACES OR PLANT ISTEMS.

CONTINUOUS CONTAINED BERM "FILTER SOCK" DETAIL

NOT TO SCALE

31 Mooney Street, Alton, N.H. 603-875-3948

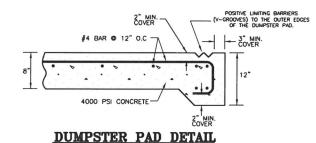


NOT TO SCALE

CIVIL ENGINEERS

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TYPICAL INFILTRATION BASIN CROSS SECTION

- DO NOT PLACE INFILTRATION BASIN INTO SERVICE UNTIL THE BMP HAS BEEN SEEDED AND ITS CONTRIBUTING AREAS HAVE BEEN FULLY STABILIZED.

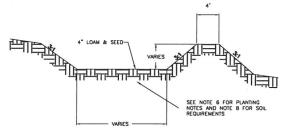



- NEW ENGLAND WETLAND PLANTS, INC. 820 WEST STREET AMHERST, MA 01002
- 7. ALL DISTURBED AREAS NOT OTHERWISE PLANTED SHALL RECEIVE FOUR INCHES OF LOAM AND SEEDED.

SIGN SIZE TEXT HEIGHT WIDTH G 12" VAN ACCESSIBLE NO 18" 12" R8-3

SIGN SCHEDULE

NOT TO SCALE

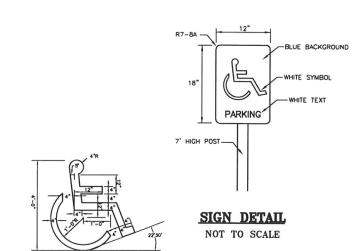

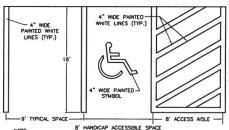

ACCESSIBLE SYMBOL

HANDICAP GRAPHIC SYMBOL (PAINTED WHITE) TO BE CENTERED IN SPACE.


SYMBOL TO BE PAINTED ON ASPHALT AS PER DETAIL

STALL STRIPING DETAIL

NOT TO SCALE

CONSTRUCTION DETAILS 72 OLD MILTON RD. TAX MAP 215, LOT 50 ROCHESTER, NH PREPARED FOR:

FIELDING'S OIL COMPANY INC. DECEMBER 2018

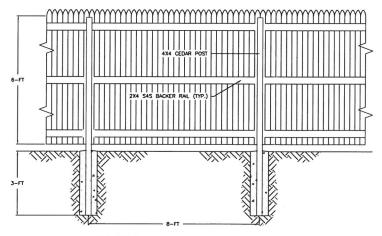

FENCE SPECIFICATIONS

- 1. FENCE POSTS SHALL BE 4"X4" CEDAR
- 2. STOCKADE PANELS SHALL BE 6-FT X 8-FT #1 NORTHERN WHITE edar. Pickets shall be 1x3x6-ft northern white cedar.
- 3. BACKER RAILS SHALL BE 2X4X8-FT S4S SQUARE END.
- 4. GOOD SIDE OF FENCE FACING OUT.

TYPICAL WOODEN STOCKADE DETAIL

SCALE: 1/2"=1'

PLAN NO.C-2949 DWG NO.18236\SP-

FILE NO 147