

Site Plans

Issued for	Permitting
Date Issued	August 7, 2019
Latest Issue	August 7, 2019


Twombly Substation

33 Twombly Street
Rochester, NH

Owner/Applicant

Public Service Co of NH
Eversource Energy DBA
PO Box 270
Hartford, CT 06141

Assessor's Map: 122
Lot: 94

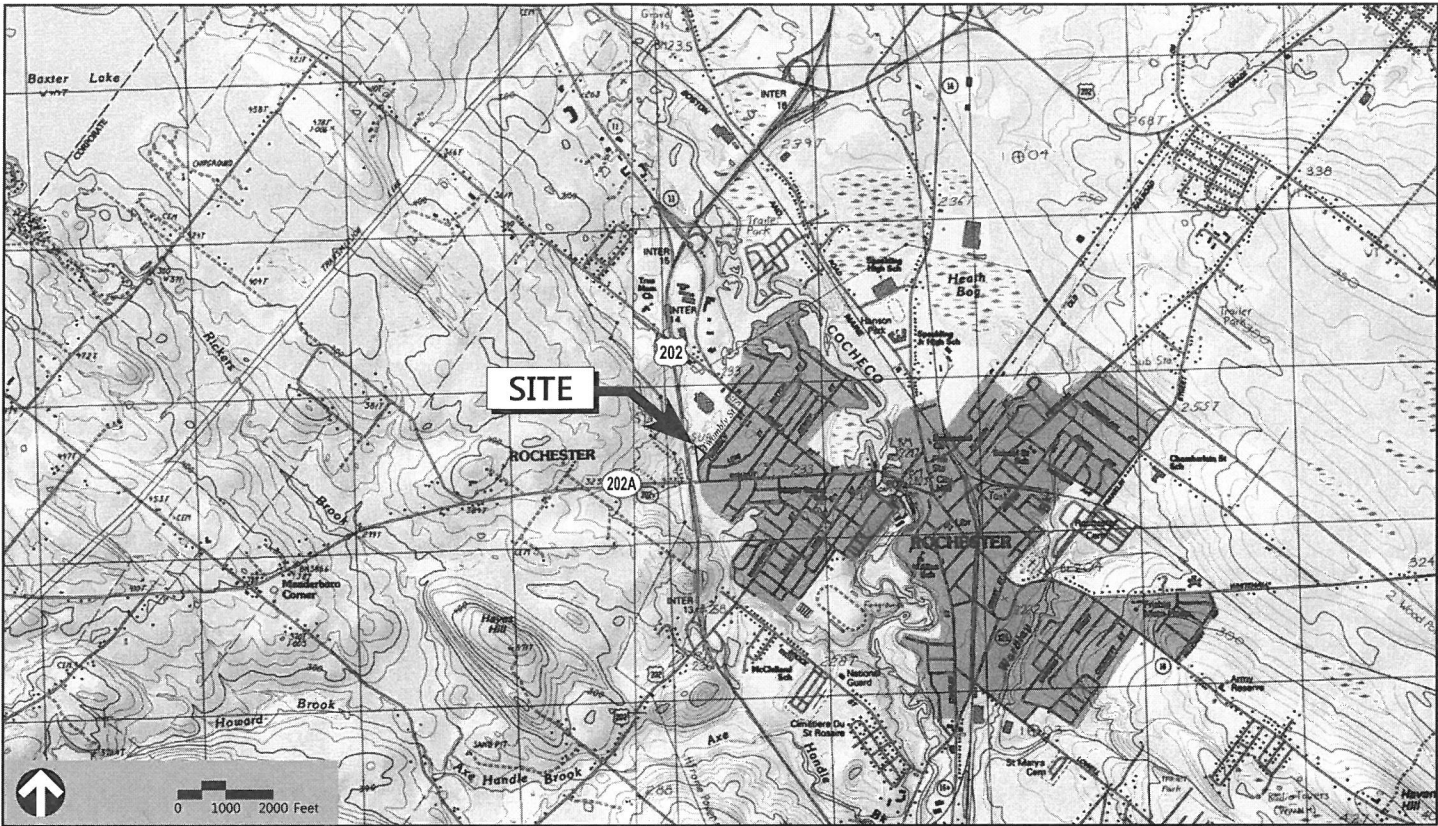

Sheet Index			Reference Drawings		
No.	Drawing Title	Latest Issue	No.	Drawing Title	Latest Issue
C-1	Legend and General Notes	August 7, 2019	4970C (EC)	Existing Conditions Plan for Public Service Company d/b/a Eversource Energy	August 1, 2019
C-2	Site Plan	August 7, 2019		Control Building	July 24, 2019
C-3	Erosion and Sediment Control Plan	August 7, 2019			
C-4	Site Details 1	August 7, 2019			




2 Bedford Farms Drive
Suite 200
Bedford, NH 03110
603.391.3900

Surveyor

Doucet Survey Inc
2 Commerce Drive
Suite 202
Bedford, NH 03110
603.614.4060

Geotechnical Engineer

S. W. Cole Engineering Inc
10 Centre Road
Somersworth, NH 03878
603.692.008

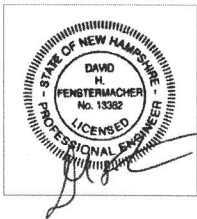



2 Bedford Farms Drive, Suite 200
Bedford, New Hampshire 03110
603.391.3900 • FAX 603.518.7495

Legend

Exist.	Prop.		Exist.	Prop.	
		PROPERTY LINE			CONCRETE
		PROJECT LIMIT LINE			HEAVY DUTY PAVEMENT
		RIGHT-OF-WAY/PROPERTY LINE			BUILDINGS
		EASEMENT			RIPRAP
		BUILDING SETBACK			CONSTRUCTION EXIT
		PARKING SETBACK			PERMANENT WETLAND IMPACTS
		BASELINE			TEMPORARY WETLAND IMPACTS
		CONSTRUCTION LAYOUT			TOP OF CURB ELEVATION
		ZONING LINE			BOTTOM OF CURB ELEVATION
		TOWN LINE			SPOT ELEVATION
		LIMIT OF DISTURBANCE			TOP & BOTTOM OF WALL ELEVATION
		WETLAND LINE WITH FLAG			BORING LOCATION
		FLOODPLAIN			TEST PIT LOCATION
		BORDERING LAND SUBJECT TO FLOODING			MONITORING WELL
		WETLAND BUFFER ZONE			UNDERDRAIN
		NO DISTURB ZONE			DRAIN
		200' RIVERFRONT AREA			ROOF DRAIN
		GRAVEL ROAD			SEWER
		EDGE OF PAVEMENT			FORCE MAIN
		BITUMINOUS BERM			OVERHEAD WIRE
		BITUMINOUS CURB			WATER
		CONCRETE CURB			FIRE PROTECTION
		CURB AND GUTTER			DOMESTIC WATER
		EXTRUDED CONCRETE CURB			GAS
		MONOLITHIC CONCRETE CURB			ELECTRIC
		PRECAST CONC. CURB			STEAM
		SLOPED GRAN. EDGING			TELEPHONE
		VERT. GRAN. CURB			FIRE ALARM
		LIMIT OF CURB TYPE			CABLE TV
		SAWCUT			CATCH BASIN CONCENTRIC
		BUILDING			CATCH BASIN ECCENTRIC
		BUILDING ENTRANCE			DOUBLE CATCH BASIN CONCENTRIC
		LOADING DOCK			DOUBLE CATCH BASIN ECCENTRIC
		BOLLARD			GUTTER INLET
		DUMPSTER PAD			DRAIN MANHOLE CONCENTRIC
		SIGN			DRAIN MANHOLE ECCENTRIC
		DOUBLE SIGN			TRENCH DRAIN
		STEEL GUARDRAIL			PLUG OR CAP
		WOOD GUARDRAIL			CLEANOUT
		PATH			FLARED END SECTION
		TREE LINE			HEADWALL
		WIRE FENCE			SEWER MANHOLE CONCENTRIC
		FENCE			SEWER MANHOLE ECCENTRIC
		STOCKADE FENCE			CURB STOP & BOX
		STONE WALL			WATER VALVE & BOX
		RETAINING WALL			TAPPING SLEEVE, VALVE & BOX
		STREAM / POND / WATER COURSE			SIAMESE CONNECTION
		DETENTION BASIN			FIRE HYDRANT
		HAY BALES			WATER METER
		SILT FENCE			POST INDICATOR VALVE
		SILT SOCK / STRAW WATTLE			WATER WELL
		MINOR CONTOUR			GAS GATE
		MAJOR CONTOUR			GAS METER
		PARKING COUNT			ELECTRIC MANHOLE
		COMPACT PARKING STALLS			ELECTRIC METER
		DOUBLE YELLOW LINE			LIGHT POLE
		STOP LINE			TELEPHONE MANHOLE
		CROSSWALK			TRANSFORMER PAD
		ACCESSIBLE CURB RAMP			POST INDICATOR VALVE
		ACCESSIBLE PARKING			UTILITY POLE
		VAN-ACCESSIBLE PARKING			GUY POLE
		HAND HOLE			GUY WIRE & ANCHOR
		PULL BOX			HAND HOLE
		PULL BOX			PULL BOX
		MATCHLINE			MATCHLINE

Abbreviations

General	
ABAN	ABANDON
ACR	ACCESSIBLE CURB RAMP
ADJ	ADJUST
APPROX	APPROXIMATE
BIT	BITUMINOUS
BS	BOTTOM OF SLOPE
BWLL	BROKEN WHITE LANE LINE
CONC	CONCRETE
DYCL	DOUBLE YELLOW CENTER LINE
EL	ELEVATION
ELEV	ELEVATION
EX	EXISTING
FDN	FOUNDATION
FFE	FIRST FLOOR ELEVATION
GRAN	GRANITE
GTD	GRADE TO DRAIN
LA	LANDSCAPE AREA
LOD	LIMIT OF DISTURBANCE
MAX	MAXIMUM
MIN	MINIMUM
NIC	NOT IN CONTRACT
NTS	NOT TO SCALE
PERF	PERFORATED
PROP	PROPOSED
REM	REMOVE
RET	RETAIN
R&D	REMOVE AND DISPOSE
R&R	REMOVE AND RESET
SWEL	SOLID WHITE EDGE LINE
SWLL	SOLID WHITE LANE LINE
TS	TOP OF SLOPE
TYP	TYPICAL
Utility	
CB	CATCH BASIN
CMP	CORRUGATED METAL PIPE
CO	CLEANOUT
DCB	DOUBLE CATCH BASIN
DMH	DRAIN MANHOLE
CIP	CAST IRON PIPE
COND	CONDUIT
DIP	DUCTILE IRON PIPE
FES	FLARED END SECTION
FM	FORCE MAIN
F&G	FRAME AND GRATE
F&C	FRAME AND COVER
GI	GUTTER INLET
GT	GREASE TRAP
HDPE	HIGH DENSITY POLYETHYLENE PIPE
HH	HANDHOLE
HW	HEADWALL
HYD	HYDRANT
INV	INVERT ELEVATION
I=	INVERT ELEVATION
LP	LIGHT POLE
MES	METAL END SECTION
PV	POST INDICATOR VALVE
PWW	PAVED WATER WAY
PVC	POLYVINYLCHLORIDE PIPE
RCP	REINFORCED CONCRETE PIPE
R=	RIM ELEVATION
RIM=	RIM ELEVATION
SMH	SEWER MANHOLE
TSV	TAPPING SLEEVE, VALVE AND BOX
UG	UNDERGROUND
UP	UTILITY POLE

Notes

- General**
- THE INTENT OF THIS PLANSET IS TO SHOW PROPOSED SITE IMPROVEMENTS ASSOCIATED WITH THE SUBSTATION REBUILD ON TWOMBLY STREET IN ROCHESTER, NEW HAMPSHIRE.
 - CONTRACTOR SHALL NOTIFY "DIG-SAFE" (1-888-344-7233) AT LEAST 72 HOURS BEFORE EXCAVATING.
 - CONTRACTOR SHALL BE RESPONSIBLE FOR SITE SECURITY AND JOB SAFETY. CONSTRUCTION ACTIVITIES SHALL BE IN ACCORDANCE WITH OSHA STANDARDS AND LOCAL REQUIREMENTS.
 - ACCESSIBLE ROUTES, PARKING SPACES, RAMPS, SIDEWALKS AND WALKWAYS SHALL BE CONSTRUCTED IN CONFORMANCE WITH THE FEDERAL AMERICANS WITH DISABILITIES ACT AND WITH STATE AND LOCAL LAWS AND REGULATIONS (WHICHEVER ARE MORE STRINGENT).
 - AREAS DISTURBED DURING CONSTRUCTION AND NOT RESTORED WITH IMPERVIOUS SURFACES (BUILDINGS, PAVEMENTS, WALKS, ETC.) SHALL RECEIVE SIX (6) INCHES LOAM AND SEED.
 - WITHIN THE LIMITS OF THE BUILDING FOOTPRINT, THE SITE CONTRACTOR SHALL PERFORM EARTHWORK OPERATIONS REQUIRED UP TO SUBGRADE ELEVATIONS.
 - WORK WITHIN THE LOCAL RIGHTS-OF-WAY SHALL CONFORM TO LOCAL MUNICIPAL STANDARDS. WORK WITHIN STATE RIGHTS-OF-WAY SHALL CONFORM TO THE LATEST EDITION OF THE STATE HIGHWAY DEPARTMENTS STANDARD SPECIFICATIONS FOR HIGHWAYS AND BRIDGES.
 - UPON AWARD OF CONTRACT, CONTRACTOR SHALL MAKE NECESSARY CONSTRUCTION NOTIFICATIONS AND APPLY FOR AND OBTAIN NECESSARY PERMITS, PAY FEES, AND POST BONDS ASSOCIATED WITH THE WORK INDICATED ON THE DRAWINGS, IN THE SPECIFICATIONS, AND IN THE CONTRACT DOCUMENTS. DO NOT CLOSE OR OBSTRUCT ROADWAYS, SIDEWALKS, AND FIRE HYDRANTS, WITHOUT APPROPRIATE PERMITS.
 - TRAFFIC SIGNAGE AND PAVEMENT MARKINGS SHALL CONFORM TO THE MANUAL OF UNIFORM TRAFFIC CONTROL DEVICES.
 - AREAS OUTSIDE THE LIMITS OF PROPOSED WORK DISTURBED BY THE CONTRACTOR'S OPERATIONS SHALL BE RESTORED BY THE CONTRACTOR TO THEIR ORIGINAL CONDITION AT THE CONTRACTOR'S EXPENSE.
 - IN THE EVENT THAT SUSPECTED CONTAMINATED SOIL, GROUNDWATER, AND OTHER MEDIA ARE ENCOUNTERED DURING EXCAVATION AND CONSTRUCTION ACTIVITIES BASED ON VISUAL, OLFACTORY, OR OTHER EVIDENCE, THE CONTRACTOR SHALL STOP WORK IN THE VICINITY OF THE SUSPECT MATERIAL TO AVOID FURTHER SPREADING OF THE MATERIAL, AND SHALL NOTIFY THE OWNER IMMEDIATELY SO THAT THE APPROPRIATE TESTING AND SUBSEQUENT ACTION CAN BE TAKEN.
 - CONTRACTOR SHALL PREVENT DUST, SEDIMENT, AND DEBRIS FROM EXITING THE SITE AND SHALL BE RESPONSIBLE FOR CLEANUP, REPAIRS AND CORRECTIVE ACTION IF SUCH OCCURS.
 - DAMAGE RESULTING FROM CONSTRUCTION LOADS SHALL BE REPAIRED BY THE CONTRACTOR AT NO ADDITIONAL COST TO OWNER.
 - CONTRACTOR SHALL CONTROL STORMWATER RUNOFF DURING CONSTRUCTION TO PREVENT ADVERSE IMPACTS TO OFF-SITE AREAS, AND SHALL BE RESPONSIBLE TO REPAIR RESULTING DAMAGES, IF ANY, AT NO COST TO OWNER.

Utilities

- THE LOCATIONS, SIZES, AND TYPES OF EXISTING UTILITIES ARE SHOWN AS AN APPROXIMATE REPRESENTATION ONLY. THE OWNER OR ITS REPRESENTATIVES HAVE NOT INDEPENDENTLY VERIFIED THIS INFORMATION AS SHOWN ON THE PLANS. THE UTILITY INFORMATION SHOWN DOES NOT GUARANTEE THE ACTUAL EXISTENCE, SERVICEABILITY, OR OTHER DATA CONCERNING THE UTILITIES, NOR DOES IT GUARANTEE AGAINST THE POSSIBILITY THAT ADDITIONAL UTILITIES MAY BE PRESENT THAT ARE NOT SHOWN ON THE PLANS. PRIOR TO ORDERING MATERIALS AND BEGINNING CONSTRUCTION, THE CONTRACTOR SHALL VERIFY AND DETERMINE THE EXACT LOCATIONS, SIZES, AND ELEVATIONS OF THE POINTS OF CONNECTIONS TO EXISTING UTILITIES AND, SHALL CONFIRM THAT THERE ARE NO INTERFERENCES WITH EXISTING UTILITIES AND THE PROPOSED UTILITY ROUTES, INCLUDING ROUTES WITHIN THE PUBLIC RIGHTS OF WAY.
- WHERE AN EXISTING UTILITY IS FOUND TO CONFLICT WITH THE PROPOSED WORK, OR EXISTING CONDITIONS DIFFER FROM THOSE SHOWN SUCH THAT THE WORK CANNOT BE COMPLETED AS INTENDED, THE LOCATION, ELEVATION, AND SIZE OF THE UTILITY SHALL BE ACCURATELY DETERMINED WITHOUT DELAY BY THE CONTRACTOR, AND THE INFORMATION FURNISHED IN WRITING TO THE OWNER'S REPRESENTATIVE FOR THE RESOLUTION OF THE CONFLICT AND CONTRACTOR'S FAILURE TO NOTIFY PRIOR TO PERFORMING ADDITIONAL WORK RELEASES OWNER FROM OBLIGATIONS FOR ADDITIONAL PAYMENTS WHICH OTHERWISE MAY BE WARRANTED TO RESOLVE THE CONFLICT.
- SET CATCH BASIN RIMS, AND INVERTS OF SEWERS, DRAINS, AND DITCHES IN ACCORDANCE WITH ELEVATIONS ON THE GRADING AND UTILITY PLANS.
- RIM ELEVATIONS FOR DRAIN AND SEWER MANHOLES, WATER VALVE COVERS, GAS GATES, ELECTRIC AND TELEPHONE PULL BOXES, AND MANHOLES, AND OTHER SUCH ITEMS, ARE APPROXIMATE AND SHALL BE SET/RESET AS FOLLOWS:
 - PAVEMENTS AND CONCRETE SURFACES: FLUSH
 - ALL SURFACES ALONG ACCESSIBLE ROUTES: FLUSH
 - LANDSCAPE, LOAM AND SEED, AND OTHER EARTH SURFACE AREAS: ONE INCH ABOVE SURROUNDING AREA AND TAPER EARTH TO THE RIM ELEVATION.
- THE LOCATION, SIZE, DEPTH, AND SPECIFICATIONS FOR CONSTRUCTION OF PROPOSED PRIVATE UTILITY SERVICES SHALL BE INSTALLED ACCORDING TO THE REQUIREMENTS PROVIDED BY, AND APPROVED BY, THE RESPECTIVE UTILITY COMPANY (GAS, TELEPHONE, ELECTRIC, FIRE ALARM, ETC.). FINAL DESIGN LOADS AND LOCATIONS TO BE COORDINATED WITH OWNER AND ARCHITECT.
- CONTRACTOR SHALL MAKE ARRANGEMENTS FOR AND SHALL BE RESPONSIBLE FOR PAYING FEES FOR POLE RELOCATION AND FOR THE ALTERATION AND ADJUSTMENT OF GAS, ELECTRIC, TELEPHONE, FIRE ALARM, AND ANY OTHER PRIVATE UTILITIES, WHETHER WORK IS PERFORMED BY CONTRACTOR OR BY THE UTILITIES COMPANY.
- UTILITY PIPE MATERIALS SHALL BE AS FOLLOWS, UNLESS OTHERWISE NOTED ON THE PLAN:
 - STORM DRAINAGE PIPES SHALL BE REINFORCED CONCRETE PIPE (RCP).
- CONTRACTOR SHALL COORDINATE WITH ELECTRICAL CONTRACTOR AND SHALL FURNISH EXCAVATION, INSTALLATION, AND BACKFILL OF ELECTRICAL FURNISHED SITEWORK RELATED ITEMS SUCH AS PULL BOXES, CONDUITS, DUCT BANKS, LIGHT POLE BASES, AND CONCRETE PADS. SITE CONTRACTOR SHALL FURNISH CONCRETE ENCASEMENT OF DUCT BANKS IF REQUIRED BY THE UTILITY COMPANY AND AS INDICATED ON THE DRAWINGS.
- ALL DRAINAGE AND SANITARY STRUCTURE INTERIOR DIAMETERS (4" MIN.) SHALL BE DETERMINED BY THE MANUFACTURER BASED ON THE PIPE CONFIGURATIONS SHOWN ON THESE PLANS AND LOCAL MUNICIPAL STANDARDS. FOR MANHOLES THAT ARE 20 FEET IN DEPTH AND GREATER, THE MINIMUM DIAMETER SHALL BE 5 FEET.

Layout and Materials

- DIMENSIONS ARE FROM THE EDGE OF GRAVEL, FACE OF BUILDING, FACE OF WALL, AND CENTER LINE OF PAVEMENT MARKINGS, UNLESS OTHERWISE NOTED.
- SEE ARCHITECTURAL DRAWINGS FOR EXACT BUILDING DIMENSIONS AND DETAILS CONTIGUOUS TO THE BUILDING, INCLUDING SIDEWALKS, RAMPS, BUILDING ENTRANCES, STAIRWAYS, UTILITY PENETRATIONS, CONCRETE DOOR PADS, COMPACTOR PAD, LOADING DOCKS, BOLLARDS, ETC.
- PROPOSED BOUNDS AND ANY EXISTING PROPERTY LINE MONUMENTATION DISTURBED DURING CONSTRUCTION SHALL BE SET OR RESET BY A LICENSED LICENSED SURVEYOR (LLS).
- PRIOR TO START OF CONSTRUCTION, CONTRACTOR SHALL VERIFY EXISTING PAVEMENT ELEVATIONS AT INTERFACE WITH PROPOSED PAVEMENTS, AND EXISTING GROUND ELEVATIONS ADJACENT TO DRAINAGE OUTLETS TO ASSURE PROPER TRANSITIONS BETWEEN EXISTING AND PROPOSED FACILITIES.

Demolition

- CONTRACTOR SHALL REMOVE AND DISPOSE OF EXISTING MANMADE SURFACE FEATURES WITHIN THE LIMIT OF WORK INCLUDING BUILDINGS, STRUCTURES, PAVEMENTS, SLABS, CURBING, FENCES, UTILITY POLES, SIGNS, ETC. UNLESS INDICATED OTHERWISE ON THE DRAWINGS. REMOVE AND DISPOSE OF EXISTING UTILITIES, FOUNDATIONS AND UNSUITABLE MATERIAL BENEATH AND FOR A DISTANCE OF 10 FEET BEYOND THE PROPOSED BUILDING FOOTPRINT INCLUDING EXTERIOR COLUMNS.
- EXISTING UTILITIES SHALL BE TERMINATED, UNLESS OTHERWISE NOTED, IN CONFORMANCE WITH LOCAL STATE AND INDIVIDUAL UTILITY COMPANY STANDARD SPECIFICATIONS AND DETAILS. THE CONTRACTOR SHALL COORDINATE UTILITY SERVICE DISCONNECTS WITH THE UTILITY REPRESENTATIVES.
- CONTRACTOR SHALL DISPOSE OF DEMOLITION DEBRIS IN ACCORDANCE WITH APPLICABLE FEDERAL, STATE AND LOCAL REGULATIONS, ORDINANCES AND STATUTES.
- THE DEMOLITION LIMITS DEPICTED IN THE PLANS IS INTENDED TO AID THE CONTRACTOR DURING THE BIDDING AND CONSTRUCTION PROCESS AND IS NOT INTENDED TO DEPICT EACH AND EVERY ELEMENT OF DEMOLITION. THE CONTRACTOR IS RESPONSIBLE FOR IDENTIFYING THE DETAILED SCOPE OF DEMOLITION BEFORE SUBMITTING ITS BID/PROPOSAL TO PERFORM THE WORK AND SHALL MAKE NO CLAIMS AND SEEK NO ADDITIONAL COMPENSATION FOR CHANGED CONDITIONS OR UNFORESEEN OR LATENT SITE CONDITIONS RELATED TO ANY CONDITIONS DISCOVERED DURING EXECUTION OF THE WORK.
- UNLESS OTHERWISE SPECIFICALLY PROVIDED ON THE PLANS OR IN THE SPECIFICATIONS, THE ENGINEER HAS NOT PREPARED DESIGNS FOR AND SHALL HAVE NO RESPONSIBILITY FOR THE PRESENCE, DISCOVERY, REMOVAL, ABATEMENT OR DISPOSAL OF HAZARDOUS MATERIALS, TOXIC WASTES OR POLLUTANTS AT THE PROJECT SITE. THE ENGINEER SHALL NOT BE RESPONSIBLE FOR ANY CLAIMS OF LOSS, DAMAGE, EXPENSE, DELAY, INJURY OR DEATH ARISING FROM THE PRESENCE OF HAZARDOUS MATERIAL AND CONTRACTOR SHALL INDEMNIFY AND HOLD HARMLESS THE ENGINEER FROM ANY CLAIMS MADE IN CONNECTION THEREWITH. MOREOVER, THE ENGINEER SHALL HAVE NO ADMINISTRATIVE OBLIGATIONS OF ANY TYPE WITH REGARD TO ANY CONTRACTOR AMENDMENT INVOLVING THE ISSUES OF PRESENCE, DISCOVERY, REMOVAL, ABATEMENT OR DISPOSAL OF ASBESTOS OR OTHER HAZARDOUS MATERIALS.

Erosion Control

- PRIOR TO STARTING ANY OTHER WORK ON THE SITE, THE CONTRACTOR SHALL NOTIFY APPROPRIATE AGENCIES AND SHALL INSTALL EROSION CONTROL MEASURES AS SHOWN ON THE PLANS AND AS IDENTIFIED IN FEDERAL, STATE, AND LOCAL APPROVAL DOCUMENTS PERTAINING TO THIS PROJECT.
- CONTRACTOR SHALL INSPECT AND MAINTAIN EROSION CONTROL MEASURES ON A WEEKLY BASIS (MINIMUM). THE CONTRACTOR SHALL ADDRESS DEFICIENCIES AND MAINTENANCE ITEMS WITHIN TWENTY-FOUR HOURS OF INSPECTION. CONTRACTOR SHALL PROPERLY DISPOSE OF SEDIMENT SUCH THAT IT DOES NOT ENCUMBER OTHER DRAINAGE STRUCTURES AND PROTECTED AREAS.
- CONTRACTOR SHALL BE FULLY RESPONSIBLE TO CONTROL CONSTRUCTION SUCH THAT SEDIMENTATION SHALL NOT AFFECT REGULATORY PROTECTED AREAS, WHETHER SUCH SEDIMENTATION IS CAUSED BY WATER, WIND, OR DIRECT DEPOSIT.
- CONTRACTOR SHALL PERFORM CONSTRUCTION SEQUENCING SUCH THAT EARTH MATERIALS ARE EXPOSED FOR A MINIMUM OF TIME BEFORE THEY ARE COVERED, SEEDED, OR OTHERWISE STABILIZED TO PREVENT EROSION.
- UPON COMPLETION OF CONSTRUCTION AND ESTABLISHMENT OF PERMANENT GROUND COVER, CONTRACTOR SHALL REMOVE AND DISPOSE OF EROSION CONTROL MEASURES AND CLEAN SEDIMENT AND DEBRIS FROM ENTIRE DRAINAGE AND SEWER SYSTEMS.

Existing Conditions Information

- BASE PLAN: THE EXISTING CONDITIONS PLAN IS BASED ON ACTUAL ON THE GROUND SURVEY PERFORMED BY DOUCET SURVEY INC.

Document Use

- THESE PLANS AND CORRESPONDING CADD DOCUMENTS ARE INSTRUMENTS OF PROFESSIONAL SERVICE, AND SHALL NOT BE USED, IN WHOLE OR IN PART, FOR ANY PURPOSE OTHER THAN FOR WHICH IT WAS CREATED WITHOUT THE EXPRESSED, WRITTEN CONSENT OF VHB. ANY UNAUTHORIZED USE, REUSE, MODIFICATION OR ALTERATION, INCLUDING AUTOMATED CONVERSION OF THIS DOCUMENT SHALL BE AT THE USER'S SOLE RISK WITHOUT LIABILITY OR LEGAL EXPOSURE TO VHB.
- CONTRACTOR SHALL NOT RELY SOLELY ON ELECTRONIC VERSIONS OF PLANS, SPECIFICATIONS, AND DATA FILES THAT ARE OBTAINED FROM THE DESIGNERS, BUT SHALL VERIFY LOCATION OF PROJECT FEATURES IN ACCORDANCE WITH THE PAPER COPIES OF THE PLANS AND SPECIFICATIONS THAT ARE SUPPLIED AS PART OF THE CONTRACT DOCUMENTS.
- SYMBOLS AND LEGENDS OF PROJECT FEATURES ARE GRAPHIC REPRESENTATIONS AND ARE NOT NECESSARILY SCALED TO THEIR ACTUAL DIMENSIONS OR LOCATIONS ON THE DRAWINGS. THE CONTRACTOR SHALL REFER TO THE DETAIL SHEET DIMENSIONS, MANUFACTURERS' LITERATURE, SHOP DRAWINGS AND FIELD MEASUREMENTS OF SUPPLIED PRODUCTS FOR LAYOUT OF THE PROJECT FEATURES.



CONTRACT SERVICES	REV	DESCRIPTION	ENG/PE#	DATE	DRN	CHKD	APPR	
DWG REV		EPN/DESCRIPTION		CONT/PE#	DATE	DRN	CHKD	APPR

EVERSOURCE
ENERGY

LEGEND AND GENERAL NOTES

TWOMBLY ST. S/S ROCHESTER, NH

SCALE: 1"=20'

FILE: 14523.09-LG.DWG

DRAWING NO.


DRAWN: MEQ/VHB

ENGINEER: MEQ/VHB

CHECKED: MJV/VHB

APPROVED: DHF/VHB

DATE: Aug 7, 2019

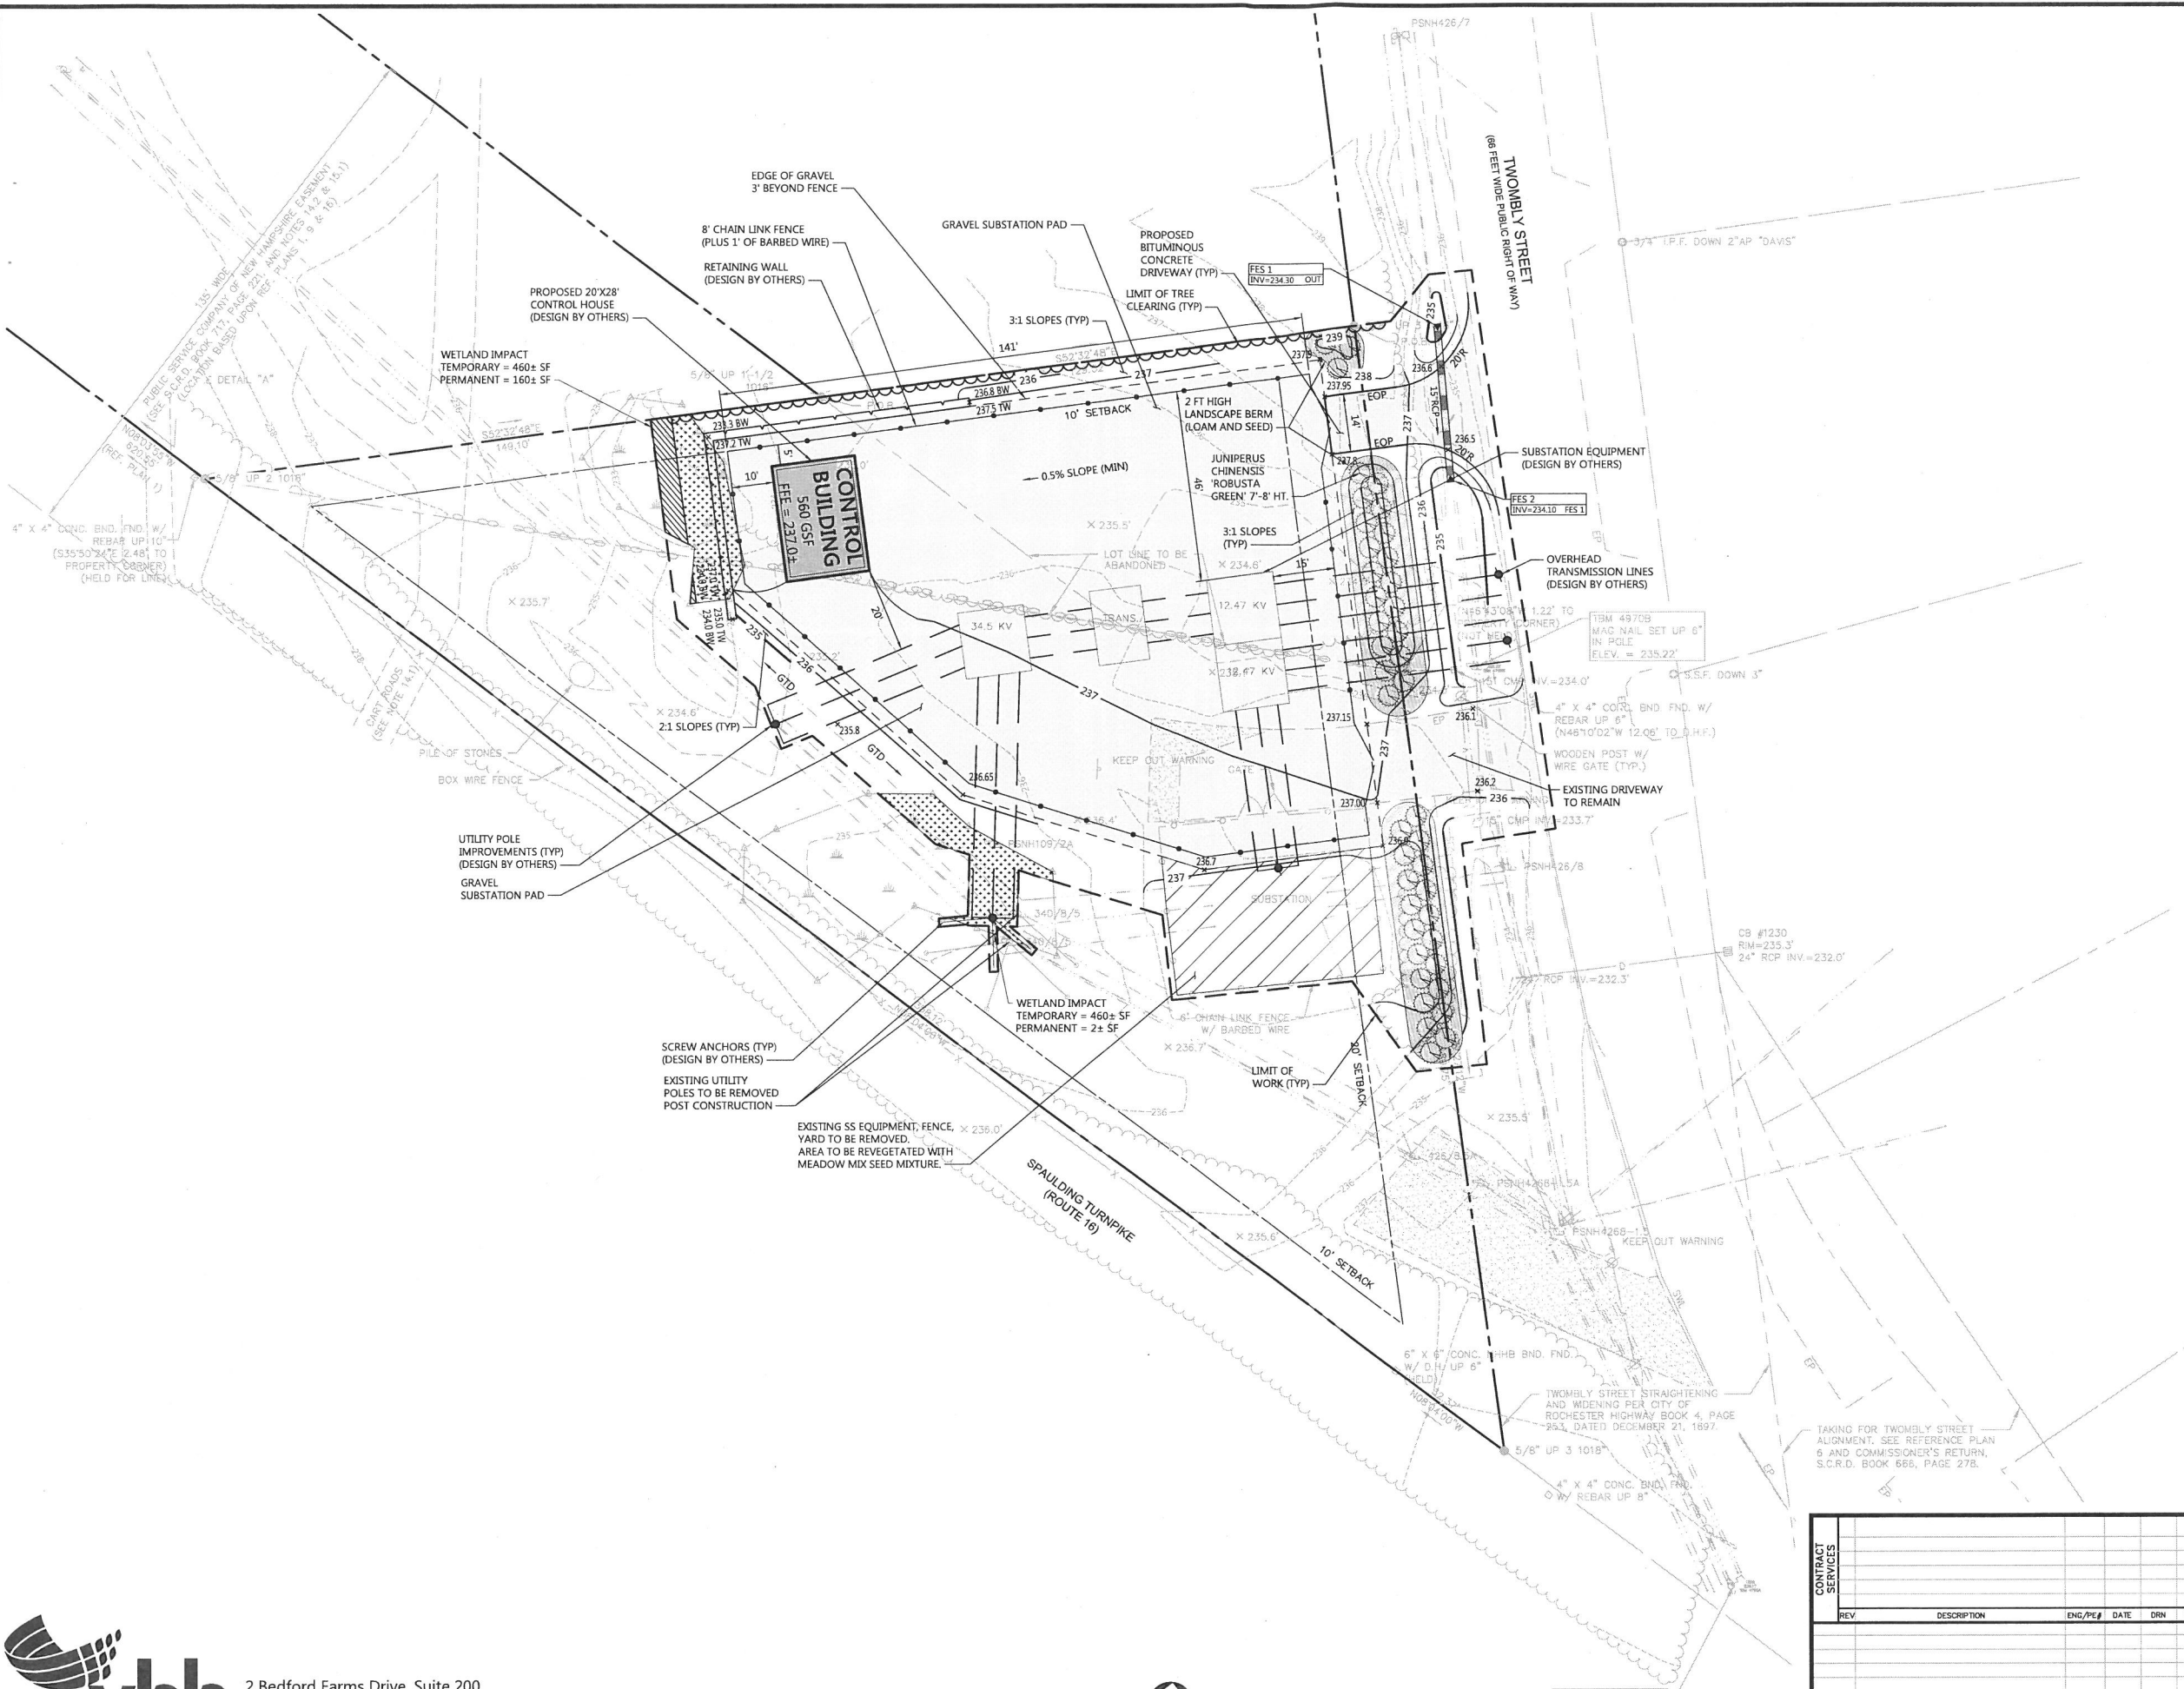

CONTRACT SERVICES	REV	DESCRIPTION	ENG/PE#	DATE	DRN	CHKD	APPR
EVSOURCE ENERGY		SITE PLAN					
TWOMBLY ST. S/S ROCHESTER, NH		SCALE: 1"=20'					
DRAWING NO.		FILE: 14523.09-SP.DWG					
DATE		AUG 7, 2019					
DRAWN		MEO/VHB					
ENGINEER		MEO/VHB					
CHECKED		MJV/VHB					
APPROVED		DHF/VHB					
DATE		AUG 7, 2019					

Erosion Control

1. PRIOR TO STARTING ANY OTHER WORK ON THE SITE, THE CONTRACTOR SHALL NOTIFY APPROPRIATE AGENCIES AND SHALL INSTALL EROSION CONTROL MEASURES AS SHOWN ON THE PLANS AND AS IDENTIFIED IN FEDERAL, STATE, AND LOCAL APPROVAL DOCUMENTS PERTAINING TO THIS PROJECT.
2. CONTRACTOR SHALL INSPECT AND MAINTAIN EROSION CONTROL MEASURES, AND REMOVE SEDIMENT THEREFROM ON A WEEKLY BASIS AND WITHIN TWELVE HOURS AFTER EACH STORM EVENT (0.5" OF RAINFALL OR GREATER) AND DISPOSE OF SEDIMENTS IN AN UPLAND AREA SUCH THAT THEY DO NOT ENCUMBER OTHER DRAINAGE STRUCTURES AND PROTECTED AREAS.
3. CONTRACTOR SHALL BE FULLY RESPONSIBLE TO CONTROL CONSTRUCTION SUCH THAT SEDIMENTATION SHALL NOT AFFECT REGULATORY PROTECTED AREAS, WHETHER SUCH SEDIMENTATION IS CAUSED BY WATER, WIND, OR DIRECT DEPOSIT.
4. CONTRACTOR SHALL PERFORM CONSTRUCTION SEQUENCING SUCH THAT EARTH MATERIALS ARE EXPOSED FOR A MINIMUM OF TIME BEFORE THEY ARE COVERED, SEEDED, OR OTHERWISE STABILIZED TO PREVENT EROSION.
5. UPON COMPLETION OF CONSTRUCTION AND ESTABLISHMENT OF PERMANENT GROUND COVER, CONTRACTOR SHALL REMOVE AND DISPOSE OF EROSION CONTROL MEASURES AND CLEAN SEDIMENT AND DEBRIS FROM ENTIRE DRAINAGE SYSTEMS.
6. AREAS REMAINING UNSTABILIZED FOR A PERIOD OF MORE THAN 30 DAYS SHALL BE TEMPORARILY SEEDED AND MULCHED. STRAW MULCH SHALL BE APPLIED AT A MINIMUM RATE OF 1-1/2 TONS/ACRE.
7. PERMANENT SEEDING SHALL OCCUR BETWEEN APRIL 1 AND JUNE 1, AND/OR BETWEEN AUGUST 15 AND OCTOBER 15. ALL SEEDING FROM SEPTEMBER 15 SHALL BE STRAW MULCHED.
8. DUST SHALL BE CONTROLLED THROUGH THE USE OF WATER.
9. SOILS TO BE STOCKPILED FOR A PERIOD OF MORE THAN 30 DAYS SHALL BE TEMPORARILY SEEDED AND MULCHED. CONTRACTOR SHALL INSTALL SILT FENCING ALONG DOWNHILL SIDE OF STOCKPILES.
10. CONTRACTOR SHALL PROVIDE TEMPORARY SEDIMENTATION BASINS TO CONTROL SEDIMENTATION AND STORMWATER RUNOFF DURING THE CONSTRUCTION PERIOD. THE CONTRACTOR SHALL SUBMIT PROPOSED BASIN LOCATIONS, DESIGNS, ETC. TO THE ENGINEER FOR REVIEW PRIOR TO CONSTRUCTION. TEMPORARY SEDIMENTATION BASINS SHALL MEET NHDES REQUIREMENTS.
11. CONTRACTOR SHALL PROVIDE NECESSARY EROSION CONTROL MEASURES TO INSURE THAT SURFACE WATER RUN-OFF FROM UNSTABILIZED AREAS DOES NOT CARRY SILT, SEDIMENT, AND OTHER DEBRIS OUTSIDE OF THE LIMITS OF WORK.
12. AN AREA SHALL BE CONSIDERED STABLE IF ONE OF THE FOLLOWING HAS OCCURRED:
 - A. BASE COURSE GRAVELS HAVE BEEN INSTALLED IN AREAS TO BE PAVED;
 - B. A MINIMUM OF 85% VEGETATED GROWTH HAS BEEN ESTABLISHED;
 - C. A MINIMUM OF 3-INCHES OF NON-EROSIVE MATERIAL, SUCH AS STONE OR RIPRAP, HAS BEEN INSTALLED;
 - D. EROSION CONTROL BLANKETS HAVE BEEN PROPERLY INSTALLED.
13. THE SMALLEST PRACTICAL AREA SHALL BE DISTURBED DURING CONSTRUCTION, BUT AT NO TIME SHALL THE TOTAL UNSTABILIZED DISTURBED AREA ON-SITE BE GREATER THAN (5) FIVE ACRES.
14. ALL DITCHES, SWALES, AND DRAINAGE BASINS SHALL BE STABILIZED PRIOR TO DIRECTING RUNOFF TO THEM.
15. ALL ROADWAYS AND PARKING LOTS SHALL BE STABILIZED WITHIN 72 HOURS OF ACHIEVING FINISHED GRADE.
16. ALL CUT AND FILL SLOPES SHALL BE LOAMED AND SEEDED WITHIN 72 HOURS OF ACHIEVING FINISHED GRADE.
17. ALL PERMANENT AND TEMPORARY SEEDING SHALL BE AS FOLLOWS (UNLESS OTHERWISE NOTED):


PERMANENT SEEDING	PROPORTION	GERMINATION MINIMUM	PURITY MINIMUM
LAWNS:			
CREeping RED FESCUE	50%	85%	95%
KENTUCKY BLUEGRASS	40%	85%	90%
MANHATTAN PERENNIAL RYE	10%	90%	95%
TEMPORARY SEEDING*	% WEIGHT	GERMINATION MINIMUM	
WINTER RYE	80% MIN.	85%	
RED FESCUE (CREeping)	4% MIN.	80%	
PERENNIAL RYE GRASS	3% MIN.	90%	
RED CLOVER	3% MIN.	90%	
OTHER CROP GRASS	0.5% MAX.		
NOXIOUS WEED SEED	0.5% MAX.		
INERT MATTER	1.0% MAX.		

* TEMPORARY SEED FOR LAWNS SHALL ONLY BE PLANTED WHEN PERMANENT GRASSES CANNOT BE PLANTED DUE TO THE GROWING SEASON.

18. EROSION CONTROL BLANKETS SHALL BE INSTALLED ON ALL SLOPES THAT ARE STEEPER THAN 3-FT HORIZONTAL AND 1-FT VERTICAL (3:1). EROSION CONTROL BLANKETS SHALL BE NORTH AMERICAN GREEN SC150BN, OR APPROVED EQUAL.
19. THE CONTRACTOR SHALL PREVENT TRACKING OR FLOWING OF SEDIMENT ONTO PUBLIC RIGHTS-OF-WAY. THIS MAY REQUIRE PERIODIC TOP DRESSING WITH ADDITIONAL STONE AS CONDITIONS DEMAND AND REPAIR OR CLEANOUT OF ANY MEASURES USED TO TRAP SEDIMENT. ALL SEDIMENT SPILLED, DROPPED, WASHED OR TRACKED ONTO PUBLIC RIGHTS-OF-WAY MUST BE REMOVED IMMEDIATELY. BERM SHALL BE PERMITTED. PERIODIC INSPECTION AND MAINTENANCE SHALL BE PROVIDED AS NEEDED.

Winter Construction

1. ALL PROPOSED VEGETATED AREAS WHICH DO NOT EXHIBIT A MINIMUM OF 85% VEGETATIVE GROWTH BY OCTOBER 15TH, OR WHICH ARE DISTURBED AFTER OCTOBER 15TH, SHALL BE STABILIZED. STABILIZATION METHODS SHALL INCLUDE SEEDING AND INSTALLING EROSION CONTROL BLANKETS ON SLOPES GREATER THAN 3:1, AND SEEDING AND PLACING 3 TO 4 TONS OF MULCH PER ACRE, SECURED WITH ANCHORED NETTING, ELSEWHERE. THE INSTALLATION OF EROSION CONTROL BLANKETS OR MULCH AND NETTING SHALL NOT OCCUR OVER ACCUMULATED SNOW OR FROZEN GROUND AND SHALL BE COMPLETED IN ADVANCE OF THAW OR SPRING MELT EVENTS.
2. ALL DITCHES OR SWALES WHICH DO NOT EXHIBIT A MINIMUM OF 85% VEGETATIVE GROWTH BY OCTOBER 15TH, OR WHICH ARE DISTURBED AFTER OCTOBER 15TH, SHALL BE TEMPORARILY STABILIZED WITH STONE OR EROSION CONTROL BLANKETS APPROPRIATE FOR THE DESIGN FLOW CONDITIONS.
3. AFTER OCTOBER 15TH, INCOMPLETE ROAD OR PARKING SURFACES, WHERE WORK HAS STOPPED FOR THE WINTER SEASON, SHALL BE PROTECTED WITH A MINIMUM OF 3 INCHES OF CRUSHED GRAVEL (NHDOT 304.3).


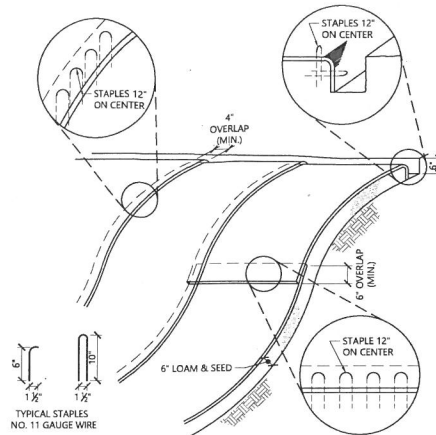


NOTES

1. BEGIN AT THE TOP OF BLANKET INSTALLATION AREA BY ANCHORING BLANKET IN A 6" DEEP TRENCH BACKFILL AND COMPACT TRENCH AFTER STAPLING.
2. ROLL THE BLANKET DOWN THE SWALE IN THE DIRECTION OF THE WATER FLOW.
3. THE EDGES OF BLANKETS MUST BE STAPLED WITH APPROX. 4 INCH OVERLAP WHERE 2 OR MORE STRIP WIDTHS ARE REQUIRED.
4. WHEN BLANKETS MUST BE SPICED DOWN THE SWALE, PLACE UPPER BLANKET END OVER LOWER END WITH 6 INCH (MIN.) OVERLAP AND STAPLE BOTH TOGETHER.
5. METHOD OF INSTALLATION SHALL BE AS PER MANUFACTURER'S RECOMMENDATIONS.
6. EROSION CONTROL BLANKETS SHALL BE USED IN ALL AREAS WHERE SLOPES EXCEED 3:1.

Erosion Control Blanket Slope Installation

N.T.S. Source: VHB 1/16 LD_680

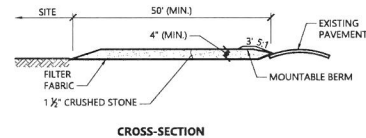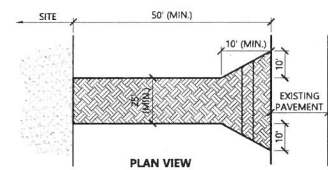


NOTES

1. EXIT WIDTH SHALL BE A TWENTY-FIVE (25) FOOT MINIMUM, BUT NOT LESS THAN THE FULL WIDTH AT POINTS WHERE INGRESS OR EGRESS OCCURS.
2. THE EXIT SHALL BE MAINTAINED IN A CONDITION WHICH SHALL PREVENT TRACKING OR FLOWING OF SEDIMENT ONTO PUBLIC RIGHTS-OF-WAY. THIS MAY REQUIRE PERIODIC TOP DRESSING WITH ADDITIONAL STONE AS CONDITIONS DEMAND AND REPAIR OR CLEANOUT OF ANY MEASURES USED TO TRAP SEDIMENT. ALL SEDIMENT SPILLED, DROPPED, WASHED OR TRACKED ONTO PUBLIC RIGHTS-OF-WAY MUST BE REMOVED IMMEDIATELY. BERM SHALL BE PERMITTED. PERIODIC INSPECTION AND MAINTENANCE SHALL BE PROVIDED AS NEEDED.
3. STABILIZED CONSTRUCTION EXIT SHALL BE REMOVED PRIOR TO FINAL FINISH MATERIALS BEING INSTALLED.


Stabilized Construction Exit

N.T.S. Source: VHB 1/16 LD_682

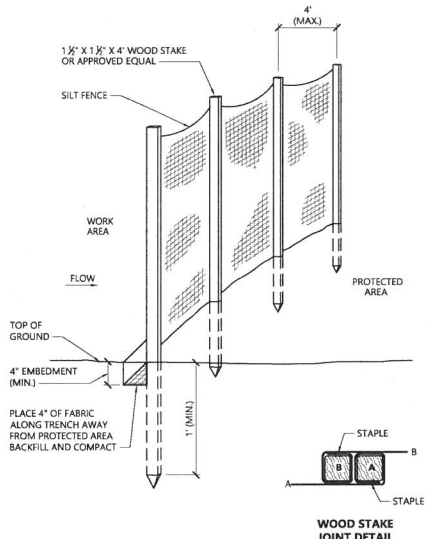

Silt Fence Barrier

N.T.S. Source: VHB 1/16 LD_650


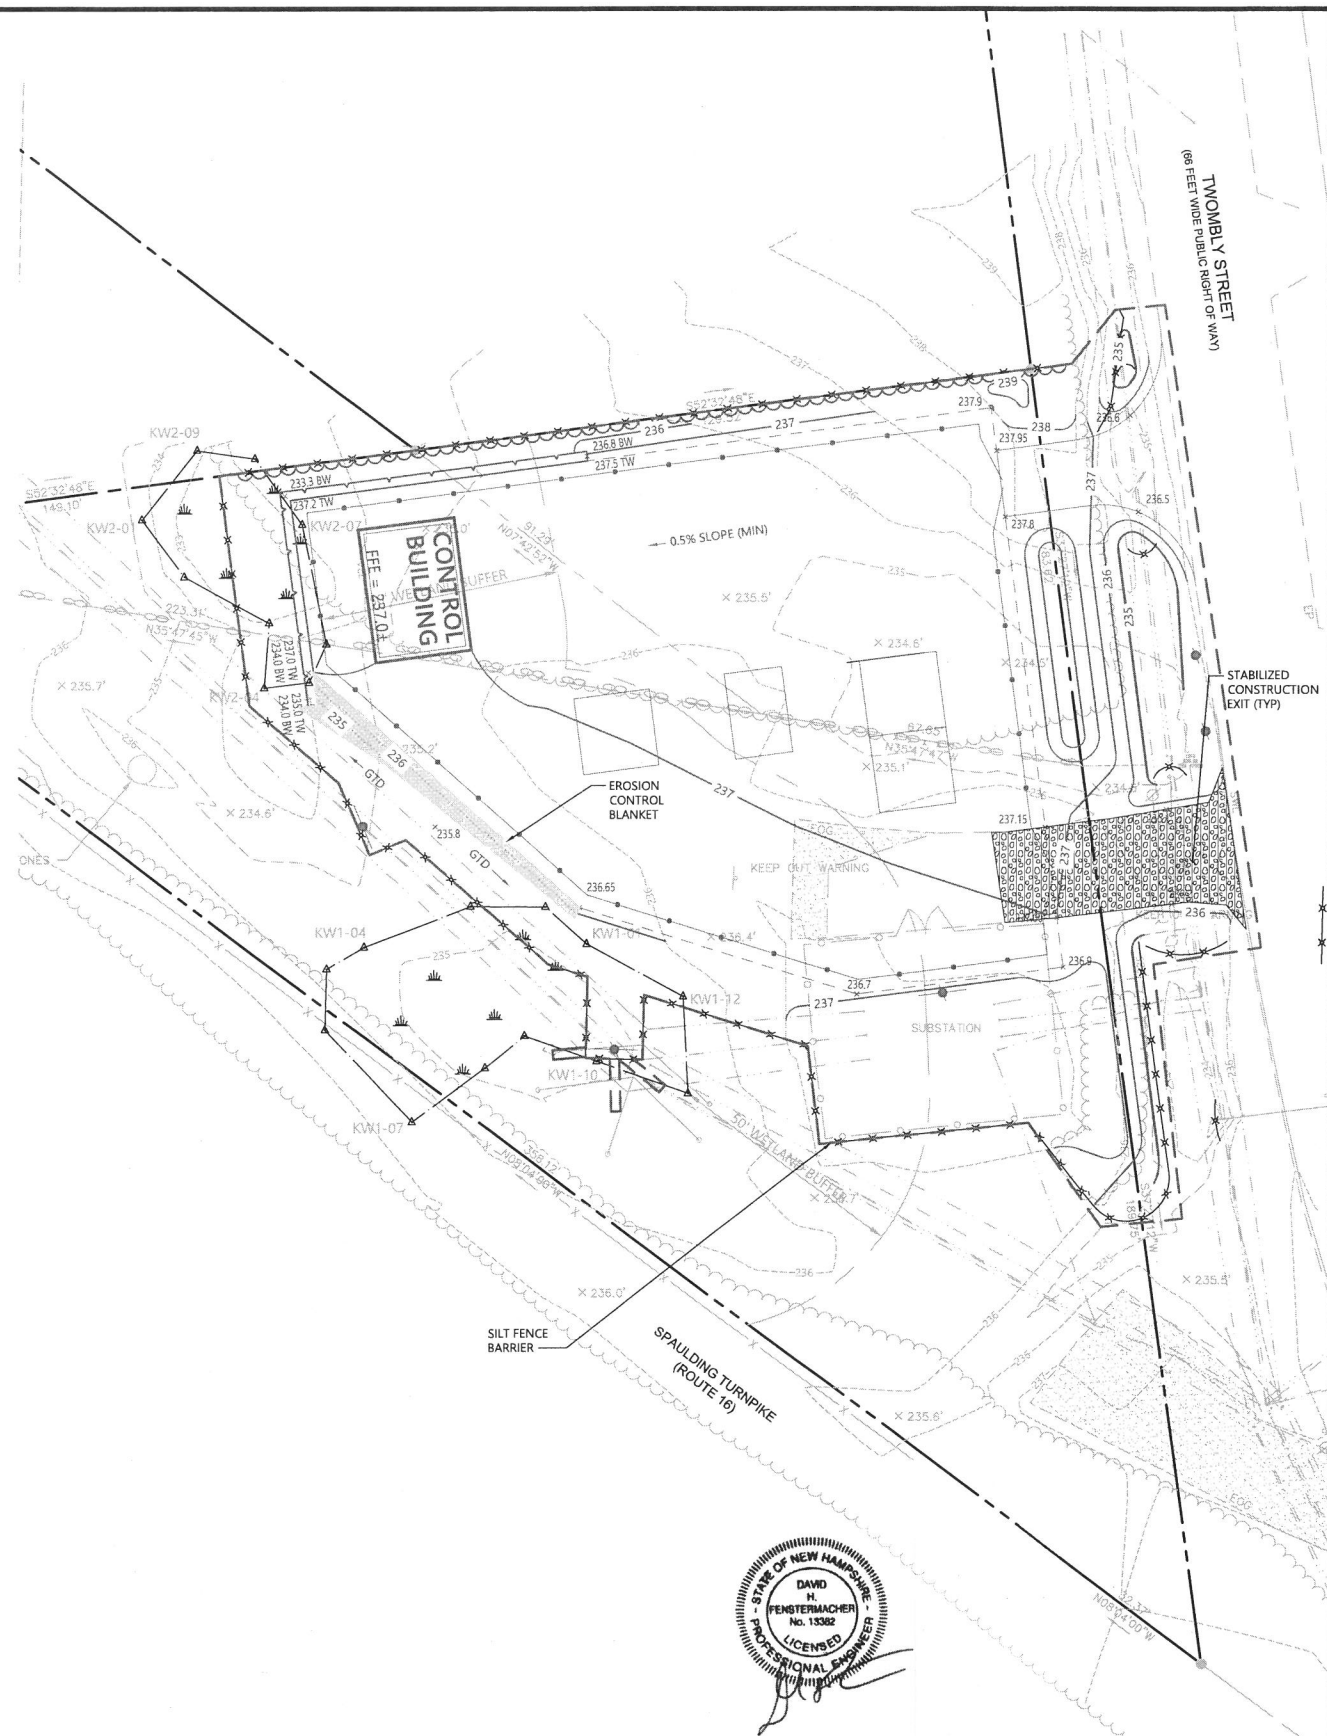


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Bedford, New Hampshire 03110
603.391.3900 • FAX 603.518.7495






0 10 20 40 Feet

CONTRACT SERVICES	REV						DESCRIPTION						ENG/PE#						DATE						DRN						CHKD						APPR																																																																																		
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EVERSOURCE ENERGY																								EROSION AND SEDIMENT CONTROL PLAN																								TWOMBLY ST. S/S ROCHESTER, NH																								0																																															
DAVID H. FENSTERMACHER No. 13382 LICENSED PROFESSIONAL ENGINEER																								SCALE: 1"=20'																								FILE: 14523.09-ER.DWG																								DRAWING NO.																																															
DRAWN: MEO/VHB																								ENGINEER: MEO/VHB																								CHECKED: MJV/VHB																								APPROVED: DHF/VHB																								DATE: Aug 7, 2019																							

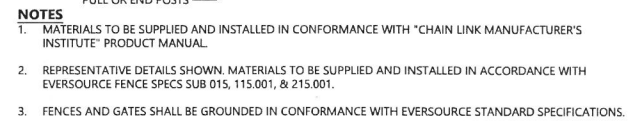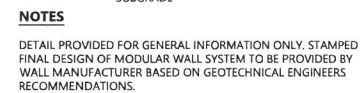


8' Chain Link Fence 1/16
 N.T.S. Source: VHB REV LD 480

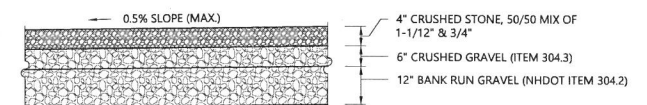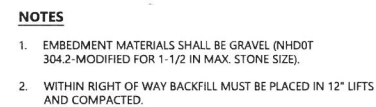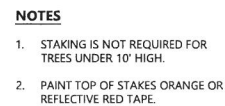


Gravel Substation Pad - Typical Section

N.T.S. Source: VHB

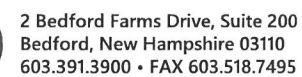


CONTRACT SERVICES								<div>EVERSOURCE ENERGY</div>		0	
										DRAWN MEO/VHB	
								ENGINEER MEO/VHB			
								CHECKED M.J.V./VHB			
								APPROVED DHF/VHB			
								DATE Aug 7, 2019			
								DRAWING NO.			

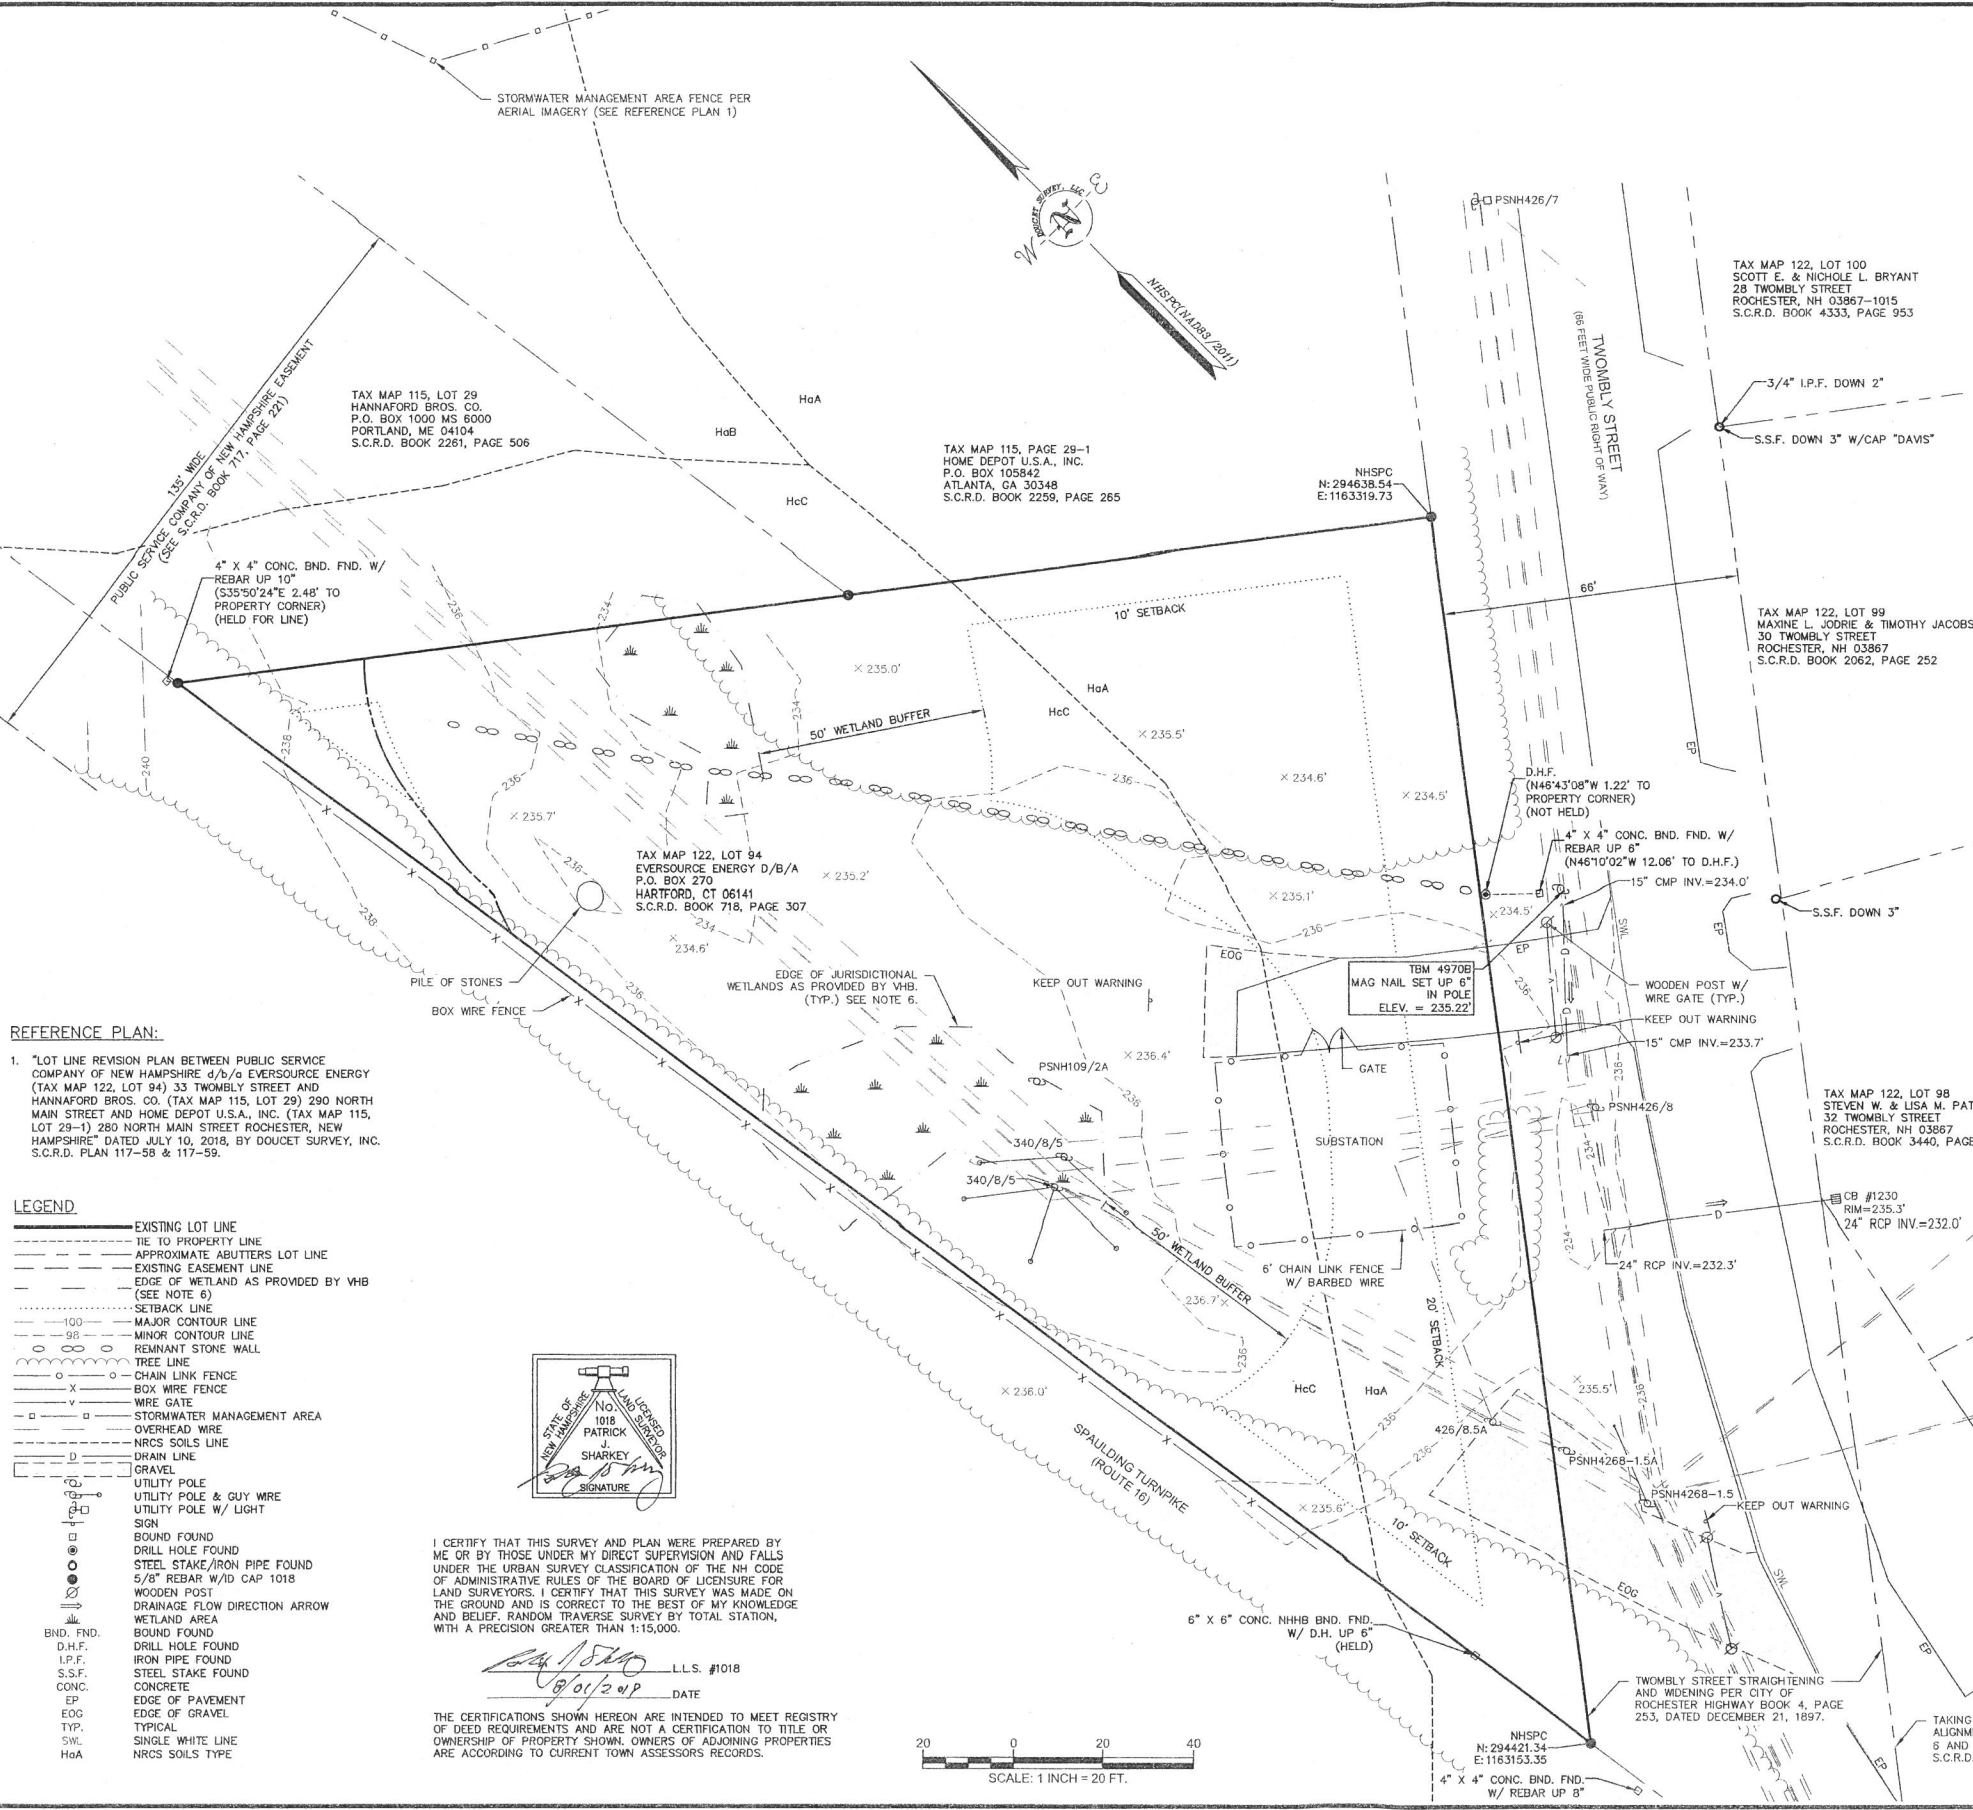

NOTES:

- REFERENCE: TAX MAP 122, LOT 94
- TOTAL EXISTING PARCEL AREA:
38,115 Sq. Ft. OR 0.875 Acres
- OWNER OF RECORD:
PUBLIC SERVICE COMPANY OF NEW HAMPSHIRE
d/b/a EVERSOURCE ENERGY
P.O. BOX 270
HARTFORD, CT 06141-0270
S.C.R.D. BOOK 718, PAGE 307
S.C.R.D. BOOK 4823, PAGE 903
S.C.R.D. BOOK 4623, PAGE 907
- ZONE: HC
DIMENSIONAL REQUIREMENTS:
MIN. LOT AREA 20,000 sq.ft.
MIN. FRONTAGE 100 ft.
MIN. FRONT SETBACK 20 ft.
MIN. SIDE SETBACK 10 ft.
MIN. REAR SETBACK 25 ft.
WETLAND BUFFER 50 ft.
- ZONING INFORMATION LISTED HEREON IS BASED ON THE CITY OF ROCHESTER ZONING ORDINANCE AS CERTIFIED BY THE CODES AND ORDINANCES COMMITTEE DATED AUGUST 7, 2014, AS AVAILABLE ON THE CITY WEBSITE ON JUNE 29, 2018. ADDITIONAL REGULATIONS APPLY, AND REFERENCE IS HEREBY MADE TO THE EFFECTIVE ZONING ORDINANCE. THE LAND OWNER IS RESPONSIBLE FOR COMPLYING WITH ALL APPLICABLE MUNICIPAL, STATE AND FEDERAL REGULATIONS.
- FIELD SURVEY PERFORMED BY S.N.F. & J.P.E. DURING APRIL 2017 AND BY S.N.F. & L.P.S. DURING JUNE 2018 USING A TRIMBLE 56 TOTAL STATION WITH A TRIMBLE TSC3 DATA COLLECTOR, A SOKKIA B21 AUTO LEVEL, AND A TRIMBLE R8 SURVEY GRADE GPS UNIT WITH A TRIMBLE TSC3 DATA COLLECTOR. TRAVERSE ADJUSTMENT BASED ON LEAST SQUARE ANALYSIS.
- WETLAND LINES SHOWN HEREON NOT FIELD LOCATED BY DOUCET SURVEY. THEY WERE PROVIDED BY VHB WITH THE FOLLOWING NOTES:
 - VHB SENIOR SCIENTIST, KRISTOPHER WILKES (NH CWS #288), REVIEWED AND MODIFIED PREVIOUSLY DELINEATED WETLAND BOUNDARIES ON MAY 17, 2019.
 - THE PREVIOUS DELINEATION WAS PERFORMED BY GZA GEOTECHNICAL, INC. IN 2018.
 - WETLAND DELINEATION CONFORMS TO THE STANDARDS IN THE 1987 U.S. ARMY CORPS OF ENGINEERS WETLAND DELINEATION MANUAL AND THE REGIONAL SUPPLEMENT TO THE U.S. ARMY CORPS OF ENGINEERS WETLAND DELINEATION MANUAL: NORTHEASTERN AND NORTHEAST REGION, VERSION 2.0 (JANUARY 2012) AND THE NH WETLAND RULES (ENV-WT 100-900).
 - DOMINANT WETLAND VEGETATION WAS ASSESSED USING THE NORTHEASTERN REGIONAL WETLAND PLANT LIST PUBLISHED BY THE U.S. ARMY CORPS OF ENGINEERS.
 - HYDRIC SOILS WERE DETERMINED USING THE FIELD INDICATORS FOR IDENTIFYING HYDRIC SOILS IN THE UNITED STATES, VERSION 8, PUBLISHED BY THE NATURAL RESOURCES CONSERVATION SERVICE, AND THE FIELD INDICATORS FOR IDENTIFYING HYDRIC SOILS IN NEW ENGLAND, VERSION 4 (JUNE 2017), PUBLISHED BY THE NEW ENGLAND INTERSTATE WATER POLLUTION CONTROL COMMISSION.
 - WETLAND CLASSIFICATIONS FOLLOW THE USFWS METHODOLOGY CLASSIFICATION OF WETLANDS AND DEEPWATER HABITATS OF THE UNITED STATES (CONARD ET AL. 1979, REVISED 1985).
 - WETLAND PLUGS WERE LOCATED USING GLOBAL POSITIONING SYSTEMS (GPS) TECHNOLOGY CAPABLE OF SUB-METER ACCURACY.
- FLOOD HAZARD ZONE: "X", PER FIRM MAP #33017C02110, DATED MAY 17, 2005.
- HORIZONTAL DATUM BASED ON NEW HAMPSHIRE STATE PLANE (2800) NAD83(2011) DERIVED FROM REDUNDANT GPS OBSERVATIONS UTILIZING THE KEYNET GPS VRS NETWORK.
- VERTICAL DATUM IS BASED ON NAVD88 PER NHDOT DISK "389 6770" (PUBLISHED ELEVATION = 259.45').
- PROPER FIELD PROCEDURES WERE FOLLOWED IN ORDER TO GENERATE CONTOURS AT 2' INTERVALS. ANY MODIFICATION OF THIS INTERVAL WILL DIMINISH THE INTEGRITY OF THE DATA, AND DOUCET SURVEY, LLC WILL NOT BE RESPONSIBLE FOR ANY SUCH ALTERATION PERFORMED BY THE USER.
- UNDERGROUND UTILITIES SHOWN HEREON ARE BASED ON OBSERVABLE PHYSICAL EVIDENCE AND PAINT MARKS FOUND ON-SITE.
- THE ACCURACY OF MEASURED UTILITY INVERTS AND PIPE SIZES/TYPES IS SUBJECT TO NUMEROUS FIELD CONDITIONS, INCLUDING: THE ABILITY TO MAKE VISUAL OBSERVATIONS, DIRECT ACCESS TO THE VARIOUS ELEMENTS, MANHOLE CONFIGURATION, ETC.
- ALL ELECTRIC, GAS, TEL. WATER, SEWER AND DRAIN SERVICES ARE SHOWN IN SCHEMATIC FASHION, THEIR LOCATIONS ARE NOT PRECISE OR NECESSARILY ACCURATE. NO WORK WHATSOEVER SHALL BE UNDERTAKEN ON THIS SITE USING THIS PLAN TO LOCATE THE ABOVE SERVICES. CONSULT WITH THE PROPER AUTHORITIES CONCERNED WITH THE SUBJECT SERVICE LOCATIONS FOR INFORMATION REGARDING SUCH. CALL DIG-SAFE AT 1-888-DIG-SAFE.
- THIS PLAN DEPICTS SITE CONDITIONS BASED ON FIELD WORK PERFORMED BY DOUCET SURVEY, LLC IN 2019. THE SOLE INTENT OF THIS PLAN IS TO UPDATE THE WETLAND LINES AS LOCATED AND PROVIDED BY VHB. NO SITE VERIFICATION WAS PERFORMED BY DOUCET SURVEY, LLC IN 2019.

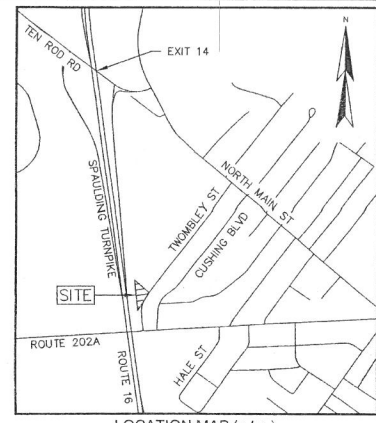


REFERENCE PLAN:

- "LOT LINE REVISION PLAN BETWEEN PUBLIC SERVICE COMPANY OF NEW HAMPSHIRE d/b/a EVERSOURCE ENERGY (TAX MAP 122, LOT 94) 33 TWOMBLY STREET AND HANNAFORD BROS. CO. (TAX MAP 115, LOT 29) 280 NORTH MAIN STREET AND HOME DEPOT U.S.A., INC. (TAX MAP 115, LOT 29-1) 280 NORTH MAIN STREET ROCHESTER, NEW HAMPSHIRE" DATED JULY 10, 2018, BY DOUCET SURVEY, INC. S.C.R.D. PLAN 117-58 & 117-59.

LEGEND


- EXISTING LOT LINE
- TIE TO PROPERTY LINE
- APPROXIMATE ADJUTERS LOT LINE
- EXISTING EASEMENT LINE
- EDGE OF WETLAND AS PROVIDED BY VHB (SEE NOTE 6)
- SETBACK LINE
- MAJOR CONTOUR LINE
- MINOR CONTOUR LINE
- REMANENT STONE WALL
- TREE LINE
- CHAIN LINK FENCE
- BOX WIRE FENCE
- WIRE GATE
- STORMWATER MANAGEMENT AREA
- OVERHEAD WIRE
- NRCS SOILS LINE
- DRAIN LINE
- GRAVEL
- UTILITY POLE
- UTILITY POLE & GUY WIRE
- UTILITY POLE W/ LIGHT
- SIGN
- BOUND FOUND
- DRILL HOLE FOUND
- STEEL STAKE/IRON PIPE FOUND
- 5/8" REBAR W/D CAP 1018
- WOODEN POST
- DRAINAGE FLOW DIRECTION ARROW
- WETLAND AREA
- BOUND FOUND
- DRILL HOLE FOUND
- IRON PIPE FOUND
- STEEL STAKE FOUND
- CONCRETE
- EDGE OF PAVEMENT
- EDGE OF GRAVEL
- TYPICAL
- SWL
- HQA

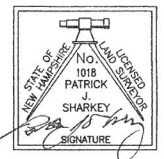

I CERTIFY THAT THIS SURVEY AND PLAN WERE PREPARED BY ME OR BY THOSE UNDER MY DIRECT SUPERVISION AND FALLS UNDER THE URBAN SURVEY CLASSIFICATION OF THE NH CODE OF ADMINISTRATIVE RULES OF THE BOARD OF LICENSURE FOR LAND SURVEYORS. I CERTIFY THAT THIS SURVEY WAS MADE ON THE GROUND AND IS CORRECT TO THE BEST OF MY KNOWLEDGE AND BELIEF. RANDOM TRAVERSE SURVEY BY TOTAL STATION, WITH A PRECISION GREATER THAN 1:15,000.

Patrick J. Sharkey L.L.S. #1018
8/01/2019 DATE

THE CERTIFICATIONS SHOWN HEREON ARE INTENDED TO MEET REGISTRY OF DEED REQUIREMENTS AND ARE NOT A CERTIFICATION TO TITLE OR OWNERSHIP OF PROPERTY SHOWN. OWNERS OF ADJOINING PROPERTIES ARE ACCORDING TO CURRENT TOWN ASSESSORS RECORDS.

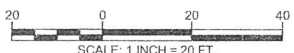


EXISTING CONDITIONS PLAN
FOR
PUBLIC SERVICE COMPANY
OF NEW HAMPSHIRE
d/b/a EVERSOURCE ENERGY
(TAX MAP 122, LOT 94)
33 TWOMBLY STREET
ROCHESTER, NEW HAMPSHIRE


NO.	DATE	DESCRIPTION	BY
1	08/01/2019	UPDATED WETLANDS PROVIDED BY VHB	PJS

DRAWN BY:	P.J.S.	DATE:	AUGUST 1, 2019
CHECKED BY:	S.V.M.	DRAWING NO.:	4970C (EC)
JOB NO.:	4970	SHEET	1 OF 1


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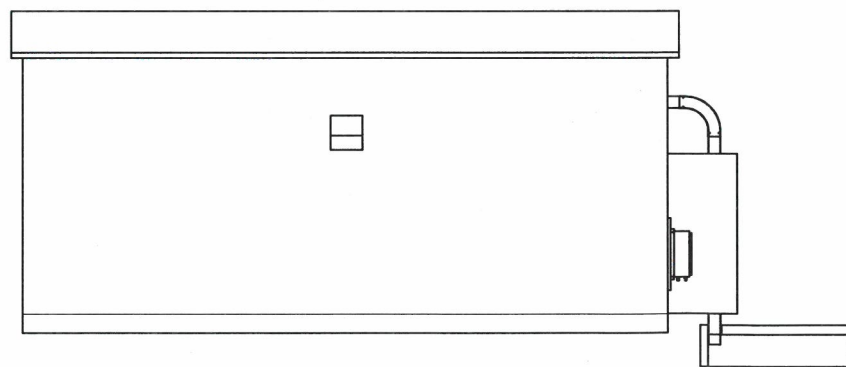
SIDE ELEVATION 1

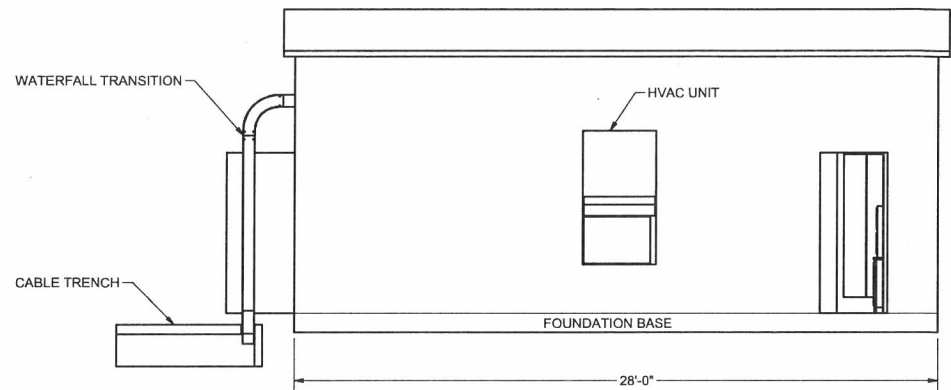


END ELEVATION 1

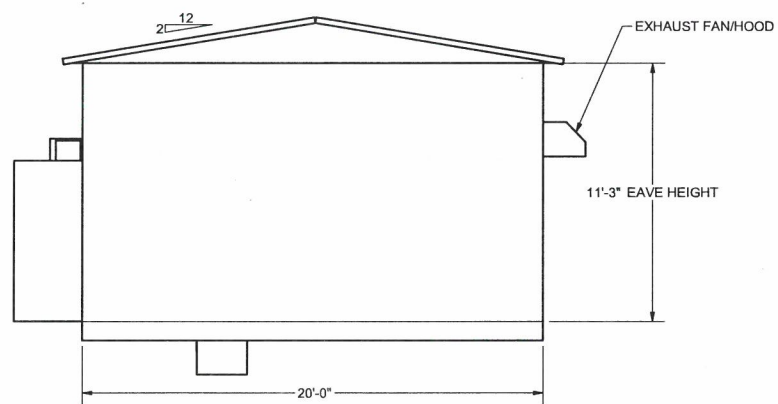

END ELEVATION 2

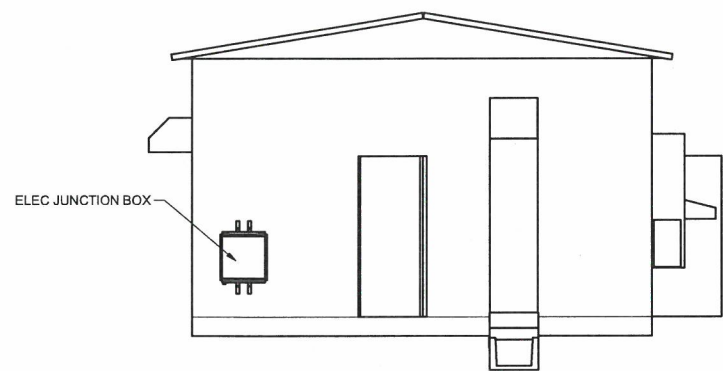

SIDE ELEVATION 2

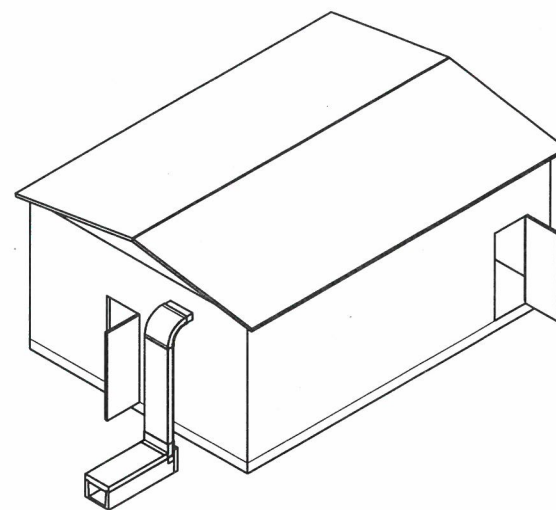

CONTRACT SERVICES																																																																																																																																																																																																																																																																																																																																																																																																																																																																																																																																																																																																																																																																																																																																																																																																																																																																																																																																																																																																																																																																																																																																																																																																																																																																																																																																																																																																																																																																																																												
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