



# NONRESIDENTIAL SITE PLAN APPLICATION

# City of Rochester, New Hampshire

	[office use only. Check #	Amount \$_	Date paid]
Date: <u>April 10, 2018</u>			No:XUnclear: plication as soon as possible.
Property information			
Tax map #: <u>262/267</u> ; Lot #	e('s): 22 & 23 / 2; Zor	ning district: Recy	cling Industrial/Agricultural
Property address/location:	36 Rochester Neck I	Road	
Name of project (if applicab	le): <u>Rochester Haulir</u>	ng Company Facil	ity
Size of site: 10.3 acres; over	lay zoning district(s)?	No	
Property owner			
Name (include name of indi	vidual): <u>Waste Mana</u>	gement of New Ha	ampshire, Inc.
Mailing address: <u>30 Roche</u>	ster Neck Road, Roc	hester, NH	
Telephone #: (603) 330-2	164	_Email:_bmagnus	son@wm.com
Applicant/developer (if Name (include name of indimediating address:	vidual):		
Telephone #:			
Mailing address: Sanborn, F	lead & Associates, In	c., 20 Foundry Str	eet, Concord, NH 0330
Telephone #: (603) 415-613	8	_Fax #: <u>(603) 415</u>	-1919
Email address: esteinhause	r@sanbornhead.com	Professional lic	cense #: <u>11494</u>
Proposed activity (check New building(s): X  Addition(s) onto existing building	Site development (oth	emolition: X	
	Page 1 (of 4	pages)	

Macintosh HD:Users:jaredrose:Desktop:Site Plan, NonResidential Application Updated 4/11/2013

(Continued Nonresidential Site Plan Application Tax Map: 262/267 Lot:22 & 23/2 Zone RI/AG)
Describe proposed activity/use: Relocation of the Rochester Hauling Facility that requires construction of a prefabricated metal building, associated parking areas, and stormwater management features. See narrative included in the Application.
Describe existing conditions/use (vacant land?): Existing Landfill Maintenance Garage
Utility information
City water? yes X no; How far is City water from the site? 435'
City sewer? yes X no ; How far is City sewer from the site? 340'
If City water, what are the estimated total daily needs? 4,600 gallons per day
If City water, is it proposed for anything other than domestic purposes? yes X no
If City sewer, do you plan to discharge anything other than domestic waste? yes X no
Where will stormwater be discharged? <u>Stormwater is fully managed on site through a closed drainage system and stormwater basin. Ultimately, stormwater is discharged to wetland areas.</u>
Building information
Type of building(s): Pre-fabricated metal building
Building height: 35 feet Finished floor elevation: 276.0 Refer to Drawings
# parking spaces: existing: 21 total proposed: 157; Are there pertinent covenants? No Number of cubic yards of earth being removed from the site 0 CY  Number of existing employees: 83; number of proposed employees total: 142  Check any that are proposed: variance X ; special exception; conditional use  Wetlands: Is any fill proposed? Yes; area to be filled: 0.01 ac; buffer impact? No
Proposed post-development disposition of site (should total 100%)

Proposed post-development disposition of site (should total 100%)					
Square footage % over					
Building footprint(s) – give for each building	100,635	0.4			
Parking and vehicle circulation	1,176,807	4.5			
Planted/landscaped areas (excluding drainage)	5,012,423	19.3			
Natural/undisturbed areas (excluding wetlands)	7,379,920	28.4			
Wetlands	3,157,936	12.1			
Other – drainage structures, outside storage, etc.	9,171,065	35.3			

Page 2 (of 4 pages)

Macintosh HD:Users:jaredrose:Desktop:Site Plan, NonResidential Application

Updated 4/11/2013

Tal	hle	a /	Va	to	c
l di	<i>916</i>	<i>71</i>	wo	ıe	S

- Wetland area should be considered approximate. WMNH owns over 1,200 acres of land and not all wetlands have been surveyed by a wetlands scientist. Within the project area, wetland areas are represented by a compilation of information determined using existing aerial photography, soils information, USFWS National Wetland Inventory Maps, and delineations conducted by Barry H. Keith, NH CWS #087.
- 2. Planted/landscaped areas within the project parcel areas represent the sum of the parcel areas subtracted by building, parking/vehicle circulation, natural/undisturbed, wetland, and other areas.

building, parking/vehicle circulation, natural/undisturbed, wetland, and other areas.
3. The TLR-III limit of waste containment area is considered "other."
(Continued <u>Nonresidential Site Plan Application</u> Tax Map: <u>262/267</u> Lot: <u>22 &amp; 23/2</u> Zone <u>RI/AG</u> )
Comments
Please feel free to add any comments, additional information, or requests for waivers here:
Refer to the narrative for wetland impacts.
Submission of application
This application must be signed by the property owner, applicant/developer (if different from property owner), and/or the agent.
I(we) hereby submit this Site Plan application to the City of Rochester Planning Board pursuant to the City of Rochester Site Plan Regulations and attest that to the best of my
knowledge all of the information on this application form and in the accompanying application
materials and documentation is true and accurate. As applicant/developer (if different from
property owner)/as agent, I attest that I am duly authorized to act in this capacity.
Signature of property owner:
Date: 4/10/18
Signature of applicant/developer:
Date:
Signature of agent:
Date:

Page3 (of 4 pages)

Macintosh HD:Users:jaredrose:Desktop:Site Plan, NonResidential Application

Updated 4/11/2013

## Authorization to enter subject property

I hereby authorize members of the Rochester Planning Board, Zoning Board of Adjustment, Conservation Commission, Planning Department, and other pertinent City departments, boards and agencies to enter my property for the purpose of evaluating this application including performing any appropriate inspections during the application phase, review phase, post-approval phase, construction phase, and occupancy phase. This authorization applies specifically to those particular individuals legitimately involved in evaluating, reviewing, or inspecting this specific application/project. It is understood that these individuals must use all reasonable care, courtesy, and diligence when entering the property.

Signature of property owner:	100	13	, Mu	gy V	w		
			Date:		4/10	/18	



**TURNKEY RECYCLING & ENVIRONMENTAL ENTERPRISI** 

April 10, 2018

30 Rochester Neck Road P.O. Box 7065 Rochester, NH 03839 (603) 330-2197 (603) 330-2130 Fax

Mr. James B. Campbell, Director Planning and Development Department City of Rochester 31 Wakefield Street Rochester, New Hampshire 03867

Re: Letter of Intent – Application for Site Plan Approval

Rochester Hauling Company Facility

Turnkey Recycling and Environmental Enterprise

Rochester, New Hampshire

Dear Mr. Campbell:

Waste Management of New Hampshire, Inc. (WMNH) is proposing to relocate the Rochester Hauling Company Facility (RHCF) to 36 Rochester Neck Road. At present the RHCF is located near the southeastern corner of the TREE Facility on the south side of Rochester Neck Road at 189 Turnkey Way. The current RHCF location occupies an area designated for future landfill use (i.e. TLR-III Refuse Disposal Facility – South Area, hereafter referred to as the TLR-III South Area). Earthwork associated with the initial TLR-III South Area construction is anticipated to begin in 2019 necessitating the move of the existing RHCF.

The following information is provided for this Site Plan Review application.

**Applicant's Name:** Waste Management of New Hampshire, Inc. (property owner)

**Property Locations:** Landfill Maintenance Garage:

36 Rochester Neck Road, Parcel 262-23

WMNH Office:

30 Rochester Neck Road, Parcel 262-22

TLR-III Facility:

90 Rochester Neck Road, Parcel 267-2

**Size and Use:** Site development on Parcel 262-23 will involve construction of a pre-

engineered metal building. The building will include approximately 19,000 square feet (ft²) for vehicle maintenance and 7,200 ft² of office space. The existing paved driveway will be relocated to the east, and additional paved and gravel parking areas are proposed. The existing training facility building will be demolished to allow for the proposed

From everyday collection to environmental protection, Think Green? Think Waste Management.

D Printed on 10% post-consumer recycled poper.

April	10,	2018
Lette	r of	Inten

Page 2

site development. Site development will extend limitedly onto adjacent parcels 262-22 and 267-2.

The entire area of development will disturb about 10.3 acres.

#### **Proposed Use:**

WMNH is proposing to redevelop the parcel that currently supports the training facility building and the existing heavy equipment maintenance facility to include relocation of the RHCF. The existing heavy equipment maintenance facility will remain unchanged.

#### **Previous Use:**

The parcel is currently used by WMNH as part of its TREE Facility operations. One building (not being modified) is WMNH's heavy equipment maintenance facility. The other building (to be demolished) is used as a training facility.

**Existing Conditions:** As indicated above, the RHCF project development includes parcels that currently support other TREE Facility operations. WMNH owns the properties encumbered by and abutting the parcels. No change in traffic on Rochester Neck Road is anticipated as a result of the development.

#### Resulting **Employees:**

Currently approximately 83 employees staff the Rochester Hauling Company operations, 78 of which work first shift, while the remaining work second shift. The new facility is designed to accommodate approximately 144 employees (132 for first shift (107 truck drivers, 13 office staff, and 12 vehicle maintenance staff), and up to 12 vehicle maintenance staff for second shift) if expansion of this operation is possible in the future.

**Hours of Operation:** Facility operating hours shall be from 6 AM to 6 PM, equipment maintenance continues at the facility indoors with a reduced staff until 12 AM.

#### **Off-street Parking:**

Employee parking and parking spaces for the haul trucks are located near the existing heavy equipment maintenance building and the proposed building.

### **Proposed Site Changes:**

The proposed development involves the following:

- Construction of a pre-engineered metal building. The building will include approximately 19,000 ft<sup>2</sup> for vehicle maintenance and 7,200 ft<sup>2</sup> of office space;
- Construction of a compressed natural gas (CNG) distribution system;
- Construction of paved and gravel parking areas;

April 10, 2018 Letter of Intent

- Relocation of the Rochester Neck Road driveway to the east for commercial use only and construction of a new driveway for personal vehicles and visitor from Taylor Avenue; and
- Construction of stormwater conveyance features.

#### **Property Access:**

Access to the proposed vehicle maintenance building, existing heavy equipment maintenance facility, and proposed hauling company truck parking, will be the relocated driveway proposed to the east of the existing driveway from Rochester Neck Road.

Access to the proposed hauling company office and associated car parking will be gained by construction of a driveway on the southern side of Taylor Avenue.

Please contact me at 330-2140 or <a href="mailto:areichert@wm.com">areichert@wm.com</a> should you require additional information regarding this proposed development.

Sincerely,

WASTE MANAGEMENT OF NEW HAMPSHIRE, INC.

Anne Reichert, P.E.

Construction Project Manager

Enclosures: Nonresidential Site Plan Application

Mailing Labels (2 per abutter, provided separately)

Waiver Requests

22" x 34" Drawings (3 copies, provided separately)

Application Fee (provided separately)

Copies to: Peter Richer, WMNH

Steve Cates, WMNH

Eric Steinhauser, Sanborn Head



April 10, 2018

**TURNKEY RECYCLING & ENVIRONMENTAL ENTERPRISI** 

30 Rochester Neck Road P.O. Box 7065 Rochester, NH 03839 (603) 330-2197 (603) 330-2130 Fax


Mr. James B. Campbell, Director Planning and Development Department City of Rochester 31 Wakefield Street Rochester, New Hampshire 03867


Waivers from Site Plan Regulations

Site Plan Application – Rochester Hauling Company Facility

Turnkey Recycling and Environmental Enterprise

Rochester, New Hampshire

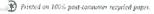

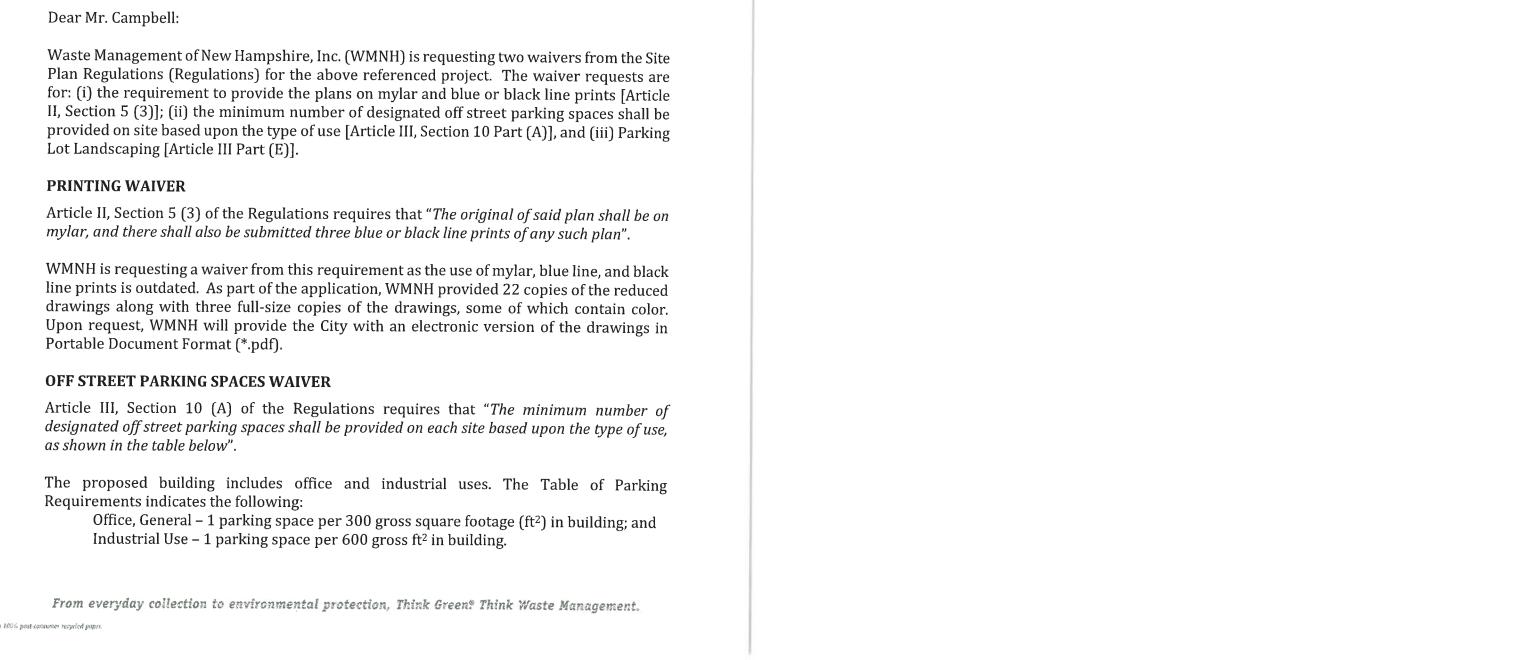

April 10, 2018 Page 2

WMNH is requesting a waiver of 27 parking spaces from this requirement for the parcel as the parking requirement exceeds the proposed uses of the office and vehicle maintenance building and strict adherence to the ordinance would require unnecessary additional land disturbance.

The proposed office space, 7,200 ft², requires a minimum of 24 parking spaces, and the proposed vehicle maintenance building, 19,000 ft², requires a minimum of 32 parking spaces for a total of 56 parking spaces. Please know that the anticipated maximum number of employees in the office is 13 and the maximum number of employees in the vehicle maintenance building is 12 per shift, or a total of 25 parking spaces. Given the type of business, vehicle maintenance staff is limited to the number of refuse hauling trucks that are operated verses manufacturing square footage. Please also note that overflow parking is available at WMNH's Visitor's Center building, which is in walking distance to this new RHCF building.

In addition, the proposed development includes 107 haul truck parking spaces and 107 vehicle parking spaces for the truck driver's personnel vehicles. The proposed development also includes 21 parking spaces for the existing heavy equipment maintenance building and landfill operations staff that currently use the existing parking located within the proposed development area.

The following table summarizes the parking space requirements, anticipated uses, and parking spaces proposed:

Parking Waiver Summary Table				
Description	Minimum # of Available # of Parking Spaces		Waiver Request	
Office	24	20	0.7	
Vehicle Maintenance Facility	32	29	27	
Existing Parking	21	21	Not Applicable	
Truck Driver Parking	107	107	Not Applicable	
Accessible <sup>1</sup>	5	5	Not Applicable	
Wheelchair Accessible <sup>1</sup>	1	1	Not Applicable	
Total	190	163	27	

As such, the proposed development proposes 27 fewer parking spaces than required by strict application of the City's ordinance.

#### PARKING LOT LANDSCAPING APPROACH

The properties where parking lots are proposed are zoned Recycling Industrial, and hence, the parking lot areas are exempt from the Landscaping requirements in accordance with Paragraph (2) of Part (B) General Provision of Article III – Development Standards, Section 5 – Landscaping.

<sup>&</sup>lt;sup>1</sup> The required number of accessible parking spaces is based on the number of proposed car spaces.

April 10, 2018 Page 3

Paragraph (2) of Part (B) General Provision of Article III – Development Standards, Section 5 – Landscaping states: "Properties that are zoned Industrial are exempt from this entire Landscaping section herein. However, applicants in these zones are encouraged to conform with these standards, at their discretion."

WMNH approach to addressing the landscaping requirements of the Regulations is as follows.

- Paragraph (2) of Part (E) Parking Lots of Article III Development Standards, Section 5 requires a vegetative buffer from the public right-of-way. Existing treed buffers are located between the Rochester Neck Road and the proposed development, and between Taylor Avenue, a private road, and the proposed development. WMNH is proposing to maintain these treed buffers.
- Paragraphs (4) and (9) of Part (E) Parking Lots of Article III Development Standards, Section 5 requires trees distributed throughout the parking lot as evenly as practical and that a shade or ornamental tree is within 75 feet of a parking spot. Considering the proposed use of the area and the desire to limit the area of disturbance, including trees in the proposed parking areas is not practical as it would unnecessarily increase the development area. The use of large trees with tall commercial vehicles could create hazards with visibility along with tree and truck damage from passing too close. The benefit of shade from the trees is not achieved given the height of the operating cab in the hauling vehicles and that they are on route and not parked in the parking lot during the heat of the day.
- Paragraph (5) of Part (E) Parking Lots of Article III Development Standards, Section 5 requires a landscaping peninsula at the end of each parking row. For this project, landscaped peninsulas are not proposed at the end of each parking row in the truck parking areas. The open ends of the parking rows within the truck parking areas include the CNG distribution trusses and are not conducive to supporting trees for safety reasons include personnel visibility. Landscaped peninsulas are proposed on the driveway side (northern side) of the vehicle parking area.

We trust that the above information fully addresses the City's need for a waiver request from the printing and off-street parking spaces requirements for this project. Should you require additional information, please contact me at <a href="mailto:areichert@wm.com">areichert@wm.com</a>.

Very truly yours,

WASTE MANAGEMENT OF NEW HAMPSHIRE, INC.

Anne Reichert, P.E.

Construction Project Manager


Copies to: Peter Richer, WMNH

Steve Cates, WMNH Eric Steinhauser, Sanborn Head

# ROCHESTER HAULING COMPANY FACILITY WASTE MANAGEMENT OF NEW HAMPSHIRE, INC. ROCHESTER, NEW HAMPSHIRE

**APRIL 2018** 



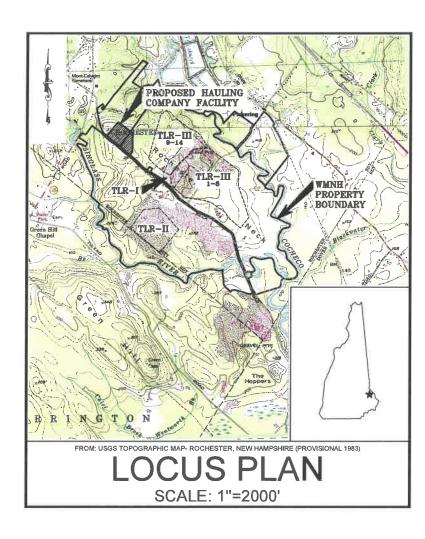

## SHEET INDEX

SHEET NO.	IIILE	SHEET NO.	IIILE
1	NOTES, LEGEND, AND ABBREVIATIONS	15-18	STORMWATER DETAILS
2	OVERALL SITE AND ZONING PLAN	19	FENCE DETAILS
3	EXISTING CONDITIONS AND DEMOLITION PLAN	20	LIGHTING AND RETAINING WALL DETAILS
4-5	PROPOSED SITE DEVELOPMENT PLAN	21-22	EROSION AND SEDIMENTATION CONTROL DETAILS
6	PROPOSED CIRCULATION, PARKING, AND SIGNAGE PLAN	G-1.10	CNG GENERAL ARRANGEMENT
7	PROPOSED UTILITIES PLAN	G-1.11	CNG GENERAL ARRANGEMENT - EQUIPMENT COMPOUND
8	POND 6W PLAN AND PROFILE	P-1.0	CNG TRUSS UP-FIT
9	BUILDING FLOOR PLAN	E-1.0	CNG TRUSS UP-FIT - ELECTRICAL
10-11	BUILDING ELEVATIONS	SK-1	CNG CAMERA PLAN
12-13	DETAILS	SK-2	CNG FLAME DETECTORS
14	WATER SUPPLY AND SEWER DETAILS		

SHEET NO TITLE

FOR MORE INFORMATION ABOUT THESE PLANS, CONTACT THE CITY OF ROCHESTER PLANNING DEPARTMENT, 31 WAKEFIELD STREET, ROCHESTER, NH 03867 (603) 335-1338.

APPROVAL CERTIFIED BY:

SHEET NO TITLE

DATE:

THE DEVELOPMENT DEPICTED IN THESE DRAWINGS MUST BE IN COMPLIANCE WITH ALL APPLICABLE LAW-INCLUDING ALL PERTINENT PROVISIONS OF THE "CITY OF ROCHESTER SITE PLAN REGULATIONS"- UNLESS OTHERWISE WAIVED,



PREPARED FOR:



WASTE MANAGEMENT OF NEW HAMPSHIRE, INC.

ROCHESTER, NEW HAMPSHIRE



20 FOUNDRY STREET, CONCORD, NEW HAMPSHIRE 03301 (603) 229-1900 FAX (603) 229-1919

2. WETLAND AREAS REPRESENT A COMPILATION OF INFORMATION DETERMINED USING EXISTING AERIAL PHOTOGRAPHY, SOILS INFORMATION, U.S.F.W.S. NATIONAL WETLAND INVENTORY MAPS, AND DELINEATIONS WITHIN THE PROJECT AREA CONDUCTED IN OCTOBER AND DECEMBER 2014 AAND SUPPLEMENTED WITH ADDITIONAL DELINEATIONS PERFORMED BETWEEN SEPTEME 2009 AND JUNE 2015 BY SHARRY H. KEITH, NH CWS #087, IN ACCORDANCE WITH NHWB ADMINISTRATIVE RULE WT 301.01 (A-C) USING THE METHODS OUTLINED IN THE CORPS OF ENGINEERS WETLAND DELINEATION MANUAL, TECHNICAL REPORT Y-97-1 (JANUARY 1987) PIELD IDENTIFYING HYDRIC SOILS IN NEW ENGLAND (VERSION II) PUBLISHED BY THE N.E. INTERSTATE WATER POLLUTION CONTROL COMMISSION. WETLAND AREAS WERE CLASSIFIED IN ACCORDANCE WITH NHWB ADMINISTRATIVE RULE WT 301.02 USING THE USENWICHORS 100 MAJUAL CLASSIFICATION OF WETTANDS AND THE PROFILED THE OFFICE AND THE OFFI AND SANDERS. IN ACCORDANCE WITH NHWB ADMINISTRATIVE RULE WT 301,02 USING THE USFWS/OBS-79/31 MANUAL CLASSIFICATION OF WETLANDS AND DEEPWATER HABITATS OF THE UNITED STATES (COWARDIN ET AL. 1979).

3. LIMIT OF WETLANDS PERTINENT TO THE TLR-III SOUTH AREA WERE MAPPED BY WSP TRANSPORTATION AND INFRASTRUCTURE, INC. OF NASHUA, NEW HAMPSHIRE, USING TOTAL STATION SURVEY METHODS AND PROVIDED ELECTRONICALLY ON NOVEMBER 7, 2014 AND FEBRUARY 3, 2015, AND SUPPLEMENTED WITH LIMIT OF WETLANDS PREVIOUSLY DELINEATED IN 2000 AND 2008.

4. EXISTING UTILITIES SHOWN WERE COMPILED FROM THE FOLLOWING SOURCES, LOCATIONS SHALL BE CONSIDERED APPROXIMATE. CONTRACTOR SHALL CONFIRM IN THE FIELD THE LOCATIONS OF UTILITIES WITHIN THE LIMIT OF DISTURBANCE:

4.1. ACTUAL ON-THE-GROUND SURVEY DONE WITH A COMBINATION OF GPS RTK AND CONVENTIONAL SURVEY METHODS, CONDUCTED BY WSP ON OCTOBER 8, OCTOBER 10, OCTOBER 27, 2014, AND SEPTEMBER 22, 2015.

4.2. A PLAN TITLED "LTP EFFLUENT FORCEMAIN ASBULT, WASTE MANAGEMENT OF NEW HAMPSHIRE, INC., ROCHESTER, NH" PREPARED BY SUR CONSTRUCTION, INC. OF ROCHESTER, NH DATED MARCH 3, 2010.

4.3. A PLAN TITLED \* RECORD DRAWING, ROCHESTER NECK ROAD ROADWAY IMPROVEMENTS, ROCHESTER, NH" PREPARED BY GCG ASSOCIATES, INC. OF LYNNFIELD, MA DATED AUGUST 1991.

4.4. ACTUAL ON-THE-GROUND SURVEY DONE USING GPS RTK SURVEY METHODS, CONDUCTED BY WMNH IN FALL 2017.

4.5. HISTORICAL SKETCHES OF THE SITE PROVIDED TO SANBORN HEAD BY WMNH.

4.6 TAYLOR AVENUE WATER LINE LOCATION DIGITIZED FROM A PLAN SET TITLED "FOREST MEADOWS SITE PLAN, ROCHESTER NECK ROAD, ROCHESTER, N.H." PREPARED BY DURGIN/SCHOFIELD ASSOCIATES, DATED MARCH 2, 1987.

5. PROPERTY LINE INFORMATION WAS TAKEN FROM A PLAN TITLED "BOUNDARY COMPILATION AND FOOTPRINT COMPILATION OF TLR-I AND TLR-III, ROCHESTER NECK ROAD, ROCHESTER, NEW HAMPSHIRE" PREPARED FOR WASTE MANAGEMENT OF NEW HAMPSHIRE, INC. BY CHAS. H. SELLS, INC. OF NASHUA, NEW HAMPSHIRE DATED JANUARY 92, 2002 AT A SCALLE OF 1"3 OLAL OTHER PROPERTY LINE INFORMATION WAS OBTAINED FROM ELECTRONIC (AUTOCAD) TAX MAP FILES CREATED BY CAI TECHNOLOGIES OF LITTLETON, NEW HAMPSHIRE.

ZONING INFORMATION IS BASED ON THE CITY OF ROCHESTER, NH ZONING MAP PREPARED BY NORWAY PLAINS ASSOCIATES, INC. OF ROCHESTER, NEW HAMPSHIRE, ADOPTED APRIL 14, 2014.

THE 100-YEAR FLOODPLAIN IS BASED ON INFORMATION PROVIDED ON THE FEDERAL EMERGENCY MANAGEMENT AGENCY (FEMA) "FLOOD INSURANCE RATE MAP, STRAFFORD COUNTY, NEW HAMPSHIRE" PANEL 302 OF 405, EFFECTIVE DATE SEPTEMBER 30, 2015.

#### MATERIAL SPECIFICATIONS

1. ORDINARY FILL SHALL BE NATURAL SOIL WITH NO PARTICLES LARGER THAN 8 INCHES.

2. GRANULAR FILL SHALL BE NATURAL SOIL WITH NO PARTICLES LARGER THAN 1 INCH.

3. UNLESS OTHERWISE NOTED ON THE DRAWINGS, CRUSHED STONE SHALL HAVE A MAXIMUM PARTICLE SIZE OF 1-1/2 INCHES.

4. TYPE I RIPRAP SHALL CONSIST OF STONE RANGING IN SIZE FROM 4 TO 10 INCHES.

5. TYPE II RIPRAP SHALL CONSIST OF STONE RANGING IN SIZE FROM 6 TO 8 INCHES.

6. GRANULAR BEDDING SAND SHALL BE A WELL GRADED SAND WITH NO PARTICLES LARGER THAN 1 INCH.

7. CRUSHED GRAVEL SHALL CONSIST OF UNIFORMLY MIXED CRUSHED STONE AND COARSE SAND WITH NO PARTICLES LARGER THAN 2

#### **ABBREVIATIONS**

Ø	DIAMETER	MIN.	MINIMUM
A, ASPH	ASPHALT	MW	MONITORING WELL
AST	ABOVE-GROUND STORAGE TANK	N	NORTHING
CB	CATCH BASIN	O.C.	ON CENTER
CFM	CUBIC FEET PER MINUTE	OD	OUTER DIAMETER
CONC.	CONCRETE	PC	PERIMETER CHANNEL
CMP	CORRUGATED METAL PIPE	PE	POLYETHYLENE
CPP	CORRUGATED POLYETHYLENE PIPE	PROJ.	PROJECTING
CW	CHANNEL WIDTH	PT	POINT OF TANGENCY
DI	DROP INLET	PVC	POLYVINYL CHLORIDE
DMH	DRAIN MANHOLE	RCP	REINFORCED CONCRETE PIPE
E	EASTING	RMC	RIGID METAL CONDUIT
EL	ELEVATION	SCH	SCHEDULE
ENDWL	ENDWALL	SDR	STANDARD DIMENSION RATIO
FES	FLARED END SECTION	SS	STAINLESS STEEL
GP	GAS PROBE	TP	TEST PIT
HDPE	HIGH DENSITY POLYETHYLENE	TLR	TURNKEY LANDFILL OF ROCHEST
HDWL	HEAD WALL	TRANS	TRANSFORMER
HP	HIGH POINT, HORSEPOWER	TYP	TYPICAL
INV.	INVERT	UST	UNDER-GROUND STORAGE TANK
MAX.	MAXIMUM	W	WELL, GAS WELL

MC METAL COVER

#### LEGEND

#### EXISTING CONDITIONS

EXISTING C	ONDITIONS	
	TOWN LINE	
	PROPERTY LINE	
	LOT LINE	
	RECYCLING INDUSTRIAL ZONING BOUNDARY	
	LIMIT OF WASTE CONTAINMENT	_
	TLR-I LIMIT OF WASTE CONTAINMENT	-
	2-FOOT ELEVATION CONTOUR	_
180	10-FOOT ELEVATION CONTOUR	_
	EDGE OF ROAD	_
	UNPAVED ROAD	_
<u> </u>	LIMIT OF WETLANDS	
	EDGE OF WATER	FY
	LIMIT OF 100-YEAR FLOODPLAIN	£
	FORCE MAIN	
2 2	SEWER	
vv	WATER MAIN	
— NG —— NG —	NATURAL GAS	
— E —— E ——	ELECTRIC	
ou ou	OVERHEAD UTILITIES	
x x	FENCE	
~~~~~~~~~~~~~~~~~~~~~~~~~~~~~~~~~~~~~~~	TREE LINE	
	GUARDRAIL	
	EXISTING SWALE & FLOW DIRECTION	
	DRAINAGE CULVERT	
	PAVEMENT	
[[]]	WETLAND AREA	
	NATURAL WETLAND BUFFER AREA	
	RIPRAP-LINED SWALE	
	GABION-LINED SWALE	
	100 YEAR FLOOD PLAIN	
ф	UTILITY POLE	
⊙	POST	


MISC. OBJECT

SEWER MANHOLE

FIRE HYDRANT

TEST PIT LOCATION AND DESIGNATION

#### PROPOSED CONDITIONS

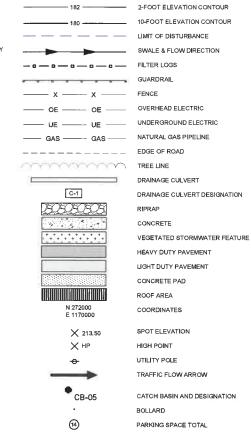

FOR MORE INFORMATION ABOUT THESE PLANS, CONTACT THE CITY OF ROCHESTER PLANNING DEPARTMENT, 31 WAKEFIELD STREET, ROCHESTER, NH 03867 (603) 335-1338.

ROCHESTER PLANNING BOARD APPROVAL CERTIFIED BY:

SANBORN

SCALE: AS NOTED

DRAWN BY: A. MATTHEWS / D. LONG DESIGNED BY: A. MATTHEWS / K. ANDERSON

 $\mathbb{R}$ 

REVIEWED BY: K. ANDERSON


PROJECT MGR: T. REED PIC: E. STEINHAUSER DATE: APRIL 2018


ROCHESTER HAULING COMPANY FACILITY WASTE MANAGEMENT OF NEW HAMPSHIRE, INC.


> NOTES, LEGEND, AND **ABBREVIATIONS**


PROJECT NUMBER 4292.00


SHEET NUMBER 1 OF 22

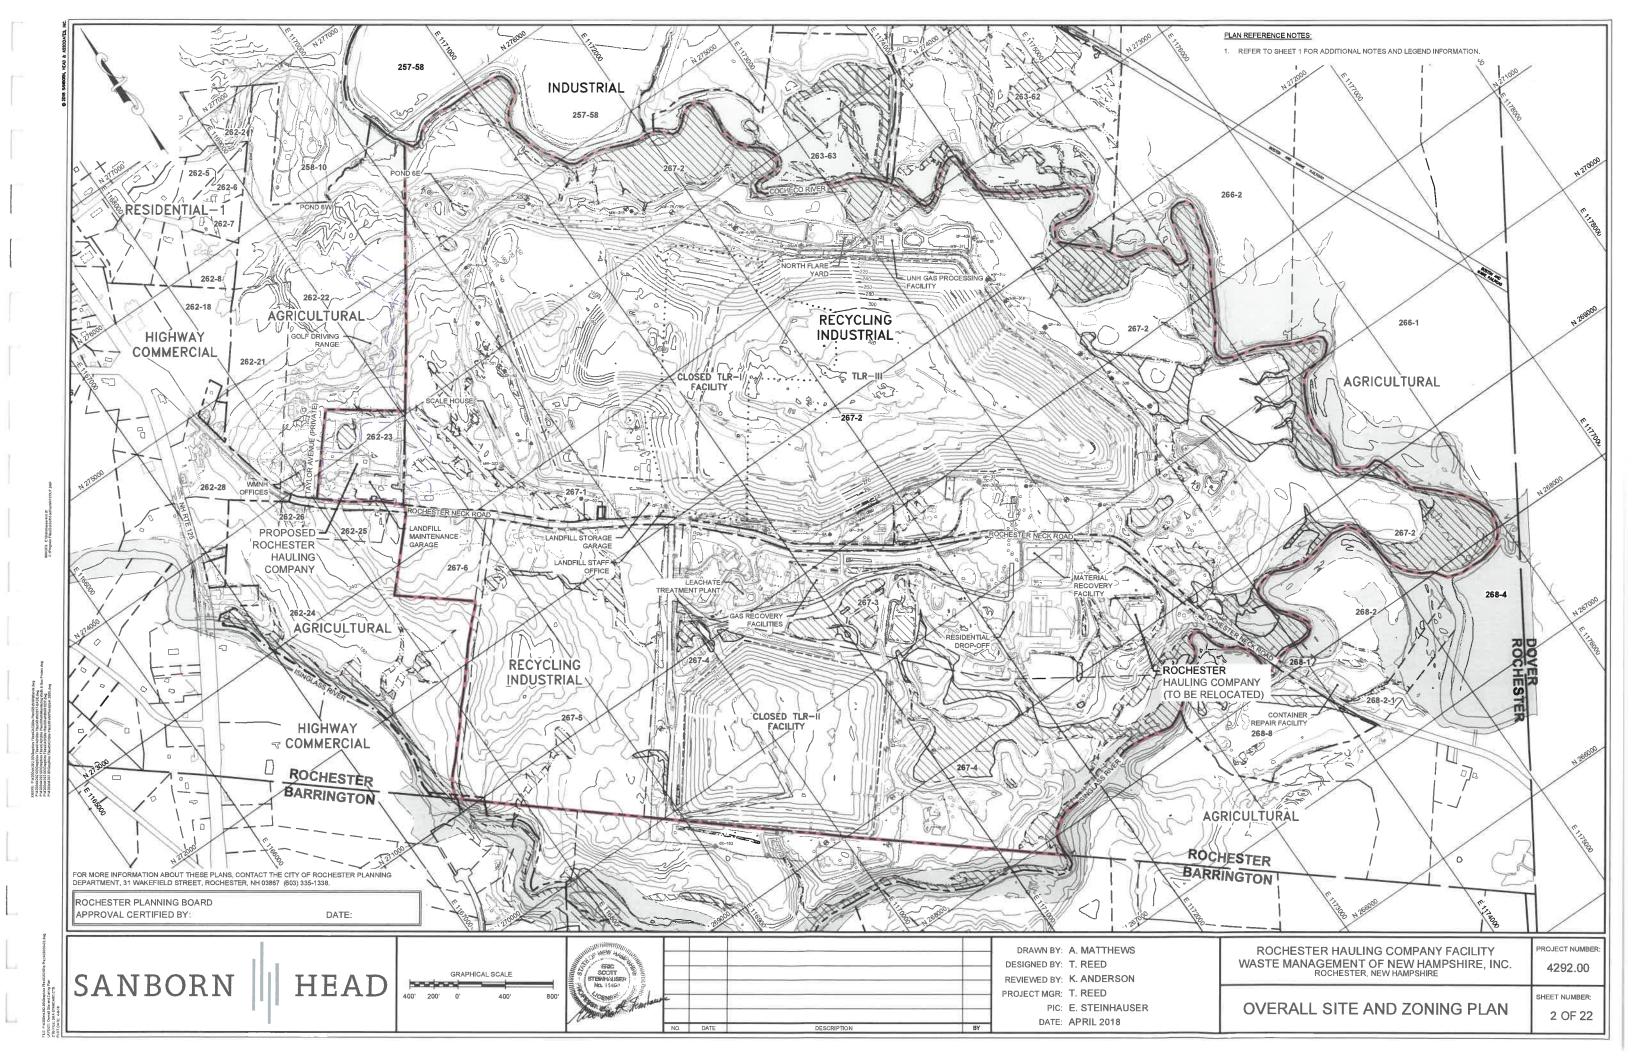


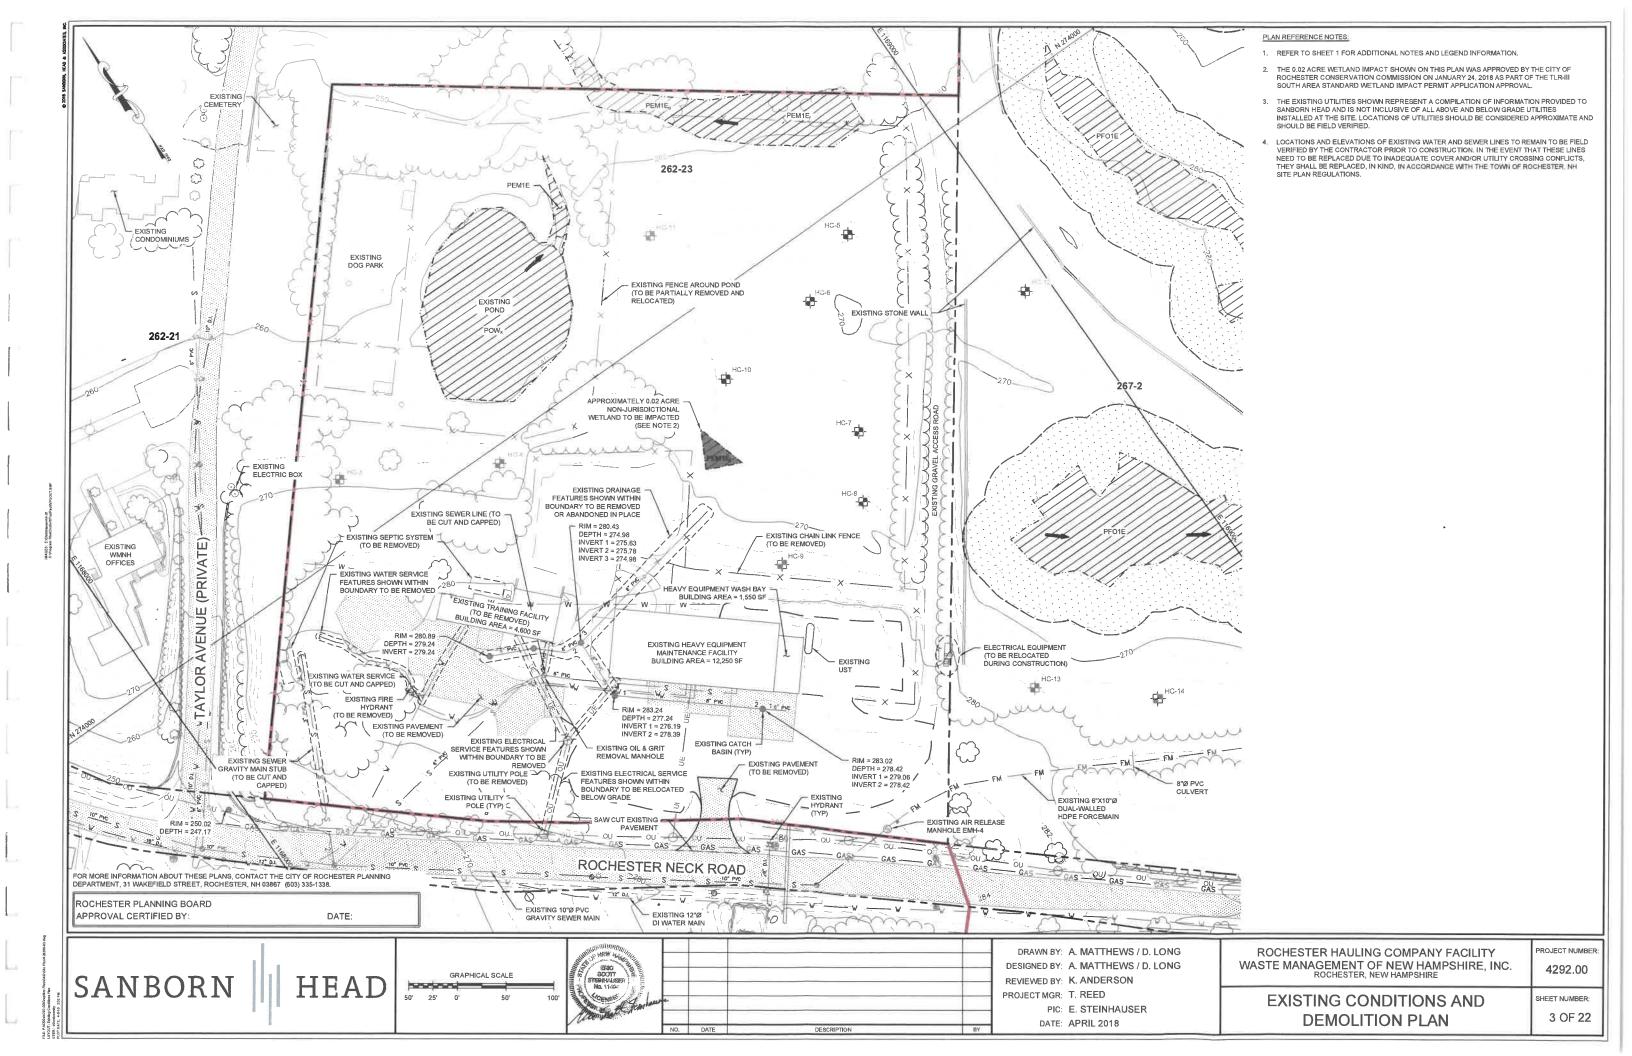


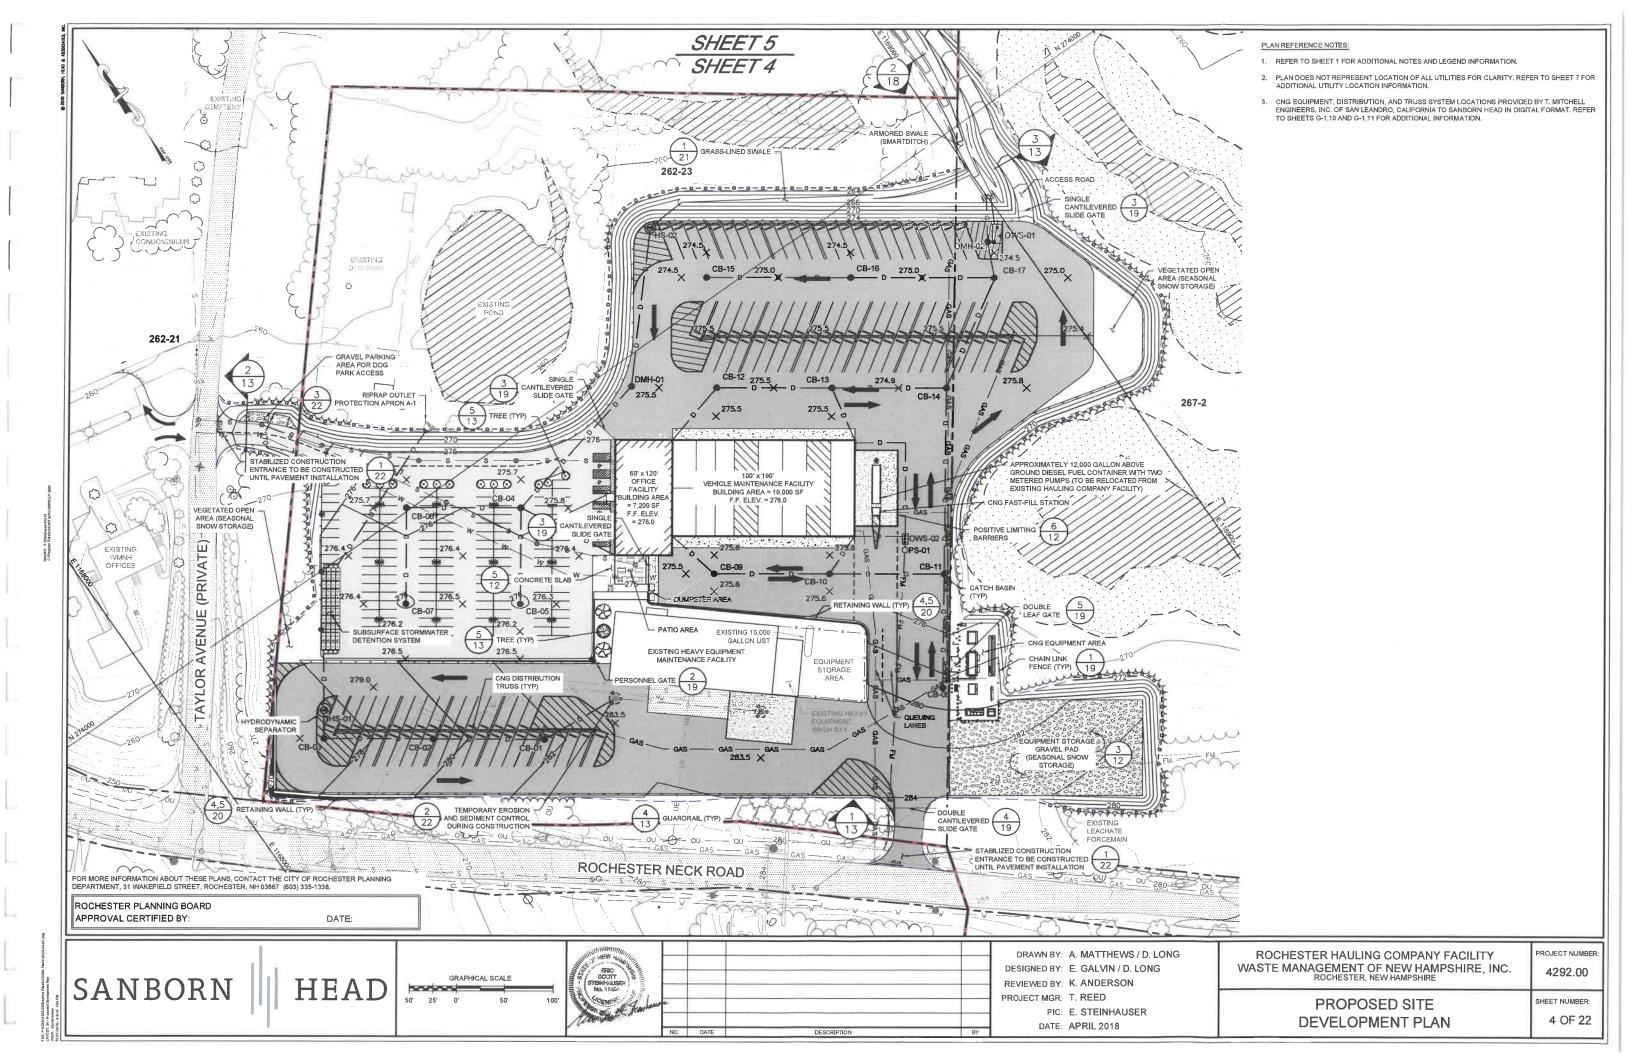


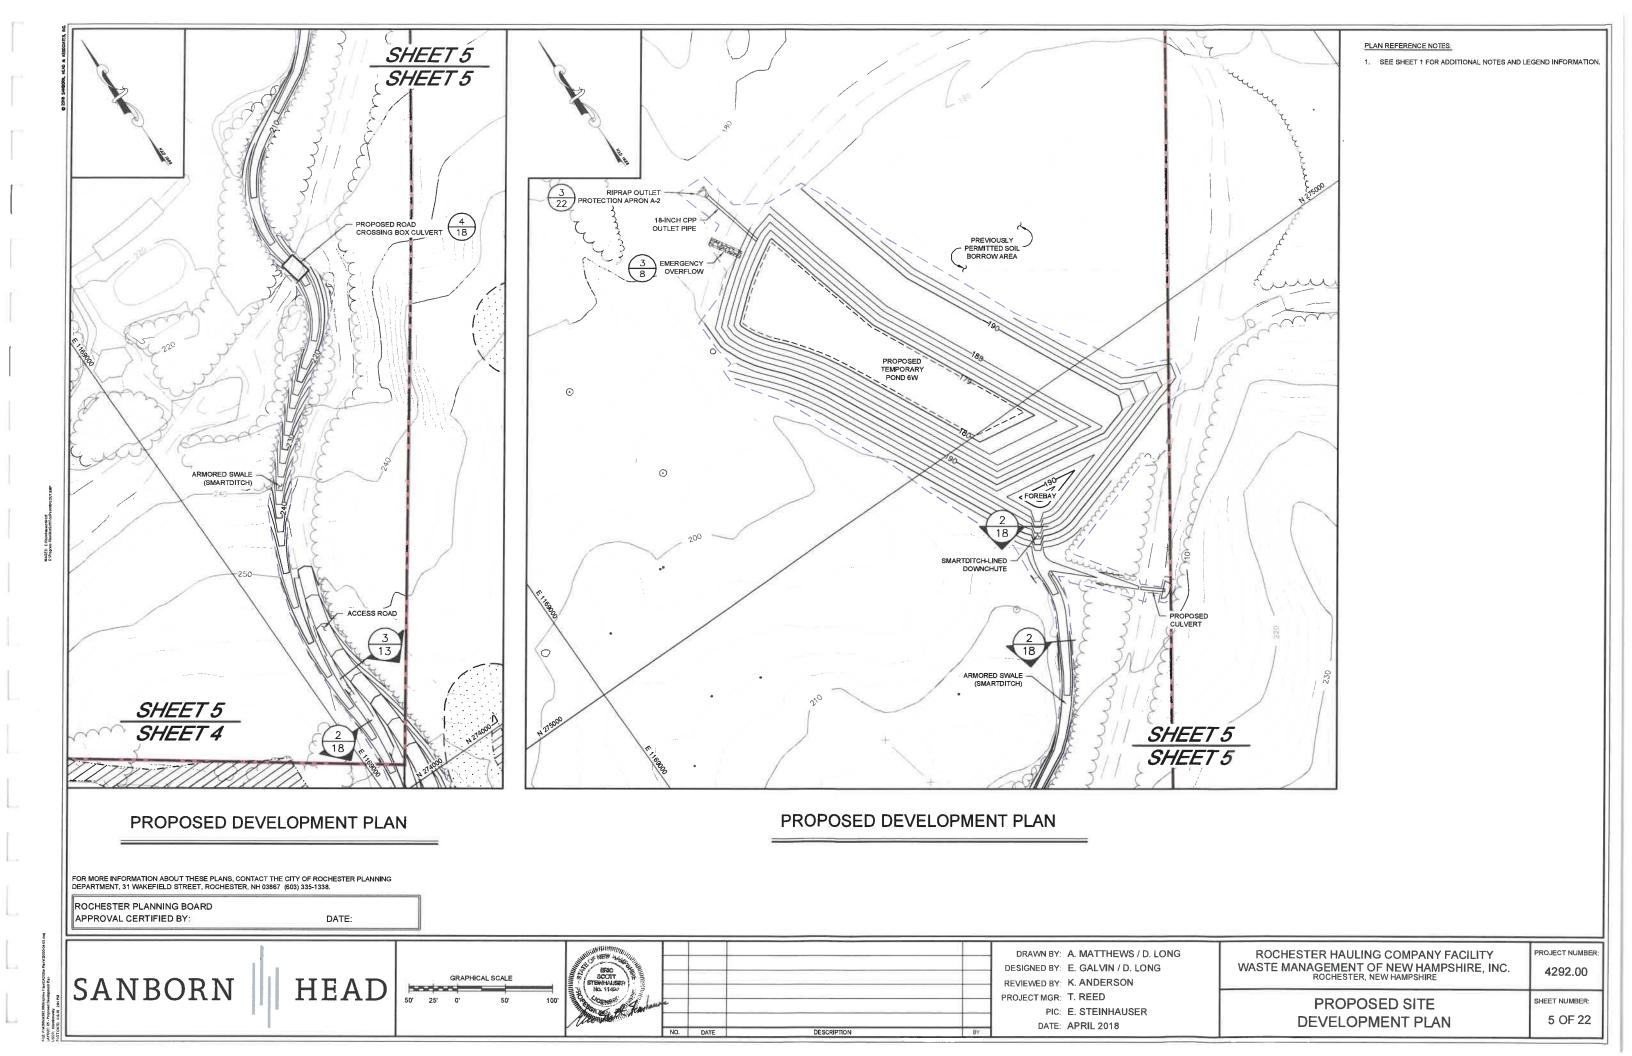

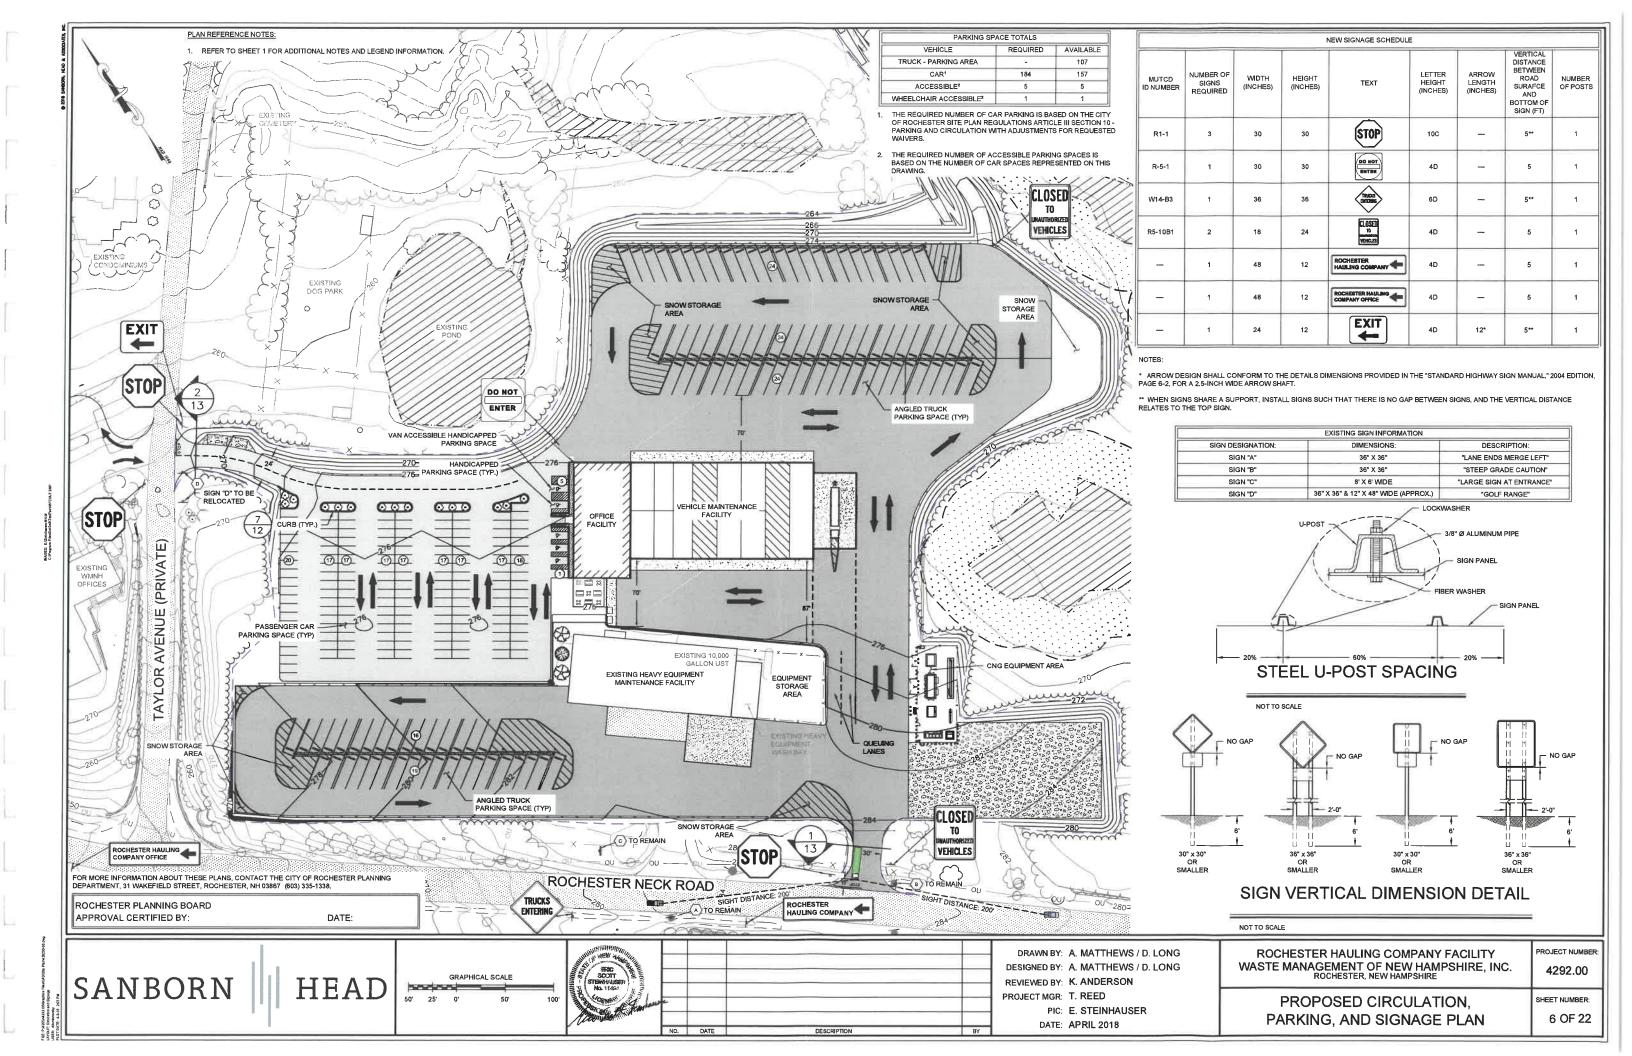

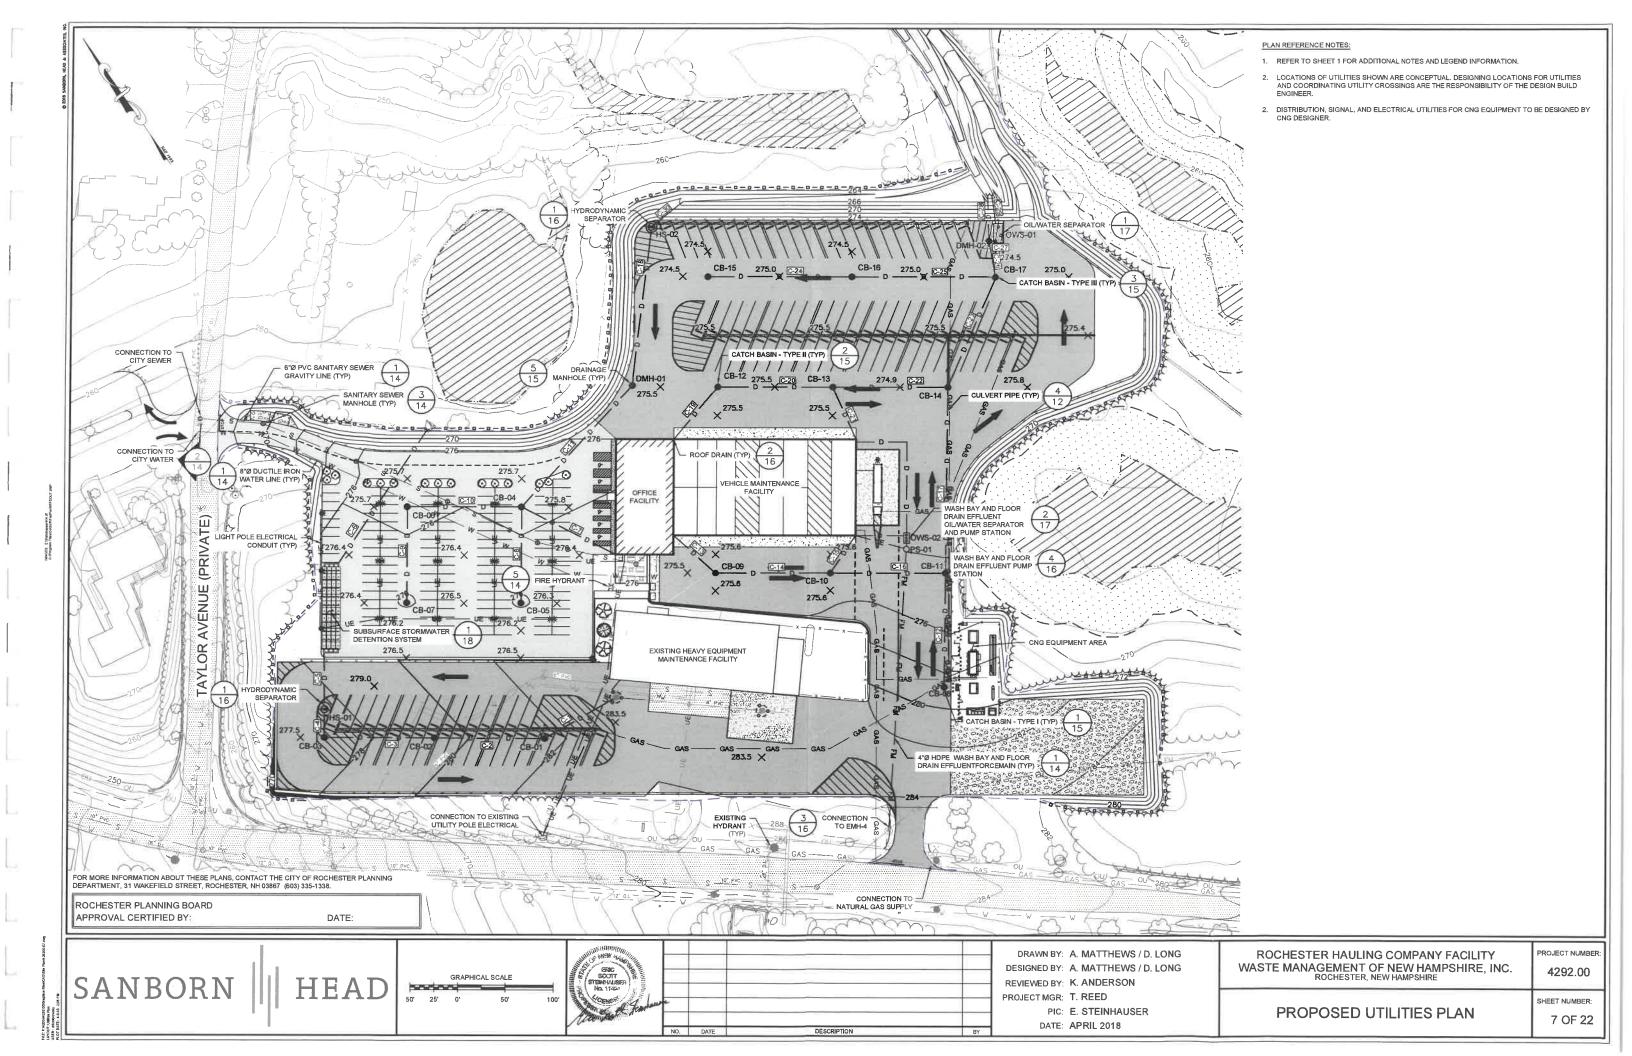


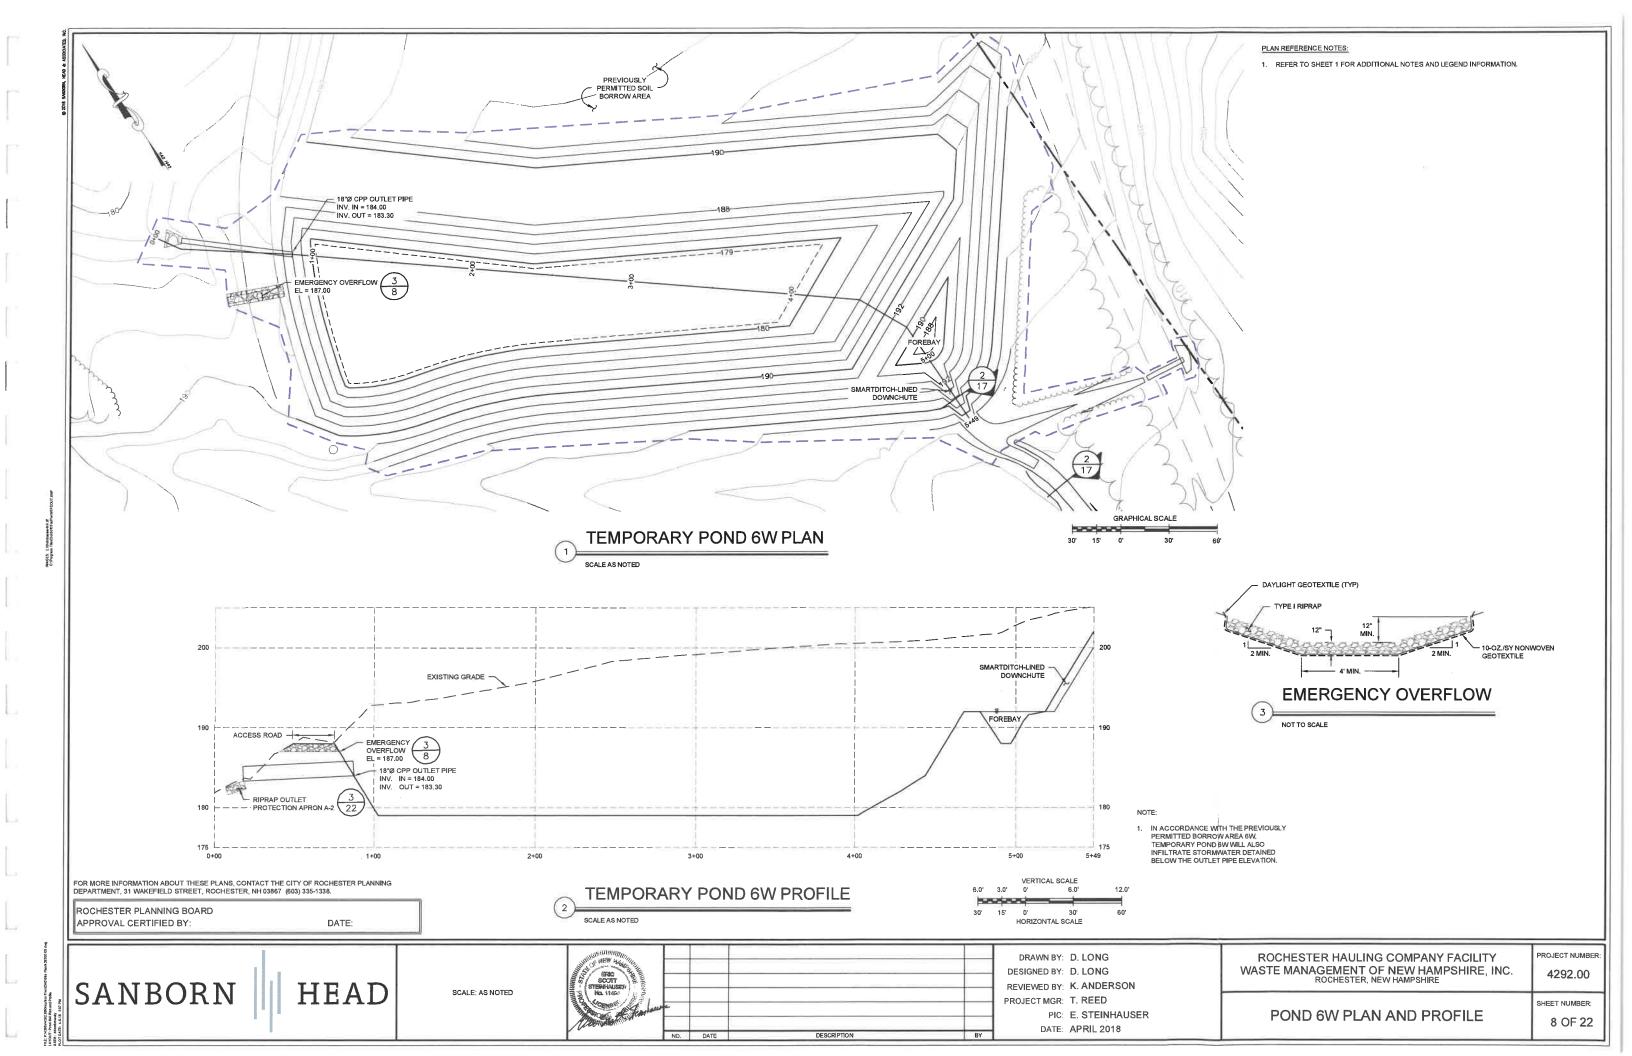

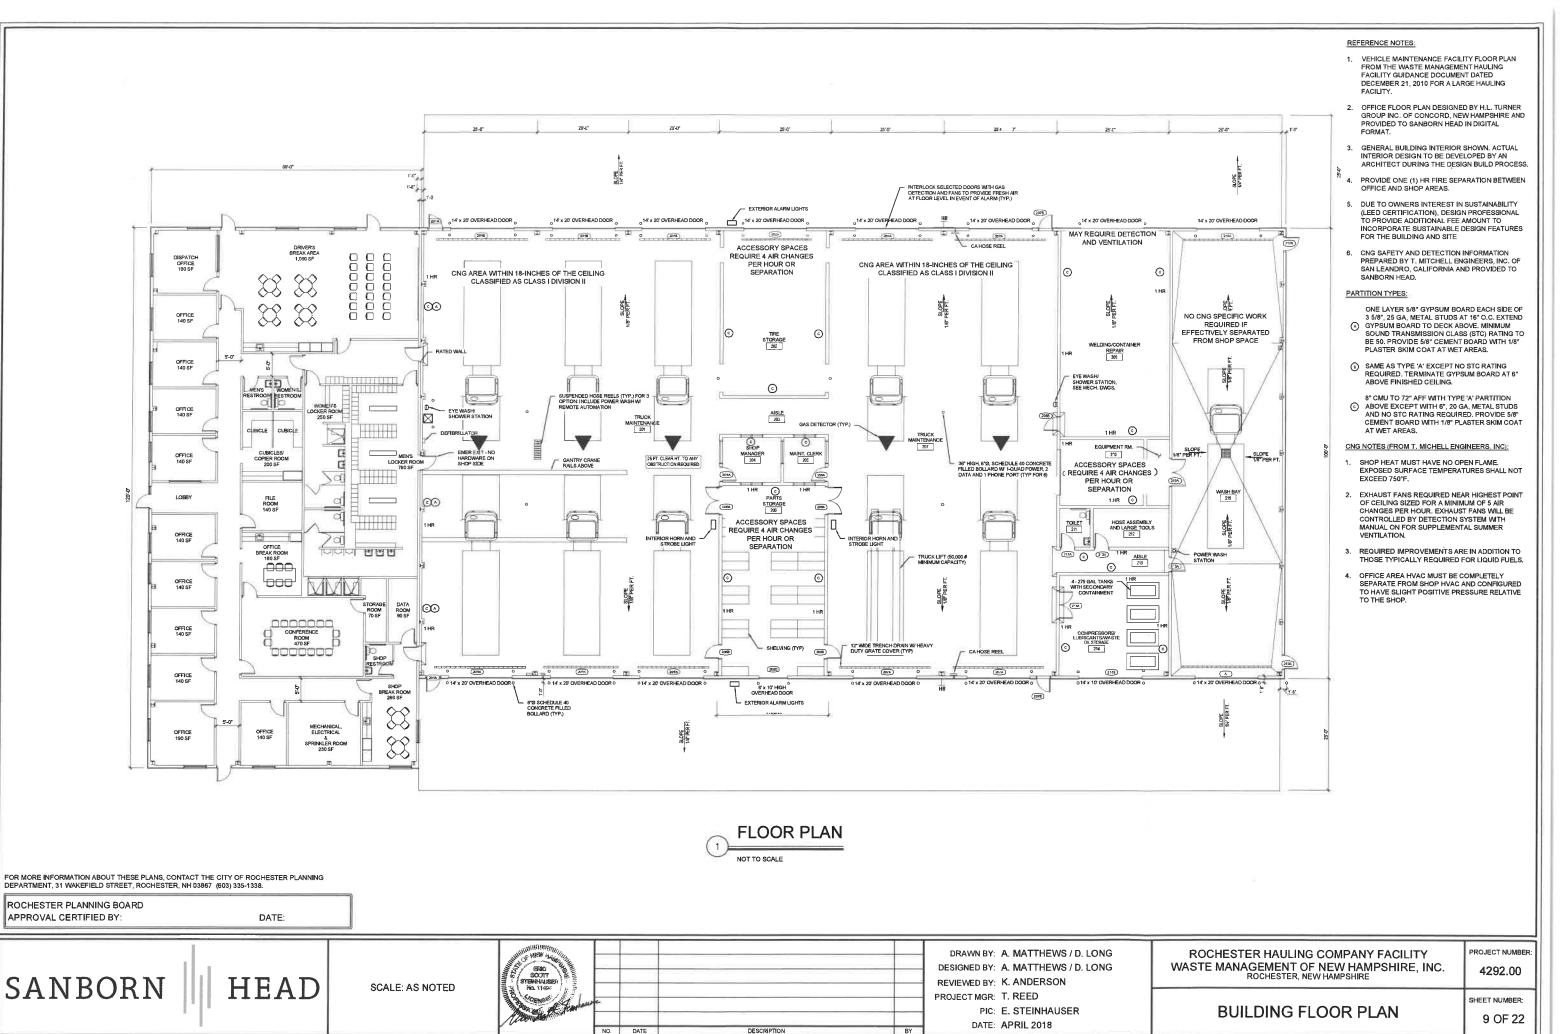


#### REFERENCE NOTES:

- BUILDING ELEVATIONS DESIGNED BY THE H.L. TURNER GROUP INC. OF CONCORD, NEW HAMPSHIRE AND PROVIDED TO SANBORN HEAD IN DIGITAL FORMAT ON MARCH 30, 2018.
- GENERAL BUILDING ELEVATIONS SHOWN, ACTUAL EXTERIOR DESIGN TO BE DEVELOPED BY AN ARCHITECT DURING THE DESIGN BUILD PROCESS.

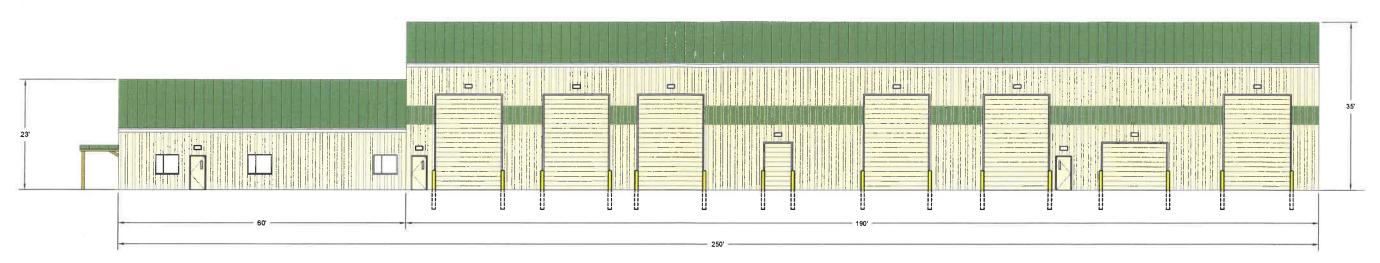

## SOUTH WALL BUILDING ELEVATION

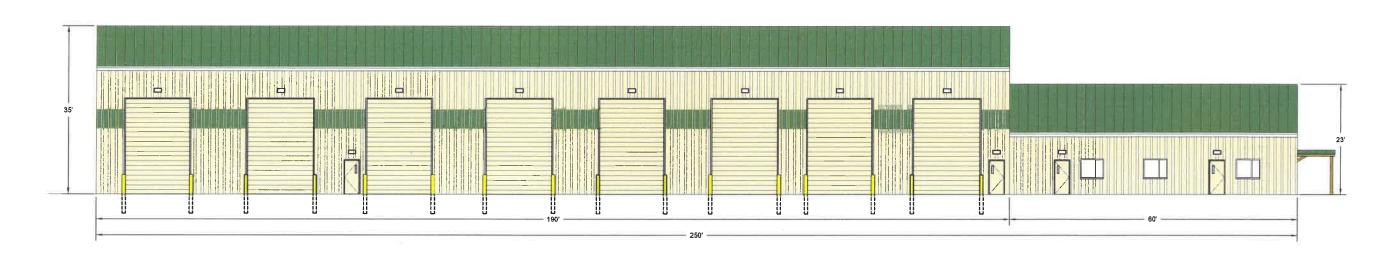

## NORTH WALL BUILDING ELEVATION


FOR MORE INFORMATION ABOUT THESE PLANS, CONTACT THE CITY OF ROCHESTER PLANNING DEPARTMENT, 31 WAKEFIELD STREET, ROCHESTER, NH 03867 (603) 335-1338.

ROCHESTER PLANNING BOARD APPROVAL CERTIFIED BY:

DATE:

SANBORN HEAD

SCALE: AS NOTED

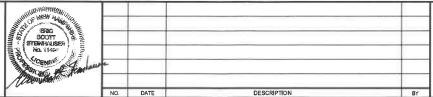

DRAWN BY: D. LONG

DESIGNED BY: D. LONG

REVIEWED BY: K. ANDERSON

PROJECT MGR: T. REED

PIC: E. STEINHAUSER DATE: APRIL 2018

ROCHESTER HAULING COMPANY FACILITY WASTE MANAGEMENT OF NEW HAMPSHIRE, INC. ROCHESTER, NEW HAMPSHIRE

PROJECT NUMBER 4292.00


SHEET NUMBER:

**BUILDING ELEVATIONS** 10 OF 22

- BUILDING ELEVATIONS DESIGNED BY THE H.L. TURNER GROUP INC. OF CONCORD, NEW HAMPSHIRE AND PROVIDED TO SANBORN HEAD IN DIGITAL FORMAT ON MARCH 30, 2018.
- GENERAL BUILDING ELEVATIONS SHOWN. ACTUAL EXTERIOR DESIGN TO BE DEVELOPED BY AN ARCHITECT DURING THE DESIGN BUILD PROCESS.



## WEST WALL BUILDING ELEVATION NOT TO SCALE

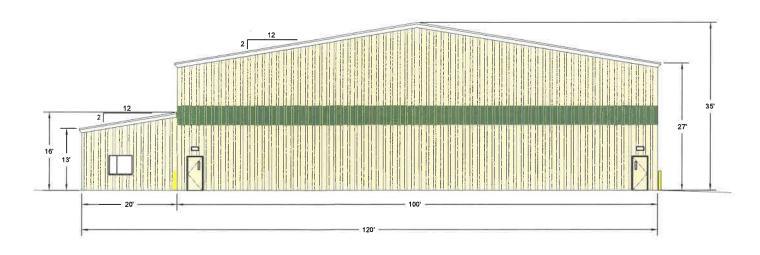

## **EAST WALL BUILDING ELEVATION**

FOR MORE INFORMATION ABOUT THESE PLANS, CONTACT THE CITY OF ROCHESTER PLANNING DEPARTMENT, 31 WAKEFIELD STREET, ROCHESTER, NH 03867 (603) 335-1338.

ROCHESTER PLANNING BOARD

SANBORN

APPROVAL CERTIFIED BY:

DATE:

SCALE: AS NOTED

1 Downson I was a second of the second of th	
No. 1940	
2 ( STEPHNALISH) : 3	_
SRC SCOTT	
ALTERIAL MARKET AND	

DRAWN BY: D. LONG DESIGNED BY: D. LONG

REVIEWED BY: K. ANDERSON

PROJECT MGR: T. REED

PIC: E. STEINHAUSER


DATE: APRIL 2018


ROCHESTER HAULING COMPANY FACILITY WASTE MANAGEMENT OF NEW HAMPSHIRE, INC. ROCHESTER, NEW HAMPSHIRE


**BUILDING ELEVATIONS** 


PROJECT NUMBER: 4292.00

SHEET NUMBER: 11 OF 22

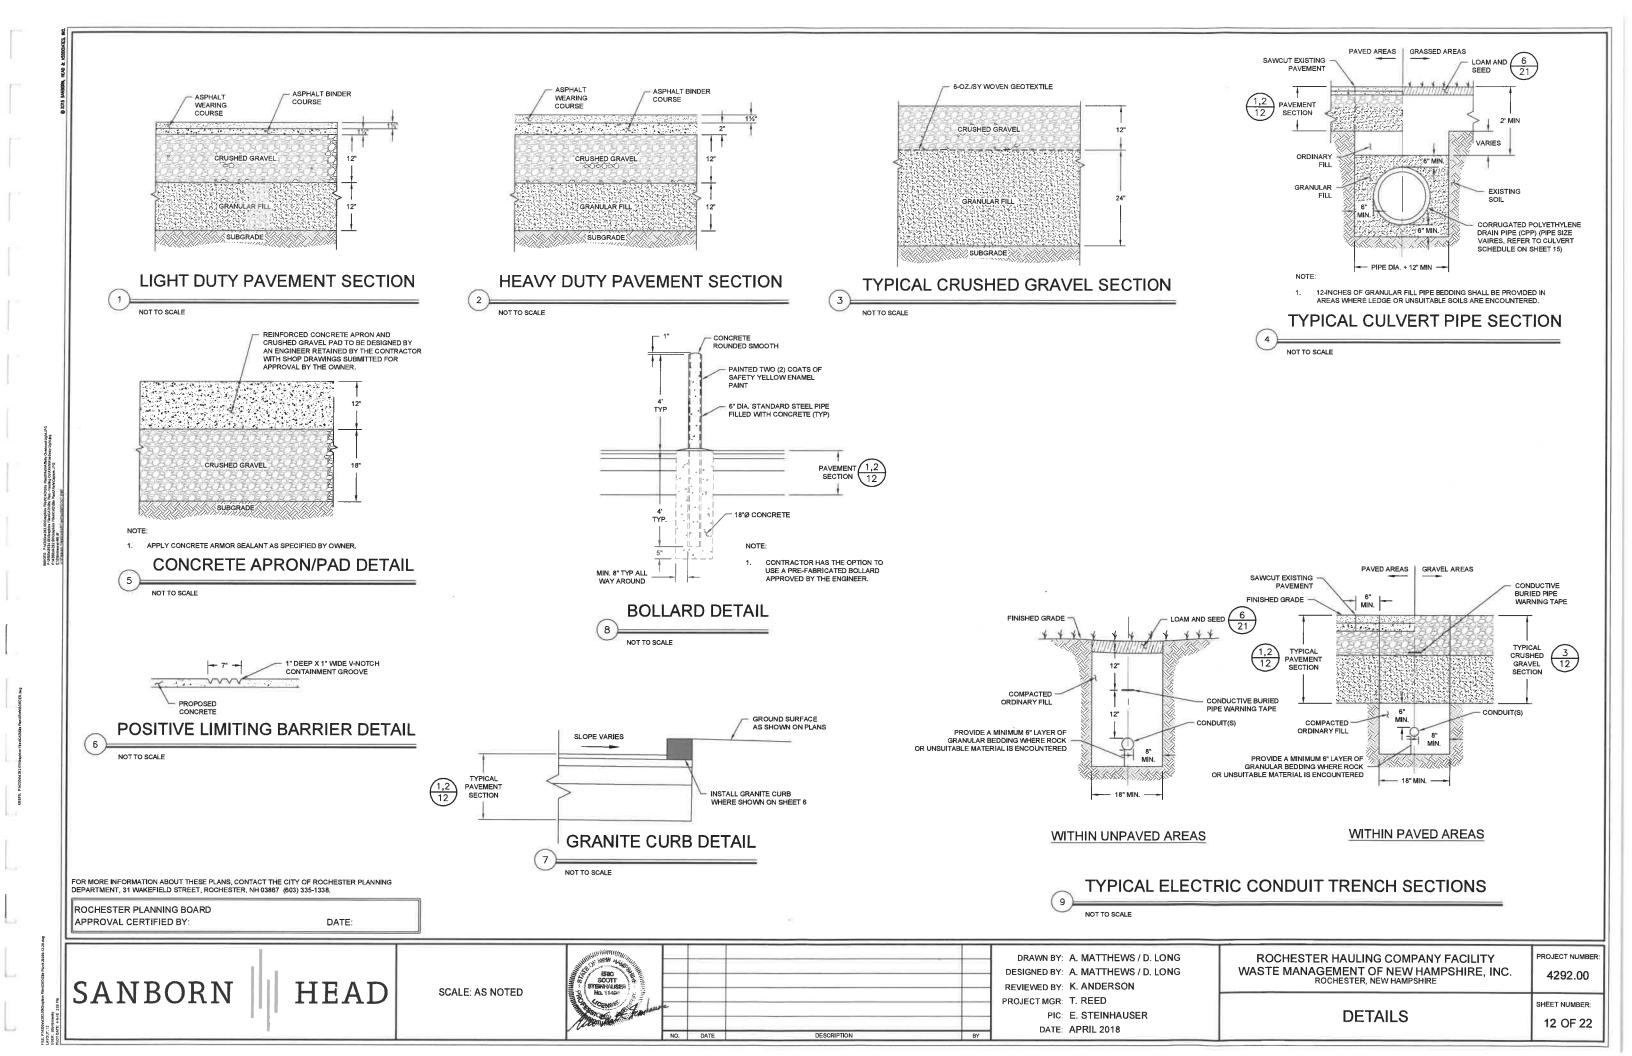


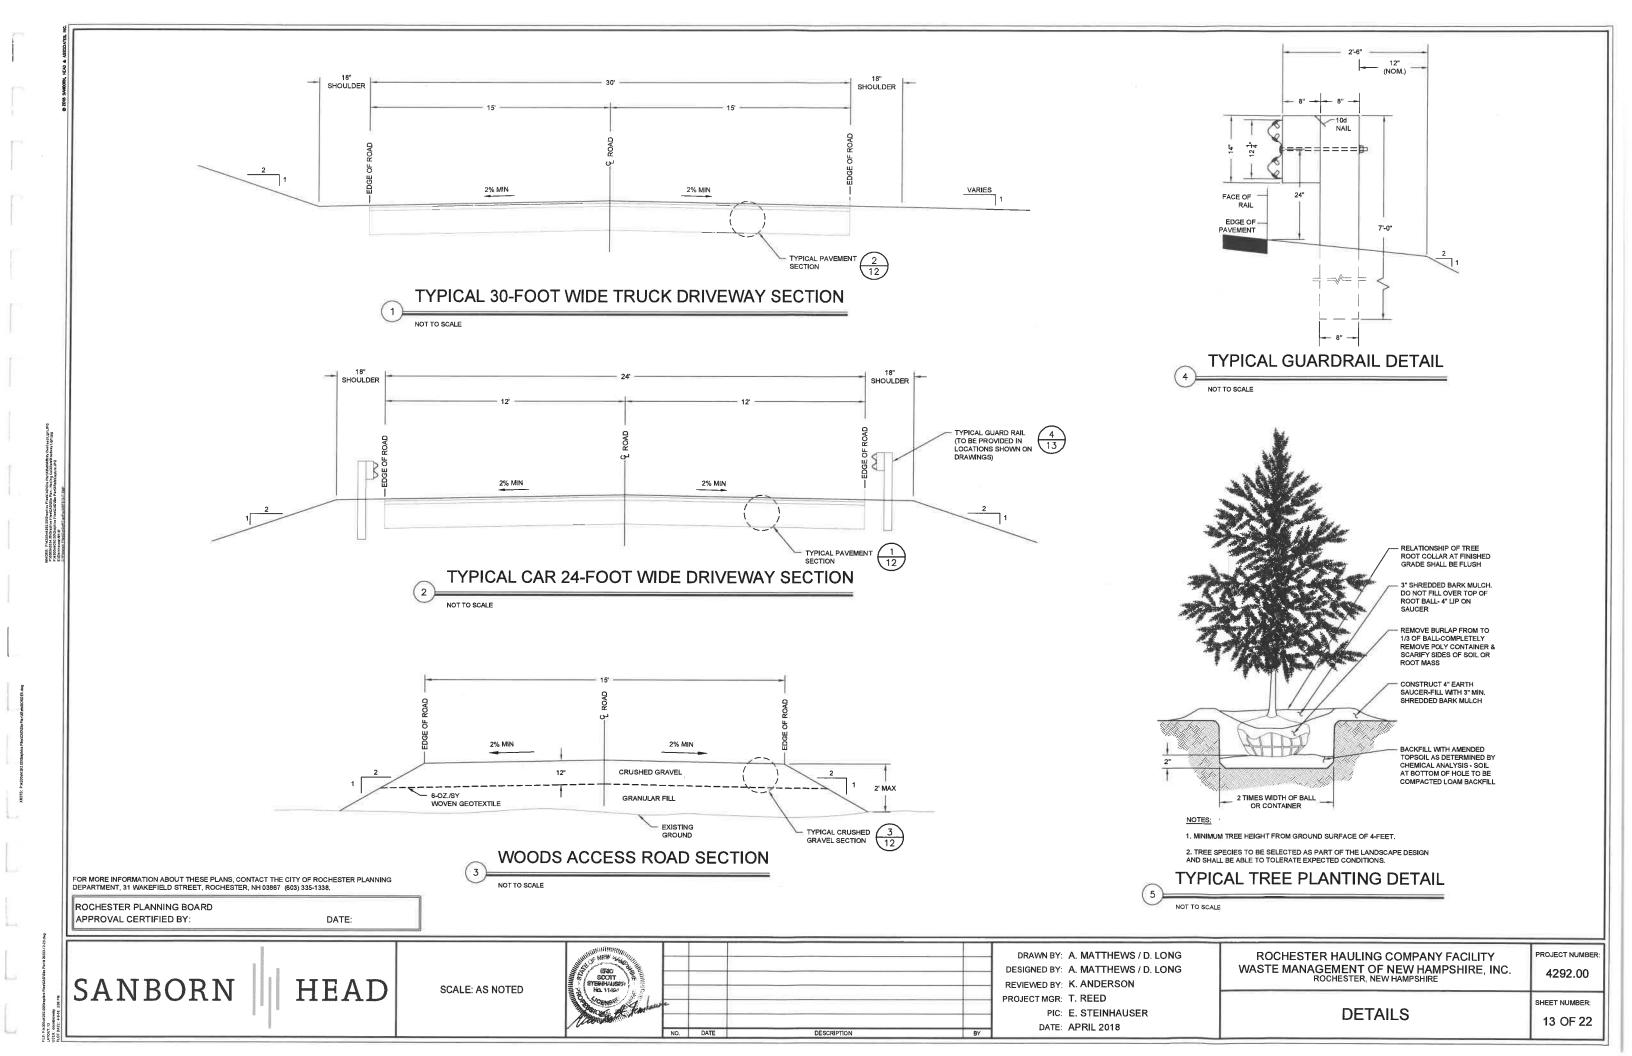


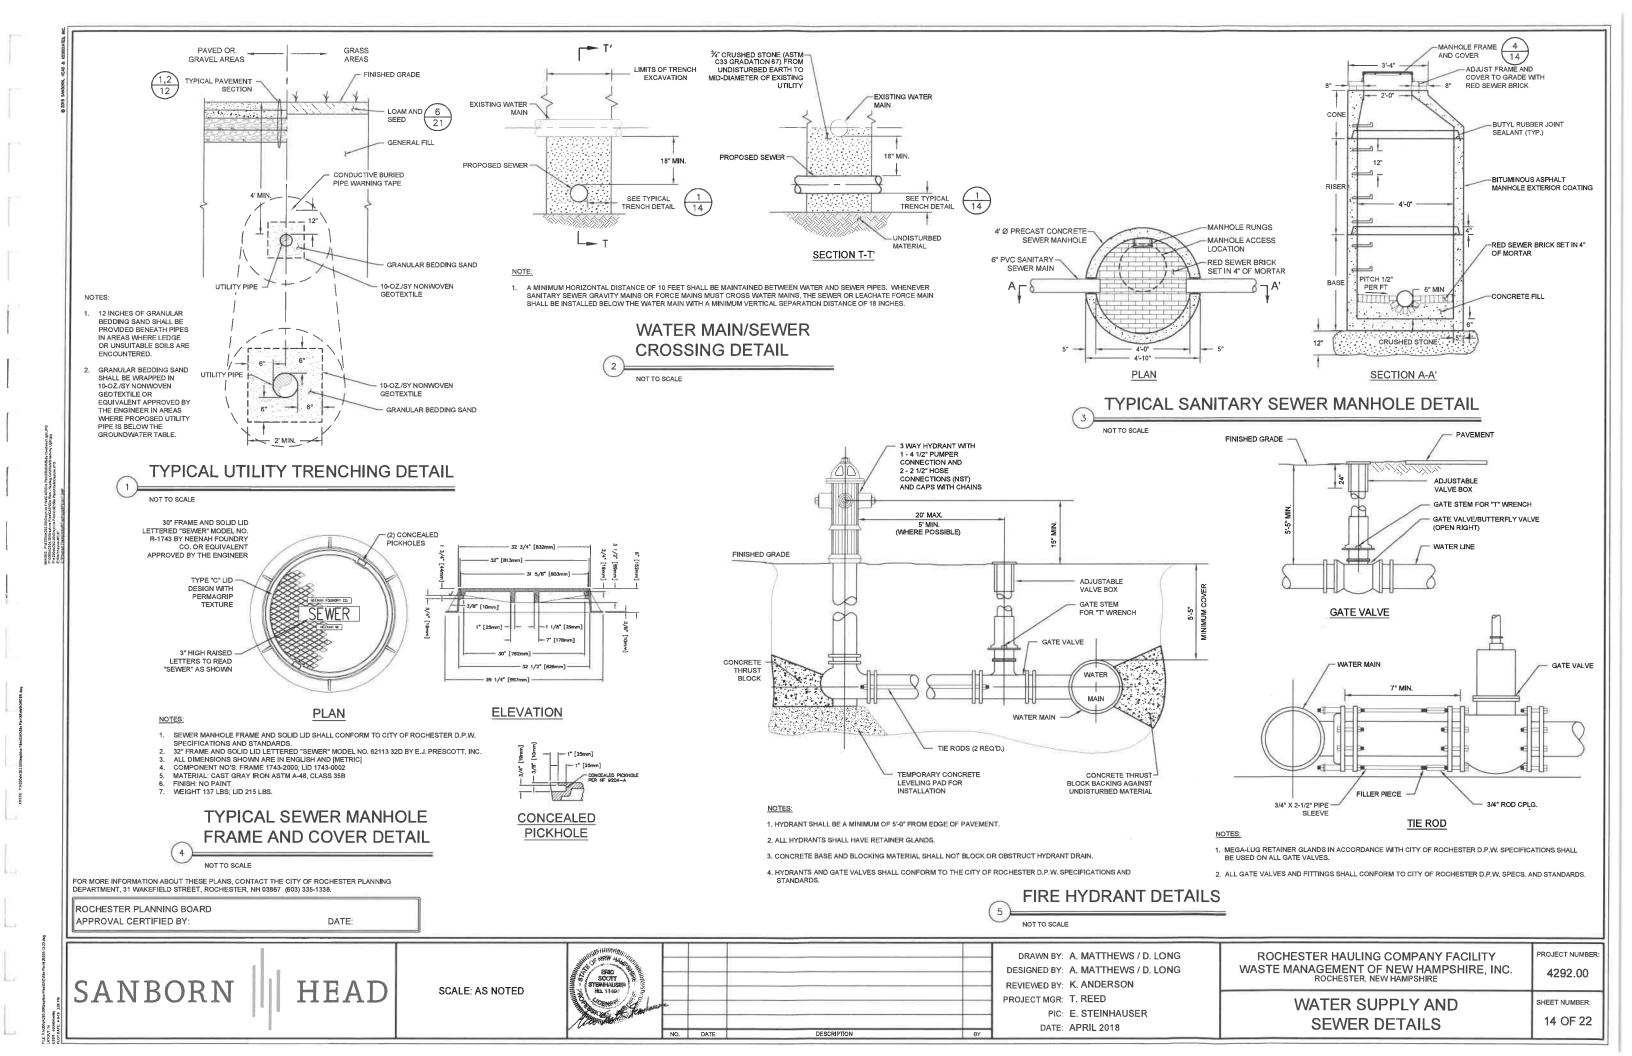


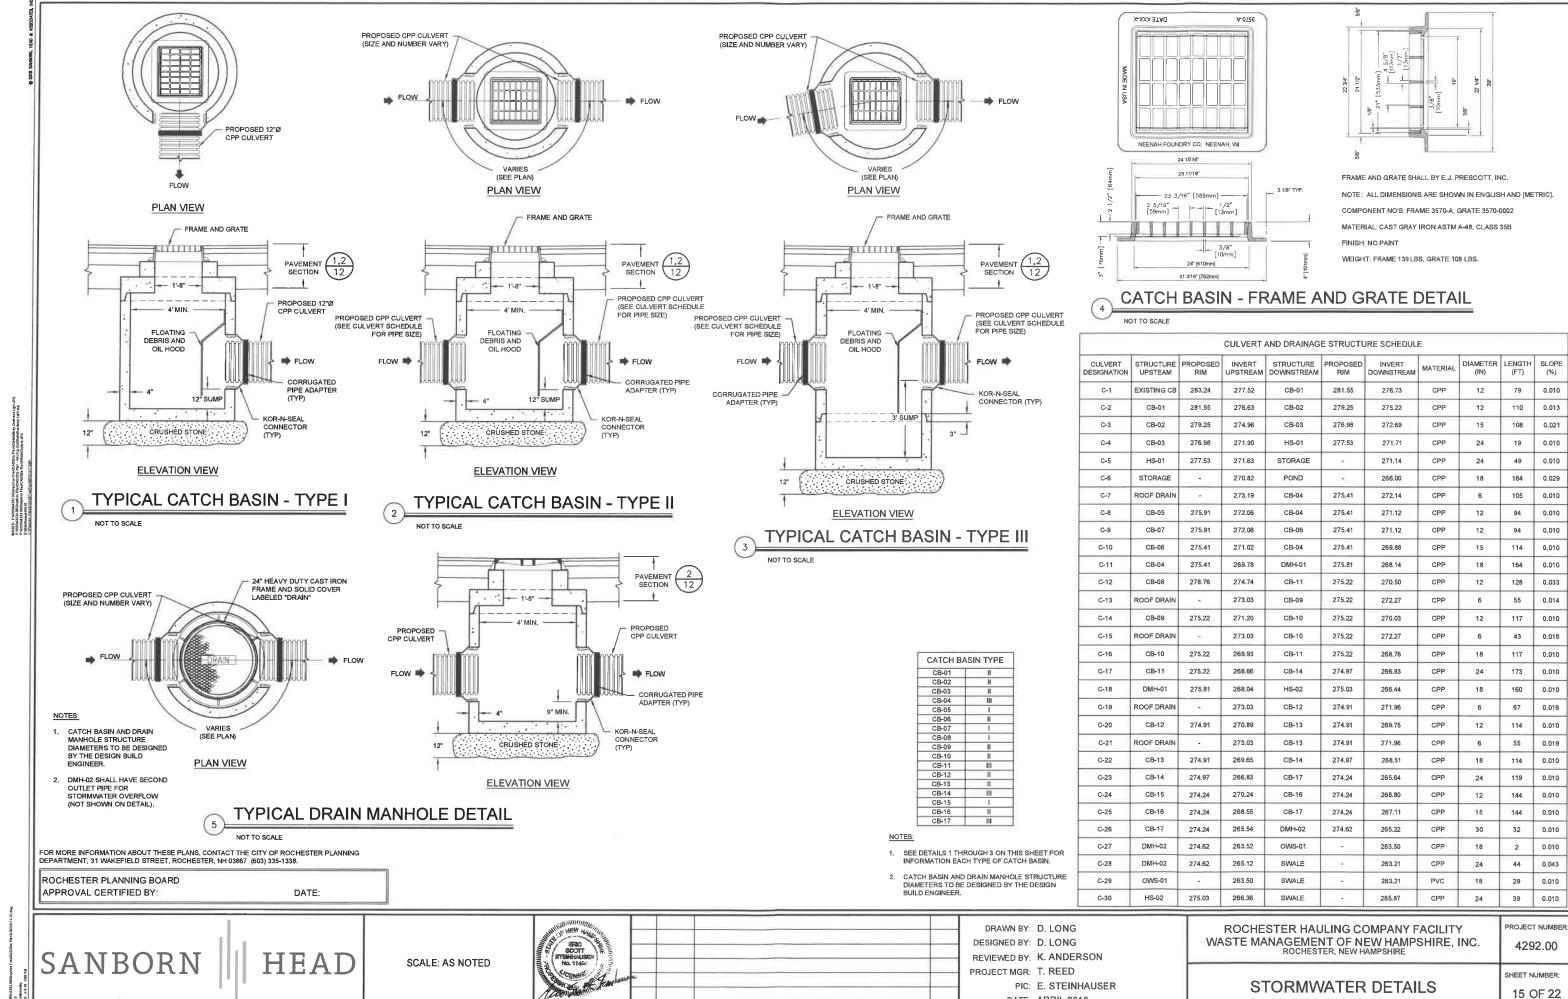



DATE: APRIL 2018

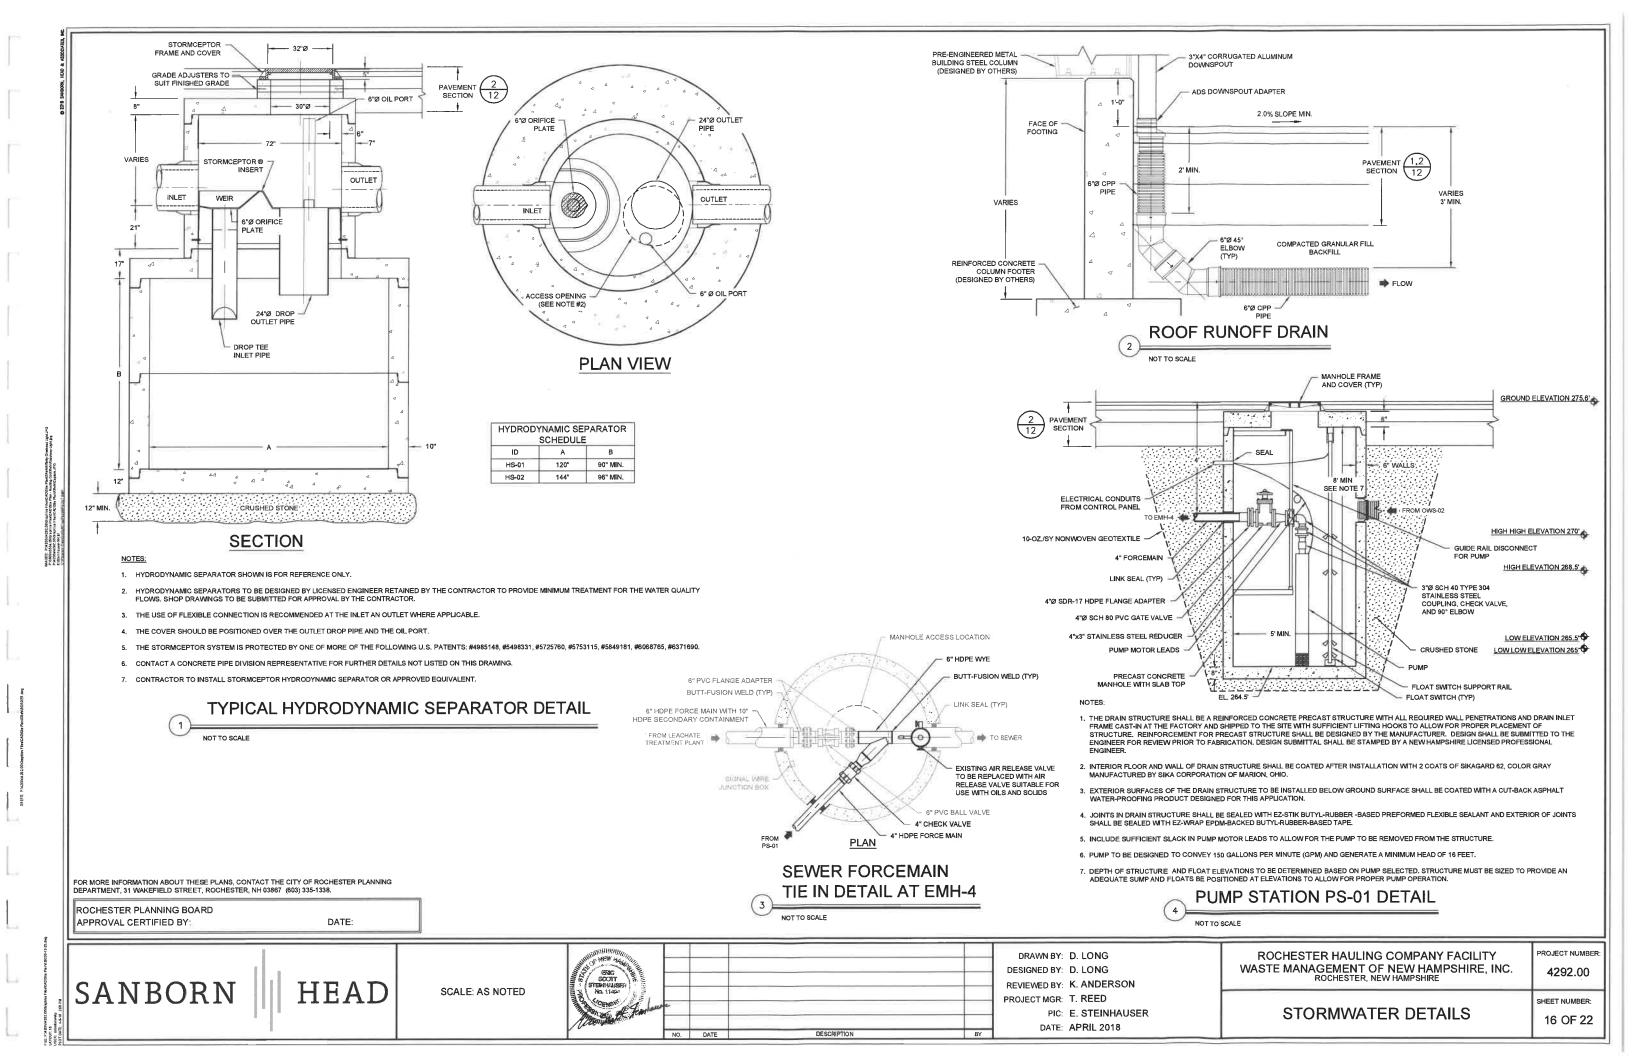


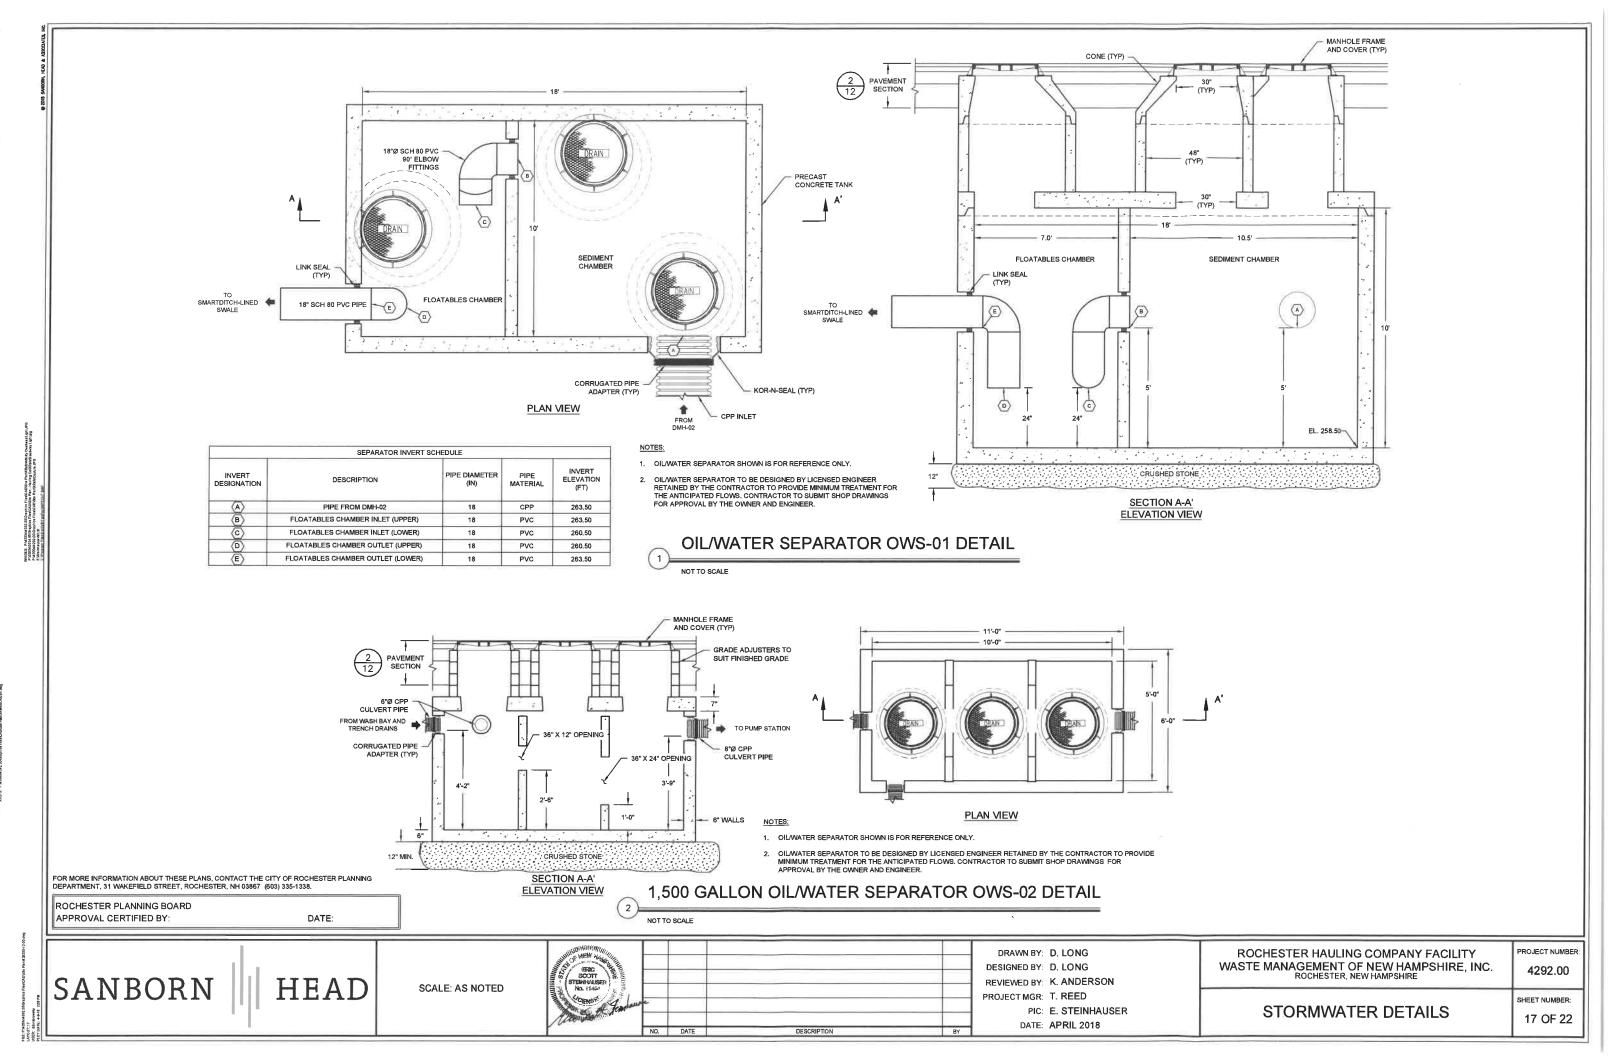

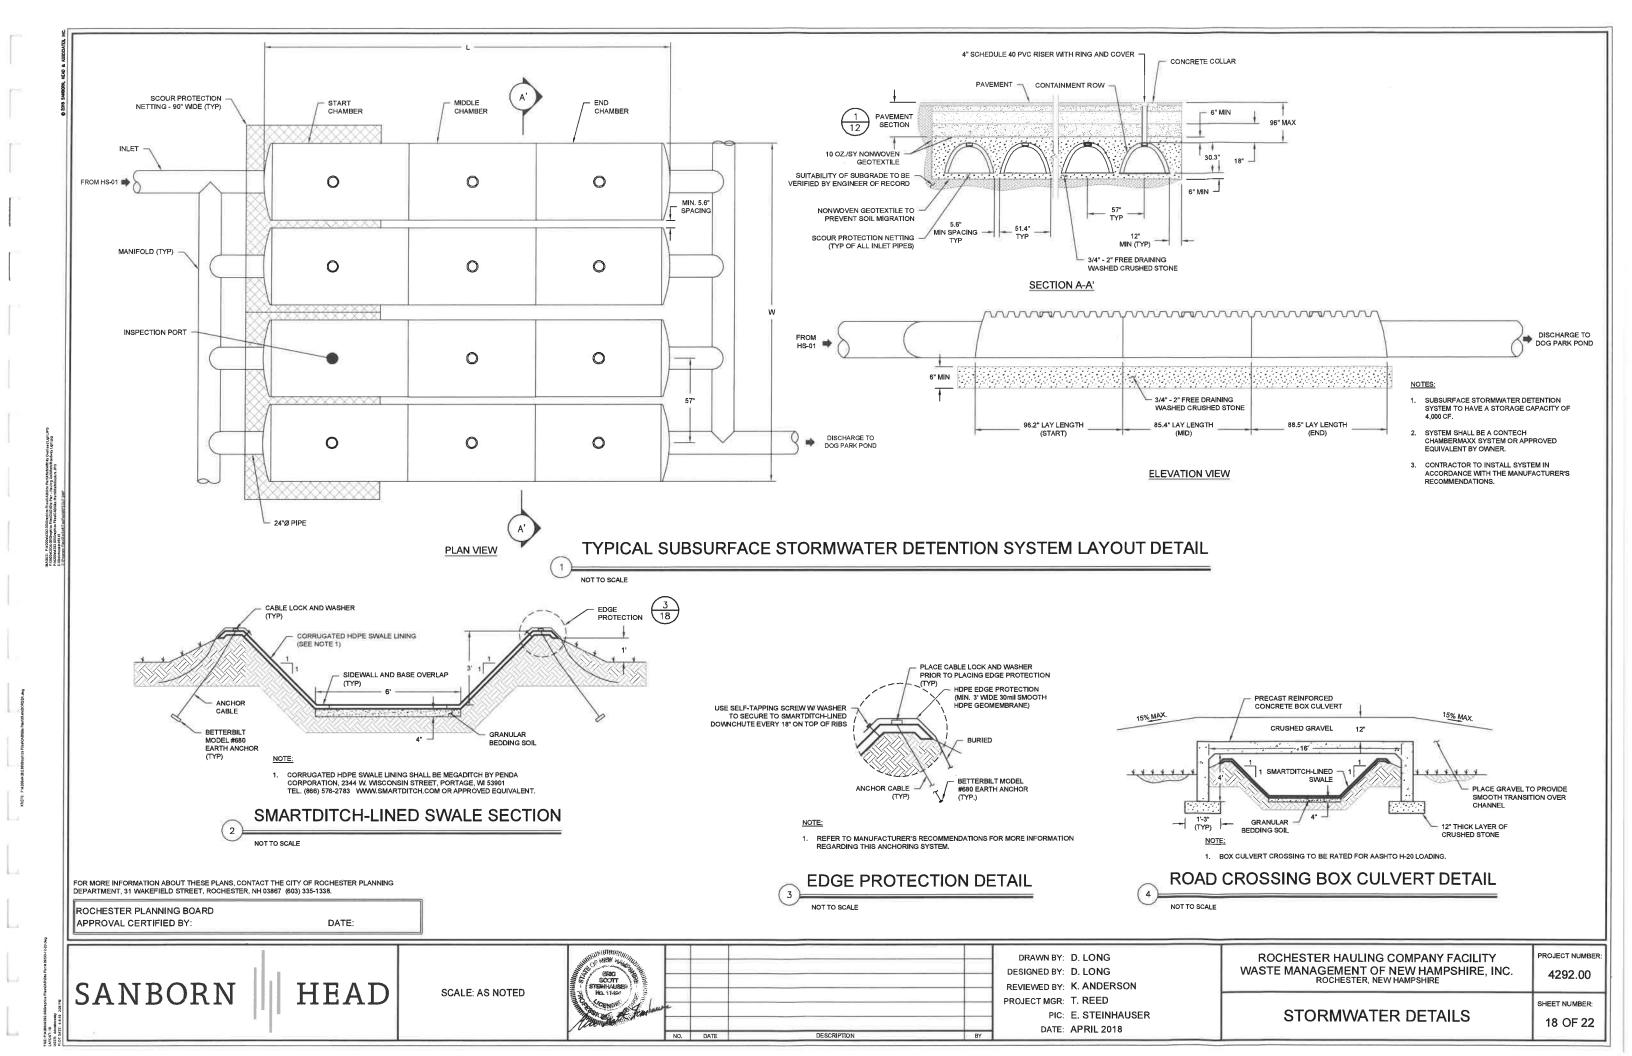

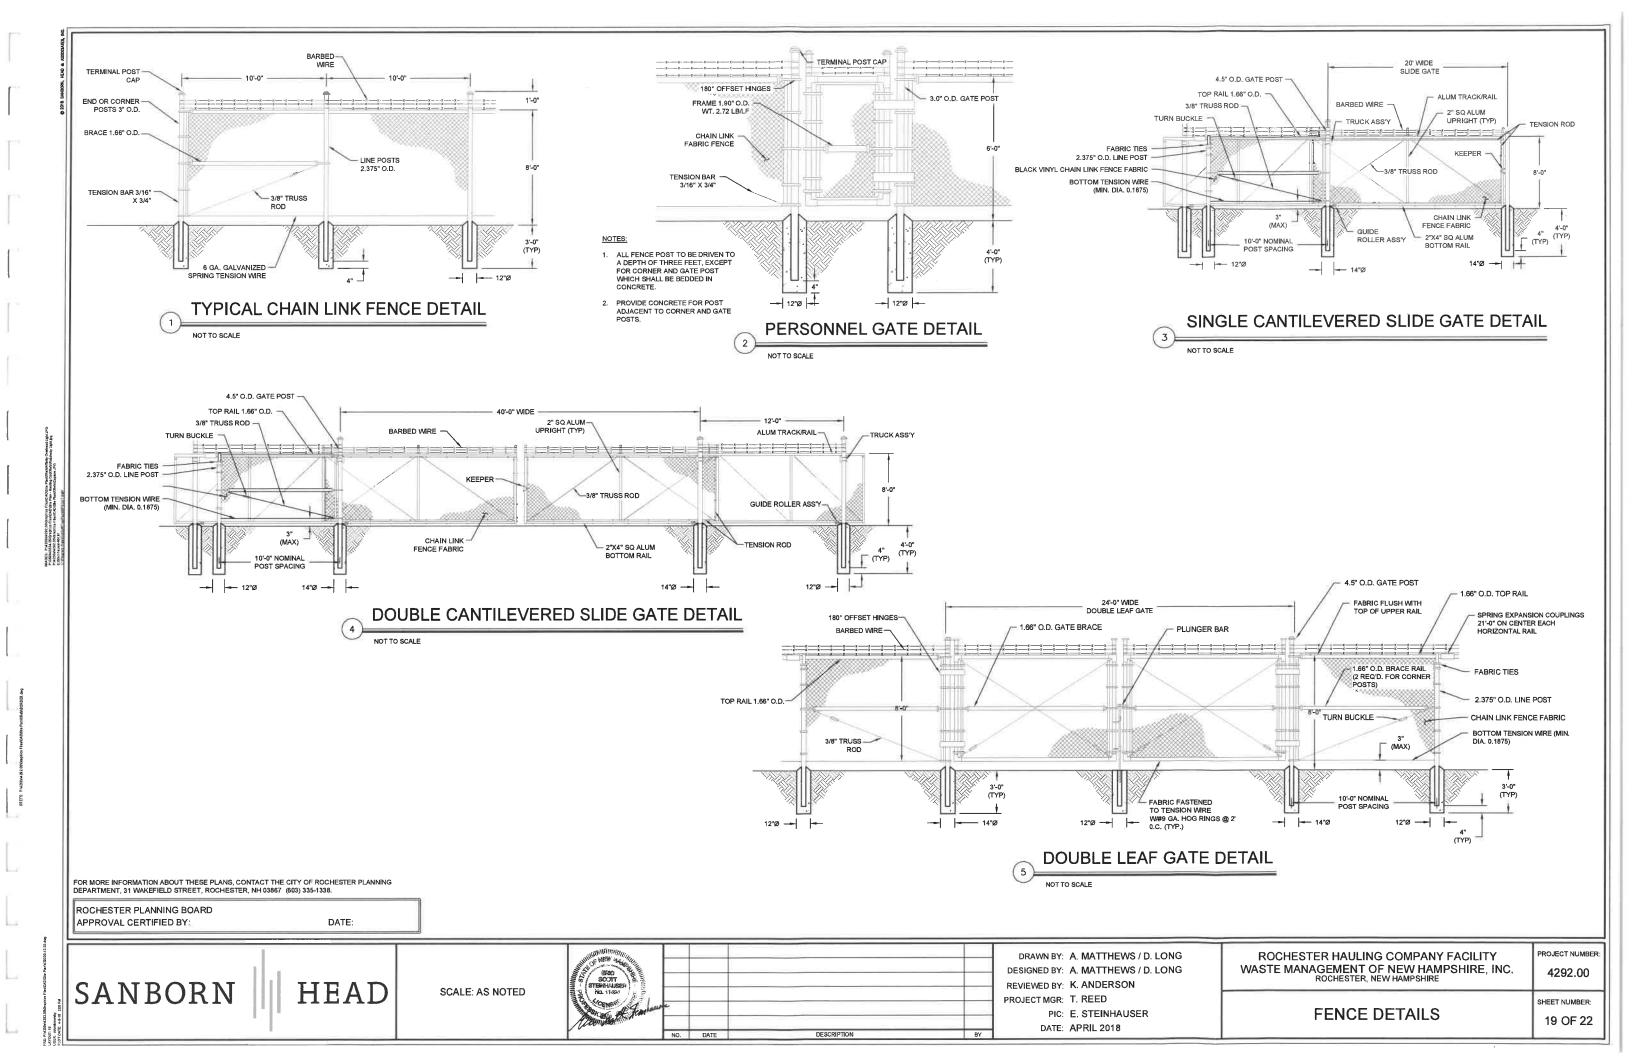


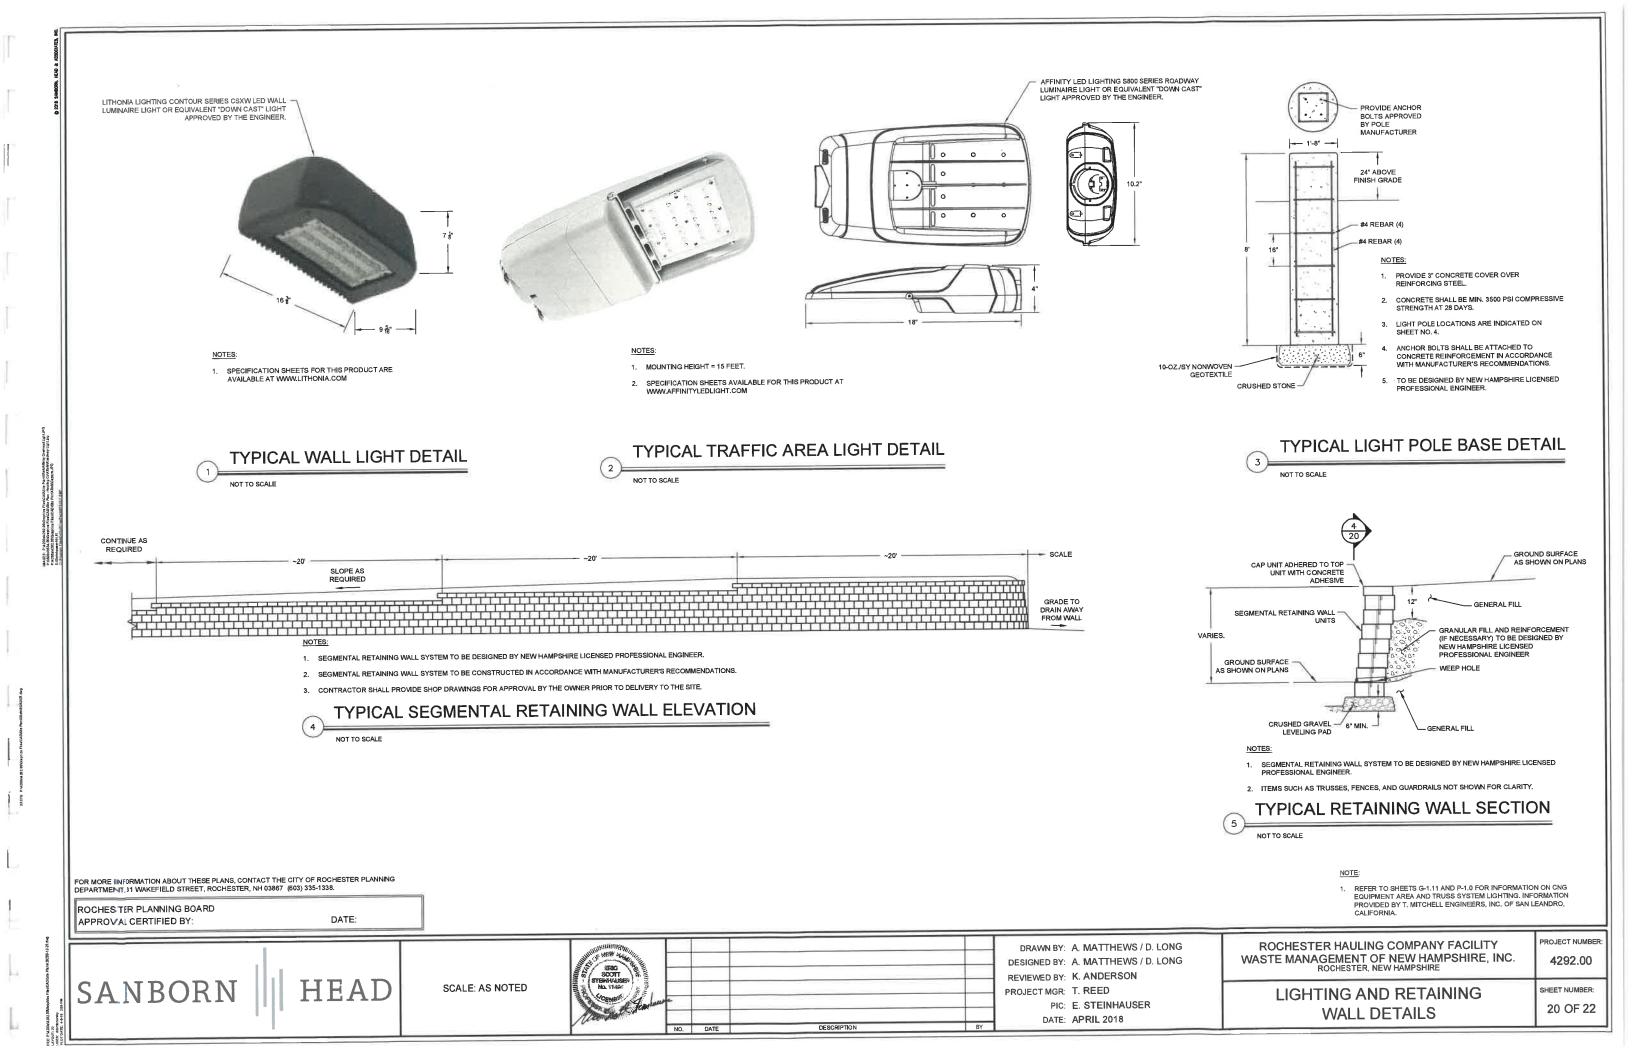


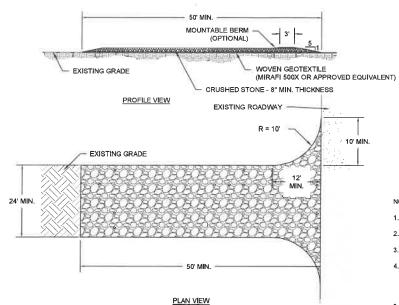

- 1. LENGTH NOT LESS THAN 50'.
- 2. THICKNESS NOT LESS THAN 8".
- 3. WIDTH NOT LESS THAN 24'.
- THE ENTRANCE SHALL BE MAINTAINED IN A CONDITION WHICH WILL IMIT TRACKING OR FLOWING OF SEDIMENT ONTO PUBLIC RIGHTS-OF-WAY. SEDIMENT SPILLED, DROPPED, WASHED, OR TRACKED ONTO PUBLIC RIGHTS-OF-WAY MUST BE REMOVED.
- 5. PERIODIC INSPECTION, AND MAINTENANCE IF REQUIRED, SHALL BE PROVIDED AFTER EACH RAIN EVENT.

## STABILIZED CONSTRUCTION ENTRANCE DETAIL

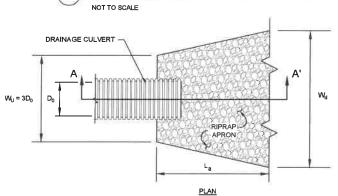

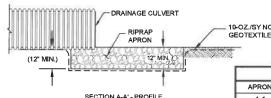

	RIPRAP OUTLET PROTECTION APRON SCHEDULE					
APRON	D <sub>0</sub> (ft)	W <sub>u</sub> (ft)	La (ft)	W <sub>d</sub> (ft)	RIPRAP TYPE	h (ir
A-1	1.50	4.50	10	11.50	TYPEI	12
A-2	1.50	4.50	10	11.50	TYPEI	12

## RIPRAP OUTLET PROTECTION APRON DETAIL


FOR MORE INFORMATION ABOUT THESE PLANS, CONTACT THE CITY OF ROCHESTER PLANNING DEPARTMENT, 31 WAKEFIELD STREET, ROCHESTER, NH 03867 (603) 335-1338.

ROCHESTER PLANNING BOARD

DATE:

SANBORN



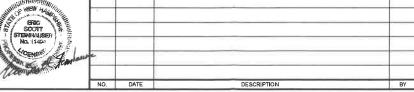

DRAWN BY: A. MATTHEWS / D. LONG

DESIGNED BY: A. MATTHEWS / D. LONG REVIEWED BY: K. ANDERSON

PROJECT MGR: T. REED

PIC: E. STEINHAUSER

DATE: APRIL 2018

# ROCHESTER HAULING COMPANY FACILITY WASTE MANAGEMENT OF NEW HAMPSHIRE, INC. ROCHESTER, NEW HAMPSHIRE

**EROSION AND SEDIMENTATION** 

SHEET NUMBER:

PROJECT NUMBER 4292.00


22 OF 22

<u>PLAN</u>

- FILTER SUPPORT FRAME SHALL BE CONSTRUCTED FROM STAINLESS STEEL TYPE 304.

1. FILTER INSERT SHALL HAVE A HIGH FLOW BYPASS FEATURE.

- POLLUTANT ABSORBENT POUCHES SHALL CONSIST OF FOSSIL ROCK AND SHALL BE INSTALLED AND MAINTAINED IN ACCORDANCE WITH MANUFACTURER SPECIFICATIONS.
- STORAGE CAPACITY REFLECTS 80% OF MAXIMUM SOLIDS COLLECTION PRIOR TO IMPEDING FILTERING BYPASS.

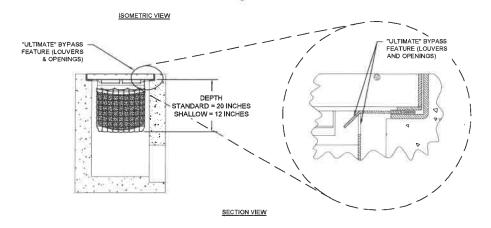

## CATCH BASIN SILT SOCK DETAIL

"ULTIMATE" BYPASS

POUCHES


LINER

SUPPORT BASKET

CATCH BASIN (FLAT GRATE STYLE)

SCALE: AS NOTED

**CONTROL DETAILS** 

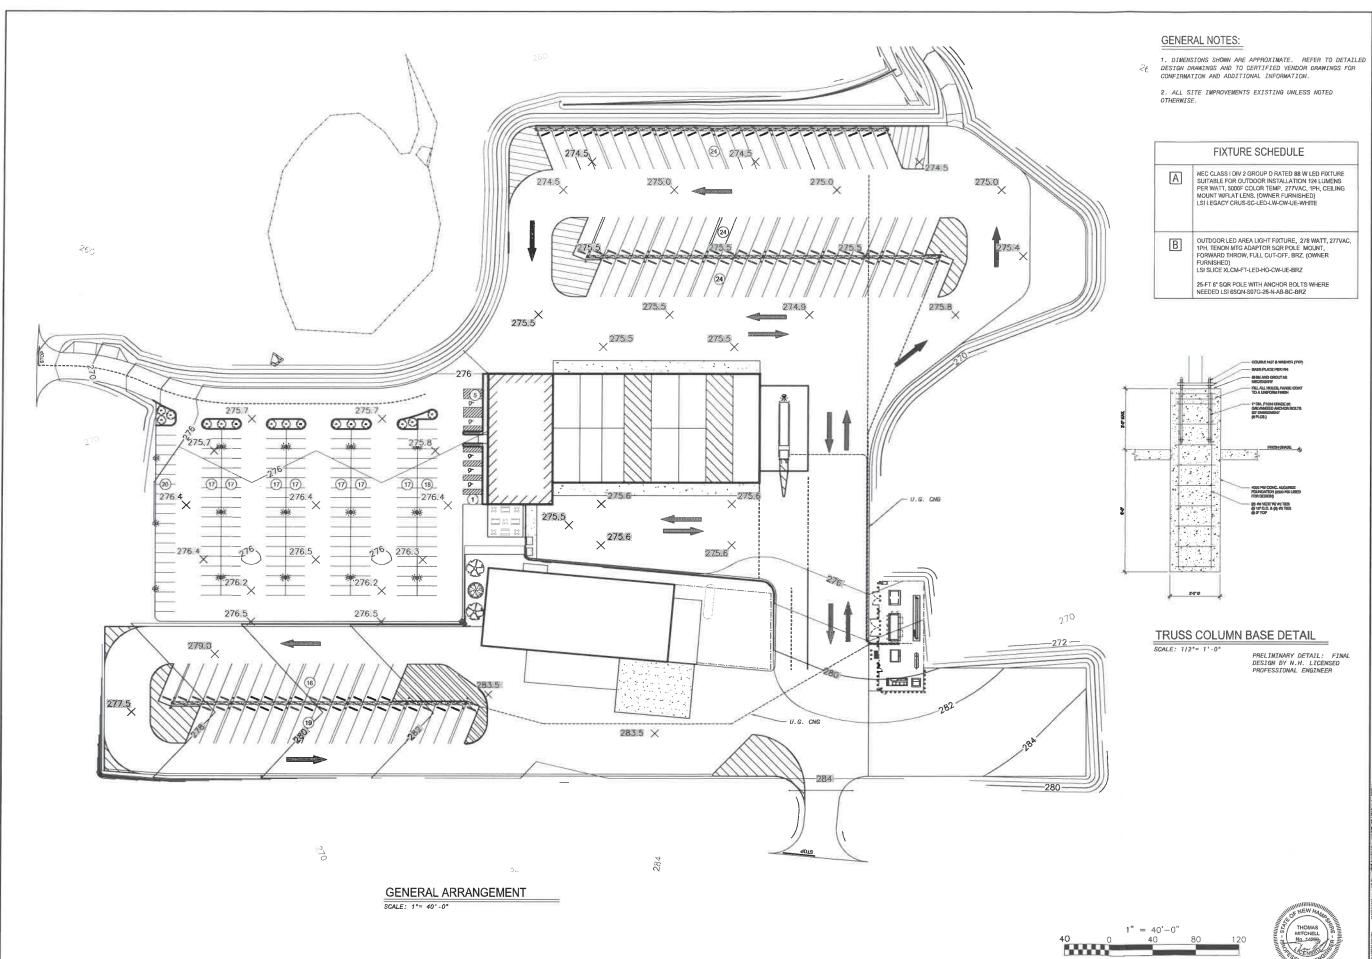



CONSULTANT:

T. MITCHELL INCOMPERS &
Professional Engineers and Cerebilitate

1220 Aborder Demo
Sen London CA 94377

Flows 507774633

Be 4067774617

CLIENT;



SHIRE, INC. TEM IRE

GENERAL ARRANGEMENT
WASTE MANAGEMENT OF NEW HAMPSHIRE,
CNG VEHICLE FUELING SYSTEM
ROCHESTER, NEW HAMPSHIRE

REVISIONS: SET ISSUE: DATE: 0 FOR REVIEW


DATE: 03/27/18

PROJECT #: |1810

DRAWN BY: | TM

CHECKED BY:
APPROVED BY:
FILENAME: |G-1.10 REVOC.dv

G-1.10

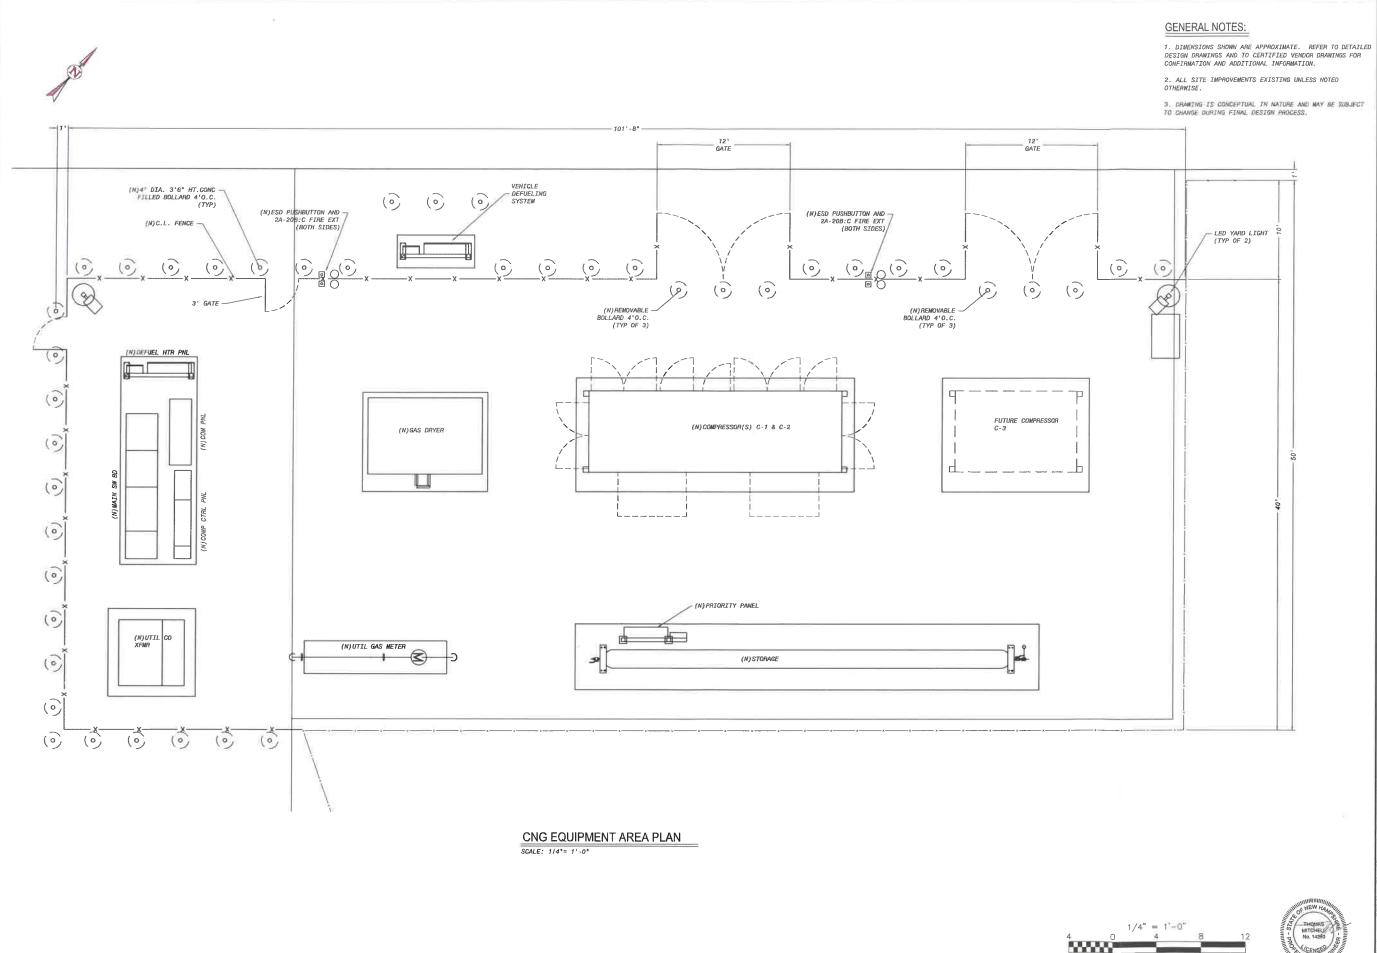



CONSULTANT:

T. MITCHELL ASSOCIATES

Prodesired Engineers of Complians

(220 Feather Septement Complians

6 Feather Septement Complians

fact (10) 777-6235

fact (10) 777-6235

CLIENT:




GENERAL ARRANGEMENT - EQUIP COMPOUND
WASTE MANAGEMENT OF NEW HAMPSHIRE, INC.
CNG VEHICLE FUELING SYSTEM
ROCHESTER, NEW HAMPSHIRE

	VISIONS:	
	T ISSUE:	DATE:
0	FOR REVIEW	-
4		_
4		-
4		-
4		-
4		
4		1
4		
4		
_		
⊒		
I		
T		
$\neg$		
$\exists$		

DATE: 03/27/18

PROJECT #: 1810
DRAWN BY:
CHECKED BY:
APPROVED BY:
FILENAME: G-1.11 REV0.dw

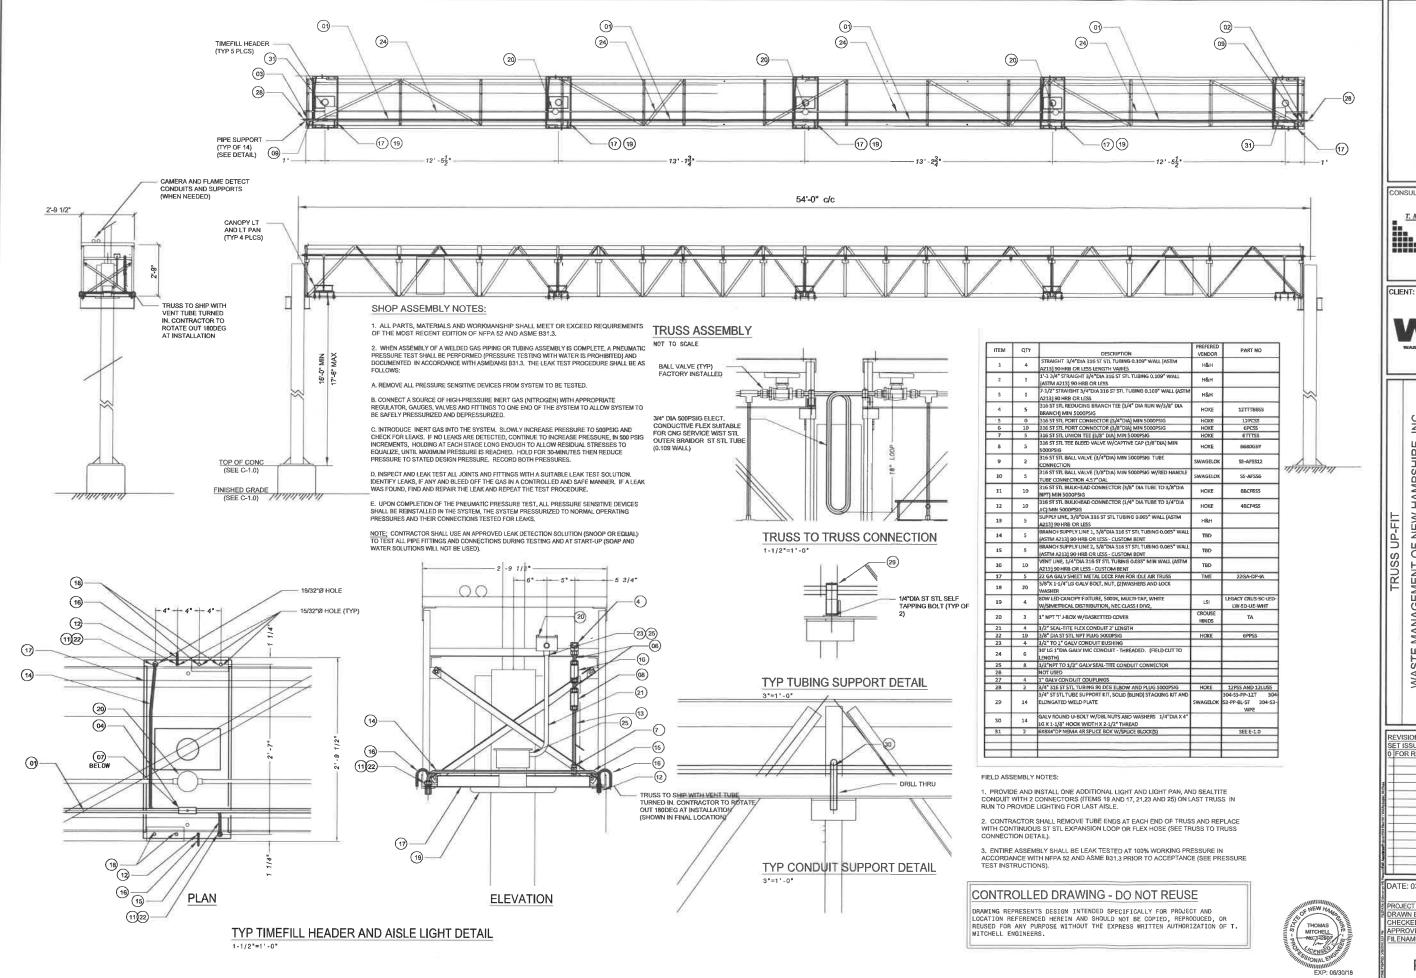

CONSULTANT

T. MITCHELL ENGINEERS & Plane: 569-777-0526 Sec: 569-777-0528




T OF NEW HAMPSHIRE FUELING SYSTEM 7, NEW HAMPSHIRE MANAGEMENT C CNG VEHICLE F ROCHESTER, N WASTE

REVISIONS: SET ISSUE: FOR REVIEW

DATE: 03/27/18

ROJECT #: 1810 DRAWN BY: TM
CHECKED BY:
APPROVED BY:
FILENAME: P-1.0 Rev0.dwg

P-1.0

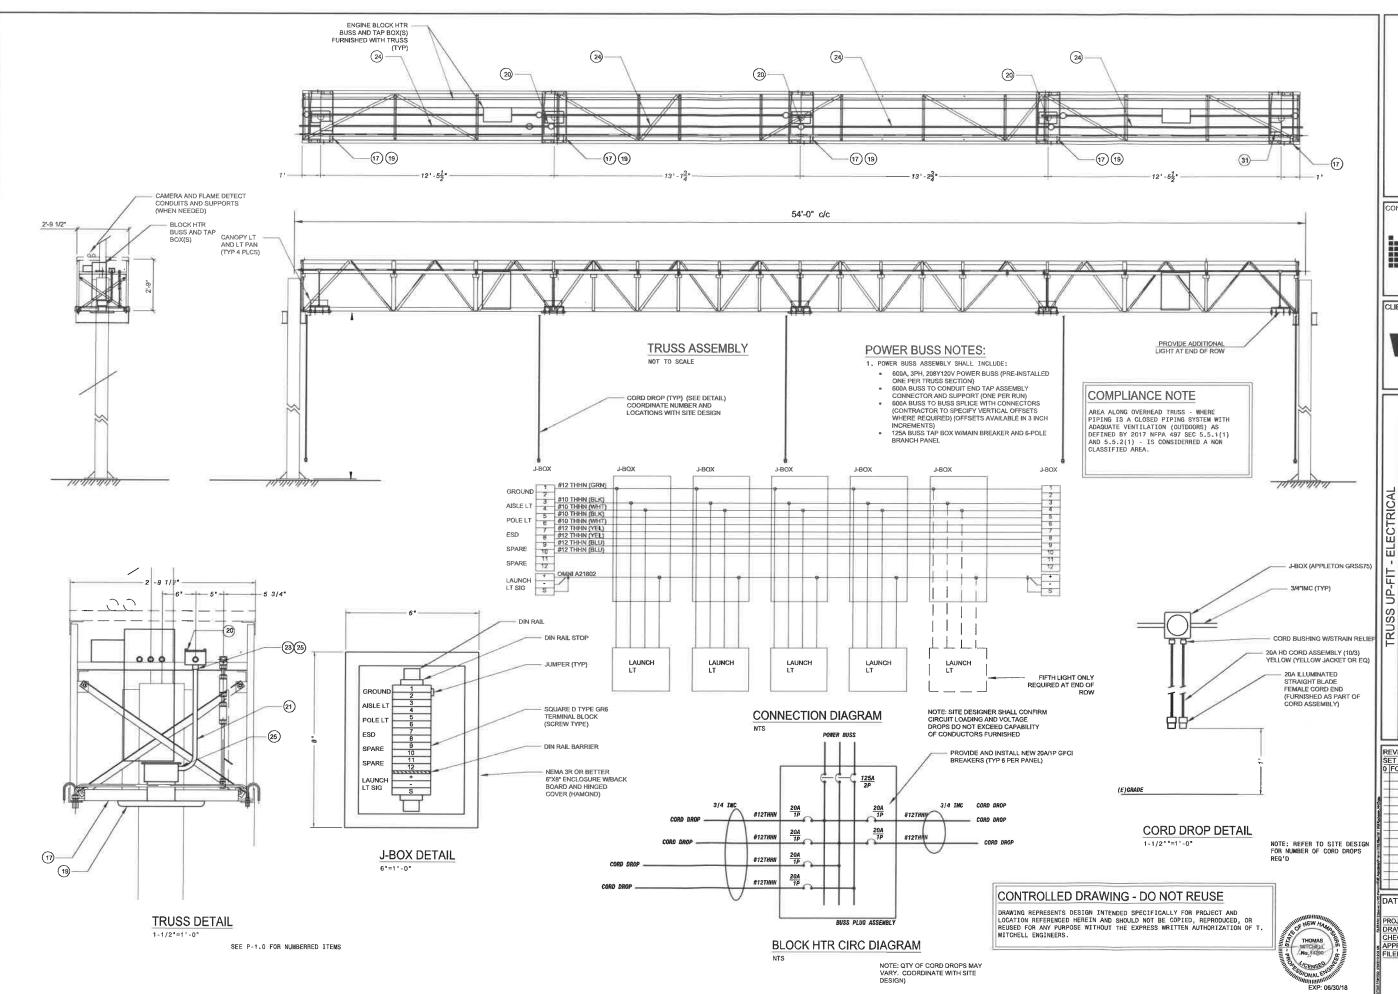

THE USE OF THESE DRAWINGS AND SPECIFICATIONS SHALL BE RESTRICTED TO THE ORIGINAL USE FOR WHIGH THEY WHER PERSARED, RELEASED, REPRODUCTION, WODERCANDON OR PUBLICATION, IN WHOLE, ROUNDERS, INC. SPROHINTED WITHOUT THE WRITTEN CONSENT OF THE WASTE MANAGENERI.

CONSULTANT:

T. MITCHELL PROGRESS

Préssival Epipers and Cressions

La State La Service

Service La Service La

CLIENT:



WASTE MANAGEMENT OF NEW HAMPSHIRE, INC. CNG VEHICLE FUELING SYSTEM ROCHESTER, NEW HAMPSHIRE

REVISIONS: SET ISSUE: DATE: 0 FOR REVIEW

DATE: 03/27/18

PROJECT #: 1810
DRAWN BY: TM
CHECKED BY:
APPROVED BY:
FILENAME: E-1.0 Rev0.dwg

E-1.0



