BIRCHWOOD PONDS RESIDENTIAL DEVELOPEMENT CHESLEY HILL ROAD

CIVIL ENGINEERS:

BEALS · ASSOCIATES PLLC

70 PORTSMOUTH AVE, STRATHAM, N.H. 03885 PHONE: 603-583-4860, FAX. 603-583-4863




LAND SURVEYORS:



WETLAND / SOIL CONSULTANT:

GOVE ENVIRONMENTAL SERVICES INC. 8 CONTINENTAL DRIVE, BLDG 2 UNIT H EXETER, NH 03833 1-603-778-0644

LOCATION MAP

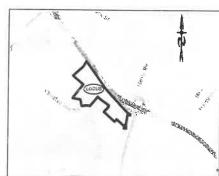

1"=2000'

PLAN SET LEGEND

UTILITY POLE SINGLE POST SIGN PINES, ETC. MAPLES, ETC. EXIST. SPOT GRADE PROP. SPOT GRADE TEST PIT FENCING 4000 SF SEPTIC

| ь | DRAINAGE L |
|---------|-------------|
| | EX. WATERW |
| * | UNDERGROU |
| Ca | STONE WALL |
| 96x69 | TREE LINE |
| (95:69) | ABUT. PROP |
| PAIA | EXIST. PROF |
| x | BUILDING SE |
| | EXIST. CONT |
| | PROP. CONT |
| | SOIL LINES |

PERTY LINES -----

INDEX

| 1-6 |
|---------|
| 7-13 |
| 14 - 17 |
| 18 |
| 19 - 25 |
| 25A-25E |
| 26-33 |
| 34 |
| 35 - 36 |
| 37 |
| 38 |
| |


OWNER OF RECORD & APPLICANT

MAKRIS R.E. DEVELOPMENT, LLC 11 WENTWORTH TERRACE DOVER, NH 03820 TM 137, LOTS 09 & 10

REQUIRED PERMITS

NOI - NPDES APPROVAL NUMBER: NHR... NHDES WETLAND PERMIT NUMBER: WPS ... NHDES SUBDIVISION APPROVAL NUMBER: \$42017. NHDES ALTERATION OF TERRAIN APPROVAL NUMBER: Act..

| | REVISIONS: | DATE: |
|---|-----------------------------|---------|
| 1 | REVISED ROAD PER TRG | 2/2/17 |
| 2 | REVISED PER REVIEW COMMENTS | 3/14/17 |
| 3 | REVISED PER REVIEW COMMENTS | 4/17/17 |
| 4 | REVISED PER REVIEW COMMENTS | 5/24/17 |
| 5 | REVISED PER REVIEW COMMENTS | 6/27/17 |
| 6 | REVISED PER REVIEW COMMENTS | 9/18/17 |

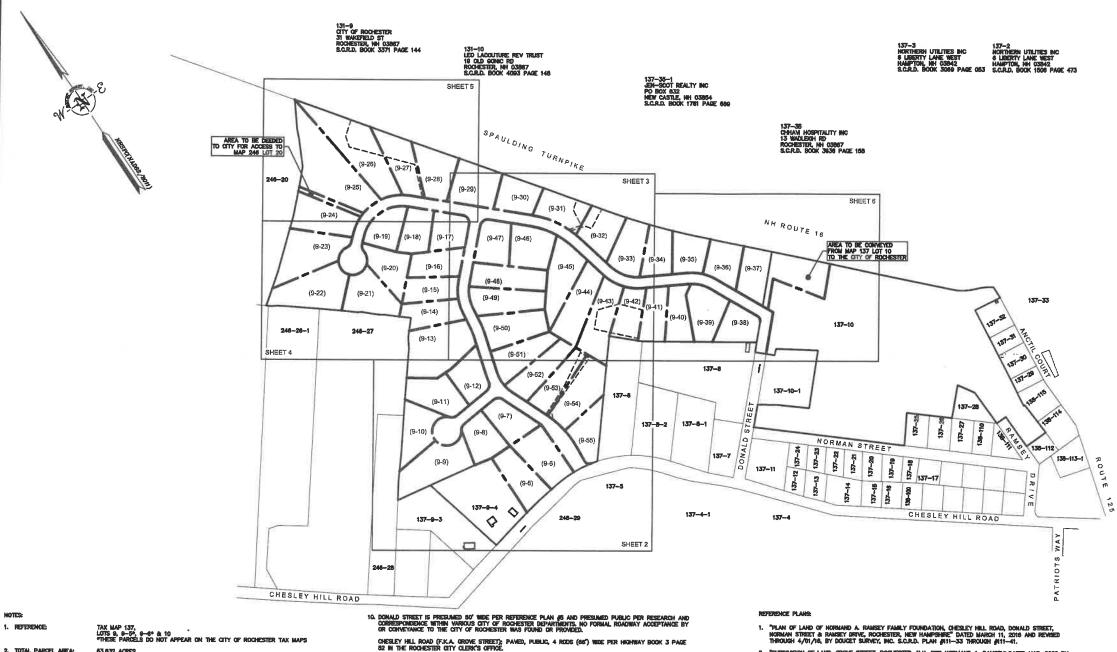

2. TOTAL PARCEL AREA:

3. OWNER OF RECORD:

MAKRIS REAL ESTATE DEVELOPMENT, LLC 11 WENTWORTH TERRACE DOVER, NH 03820 S.C.R.D. BOOK 4371, PAGE 184

4. ZONE: RESIDENTIAL 1 DMFNSIONAL REQUIREMENTS:

REFER TO CITY OF ROCHESTER ZONING ORDINANCE SECTION 42.12 ARE SHOWN HEREON, REFER TO ENGINEERING PLANS FOR SEPTIC SETBACKS

- FIELD SURVEY PERFORMED BY JULL. & L.P.S. DURING JAN. & FEB. 2016 USING A TRIMBLE 8803 TOTAL STATION WITH A TRIMBLE TSCS DATA COLLECTOR. TRAVERSE ADJUSTMENT BASED ON LEAST SQUARE ANALYSIS
- B. FLOOD HAZARD ZONE: "X". PER FIRM PANEL #33017002110, DATED MAY 18, 2005.

- THE BOUNDARY LINE ADJUSTMENT BETWEEN MAP 137 LOT 9 AND MAP 137 LOT 9—4 AS SHOWN ON REFERENCE PLAN 2 HAS NOT BEEN CONSUMBLATED AS OF THE DATE OF THIS PLAN. AS A PART OF THIS PLAN. A PORTION OF LAND IS TO BE CONVEYED TO LOT 9—4 AS SHOWN MEREON TO FULFILL A VERBAL AGREEMENT BETWEEN OWNERS DURING THE CREATION OF SAID REPERENCE PLAN.


| APPROVED | BY THE | ROCHESTER | PLANNING | BOARD ON | DATE |
|-----------|--------|-----------|----------|----------|------|
| SIGNED BY | NAME | | | POSITION | |

- JURSDICTIONAL WETLANDS DELINEATED BY GOVE ENVIRONMENTAL SERVICES, INC. DURING DECEMBER 2015 IN ACCORDANCE WITH 1987 CORPS OF ENGINEERS WETLANDS DELINEATION MANUAL, TECHNICAL REPORT Y—87—1
- 13. SITE SPECIFIC SOIL SURVEY WAS PRODUCED MARCH 8, 2018 BY JAMES GOVE, CSS (1004. FIELD WORK WAS CONDUCTED NOVEMBER AND DECEMBER 2015 AND JANUARY 2016.
- 18. SUBDIVISION APPROVIAL WHETHER OR NOT OTHERWISE EXPRESSLY RECITED ON THE SUBDIVISION PLAN, THE SUBDIVISION PARKY REAL PROPERTY OF THE OWNER, AS INDIVIDED ON FAITHFUL AND DELICENT ASMEDIED SO THE CITY OF ROCKESTE LAND SUBDIVISION REQULATIONS AS AMERICADED OR REAL MEMBELD. IN FIRST OF THE DATE OF APPROVAL, UALESS OR EXPRESSOR AS AS EXPRESSLY WAYED, IN ANY PARTICULAR, BELOW, NON-AUTREPACK MAY RESULT IN A REVOCATION OF APPROVAL ANY VARIATION FROM THE APPROVED PLAN WILL RECURRE A RESULTINGS.
- 16. PRELIMINARY TEST PIT DATA REVEALS THAT SEVERAL LOTS ARE LOCATED ON LAND THAT HAS ESTIMATED SEASONAL HIGH WATER TABLES WITHIN 24" OF THE SURFACE. THE TEST PIT LOCATIONS AND DATA ARE ON PILE AT THE ROCHESTER PLANNING DEPARTMENT. IT IS ADVISED THAT POTENTIAL HOME/LOT PURCHASERS REVIEW THIS MATERIAL.

- A. LOTS 9-25 THROUGH 9-37 RESIDENTIAL BUILDINGS SHALL HAVE STONE TRENCHES FOR ROOF RUNOFF MITIGATION (SEE DETAIL SHEET 17).
- C. REMOVE AND DISPOSE OF SEDIMENTS OR DEBRIS AS NEEDED.
- D. TOTAL REHABILITATION OF A DRIP EDGE SHOULD BE CONDUCTED TO MAINTAIN STORAGE CAPACITY WITHIN 2/3 OF THE DESIGN VOLUME AND 72—HOUR EXPILITATION RATE LIMIT.
- E. TRENCH WALLS SHOULD BE EXCAVATED TO EXPOSE CLEAN SOIL UPON FAILURE, AND THE SOIL SCARFED PRIOR TO REPLACEMENT OF CLEAN STONE.

- B. THERE IS A PROPOSED 20' WIDE GRADING AND UTILITY EASEMENT THAT IS TO RUN ALONG THE FRONTAGE OF THE PROPOSED ROAD AND BE BINDING ON EACH OF THE PROPOSED LOTS.

- "SUBDIVISION OF LAND, GROVE STREET, ROCHESTER, N.H. FOR NORMAND A. RAMSEY DATED MAR. 2000 BY NORMAY PLANS ASSOCIATES, INC. S.C.P.D. PLAN (81—10.
- "STATE OF NEW HAMPSHIRE DEPARTMENT OF TRANSPORTATION RIGHT OF WAY PLANS INI PROJECT NO. 10020-D SPAULDING TURNPIKE NIN ROUTE 16" DATED JANUARY 11, 2011, S.C.R.D. PLAN #101-001.
- 4. "PLAN OF PROPOSED LS 1828 (1) N.H. NO. P-2882-T SPAULDING TURNPIKE" DATED 1985. ON FILE THROUGH THE INDOOT ONLINE PROJECT VIEWER,
- "Subdivision of Land, donald street, rochester, n.h. for norman a. Ramsey" dated june 1995 by Norway Plans associates, NC. S.Cr.D. Plan #47—17.

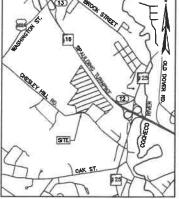

LOCATION MAP (1" = 1,000')

LEGEND

OSTOCKUE PERCE

- CHAIN LINK FENCE

BOUND FOUND

DRILL HOLE POUND

RON PIPE/ROD FOUND

4"X4" GRANTE BOUND TO BE SET

5/8" REBAR W/ ID CAP TO BE SET PENCE POST WOOD POST TREE STUMP COMPERCUS TREE DECEDUOUS TREE CONCRETE
BOUND FOUND
DRILL HOLE SET
RON PPE FOUND
RON ROD SET
EDGE OF PAVEMENT
EDGE OF GRAVEL
WITH BARBED WITE
ROW HAMP-SHIPE HIGHWA
TAX MAP & LOT NUMBE CONC. BND. FND. D.H.S. I.P.F. I.R.S. EP EOG W/BW N9HB 137-33



SUBDIVISION PLAN BIRCHWOOD PONDS RESIDENTIAL DEVELOPMENT LAND OF

MAKRIS REAL ESTATE DEVELOPMENT, LLC

TAX MAP 137, LOTS 9, 9-5, 9-6 & 10 CHESLEY HILL ROAD & DONALD STREET ROCHESTER, NEW HAMPSHIRE

| 4 | 1 | | |
|-----|----------|-----------------------------|------|
| 3 | 09/19/17 | REVISED PER T.R.G. COMMENTS | JFK |
| 2 | 05/25/17 | REVISED PER T.R.O. COMMENTS | MITA |
| 1 | 02/10/17 | REVISED LOT LINES | MYL |
| NO. | DATE | DESCRIPTION | BY |

| DRAWN BY: M.T.L. DAT | | DATE: JANUARY 9, 2017 |
|----------------------|--------|-----------------------|
| CHECKED BY: | J.F.K. | DRAWING NO.; 4380F |
| JOB NO.: | 4380 | SHEET OF 13 |





Serving Your Professional Surveying & Mapping Needs 102 Kent Place, Newmarket, NH 03857 (503) 659-6560 Commerce Drive (Sulta 202) Bedford, NH 03110 (503) 614-4060 0 Storer Street (Riverview Sulta) Kennebunk, ME (207) 502-7005 http://www.doucetsurvey.com


SHEETS 7-13 NOT FOR RECORDING


DATE


CERTIFICATIONS SHOWN HEREON ARE INTENDED TO MEET REGISTRY DEED REQUIREMENTS AND ARE NOT A CERTIFICATION TO TITLE OR EXISTS OF PROPERTY SHOWN, DWINERS OF ABJORNING PROPERTIES ACCORDING TO CURRENT TOWN ASSESSORS RECORDS.

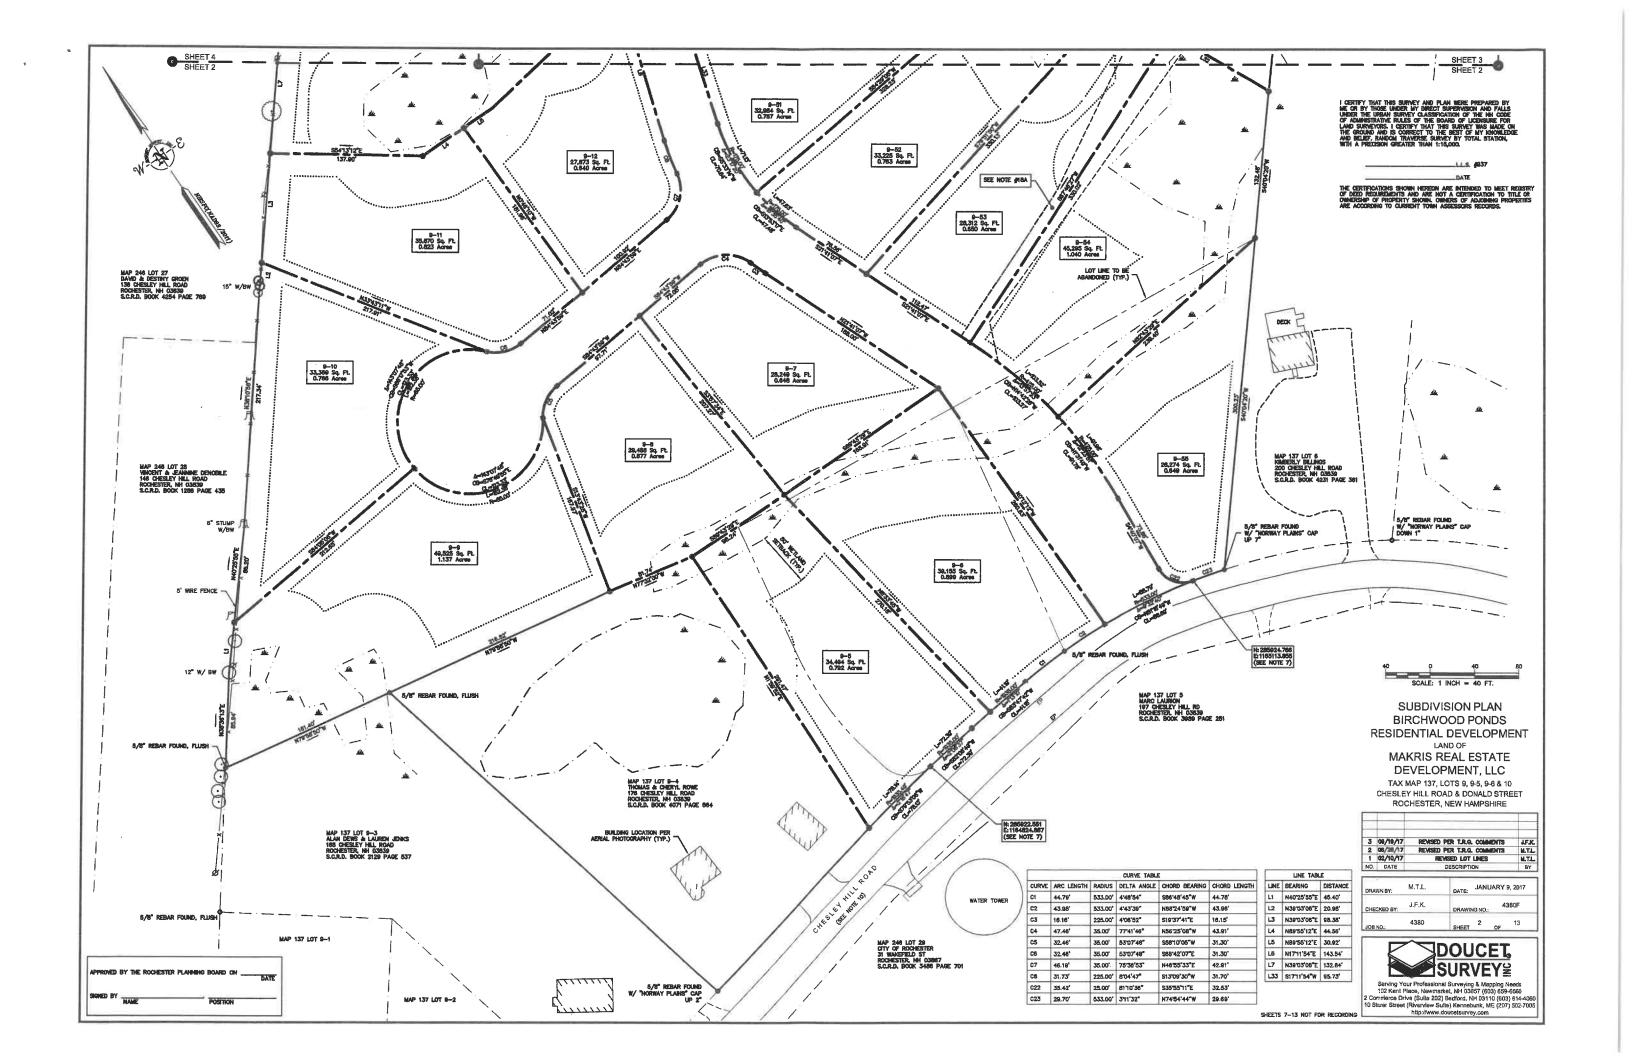

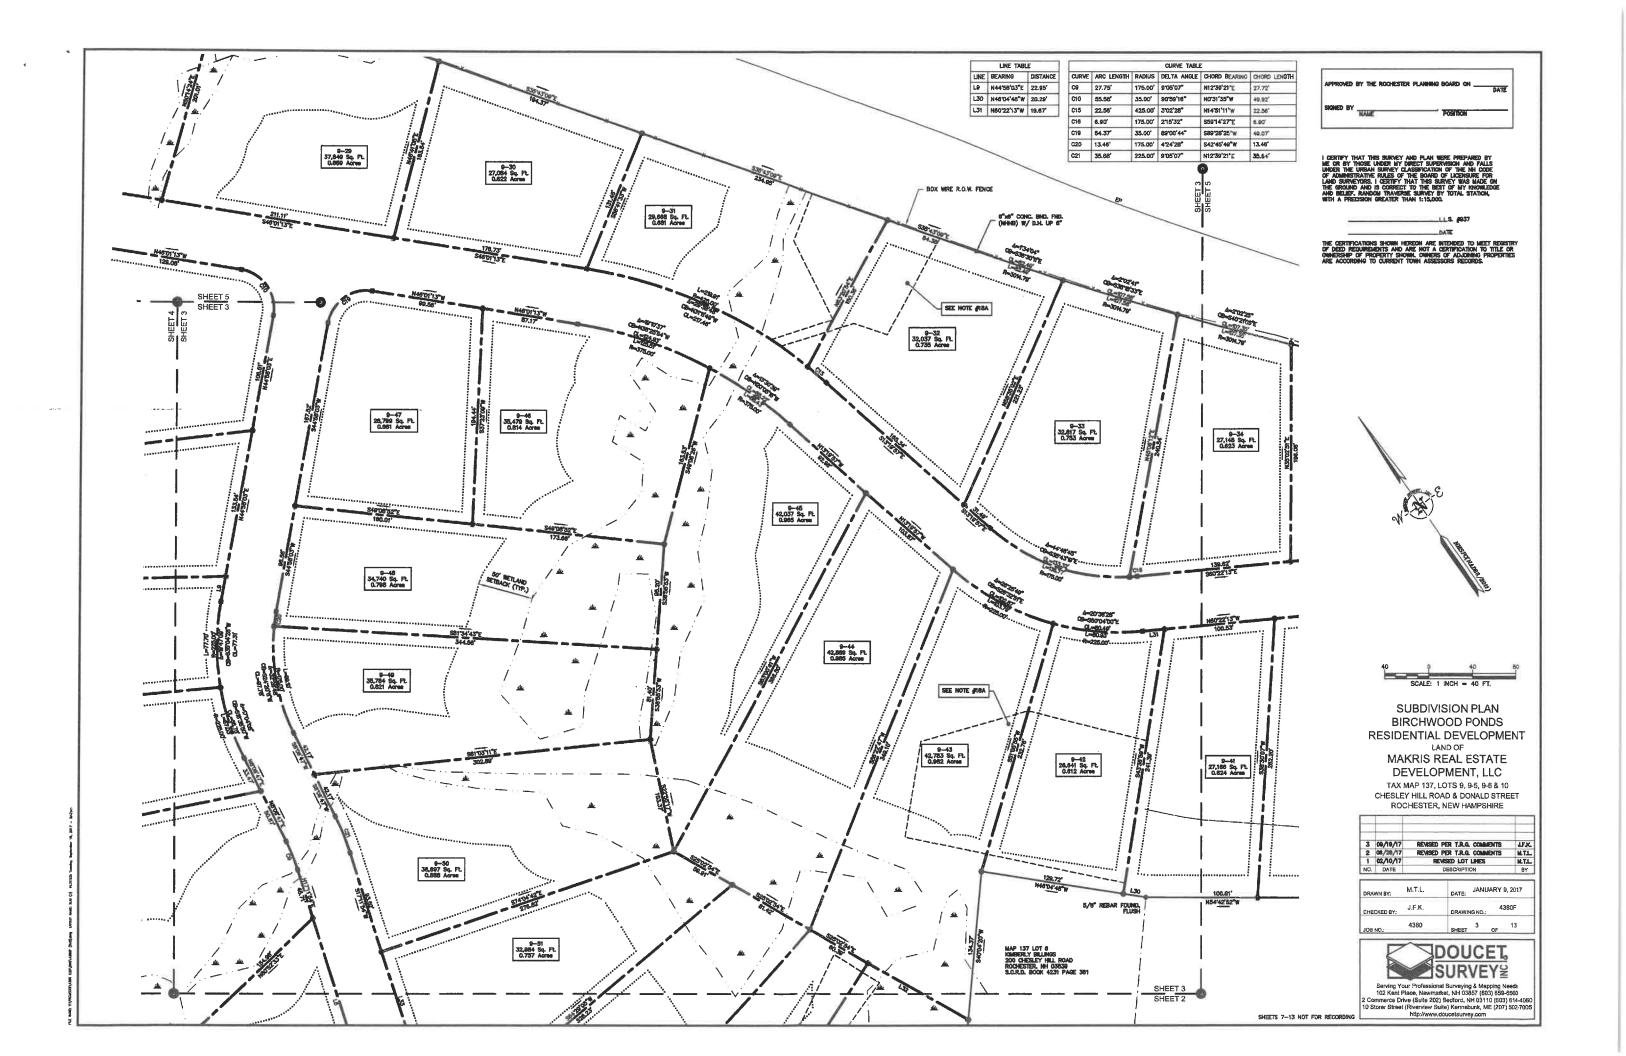

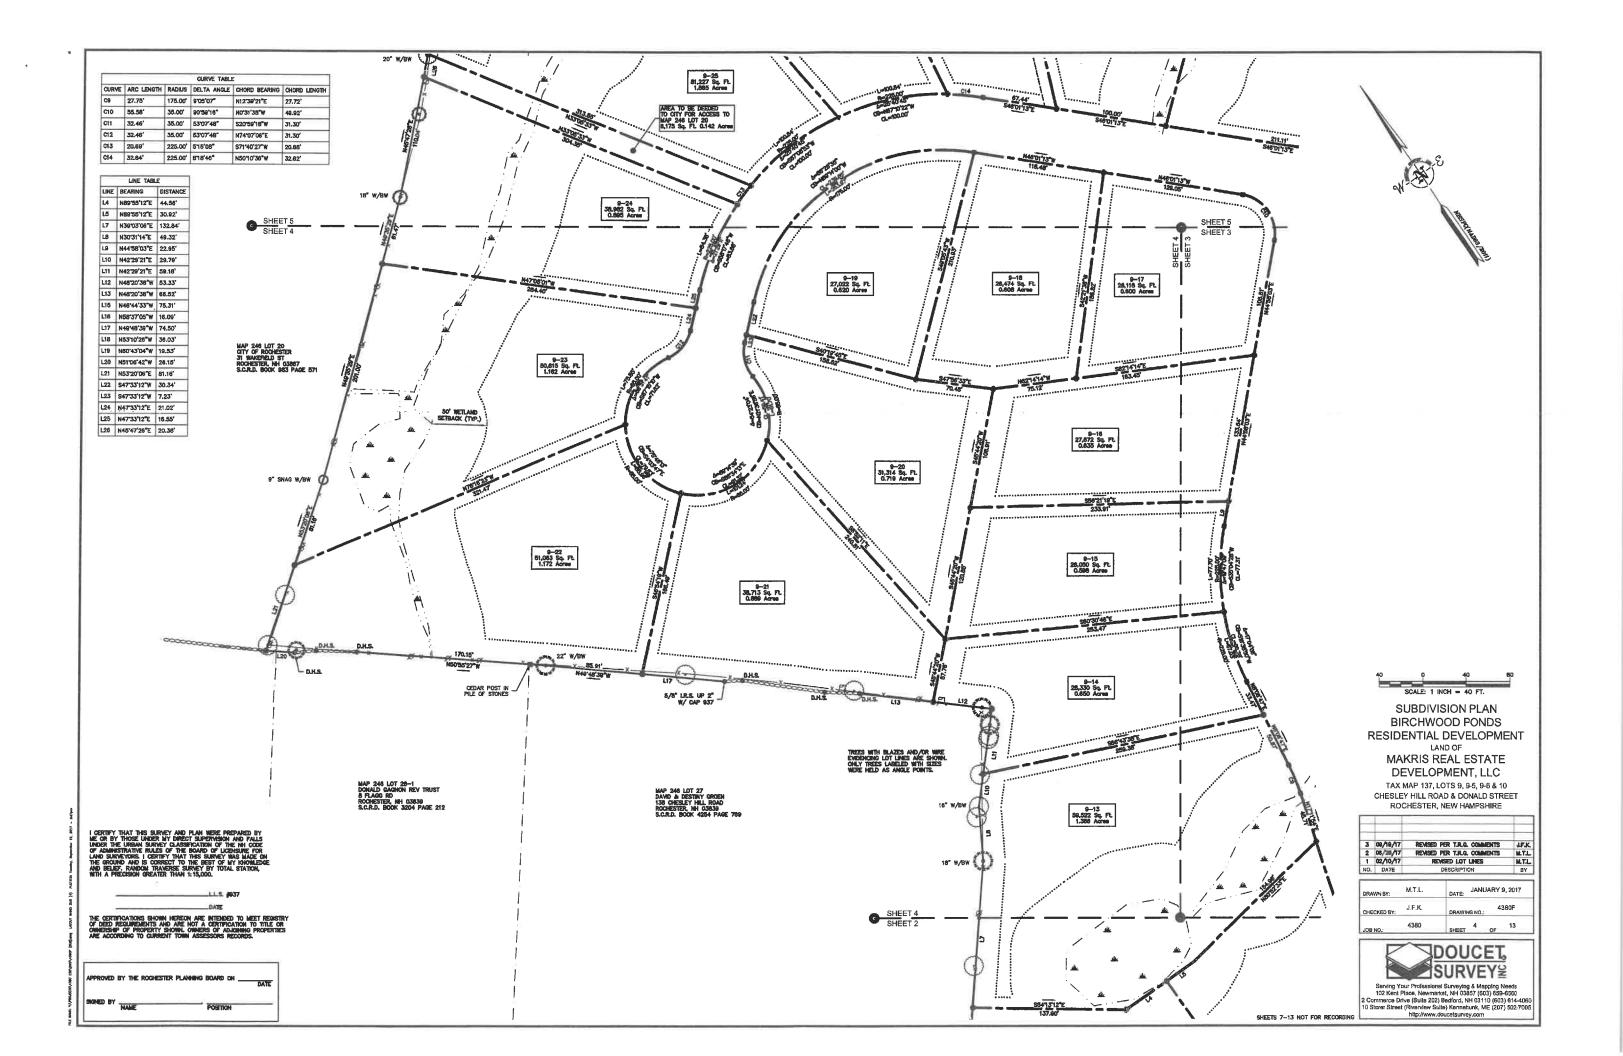

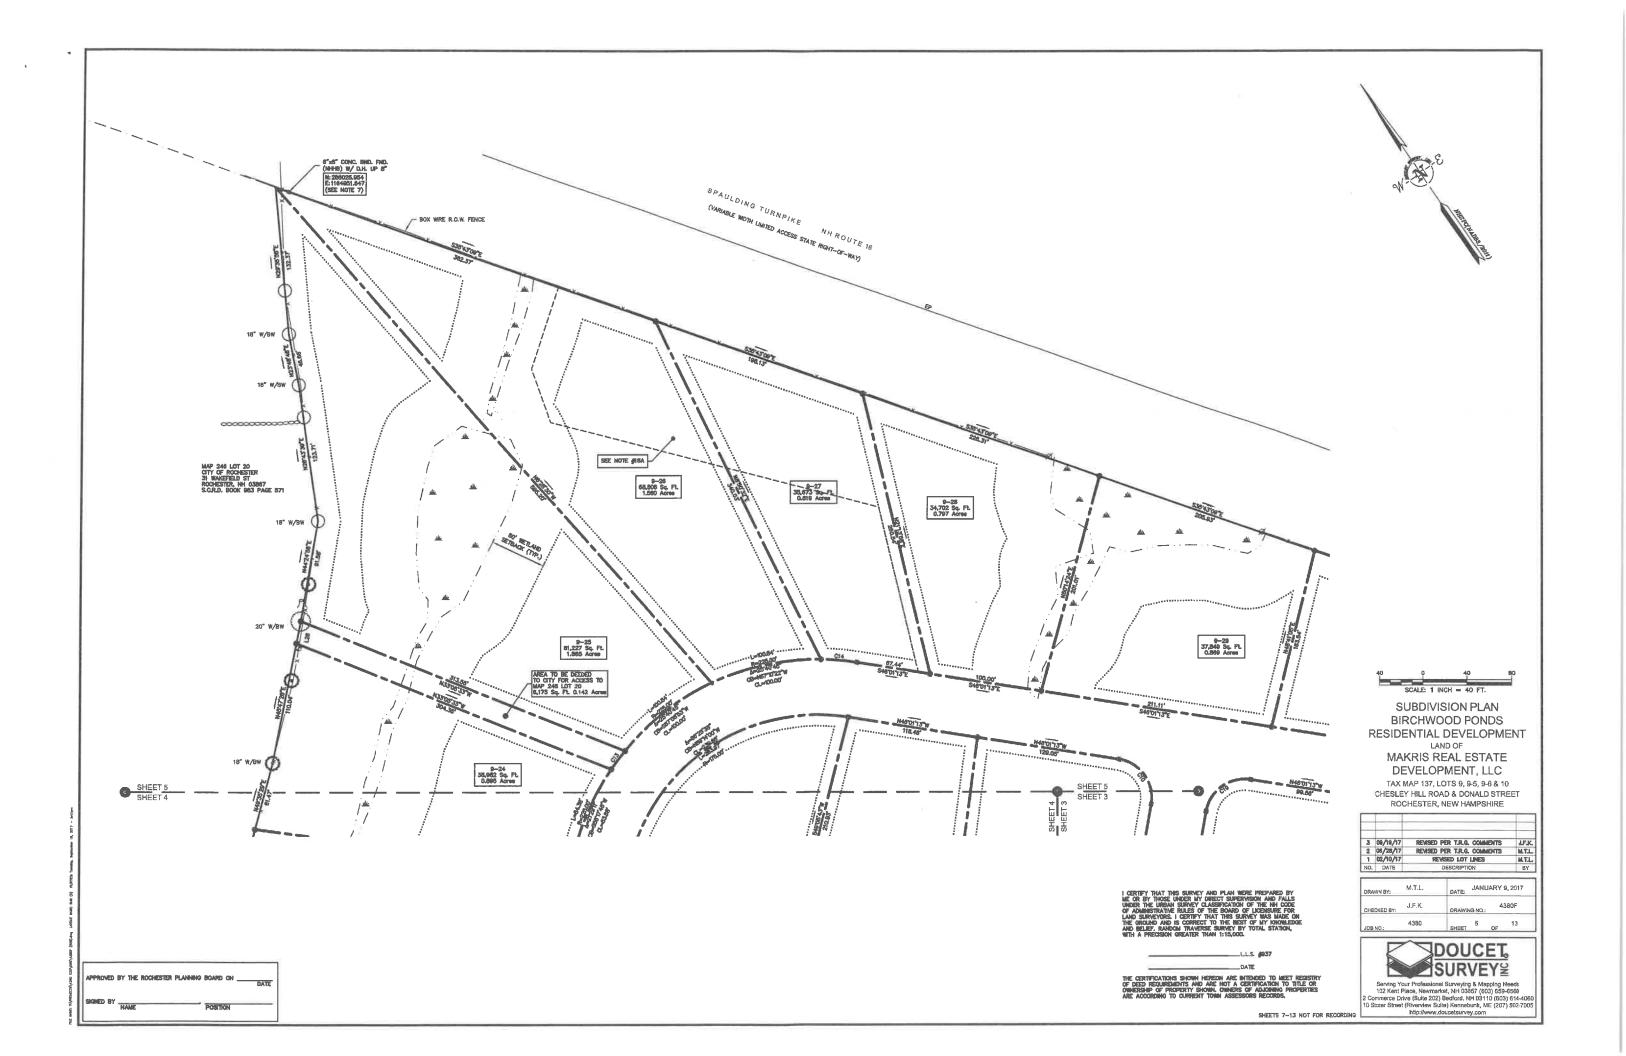

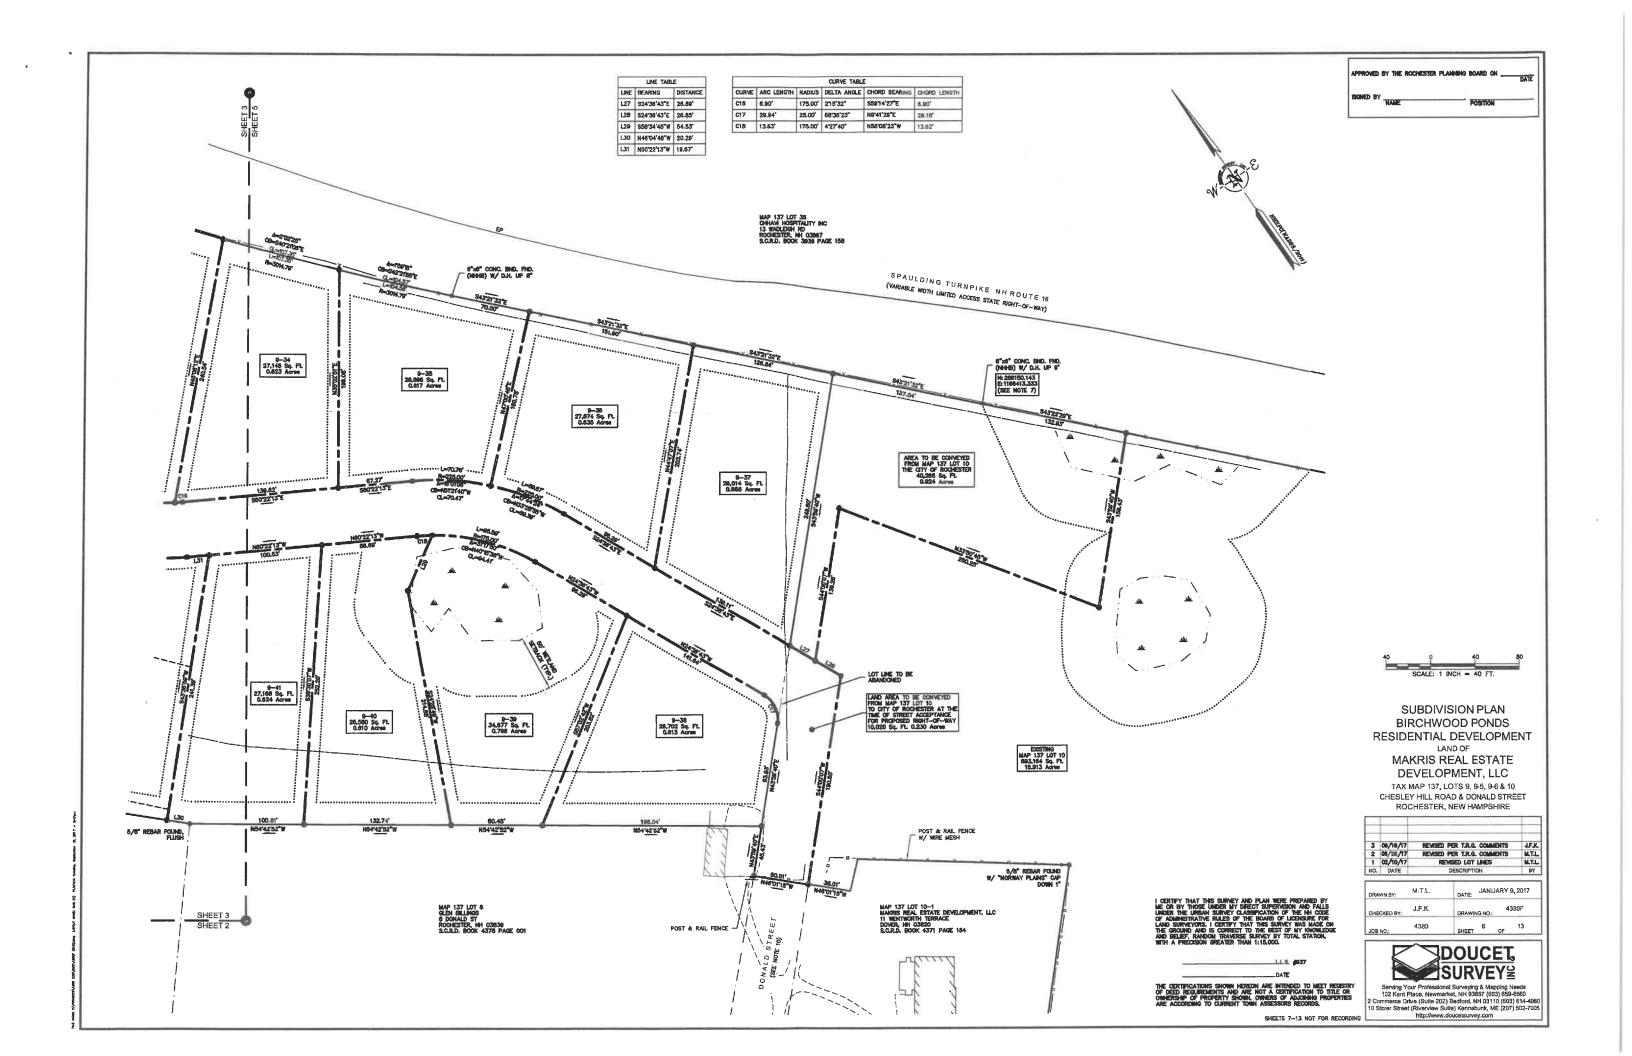



1. REFERENCE:

TAX MAP 137, LOTS 9, 9-5°, 9-8° & 10 *THESE PARCELS DO NOT APPEAR ON THE CITY OF ROCHESTER TAX MAPS

2. TOTAL PARCEL AREA: 63.832 ACRES

3. OWNER OF RECORD:

MAKRIS REAL ESTATE DEVELOPMENT, LLC 11 WENTWORTH TERRACE DOVER, NH 03820 S.C.R.D. BOOK 4371, PAGE 184

4. ZONE: RESIDENTIAL 1
DIMENSIONAL REQUIREMENTS:

MIN. LOT AREA MIN. FRONTAGE MIN. FRONT SETBACK MIN. SIDE SETBACK MEN. REAR SETBACK MAX. BUILDING HEIGHT WETLAND SETBACKS

10,000 sq.ft.
100 ft.
10 ft.
10 ft.
20 ft.
35 ft.
REPER TO CITY OF ROCHESTER ZOMING ORDINANCE SECTION 42.12

- FIELD SURVEY PERFORMED BY J.M.L. & L.P.S. DURING JANUARY & FEBRUARY, 2016 USING A TRIMBLE 5603 TOTAL STATION WITH A TRIMBLE 15C3 DATA COLLECTOR. TRAVERSE ADJUSTMENT BASED ON LEAST SQUARE ANALYSIS.
- 6. FIELD SURVEY PERFORMED BY J.F.K. DURING DECEMBER 2015 USING A TRIMBLE PRO XR SUB METER RES UNIT WITH A RECON AND/OR A TSC-1 DATA COLLECTOR. ACCURACY UNDER IDEAL CONDITIONS IS +/- 5 FEET. ANY METLAND FLASS NEAR PROPOSED DEVELOPMENT NEED TO BE CONVENTIONALLY SURVEY LOCATED PRIOR TO FINAL DESIGN AND/OR CONSTRUCTION.
- FIELD SURVEY PERFORMED TO ESTABLISH HORIZONTAL DATUM AND AERIAL CONTROL BY E.J.S. DURING DECEMBER 2018 USING A TRIMBLE R8 SURVEY GRADE GPS UNIT WITH A TRIMBLE TSC3 DATA COLLECTOR.
- JURISDICTIONAL WETLANDS DELINEATED BY GOVE ENVIRONMENTAL SERVICES, INC. DURING DECEMBER 2015 IN ACCORDANCE WITH 1987 CORPS OF ENGINEERS WETLANDS DELINEATION MANUAL, TECHNICAL REPORT Y-87-1.
- THE SITE SPECIFIC SCIL SURVEY WAS PRODUCED MARCH 9, 2016, AND WAS PREPARED BY JAMES P. GOVE, CSS § 004, GOVE ENVIRONMENTAL SERVICES, INC. FIELD WORK WAS CONDUCTED NOVEMBER AND DECEMBER OF 2015, AND JANUARY OF 2016. PROJECT IS 625; § 201570.
- SOLS WERE IDENTIFIED WITH THE NEW HAMPSHIRE STATE—WIDE NUMERICAL SOILS LEGEND, USDA NRCS, DURHAM, NH. ISSUE # 10, JANUARY 2011.
- 11. FLOOD HAZARD ZONE: "X", PER FIRM PANEL #33017C0211D, DATED MAY 16, 2005.

- 12. HORIZONTAL DATUM BASED ON NEW HAMPSHIRE STATE PLANE(2800) NADB3(2011) DERIVED FROM REDUNDANT OP OBSERVATIONS INILIZING THE KENNET OFS WAS NETWORK THIS DATUM HAS BEEN FOUND TO BE CONSISTENT ±2" WITH THE CITY OF ROOMESTER MIS COORDINATE SYSTEM.
- 13. VERTICAL DATUM IS BASED ON CITY OF ROCHESTER NAVDB8 UTILIZING CITY OF ROCHESTER GEODETIC MONUMENT #226 HAVING A PUBLISHED ELEVATION OF 399.342°.
- 14. PROPER PROCEDURES WERE FOLLOWED IN ORDER TO GENERATE CONTOURS AT 2' INTERVALS. ANY MODIFICATION OF THIS INTERVAL WILL DIMINISH THE INTEGRITY OF THE DATA, AND DOUGET SURVEY, INC. WILL NOT BE RESPONSIBLE FOR ANY SUCH ALTERATION PERFORMED BY THE USER.
- 16. AERIAL TOPOGRAPHY WAS CONDUCTED BY EASTERN TOPOGRAPHICS FROM IMAGES TAKEN DURING DECEMBER 2015 WITH A PHOTO SCALE OF 1° = 40°. CONTOURS AND OBJECTS SHOWN WITHIN OBSCURED AREAS ARE APPROXIMATE AND SHOULD BE VENIFIED BEFORE USE FOR DESIGN OR CONSTRUCTION PURPOSES.
- 15. TAX MAP 137, LOT 9—6 IS SUBJECT TO A DRAINAGE EASEMENT TO THE CITY OF ROCHESTER RECORDED IN S.C.R.D. BOOK 1779, PAGE 386, THE EXACT LOCATION IS UNBNOWN. A 12° DRAINAGE PIPE WAS FOUND AND SHOWN HEREON IN THE DESCRIPCTION STREYERS OF THE TOTAL OF THE PAGE 187.
- 18. ROADWAY NOTES:


ROADWAY STATUS RESEARCH WAS PERFORMED AT STRAFFORD COUNTY REGISTRY OF DEEDS, CITY OF ROCHESTER PLANNING DEPARTMENT AND CLERK'S OFFICE, AND THROUGH CORRESPONDENCE WITH CITY OF ROCHESTER ENGINEERING DEPARTMENT.

A. CHESLEY HILL ROAD (F.K.A. GROVE STREET): PAVED, PUBLIC, 4 RODS (66") WIDE PER HIGHWAY BOOK 3 PAGE 52 IN THE ROCHESTER CITY CLERK'S OFFICE.


B. NORMAN STREET; PAVED IN PART, 50' WIDE FROM RAMSEY DRIVE TO DONALD STREET AS DEEDED TO CITY OF ROCHESTER IN S.C.R.D. BOOK 757, PAGE 350. PRESUMED PUBLIC PER ABOVE RESEARCH. NO FORMAL ACCEPTANCE FOUND OR PROVIDED DURING RESEARCH.

C. RANSEY DRIVE; PAVED, PRESUMED 50' PER REFERENCE PLAN (A), PRESUMED PUBLIC PER ABOVE RESEARCH. NO FORMAL ACCEPTANCE OR CONVEYANCE TO CITY FOUND OR PROVIDED DURING RESEARCH. D. DONALD STREET: PAVED IN PART, PRESUMED 50' PER REFERENCE PLAN (M. PRESUMED PUBLIC PER ABOVE RESEARCH. NO FORMAL ACCEPTANCE OR CONVEYANCE TO CITY FOUND OR PROVIDED DURING RESEARCH.

- PROPOSED SUBDIVISION NORMAND A. & IRENE M. RAMSEY, NORMAN STREET, GONIC, ROCHESTER, N.H.* DATED 27 NOV 1984 BY BERRY CONST. CO., INC. S.C.R.D. PLAN #25-49.
- PLAN OF LAND OF GLEN & KIMBERLY BILLINGS, GROVE STREET, ROCHESTER, N.H. DATED MAY 5, 1989 BY BERRY SURVEYING & ENGINEERING. S.C.R.D. PLAN #37-111.
- SUBDIVISION PLAN OF LAND LOTS 113, TAX ASSESSOR'S MAP 138, 69 GONIC ROAD, GONIC, NEW HAMPSHIRE, COUNTY OF STRAFFORD DATED 9-3-04 BY CIVILWORKS, S.C.R.D. PLAN \$77-80. MILLSDE ACRES DEVELOPMENT, ROCHESTER, N.H. PLAN OF LOT LAYOUT ON LAND OF NORMAN RAMSEY, GONG, N.H. TORIGINAL PRINT BY UNKNOWN, TRACED BY T.W. CHESLEY, DATED SEPT. 1955 REWISED APRIL 1956. S.CR.D. PLAN 27, POCKET 3, FOLDER 4.
- 5. "SUBDIMISION PLAN OF LAND ON CHESLEY-HILL-ROAD, ROCHESTER N.H. FOR RONALD P. LAVALLEE' DATED NOV 13, 1971. S.C.R.D. PLAN 4, POCKET 9, FOLDER 1
- SUBDIVISION OF LAND, ROCHESTER, N.H. VINCENT J. & LAVERENE T. DENOBILE DATED JAN 24, 1986 BY JOHN W. DURGIN. S.C.R.D. PLAN #29—18.
- 7. "Subdivision of Land, grove street, rochester, n.h. for rawsey reality co., inc." dated Sept. 1992 By norway plains associates, inc. s.c.r.d. plan #45—25.
- SUBDIVISION OF LAND, DONALD STREET, ROCHESTER, N.H. FOR NORMAN A. RAMSEY DATED JUNE 1895 BY NORWAY PLAINS ASSOCIATES, INC. S.C.R.D. PLAN ₱47-17.
- SUBDIVISION OF LAND, GROVE ST. & DONALD ST., ROCHESTER, N.H. FOR NORMAND A. RAMSEY DATED JULY 2000 BY NORWAY PLAINS ASSOCIATES, INC. S.C.R.D. PLAN #61-9.
- SUBDIVISION OF LAND, GROVE STREET, ROCHESTER, N.H. FOR NORMAND A. RAMSEY DATED MAR. 2000 BY NORWAY PLAINS ASSOCIATES, INC. S.C.R.D. PLAN #61-10.
- "STATE OF NEW HAMPSHIRE DEPARTMENT OF TRANSPORTATION RIGHT OF WAY PLANS NH PROJECT NO. 10620-D SPAULDING TURNPIKE NH ROUTE 16" DATED JANUARY 11, 2011. S.C.R.D. PLAN #IDI-CO1.
- 12. "PLAN OF PROPOSED LS 1826 (1) N.H. NO. P-2692-T SPAULDING TURNPIKE" DATED 1985. ON FILE THROUGH THE NHOOT ONLINE PROJECT MEWER.

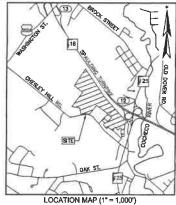

WETLAND AREA TREE STUMP CONIFEROUS TREE DECIDUOUS TREE DECIDUOUS BUSH BOULDER TEST PIT CONCRETE
BOUND FOUND
DRILL HOLE SET
FRON PIPE FOUND
IRON ROD SET
EDGE OF PAVEMENT
EDGE OF GRAVEL
WITH BARBED WIRE
NEW HAMDSHIPE HIS

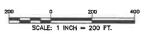

EXISTING CONDITIONS PLAN BIRCHWOOD PONDS RESIDENTIAL DEVELOPMENT

MAKRIS REAL ESTATE DEVELOPMENT, LLC


TAX MAP 137, LOTS 9, 9-5, 9-6 & 10 CHESLEY HILL ROAD & DONALD STREET ROCHESTER, NEW HAMPSHIRE


| F |
|-------|
| |
| - |
| |
| - |
| - |
| _ |


| DRAWN BY: | M.T.L | DATE: JANUARY 9, 2017 |
|-------------|--------|-----------------------|
| CHECKED BY: | J.F.K. | DRAWING NO.: 4380F |
| 2000 | 4380 | 7 7 13 |




THIS SHEET NOT FOR RECORDING

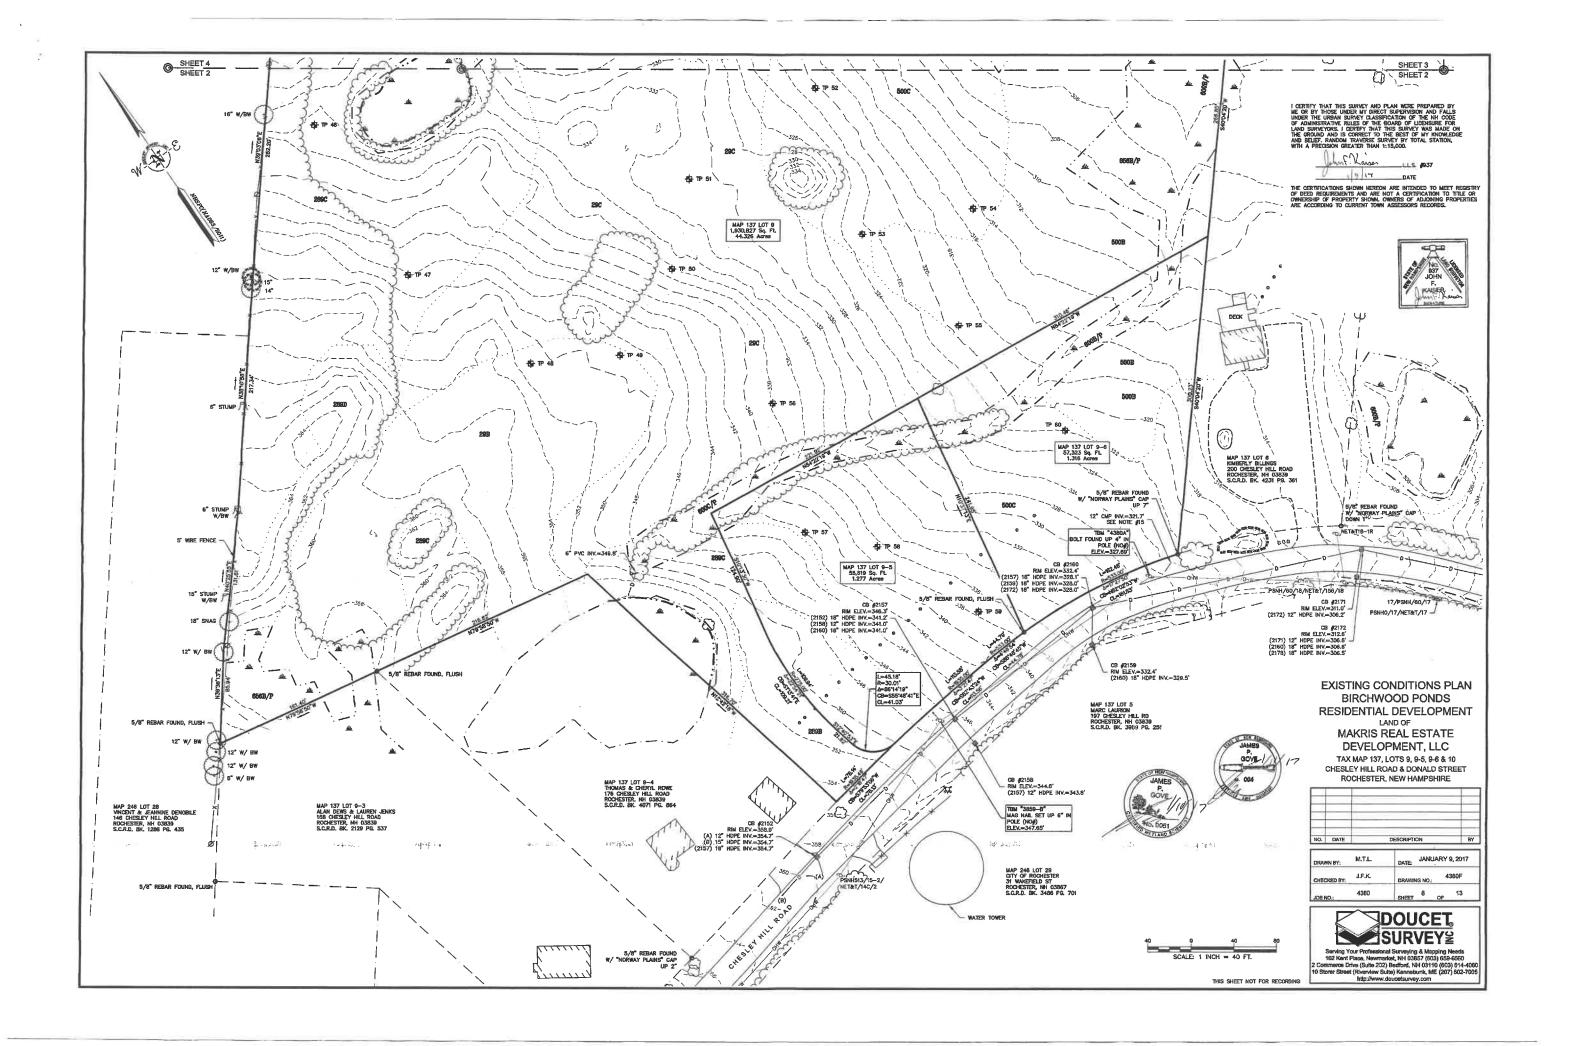


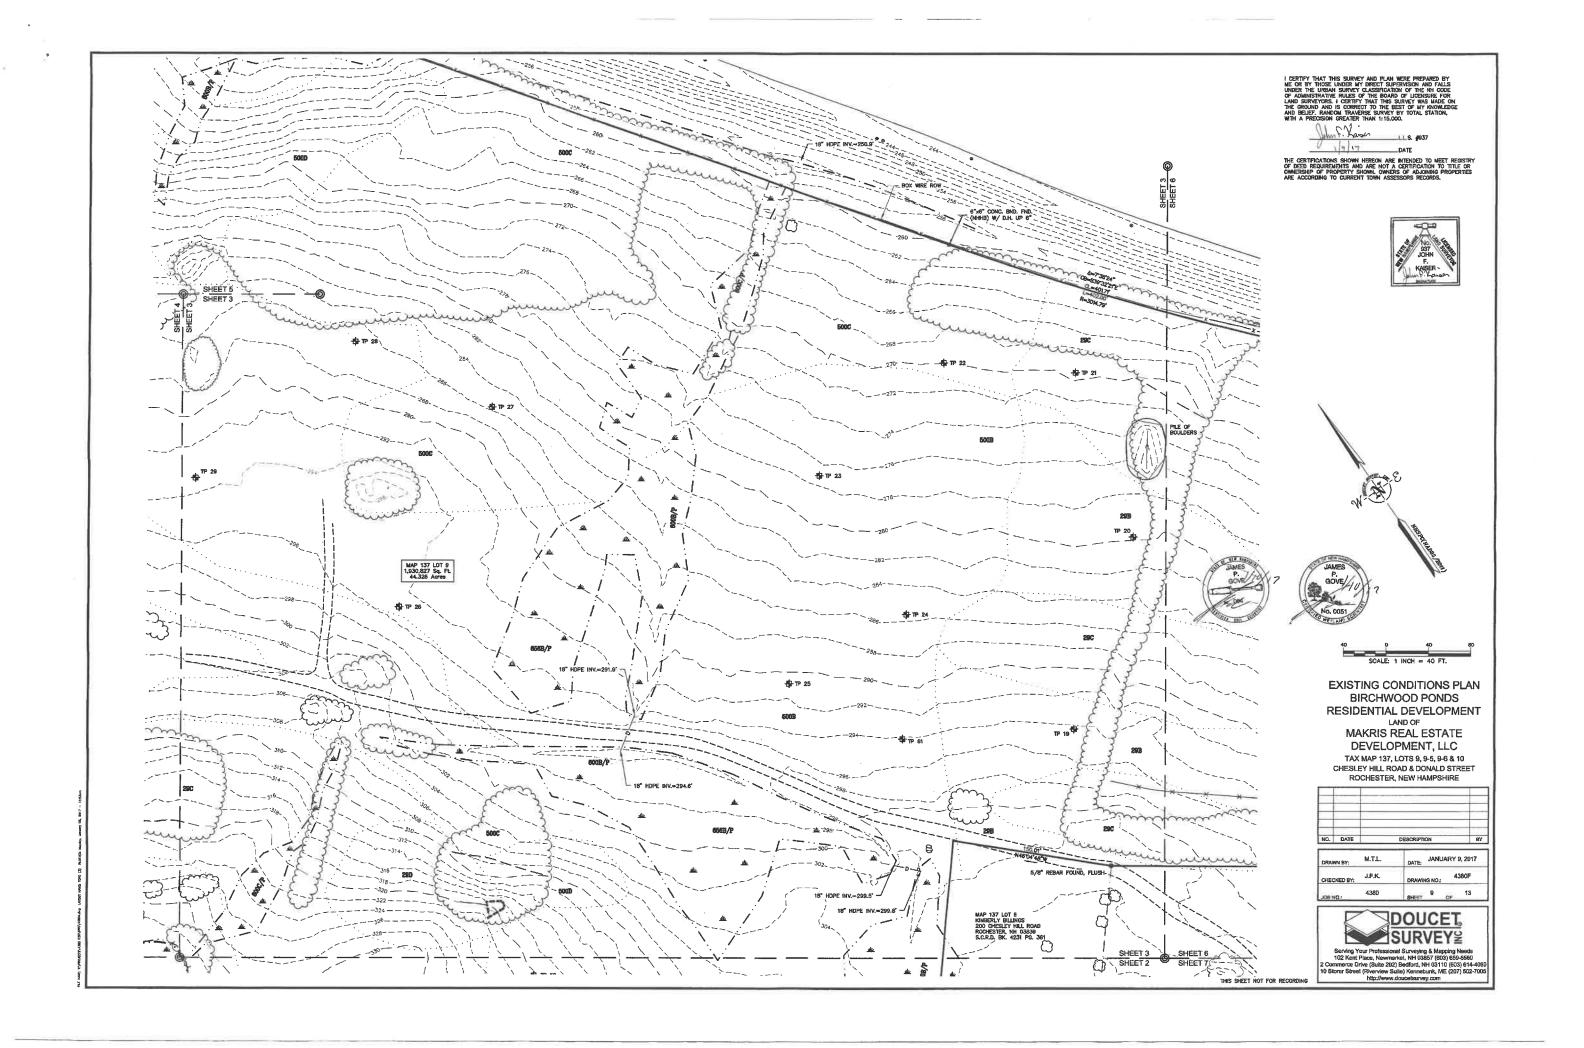


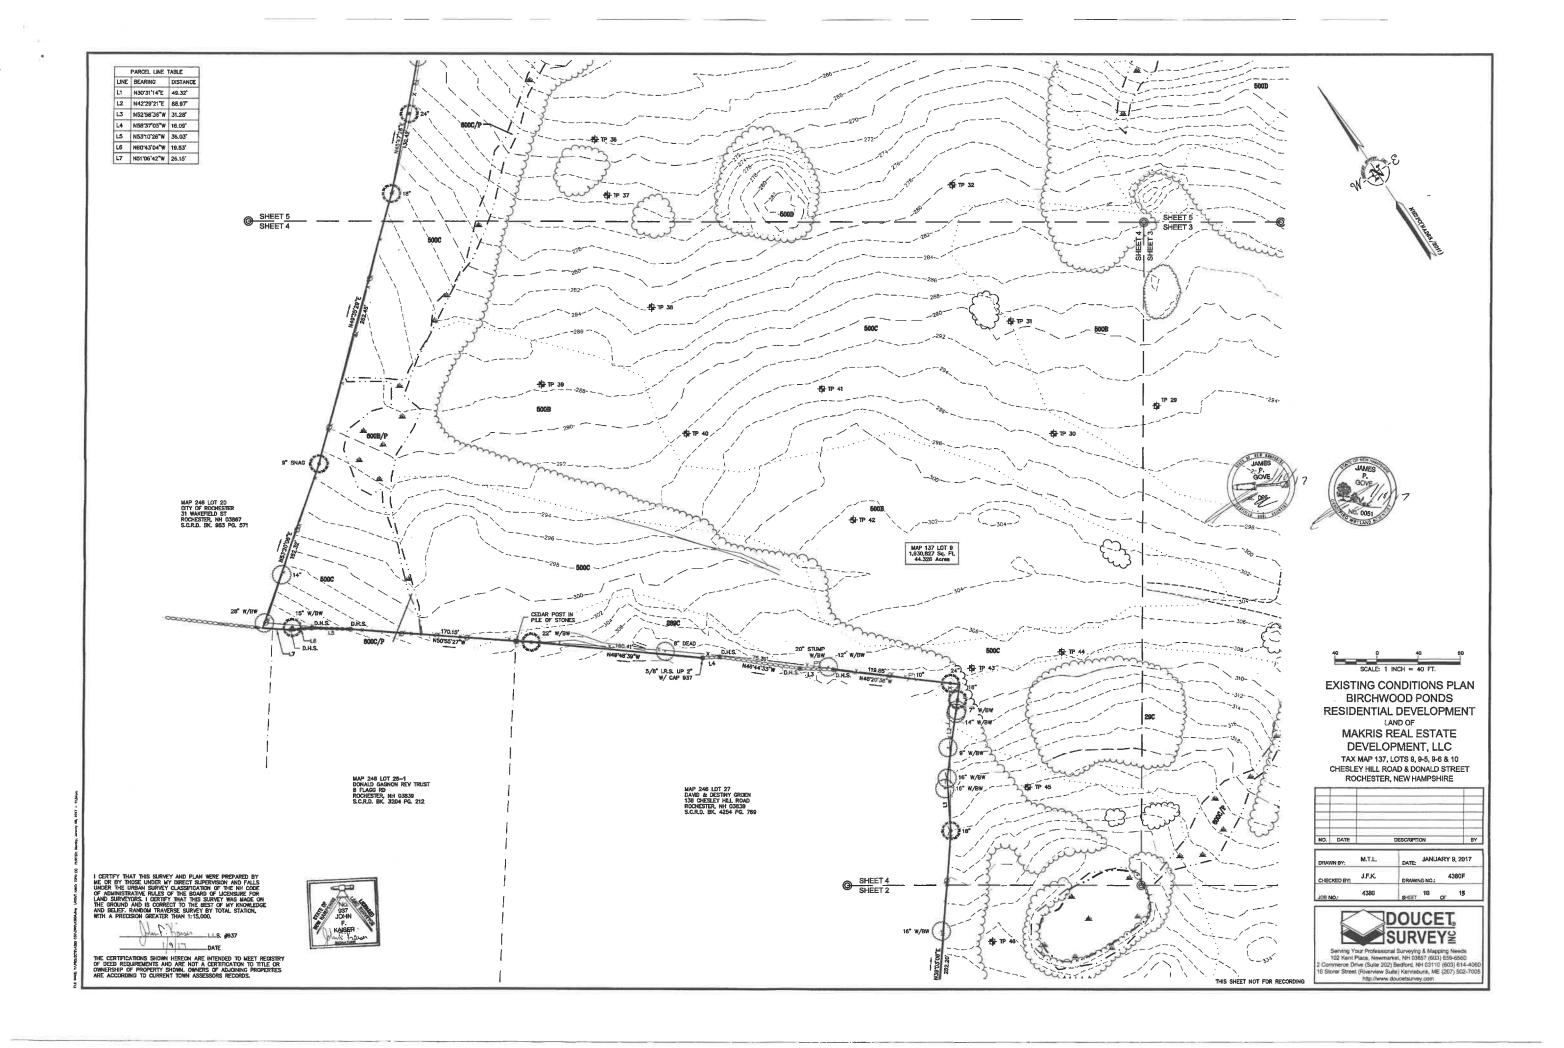


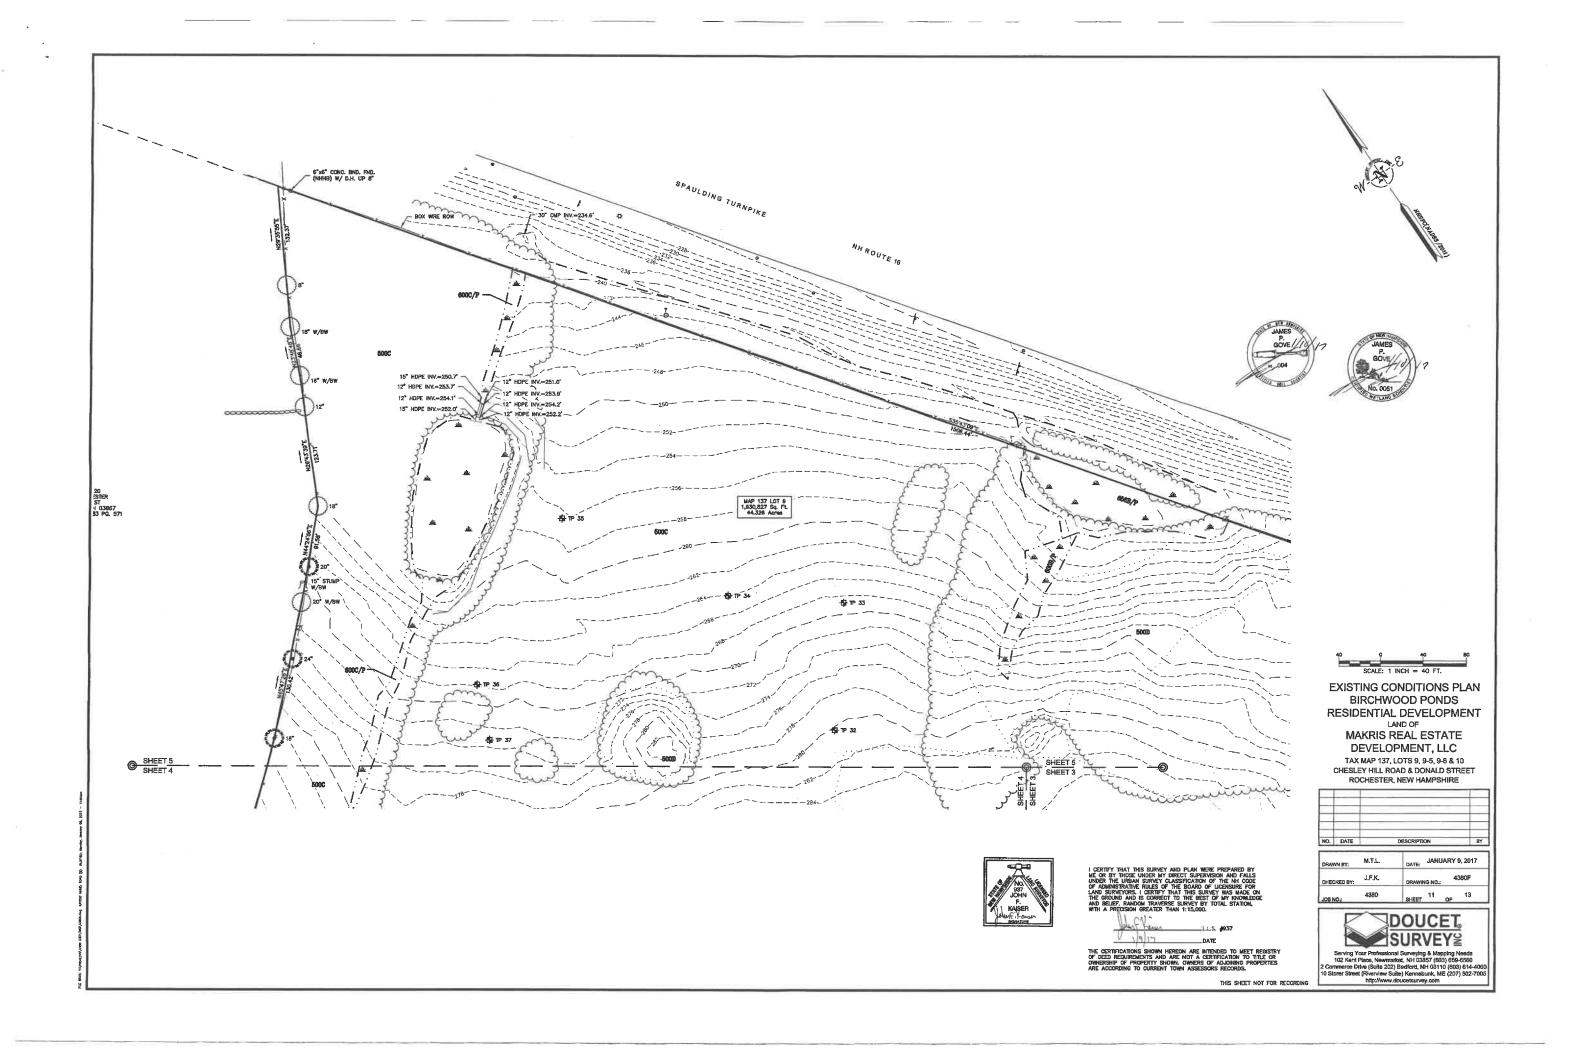





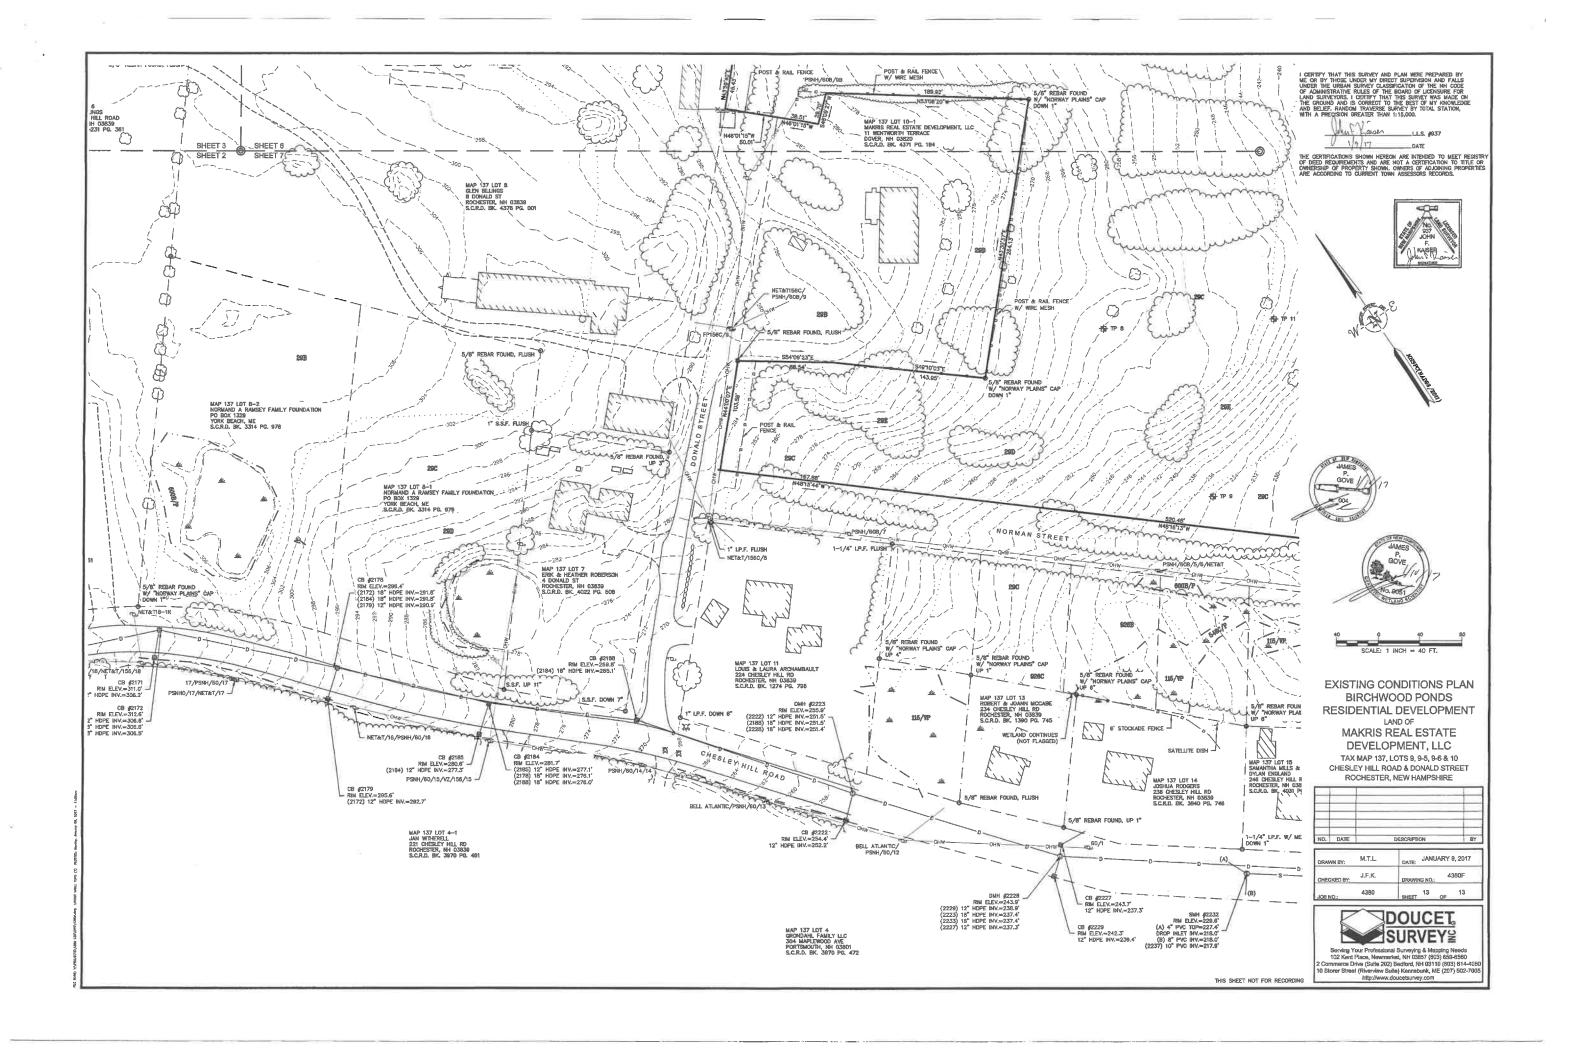


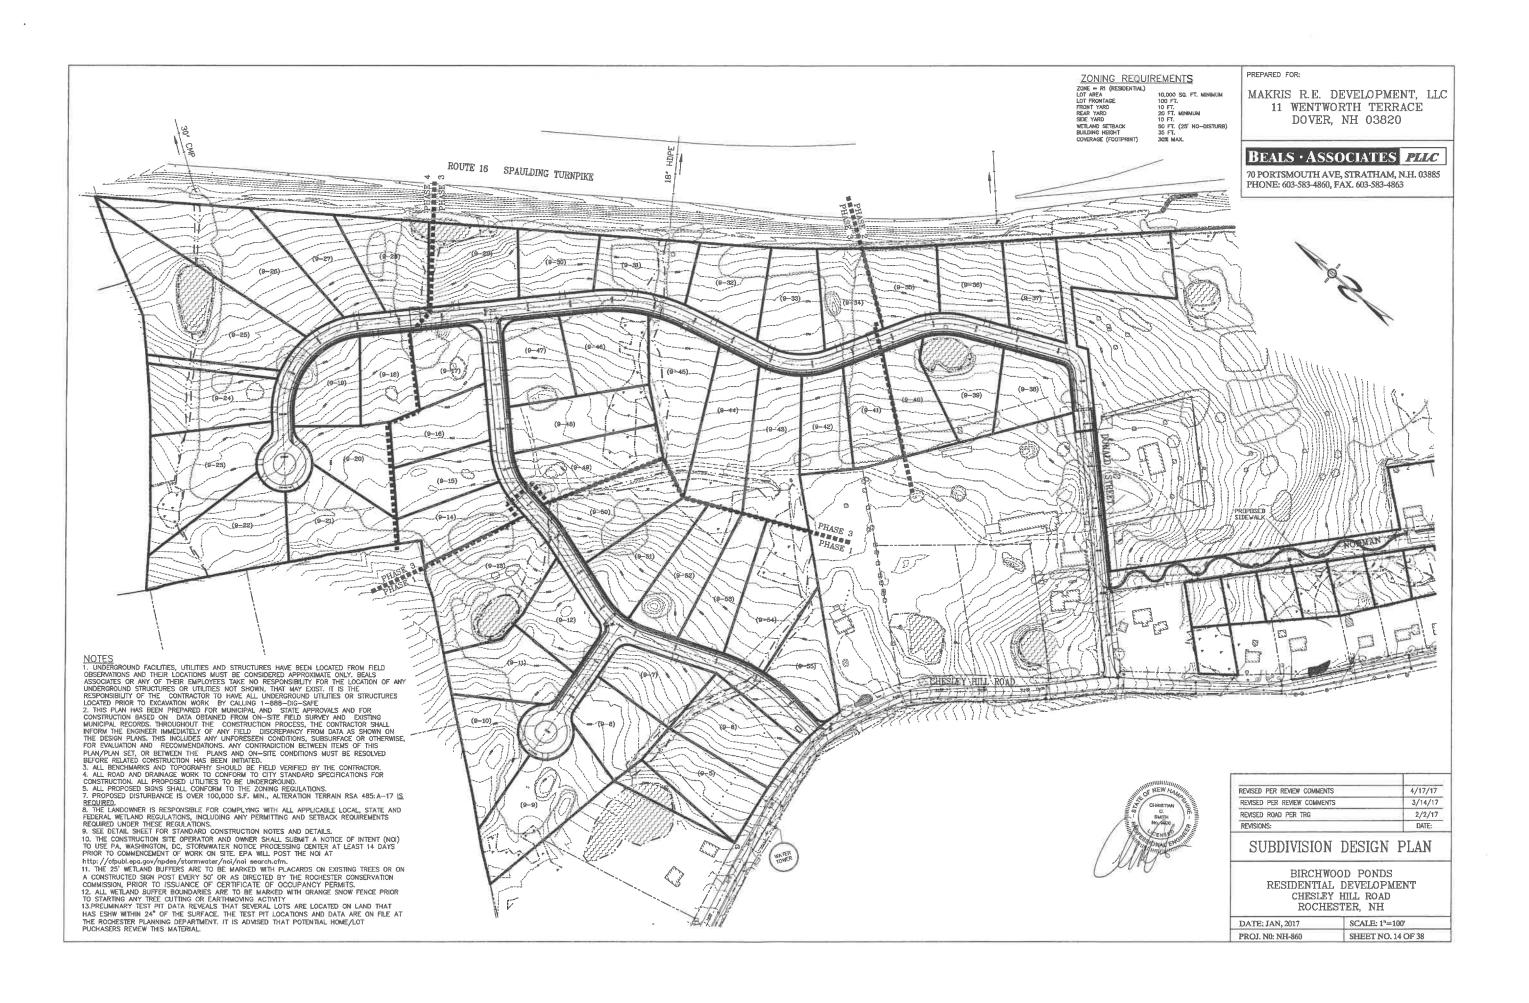


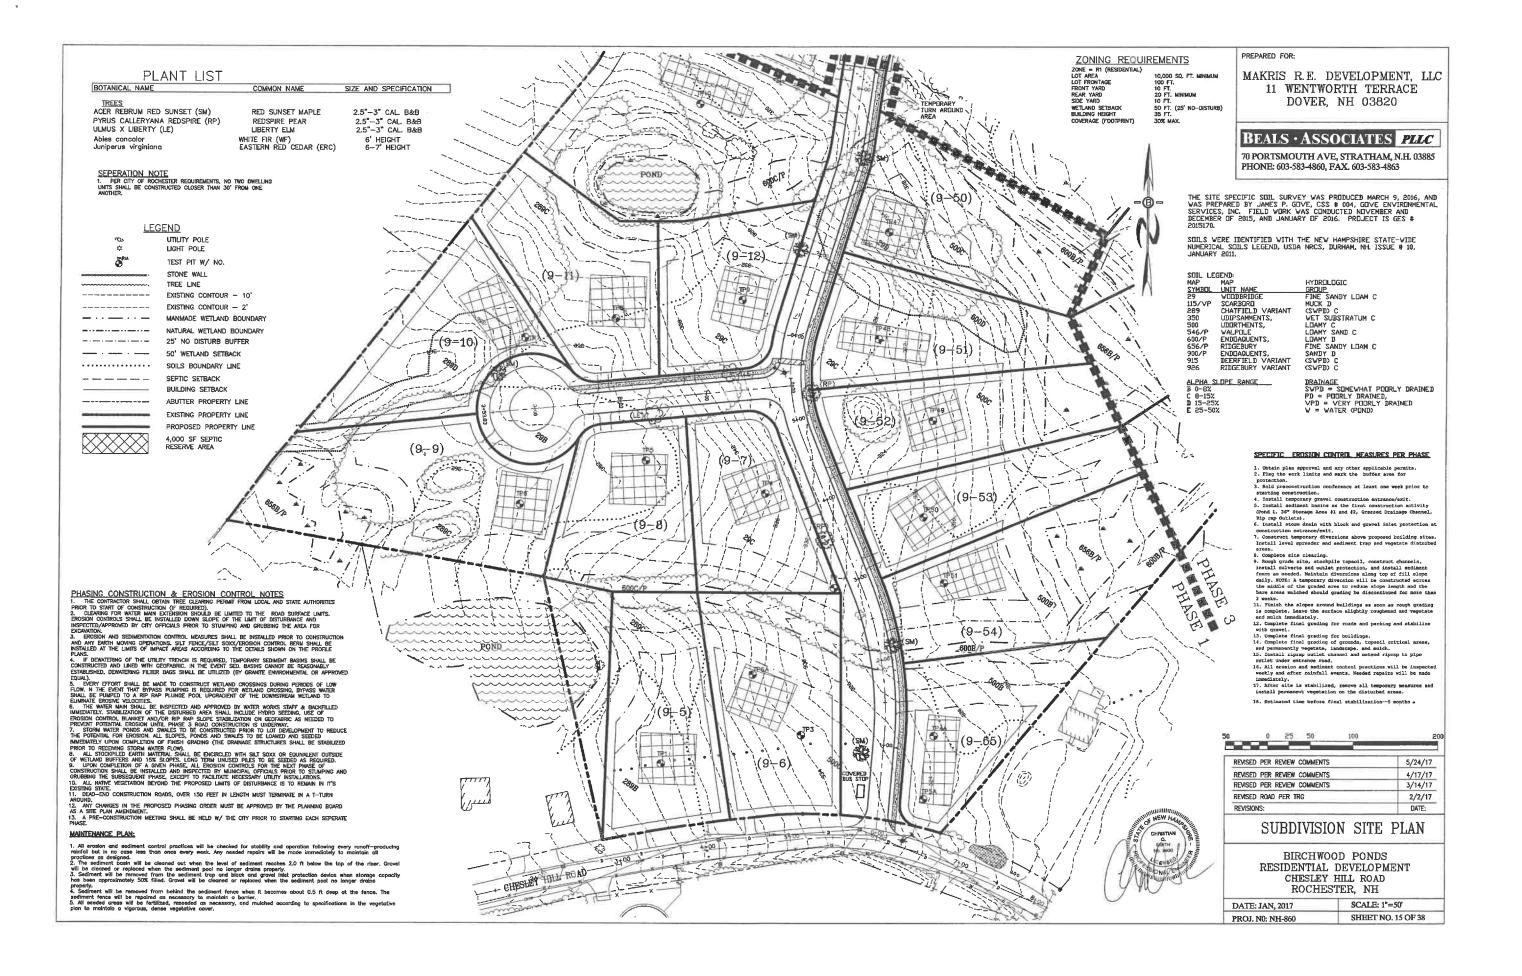


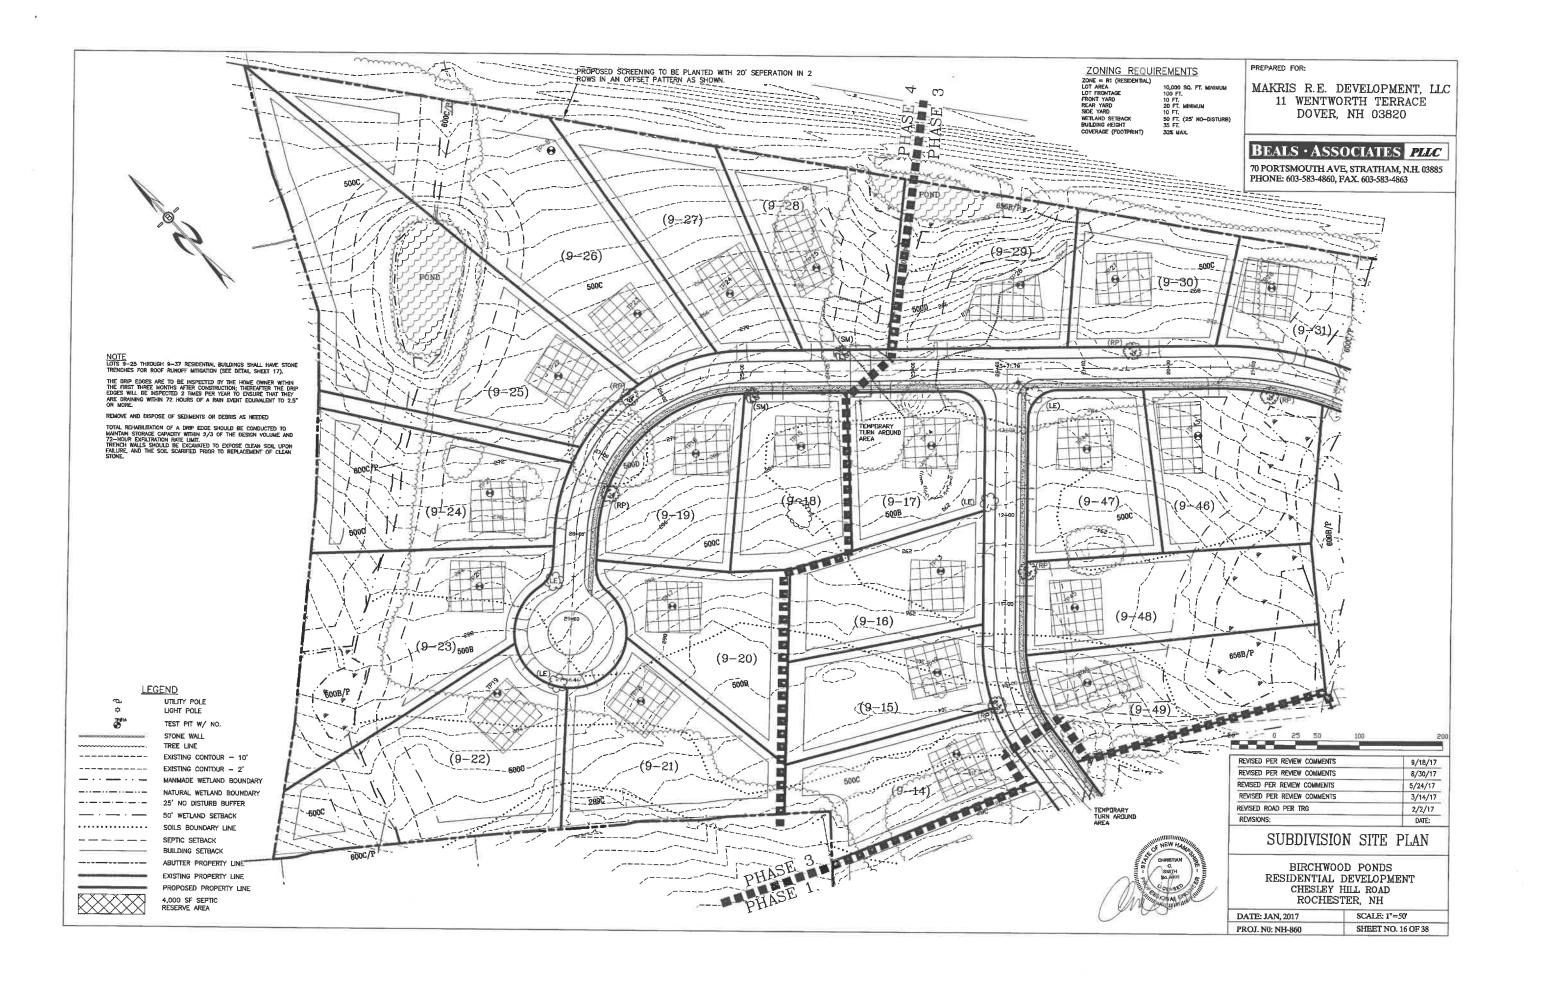

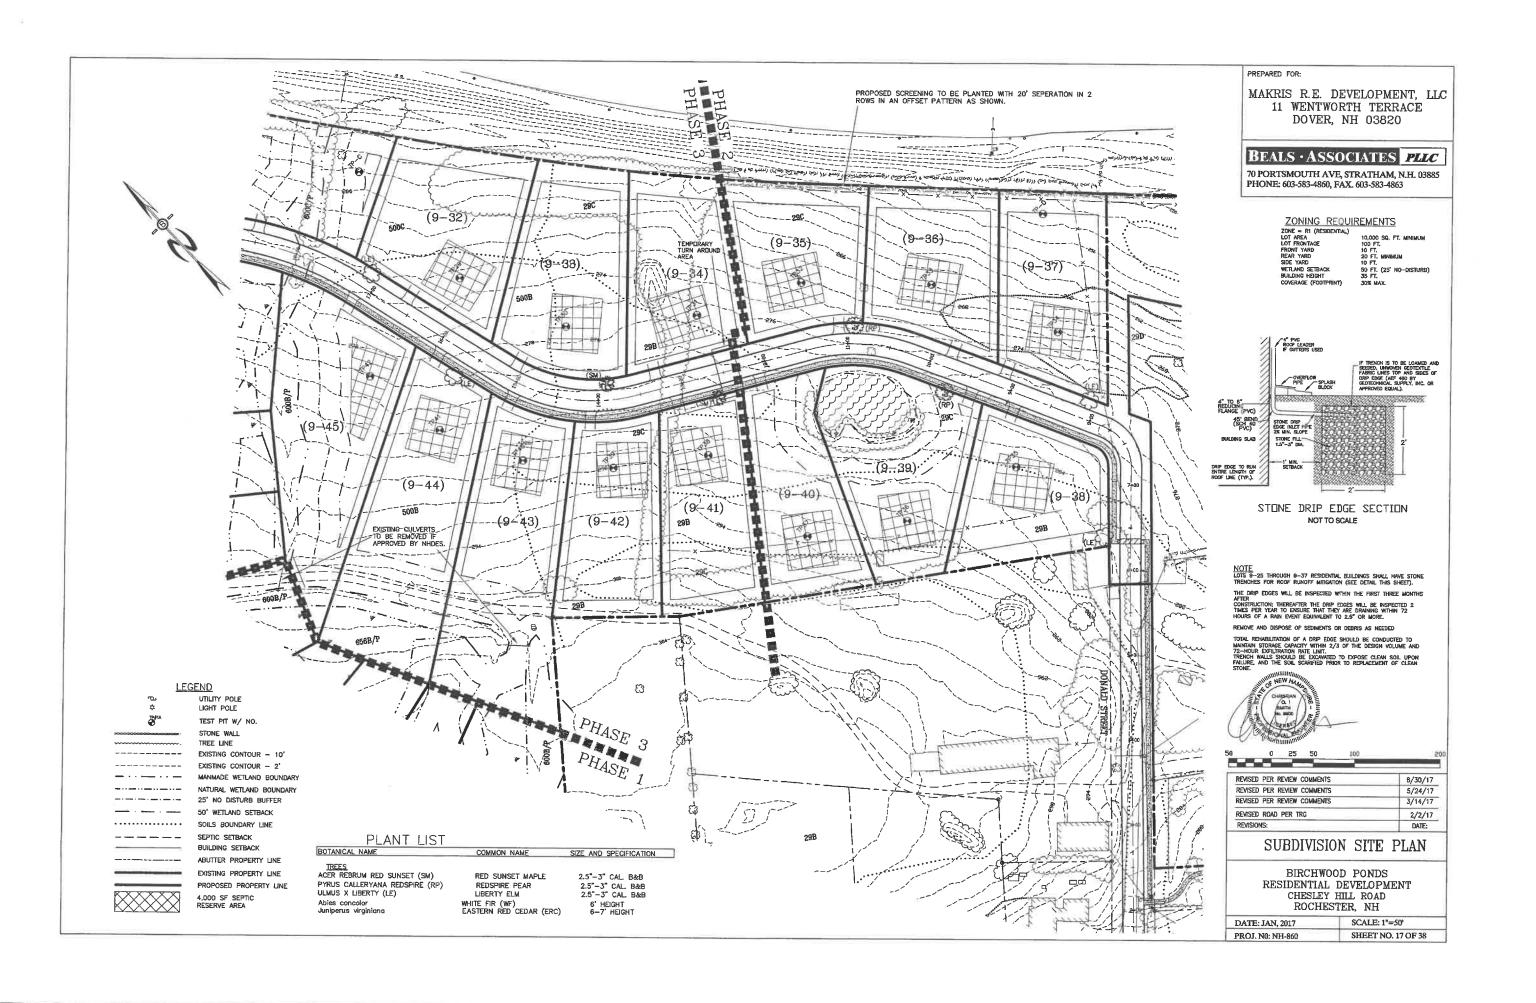

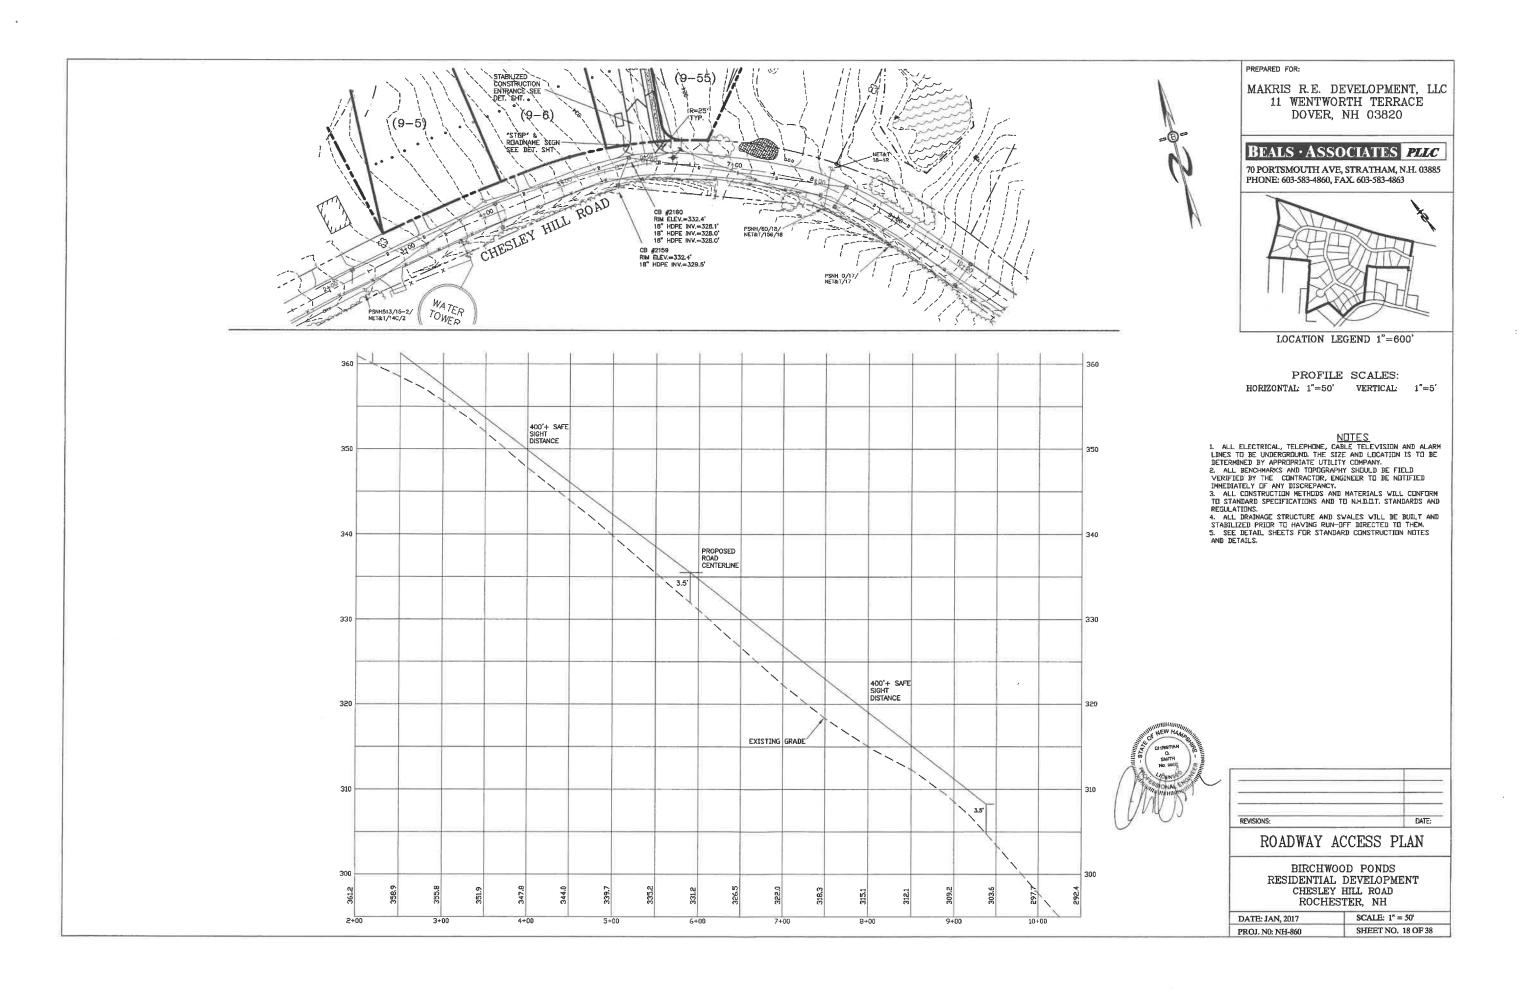

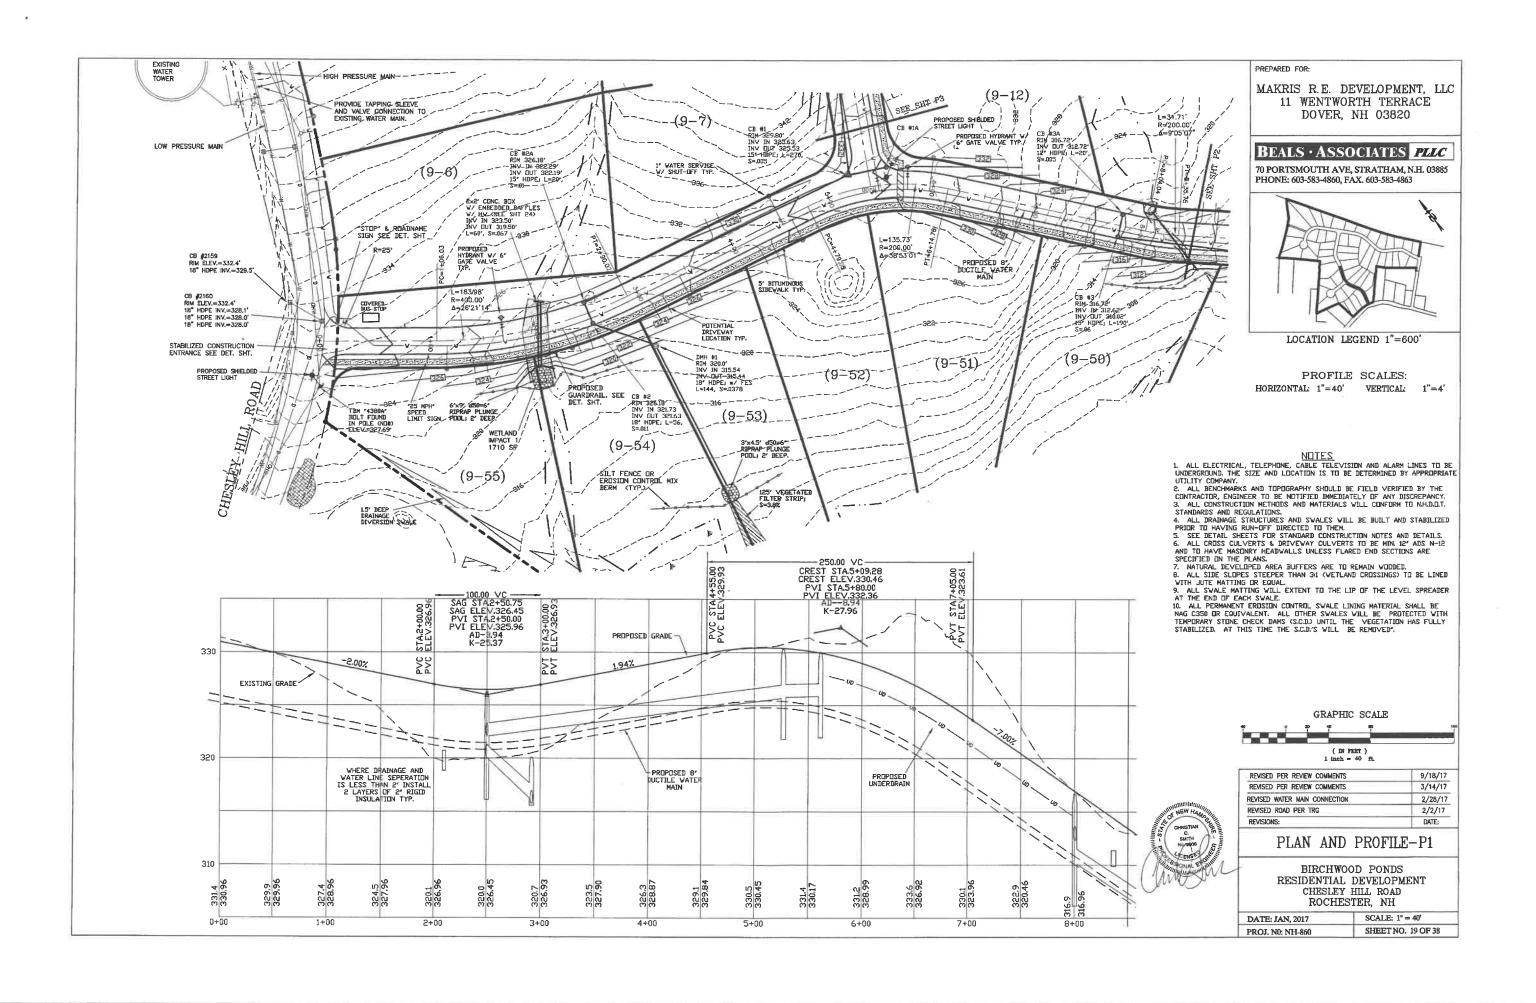

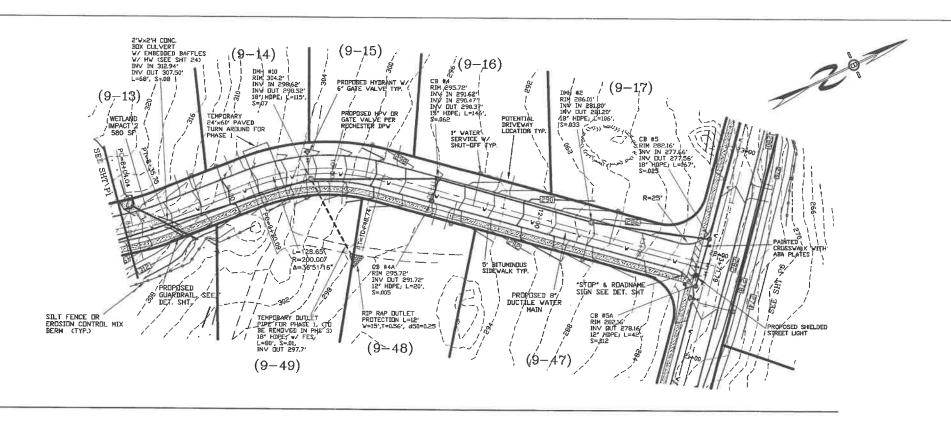



MAKRIS R.E. DEVELOPMENT, LLC 11 WENTWORTH TERRACE DOVER, NH 03820


BEALS · ASSOCIATES PLLC


70 PORTSMOUTH AVE, STRATHAM, N.H. 03885 PHONE: 603-583-4860, FAX. 603-583-4863



LOCATION LEGEND 1"=600'

PROFILE SCALES:
HORIZONTAL: 1"=40' VERTICAL: 1"=54'

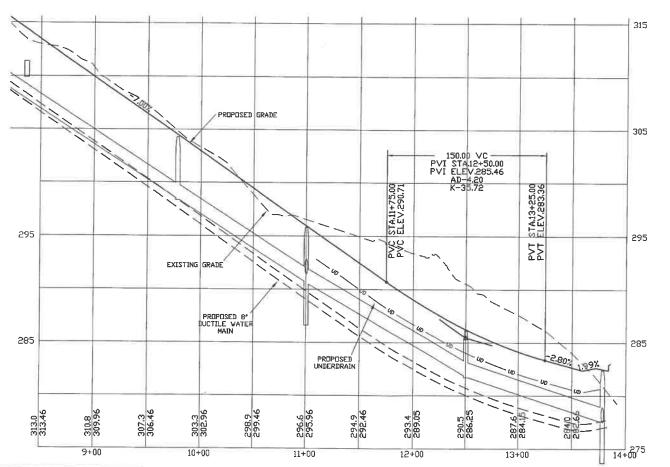


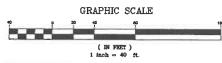

| REVISED PER REVIEW COMMENTS | 9/18/17 |
|-----------------------------|---------|
| REVISED PER REVIEW COMMENTS | 5/24/17 |
| REVISED PER REVIEW COMMENTS | 4/17/17 |
| REVISED PER REVIEW COMMENTS | 3/14/17 |
| REVISIONS: | DATE: |

PLAN AND PROFILE-P2

| DATE: JAN, 2017 | SCALE: 1" = 40° | |
|------------------|--------------------|--|
| PROJ. NO: NH-860 | SHEET NO. 20 OF 38 | |

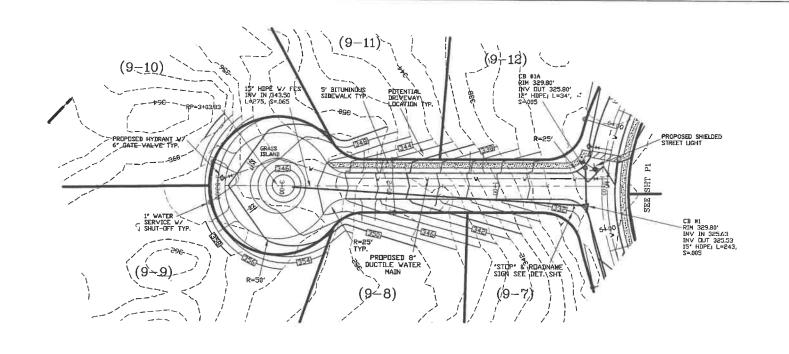




PREPARED FOR:

MAKRIS R.E. DEVELOPMENT, LLC 11 WENTWORTH TERRACE DOVER, NH 03820


BEALS · ASSOCIATES PLLC


70 PORTSMOUTH AVE, STRATHAM, N.H. 03885 PHONE: 603-583-4860, FAX. 603-583-4863

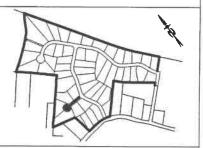

LOCATION LEGEND 1"=600'

PROFILE SCALES:
HORIZONTAL: 1"=40' VERTICAL: 1"=54'

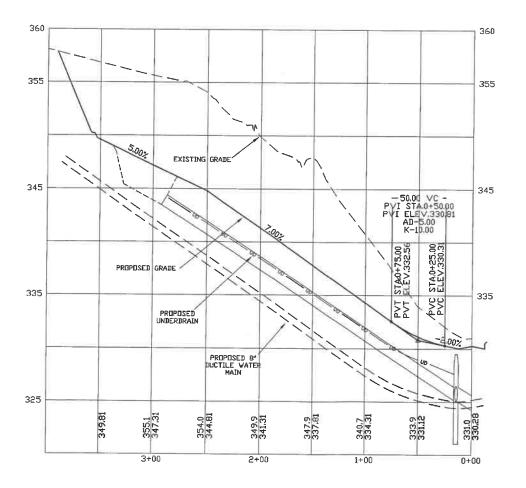


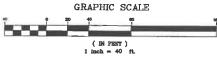



| REVISED PER REVIEW COMMENTS | 9/18/17 |
|-----------------------------|---------|
| UPDATED LOT NUMBERS | 6/27/17 |
| REVISED PER REVIEW COMMENTS | 3/14/17 |
| REVISED ROAD PER TRG | 2/2/17 |
| REVISIONS: | DATE: |

PLAN AND PROFILE-P3

| DATE: JAN, 2017 | SCALE: 1" = 40' |
|------------------|--------------------|
| PROJ. N0: NH-860 | SHEET NO. 21 OF 38 |

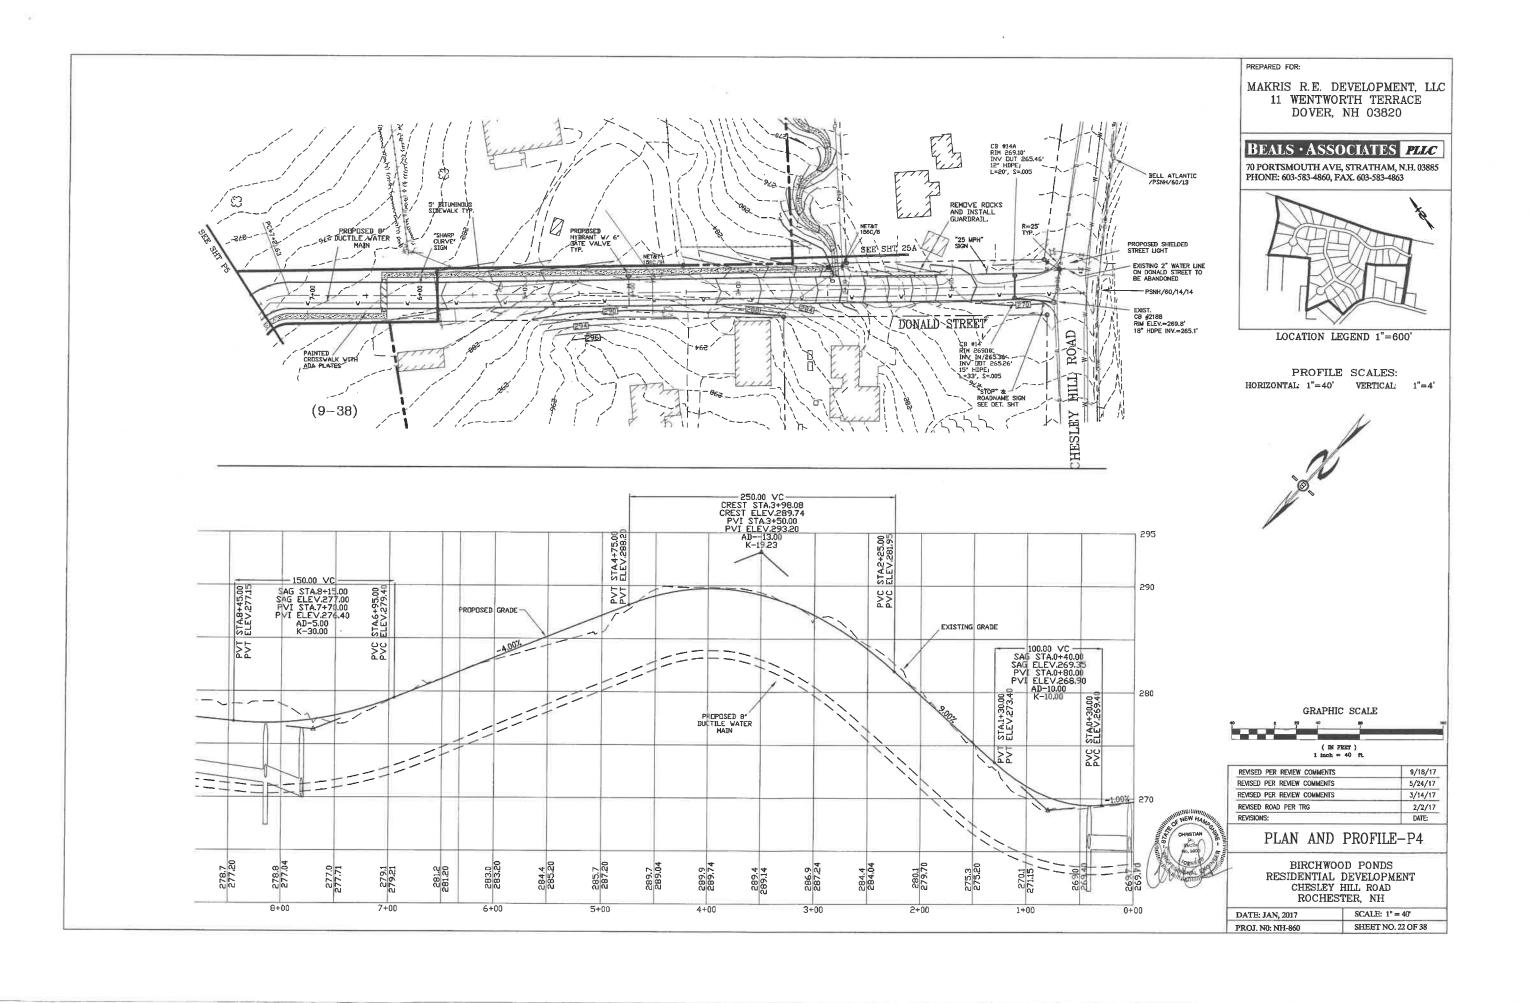

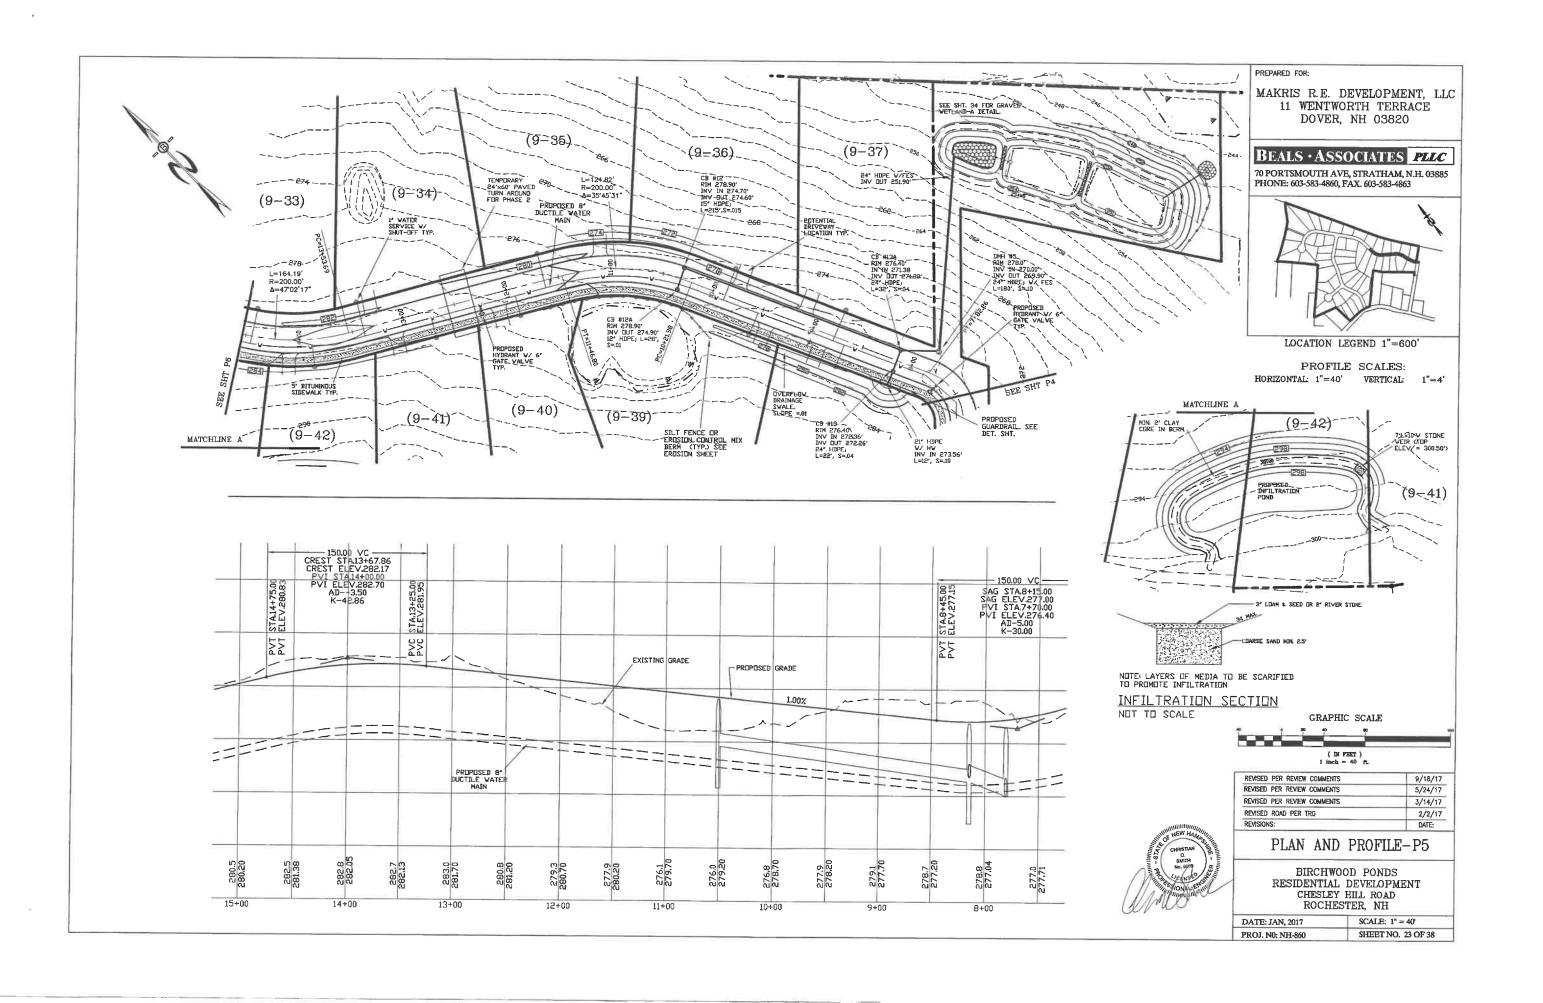

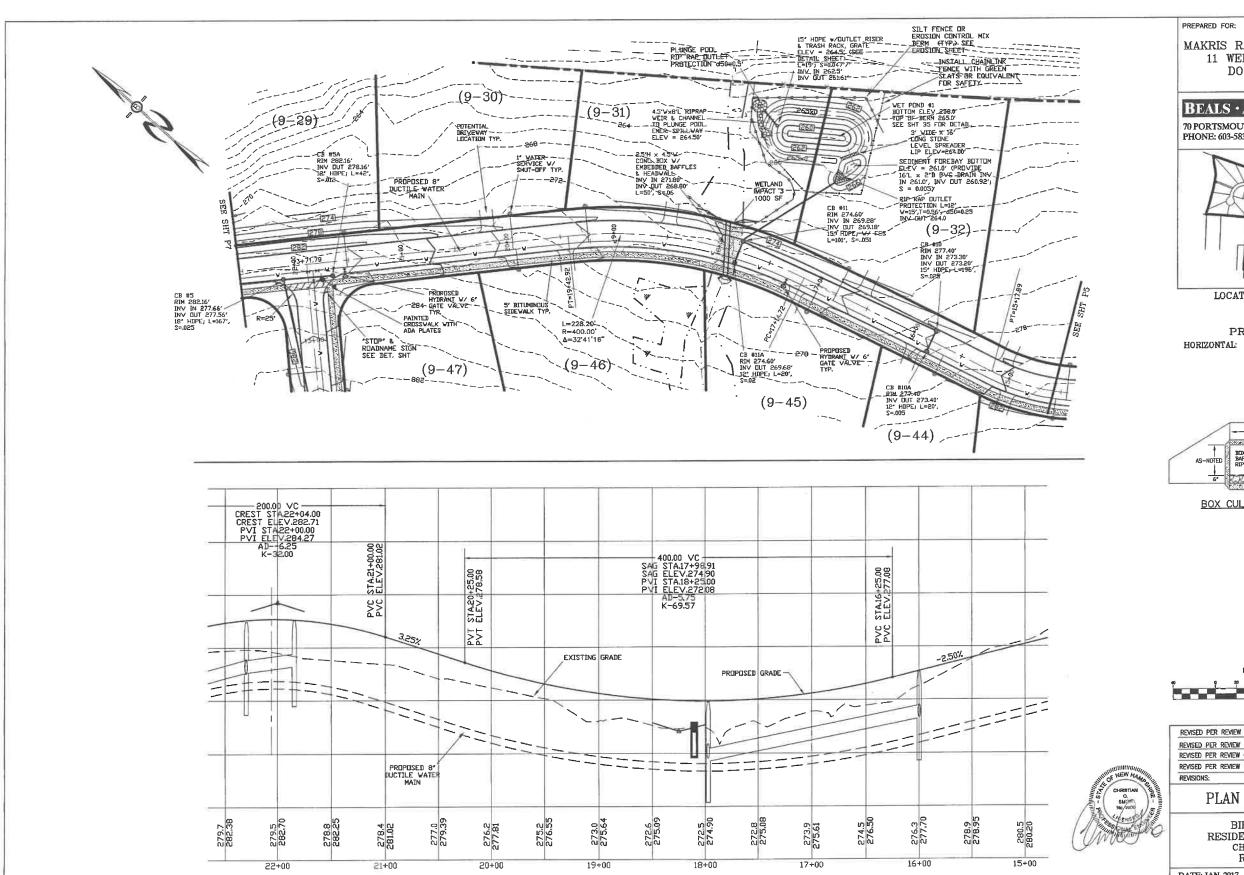

MAKRIS R.E. DEVELOPMENT, LLC 11 WENTWORTH TERRACE DOVER, NH 03820


BEALS · ASSOCIATES PLLC

70 PORTSMOUTH AVE, STRATHAM, N.H. 03885 PHONE: 603-583-4860, FAX. 603-583-4863




LOCATION LEGEND 1"=600'

PROFILE SCALES:
HORIZONTAL: 1"=40' VERTICAL: 1"=4'

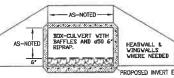


BOX CULVERT CROSSING NTS

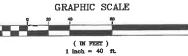



| REVISED PER REVIEW COMMENTS | 9/18/17 |
|-----------------------------|---------|
| REVISED PER REVIEW COMMENTS | 5/24/17 |
| REVISED PER REVIEW COMMENTS | 4/17/17 |
| REVISED PER REVIEW COMMENTS | 3/14/17 |
| PENSIONS: | DATE: |


PLAN AND PROFILE-P6


| DATE: JAN, 2017 | SCALE: 1" = 40' |
|------------------|--------------------|
| PROJ. NO: NH-860 | SHEET NO. 24 OF 38 |

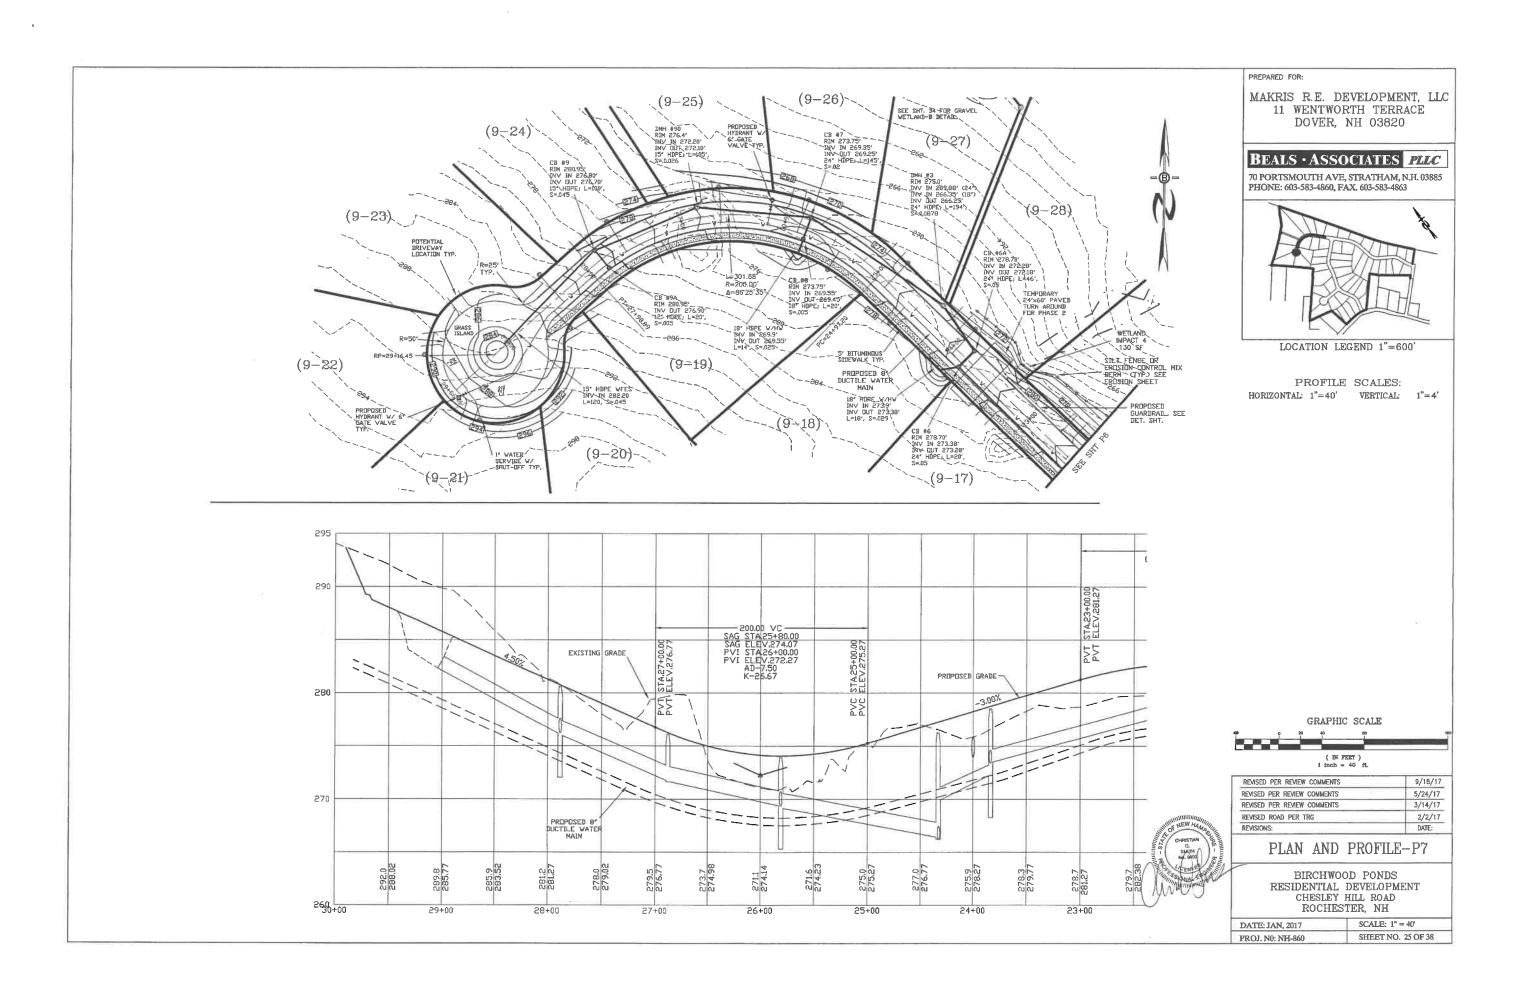

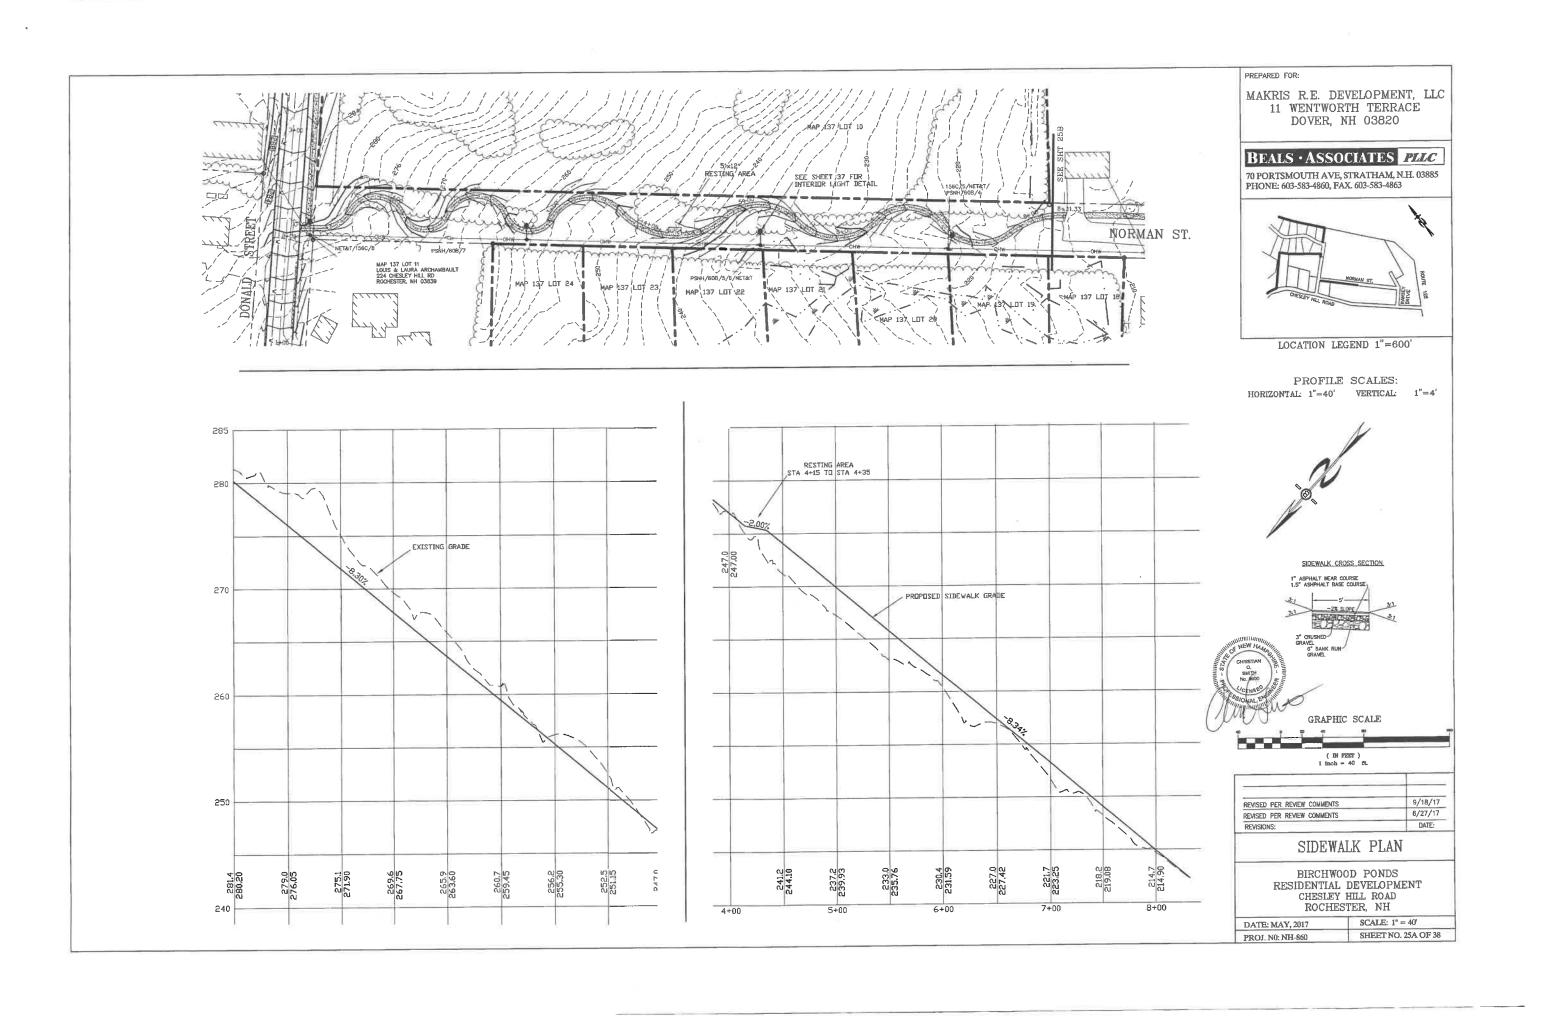

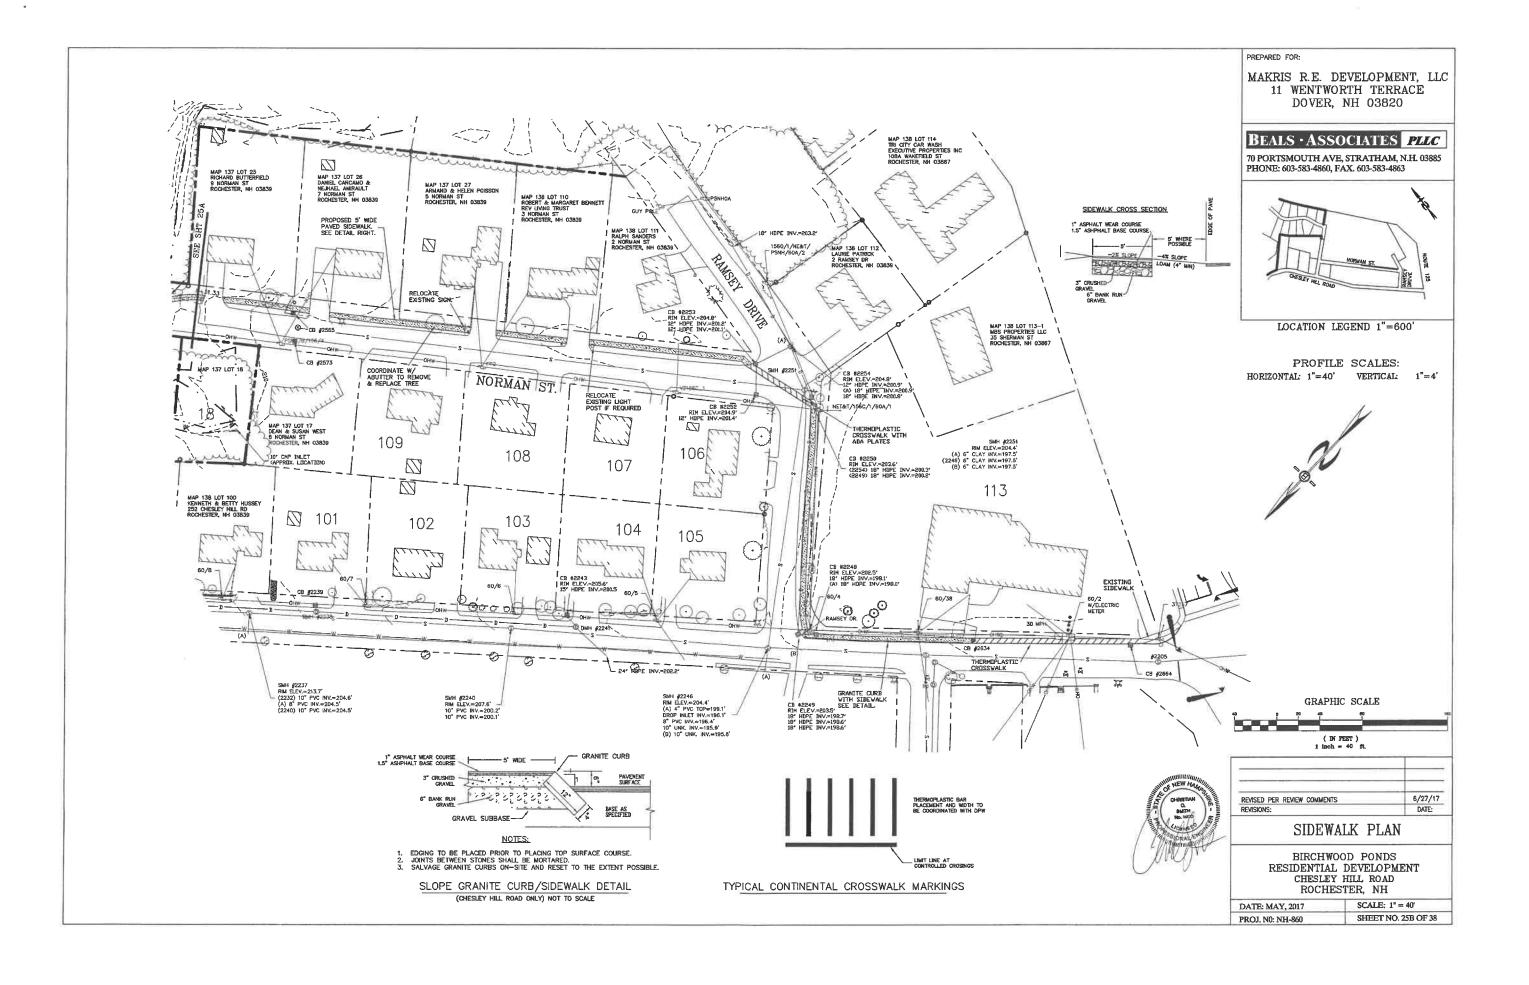

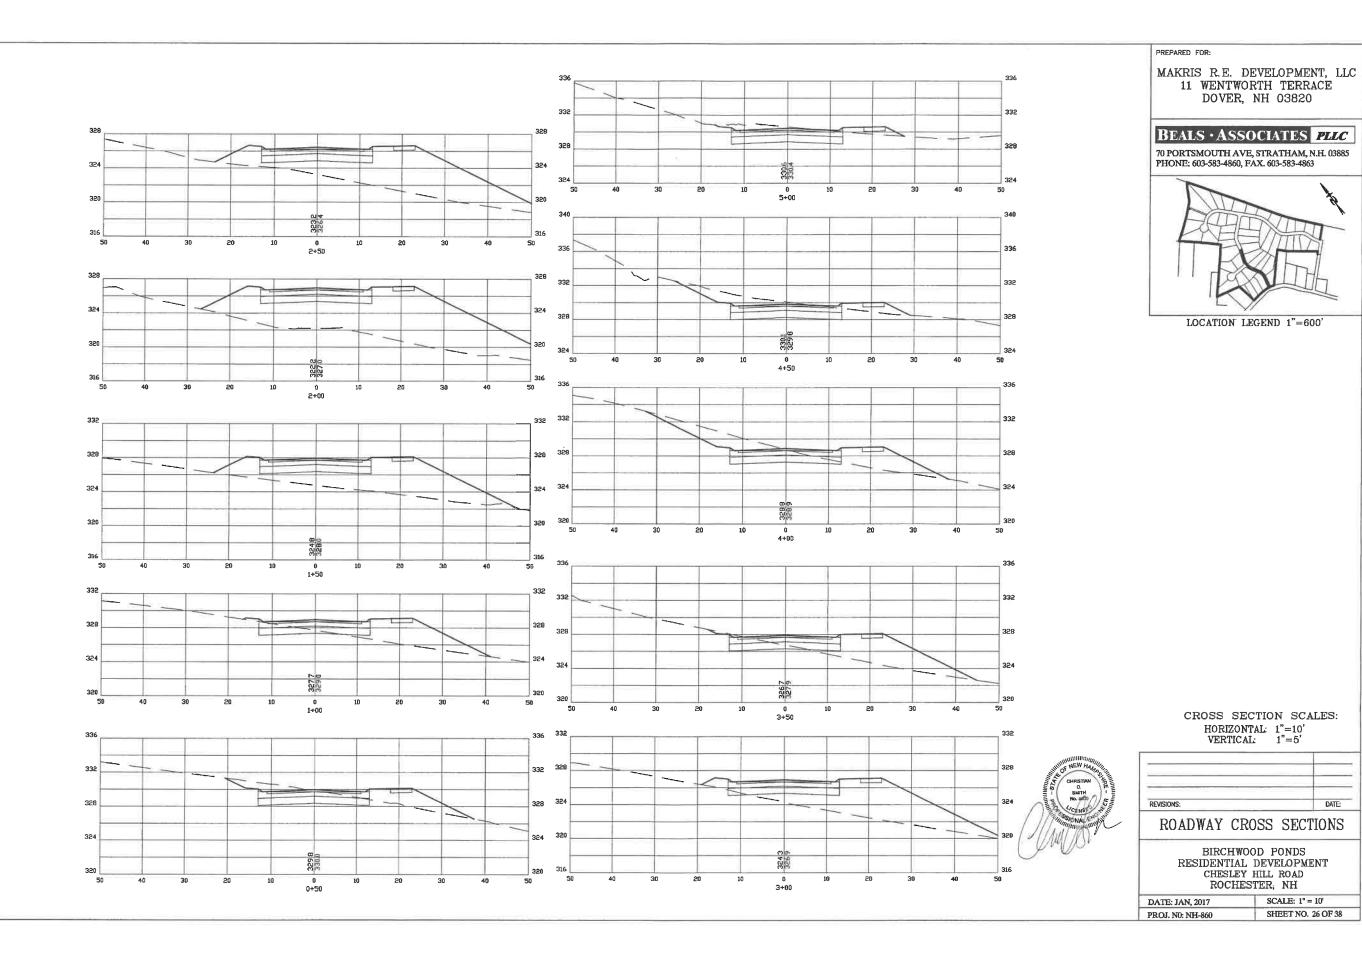

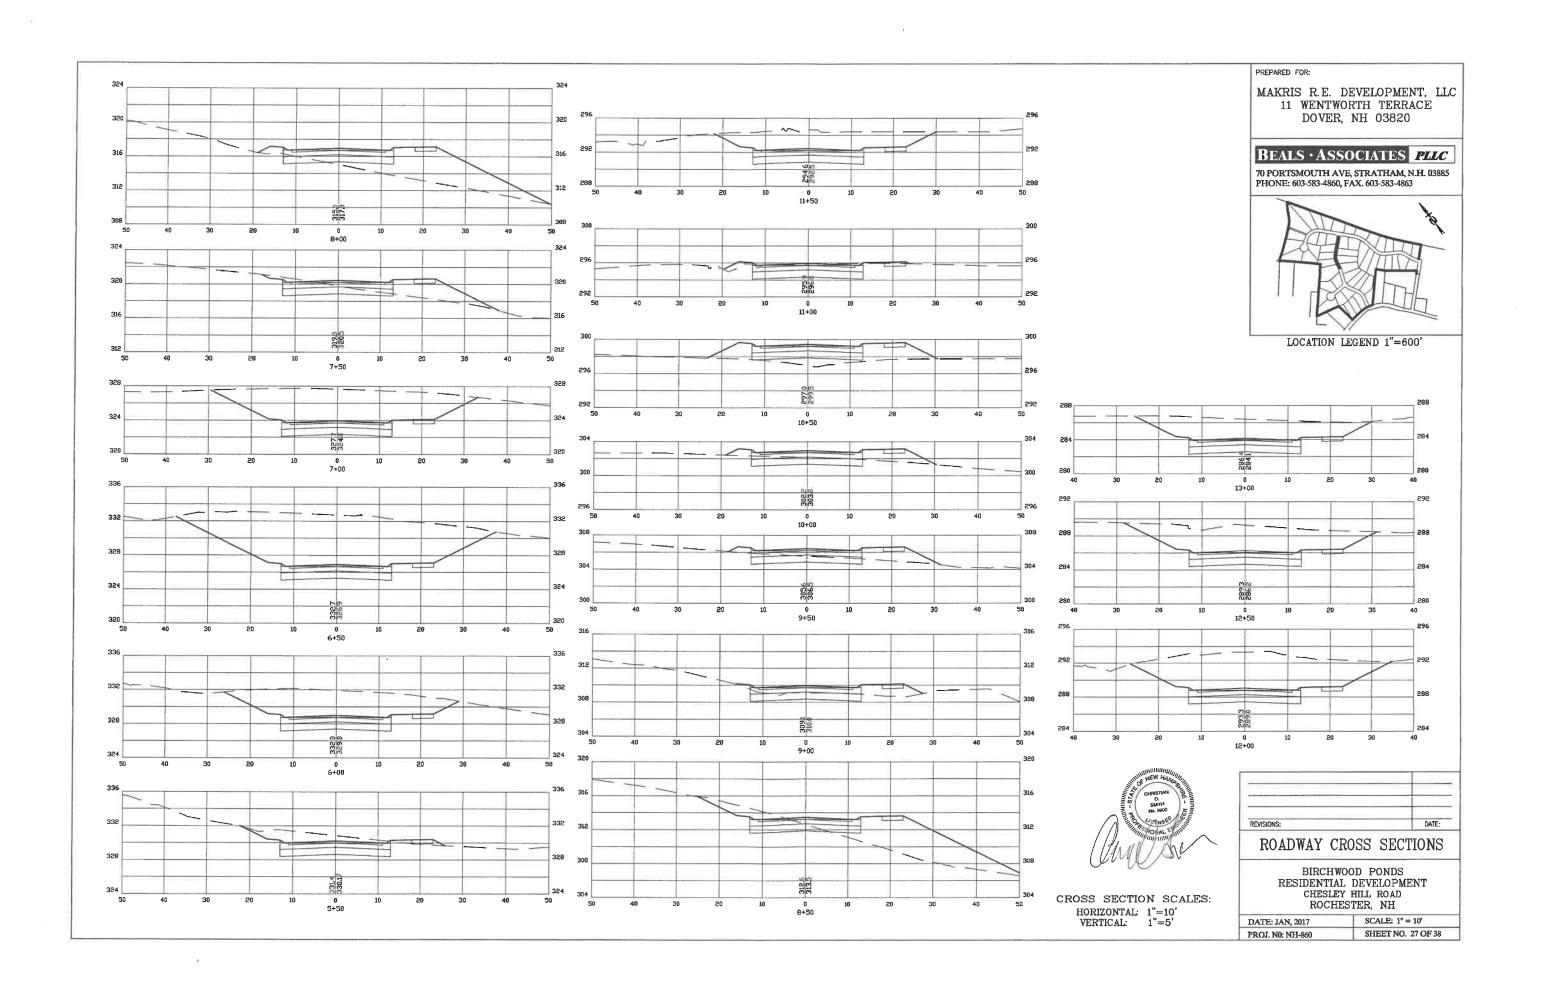

LOCATION LEGEND 1"=600'

PREPARED FOR:

MAKRIS R.E. DEVELOPMENT, LLC 11 WENTWORTH TERRACE DOVER, NH 03820

BEALS · ASSOCIATES PLLC

70 PORTSMOUTH AVE, STRATHAM, N.H. 03885 PHONE: 603-583-4860, FAX. 603-583-4863





CROSS SECTION SCALES:
HORIZONTAL: 1"=10'
VERTICAL: 1"=5'


| REVISED PER REVIEW COMMENTS | 3/14/17 |
|-----------------------------|---------|
| REVISED ROAD PER TRG | 2/2/17 |

ROADWAY CROSS SECTIONS

| DATE: JAN, 2017 | SCALE: 1" = 10' | |
|------------------|--------------------|--|
| PROJ. NO: NH-860 | SHEET NO. 28 OF 38 | |

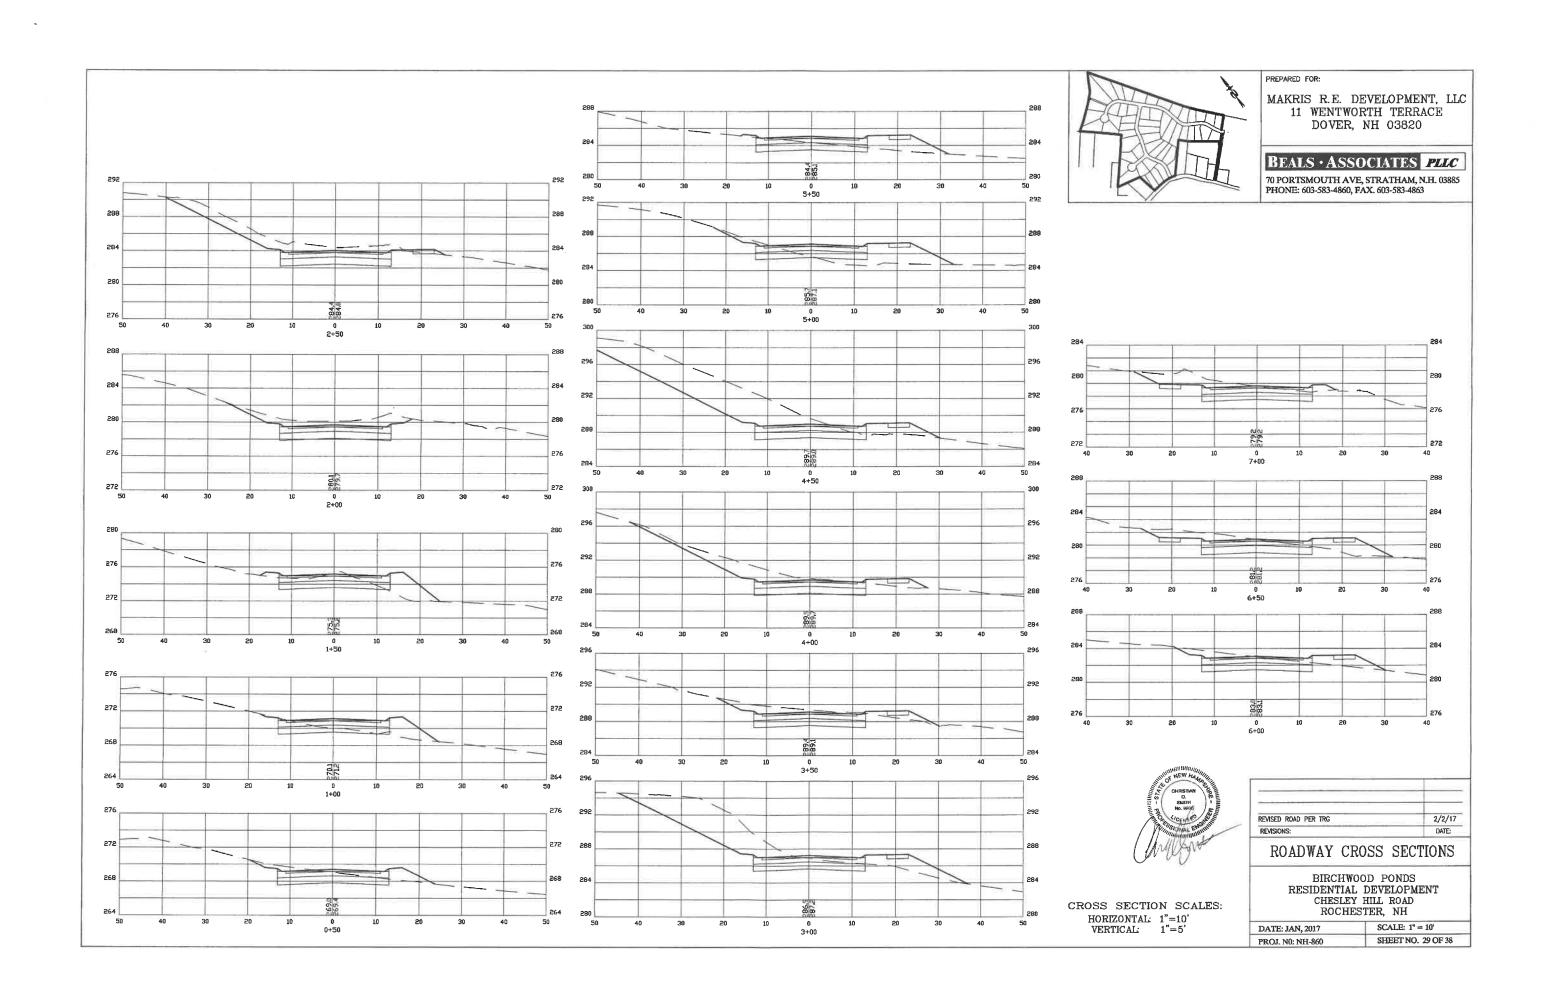

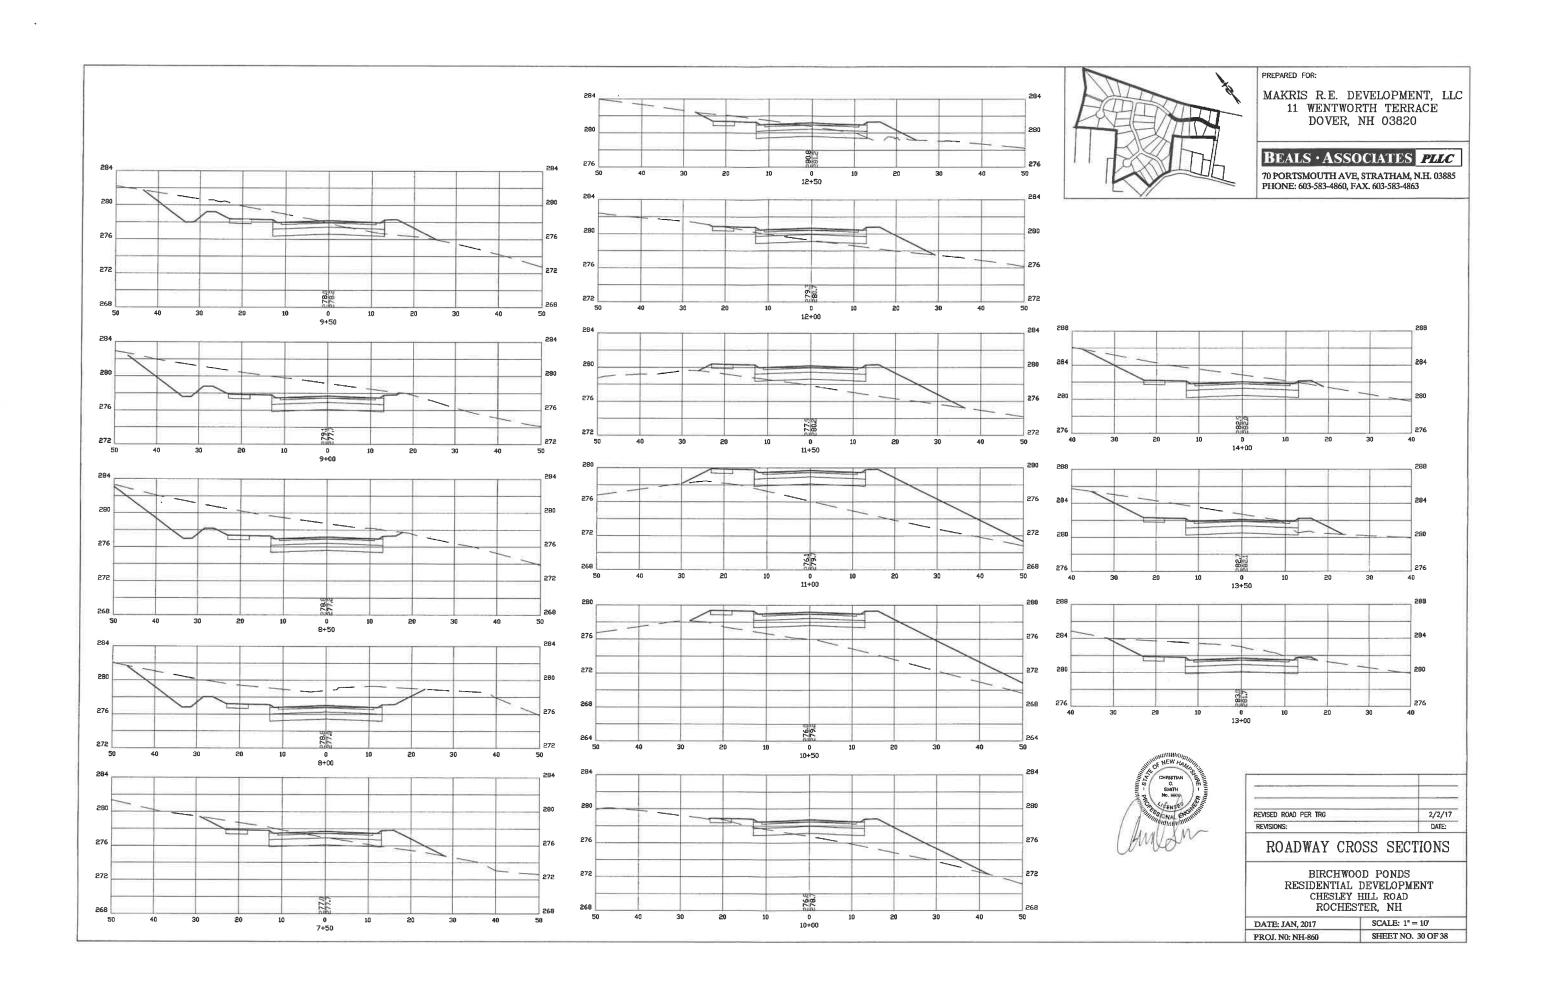

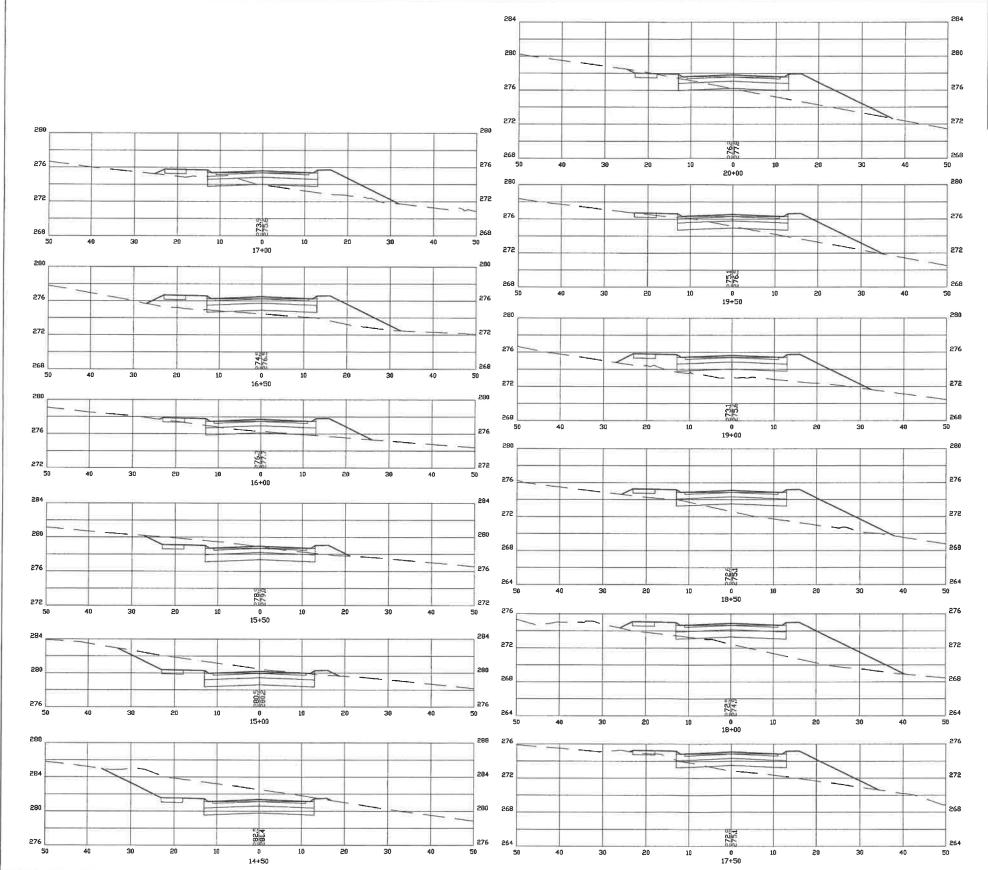



PREPARED FOR:

MAKRIS R.E. DEVELOPMENT, LLC 11 WENTWORTH TERRACE DOVER, NH 03820

BEALS · ASSOCIATES PLLC


70 PORTSMOUTH AVE, STRATHAM, N.H. 03885 PHONE: 603-583-4860, FAX. 603-583-4863



| REVISED ROAD PER TRG | 2/2/17 |
|----------------------|--------|
| | DATE: |

ROADWAY CROSS SECTIONS

| DATE: JAN, 2017 | SCALE: 1" = 10" |
|------------------|--------------------|
| PROJ. NO: NH-860 | SHEET NO. 31 OF 38 |

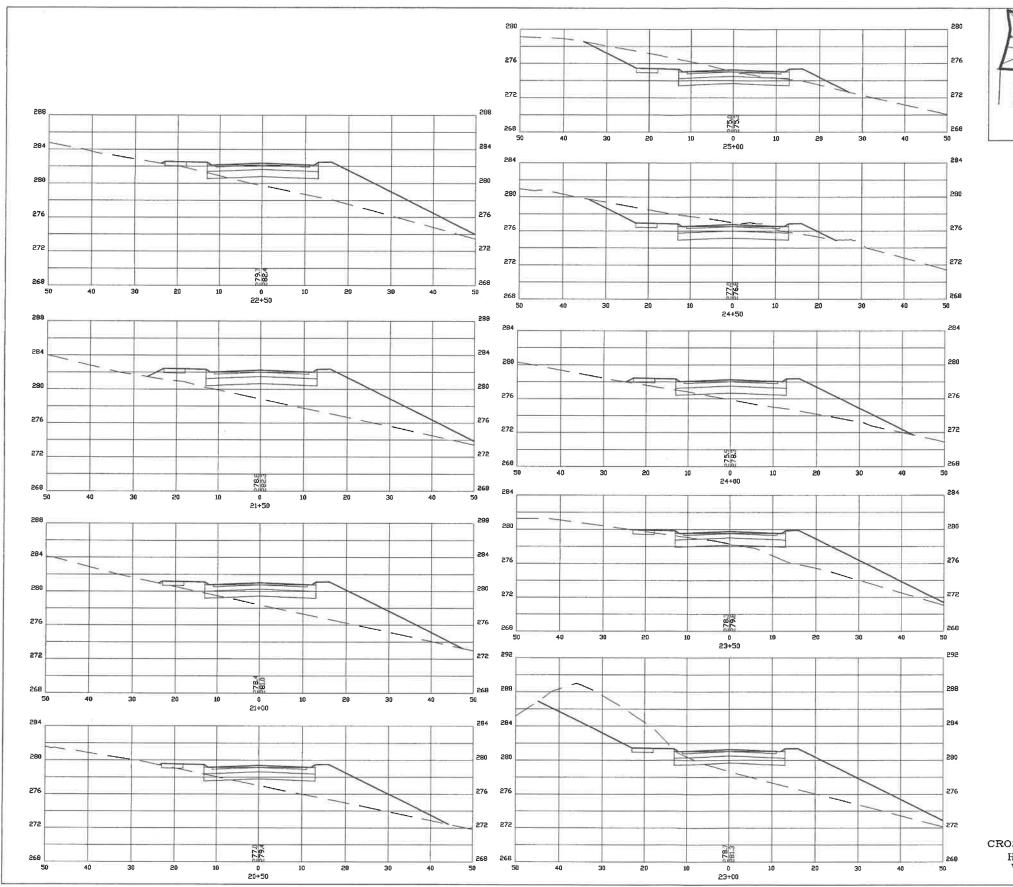



PREPARED FOR

MAKRIS R.E. DEVELOPMENT, LLC 11 WENTWORTH TERRACE DOVER, NH 03820

BEALS · ASSOCIATES PLLC

70 PORTSMOUTH AVE, STRATHAM, N.H. 03885 PHONE: 603-583-4860, FAX. 603-583-4863





CROSS SECTION SCALES:
HORIZONTAL: 1"=10'
VERTICAL: 1"=5'


| REVISED ROAD PER TRG | 2/2/17 |
|----------------------|--------|
| REVISIONS: | DATE: |

ROADWAY CROSS SECTIONS


| DATE: JAN, 2017 | SCALE: 1" = 10' |
|------------------|--------------------|
| PROJ. NO: NH-860 | SHEET NO. 32 OF 38 |

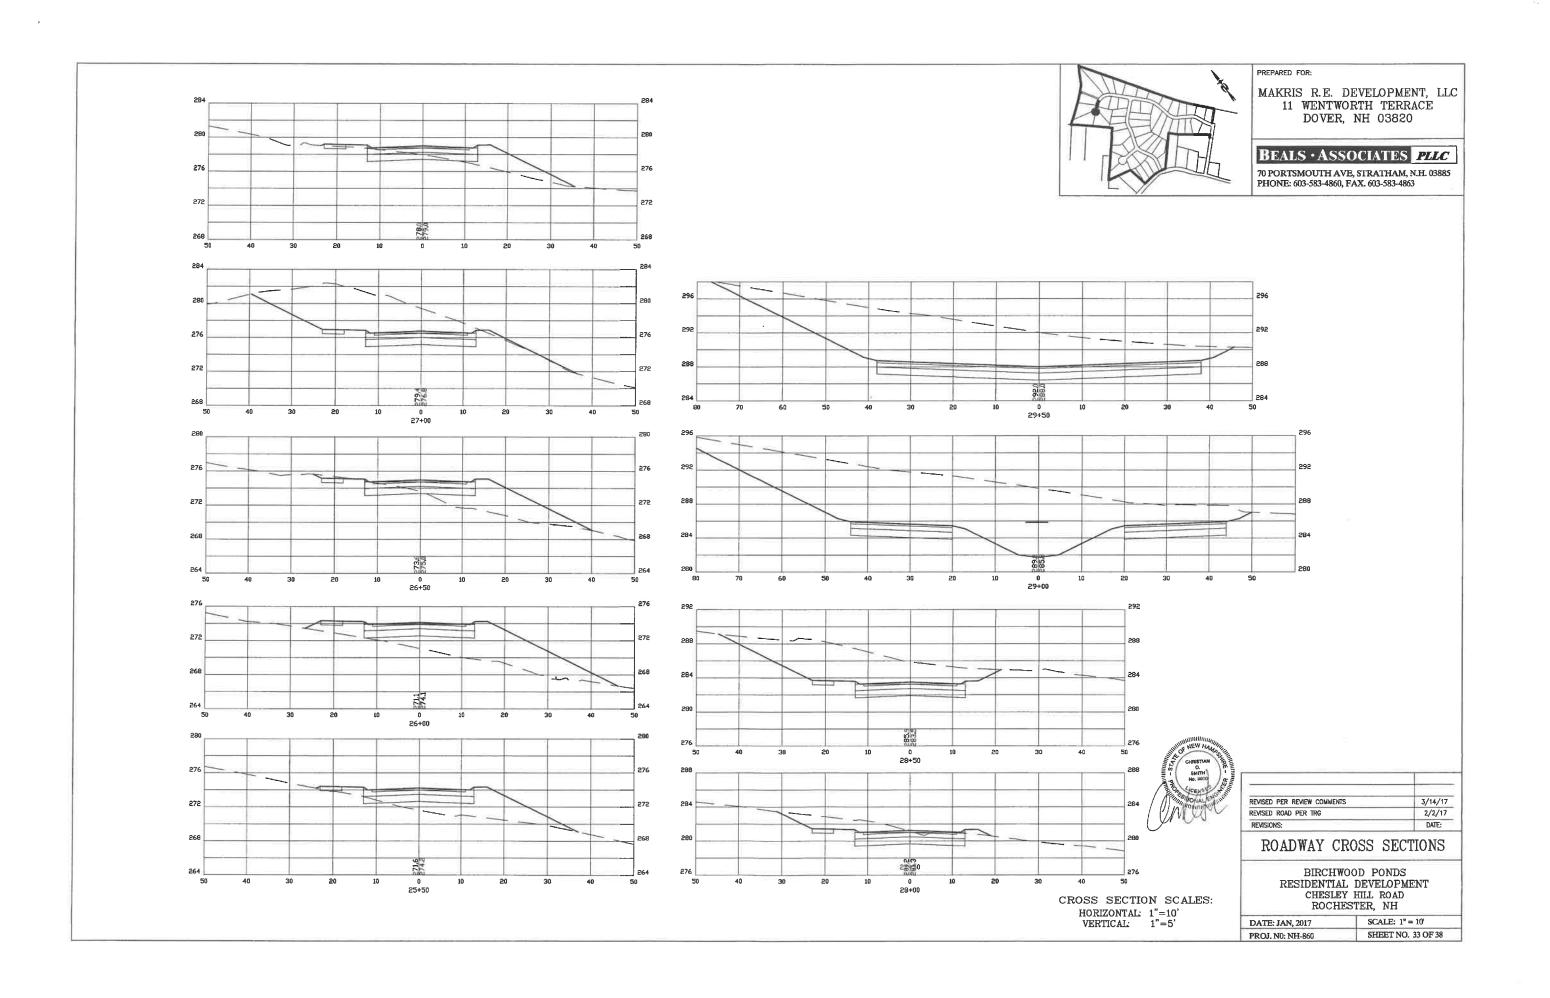

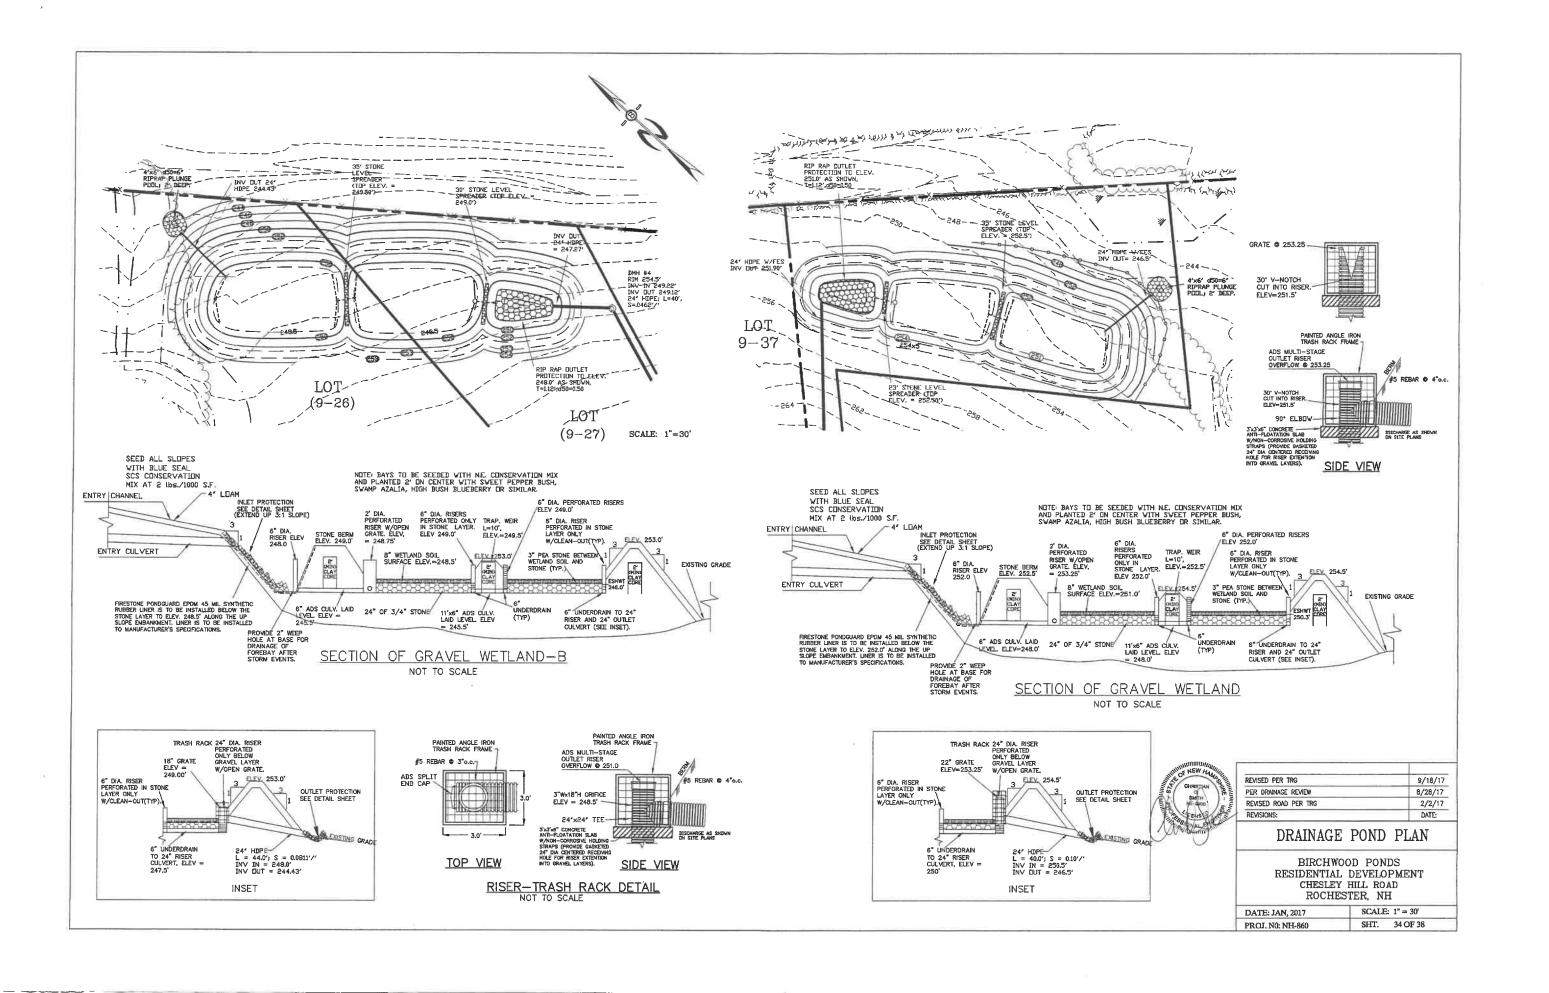

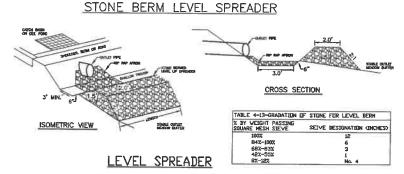

- 1. CONSTRUCT THE LEVEL SPREADER LIP ON A 0% GRADE TO INSURE UNIFORM SPREADING OF RUNOFF.
- 2. LEVEL SPREADER SHALL BE CONSTRUCTED ON UNDISTURBED SOIL AND NOT ON FILL.
- 3. THE ENTIRE LEVEL LIP AREA SHALL BE PROTECTED BY PLACING EXCELSIOR ENFORCER MATTING BENEATH THE STONE. EACH STRIP SHALL, OVERLAP BY AT LEAST SIX INCHES.
- 4. THE FLOW FROM THE LEVEL SPREADER SHALL OUTLET ONTO STABILIZED AREAS. WATER SHOULD NOT RE-CONCENTRATE IMMEDIATELY BELOW THE SPREADER.
- 5. MAINTENANCE: THE LEVEL SPREADER SHOULD BE CHECKED PERIODICALLY AND AFTER EVERY MAJOR STORM TO DETERMINE IF THE LIP HAS BEEN DAMAGED AND THE DESIGN CONDITIONS HAVE NOT CHANGED. ANY DETRIMENTAL SEDIMENT ACCUMULATION SHOULD BE REMOVED. IF STONE REMOVAL HAS TAKEN PLACE ON THE LIP, THEN THE DAMAGE SHOULD BE REPAIRED.

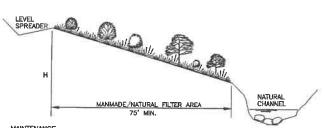


MAINTENANCE

- MAIN ENANCE.

 I. FILTER STRIPS SHOULD BE MAINTAINED AS NATURAL AREAS ONCE THE VEGETATION IS ESTABLISHED. THE FILTER STRIP SHOULD BE PROTECTED FROM DAMAGE BY FIRE, GRAZING, TRAFFIC, AND DENSE WEED GROWTH. FERTILIZATION NEEDS SHOULD BE DETERMINED BY ON SITE INSPECTIONS. SUPPLEMENTAL FERTILIZER IS USUALLY THE KEY TO COMPLETE THE ESTABLISHMENT OF THE STRIP SINCE MOST SPECIES TAKE 2 TO 3 YEARS TO BECOME FULLY ESTABLISHED.
- THE FILTER STRIP SHOULD BE INSPECTED PERIODICALLY AND AFTER EVERY MAJOR RAINSTORM TO DETERMINE IF THE ENTRANCE CONDITIONS ARE STILL UNIFORM AND LEVEL AND TO SEE IF RILLS HAVE FORMED. ANY PROBLEM AREAS SHOULD BE REPAIRED PROMPTLY TO PREVENT FURTHER DETERIORATION.


DEVELOPED AREA BUFFER DETAIL

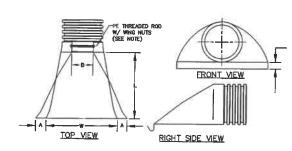

| PART No. | PIPE SIZE | A | B(MAX) | н | L | w |
|----------|---------------|-----------------|--------|----------------|----------------|----------------|
| 1510-NP | 15" | 6.5" | 10" | 6.5" | 25" | 29* |
| | 375 mm | 165 mm | 254 mm | 165 mm | 635 mm | 735 mm |
| 1810-NP | 18" | 7.5" | 15° | 6.5" | 32" | 35" |
| | 450 mm | 190 mm | 380 mm | 165 mm | 812 mm | 890 mm |
| 2410-NP | 24" | 7.5" | 18° | 6.5" | 36" | 45" |
| | 600 mm | 190 mm | 450 mm | 165 mm | 900 mm | 1140 mm |
| 3010-NP | 30" 750 mm | 10.5" 266 mm | N/A | 7.0" 178 mm | 53° 1345 mm | 68" 1725 mm |
| 3610-NP | 36" 900 mm | 10.5" 266 mm | N/A | 7.0" 178 mm | 53" 1345 mm | 68* 1725 mm |

PE THREADED ROD W/ WING NUTS PROVIDED FOR END SECTIONS 15"-24". 30" & 36" END SECTIONS TO BE WELDED PER MANUFACTURER'S RECOMMENDATIONS.

ADS N-12 FLARED END SECTIONS
NOT TO SCALE (ALL DIMENSIONS ARE NOMINAL)

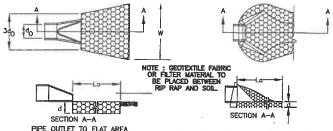

PIPE OUTLET TO FLAT AREA WITH NO DEFINED CHANNEL

PIPE OUTLET TO WELL-DEFINED CHANNEL

WITH NO DEFINED CHANNEL
PIPE QUILET TO WELL—DEFINED CHANNEL

CONSTRUCTION SPECIFICATIONS

1. THE SUB GRADE FOR THE FILTER MATERIAL, GEOTEXTILE FABRIC, AND RIP RAP SHALL BE PREPARED TO THE LINES AND GRADES SHOWN ON THE PLANS.


2. THE ROCK OR GRAVEL USED FOR FILTER OF RIP RAP SHALL CONFORM TO THE SPECIFIED GRADATION. 3. GEOTEXTILE FABRICS SHALL BE PROTECTED FROM PUNCTURE OR TEARING DURING THE PLACEMENT OF THE ROCK RIP RAP. DAMAGED AREAS IN THE FABRIC SHALL BE RAPIRED BY PLACING A PIECE OF FABRIC OVER THE DAMAGED AREA OR BY COMPLETE REPLACEMENT OF THE FABRIC. ALL OVERLAPS REQUIRED FOR REPAIRS OR JOINING TWO PIECES OF FABRIC SHALL BE A MINIMUM OF 12 INCHES.

4. STONE FOR THER IP RAP MAY BE PLACED BY EQUIPMENT AND SHALL BE CONSTRUCTED

TO THE FULL LAYER THICKNESS IN ONE OPERATION AND IN SUCH A MANNER AS TO PREVENT SECREGATION OF THE STONE SIZES.

5. STONE FOR RIRAP SHALL BE ANGULAR OR SUBANGULAR. THE STONES SHAPED SO THAT THE LEAST DIMENSION OF THE STONE FRAGMENT.

6. FLAT ROCKS SHALL NOT USED FOR RIP RAP. VOIDS IN THE ROCK RIPRAP SHOULD BE FILLED WITH SPALLS AND SMALLER ROCKS.

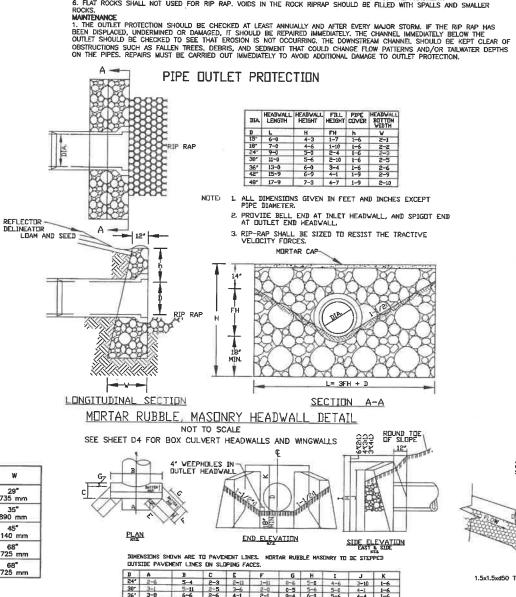

MORTAR RUBBLE, MASONRY HEADWALL W/ 45° WINGWALLS NOT TO SCALE

TABLE 7-24--RECOMMENDED RIP RAP GRADATION RANGES THICKNESS OF RIP RAP = 0.50 FEET FEET INCHES % OF WEIGHT SMALLER THAN THE GIVEN d50 SIZE SIZE OF STONE (INCHES) 85% 50% 15%

| TABLE 7-24-RECOMMENDED R | IP RAP GRADATION RANGES |
|--|----------------------------------|
| THICKNESS OF RIP RAP = 0.7 | 5 FEET |
| d50 SIZE= 0.75 | FEET 9 INCHES |
| % OF VEIGHT SMALLER THAN THE GIVEN d50 SIZE | SIZE OF STONE(INCHES) FROM TO |
| 100% | 14 18 |
| 85% | 12 16 |
| 50% | 9 14 |
| 15% | 3 5 |

DUCTSLE BROW FRAME AND GRATE VITN HED LIADING PANNEX ER

DR COMC. RINGS. CIR" MAX.)


PREPARED FOR: MAKRIS R.E. DEVELOPMENT, LLC

BEALS · ASSOCIATES PLLC 70 PORTSMOUTH AVE, STRATHAM, N.H. 03885 PHONE: 603-583-4860, FAX. 603-583-4863

LOAM AREA | PAVED AREA

11 WENTWORTH TERRACE

DOVER. NH 03820

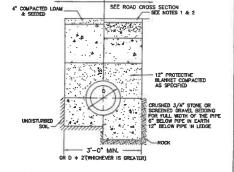



E:

1. PAVEMENT REPAIR IN EXISTING ROADWAYS SHALL
CONFORM TO STREET OPENING REGULATIONS.

2. NEW ROADWAY CONSTRUCTION SHALL CONFORM TO
SUBDIVISION SPEC'S.

TYPICAL DRAINAGE TRENCH

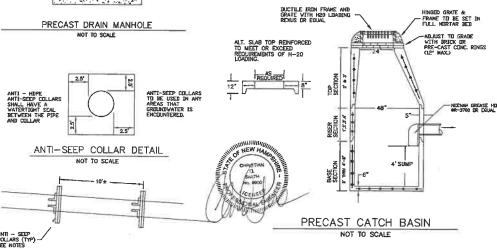


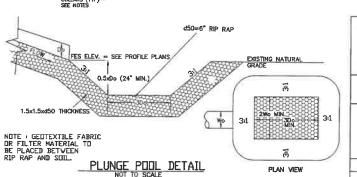


| REVISED PER REVIEW COMMENTS | 9/18/17 |
|-----------------------------|---------|
| REVISED PER REVIEW COMMENTS | 3/14/17 |
| REVISED ROAD PER TRG | 2/2/17 |
| REVISIONS: | DATE: |


CONSTRUCTION DETAILS D1

| DATE: JAN, 2017 | | SCALE: NTS | |
|-----------------|------------------|--------------------|--|
| 1 | PROJ. NO: NH-860 | SHEET NO. 35 OF 38 | |

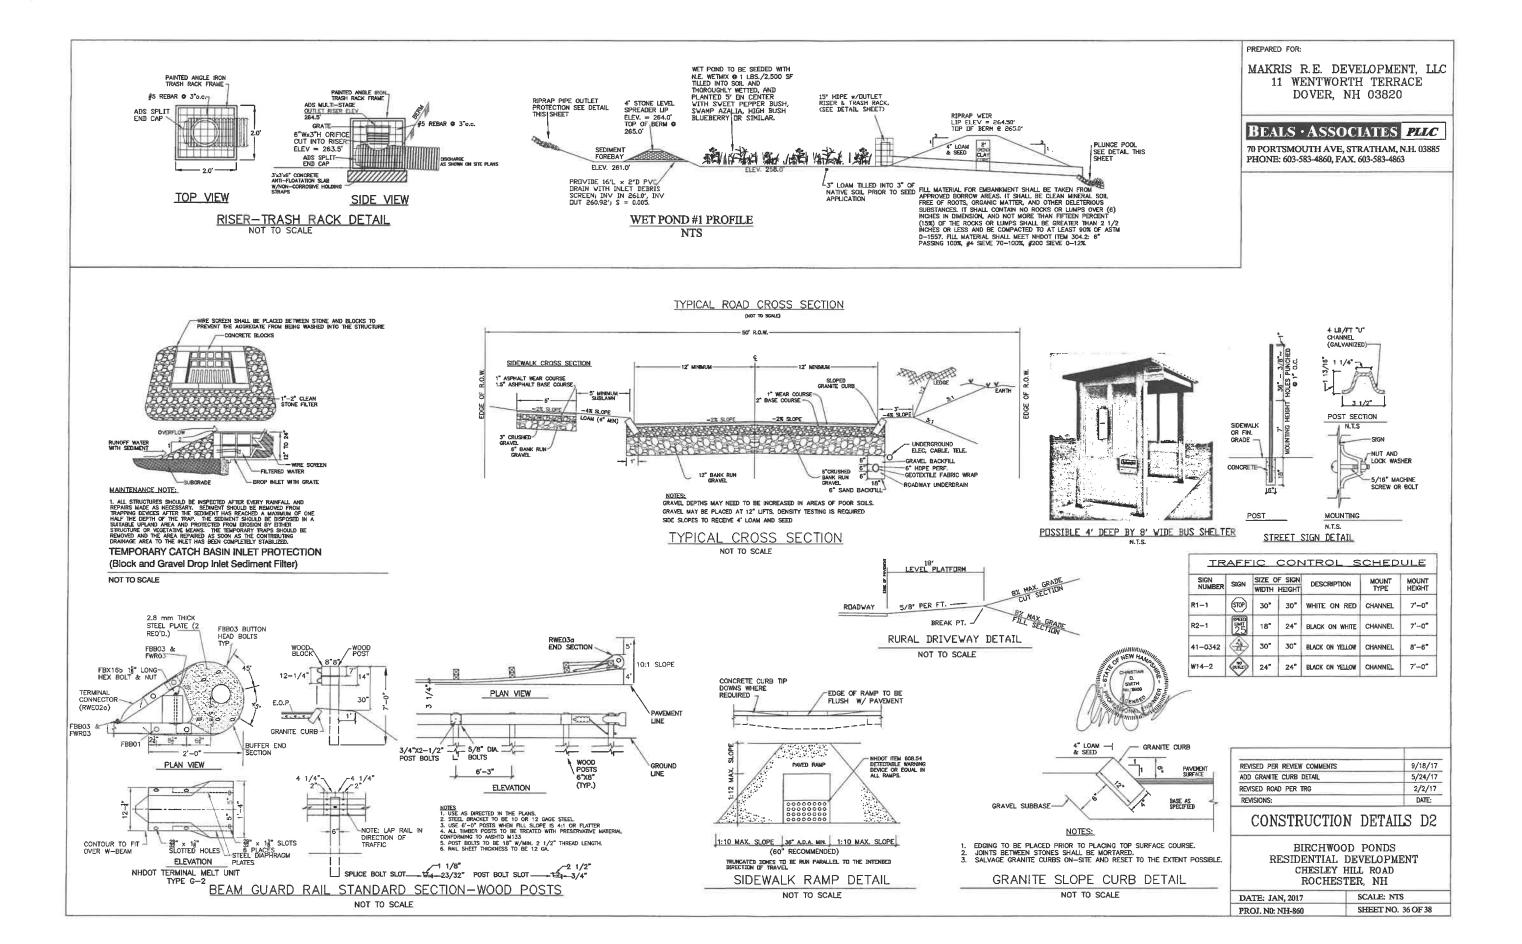


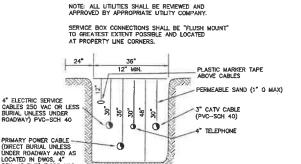


UTILITY TRENCH DETAIL

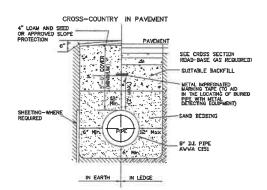

TYPICAL TRENCH DETAIL FOR WATER SYSTEM

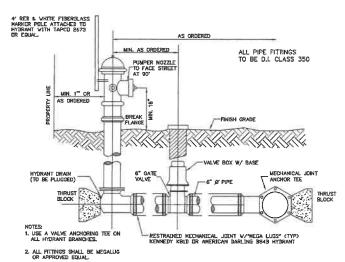

LOW PRESSURE HYDRANTS SHALL BE PAINTED ALL RED. HIGH PRESSURE HYDRANTS SHALL BE RED WITH YELLOW CAPS. HYDRANT INSTALLATION DETAIL

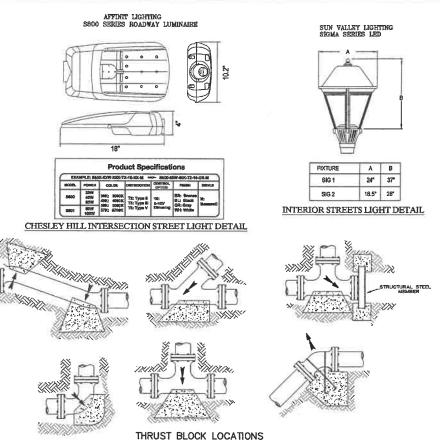

TYPICAL THRUST BLOCK DETAILS

- 1. BLOCKS MUST BE POURED AGAINST UNDISTURBED SOIL. 2. PIPE JOINTS AND BOLTS MUST BE ACCESSIBLE

TEST PLUG -

EXISTING WATERMAIN

3. CONCRETE SHOULD BE CURED AT LEAST 5 DAYS AND SHALL HAVE A COMPRESSIVE STRENGTH OF 2000 PSI AT 28 DAYS. BLOCKS MUST BE POSITIONED TO COUNTERACT THE DIRECTION OF THE

SLEEVE W/8" OUTLET FLANGE OR APPROVED EQUA

WATER MAIN TAPPING SLEEVE DETAIL
NOT TO SCALE

-VALVE CAP TO BE SET FLUSH

SAVEY CLAY 6500 HARD CLAY 5000



SOILS BEARING CAPACITY
SOIL BARING
LOAD

NOTE: TO DETERMINE THRUST AT PRESSURES OTHER THAN 100 PSI, MULTIPLY THE THRUST OBTAINED IN THE TABLE BY THE RATIO OF THE PRESSURE TO 100. FOR EXAMPLE: THE THRUST ON A 12", 90" SEND 9 125 PSI IS:

1'-8" POLE FOUNDATION

LIGHT BASE DETAIL SCALE: NONE

THRUST FORCES ARE CREATED IN A PIPELINE AT CHANGES IN DIRECTION, TEF, DEADENDS OR WHERE CHANGES IN PIPE SIZE OCCUR AT REDUCERS. AVAILABLE RESTRAINT METHODS INCLUDE CONCRETE THRUST BLOCKS,

RESULTANT THRUST AT FITTINGS @ 100 PSI PREPARED FOR:

MAKRIS R.E. DEVELOPMENT, LLC 11 WENTWORTH TERRACE DOVER, NH 03820

BEALS · ASSOCIATES PLLC

70 PORTSMOUTH AVE, STRATHAM, N.H. 03885 PHONE: 603-583-4860, FAX. 603-583-4863

NOTES

- ORDERED EXCAVATION OF UNSUITABLE MATERIAL BELOW GRADE: REFILL WITH BEDDING MATERIAL. (SEE NOTE 6 ALSO)
- BEDDING: MINIMUM 12" SAND BLANKET AS SPECIFIED AND REMAINING FILL AS SCREENED GRAVEL AND/OR CRUSHED STONE FREE FROM CLAY, LOAM, ORGANIC MATERIAL AND MEETING ASTM C-33 STONE SIZE No. 67


| | 100% | PASSING | 1 | INCH | SCR |
|--|---------|---------|-----|------|-------|
| | 90-100% | PASSING | 3/4 | INCH | SCR |
| | 20-50% | PASSING | 3/8 | INCH | SCR |
| | 0-10% | PASSING | No. | 4 | SIEVE |
| | 0-EW | DAPCIMO | Ma | | CHENT |

WHERE ORDERED BY THE ENGINEER TO STABILIZE THE TRENCH BASE, GRADED SCREENED GRAVEL OR CRUSHED STONE 3/4 INCH TO $1\!-\!1/2$ INCH SHALL BE USED.

- 3) SUITABLE MATERIAL IN ROADS, ROAD SHOULDERS, WALKWAYS, AND TRAVELED WAYS: SUITABLE MATERIAL FOR TRENCH BACKFILL SHALL BE THE NATURAL MATERIAL EXCAVATED DURING THE COURSE OF CONSTRUCTION, BUT SHALL EXCLUDE DEBRIS, PIECES OF PAVEMENT, ORGANIC MATTER, TOP SOIL, ALL EXCLUDE DEBRIS, PIECES OF PAVEMENT, ORGANIC MATER, TOP SOIL, ALL EXCLOVER DEBRIS TO SOL ALL EXCLOVER SIX INCHES IN LARGEST DIMENSION.
- 4) BASE COURSE: IF ORDERED BY THE ENGINEER, SHALL MEET THE REQUIREMENTS OF DIVISION 300 OF THE LATEST EDITION OF THE STANDARD SPECIFICATIONS FOR ROAD AND BRIDGE CONSTRUCTION OF THE STATE OF NEW HAMPSHIRE, IDPARTMENT OF TRANSPORTATION.
- WOOD SHEETING: IF REQUIRED, WHERE SHEETING IS PLACED ALONG SIDE THE PIPE AND EXTENDS BELOW MID-DIAMETER. IT SHALL BE CUT OFF AND LEFT IN PLACE TO AN ELEVATION NOT LESS THAN ONE FOOT ABOVE THE TOP OF THE PIPE. WHERE SHEETING IS ORDERED BY THE ENGINEER TO BE LEFT IN PLACE, IT SHALL BE CUT OFF AT LEAST 3 FEET BELOW FINISHED GRADE, BUT NOT LESS THAN ONE FOOT ABOVE THE TOP OF THE PIPE.
- 6) W = MAXIMUM ALLOWABLE TRENCH WIDTH TO A PLANE 12 INCHES ABOVE THE PIPE FOR PIPES 15 INCHES NOMINAL DIAMETER OR LESS, W SHALL BE NO MORE THAN 36 NHORES FOR PIPES GREATER THAN 15 INCHES NOMINAL DIAMETER, W SHALL BE 24 NICHES PLUS PIPE O.D., W SHALL ALSO BE THE PAYMENT WIDTH FOR LEDGE EXCAVATION AND FOR ORDERED EXCAVATION SELOW GRADE.
- FOR CROSS COUNTRY CONSTRUCTION: BACKFILL OR FILL SHALL BE MOUNDED TO A HEIGHT OF 6 INCHES ABOVE THE ORIGINAL GROUND SUFFACE.
- DUCTILE-IRON PIPE, FITTINGS AND JOINTS:
 DUCTILE IRON PIPE AND FITTINGS SHALL CONFORM TO THE FOLLOWING STANDARDS OF THE UNITED STATES OF AMERICA STANDARDS INSTITUTE
 ANSI A21.50/AWWA C150 THICKNESS DESIGN OF DUCTILE—IRON PIPE AND WITH ASTM A-536 DUCTILE—IRON CASTINGS ANSI A21.51/AWWA C151 DUCTILE-IRON PIPE, CENTRIFUGALLY CAST IN METAL MOLDS OR SAND-LINED MOLDS FOR WATER OR OTHER
- LIQUIDS

 2- JOINTS SHALL BE OF THE MECHANICAL OR PUSH-ON TYPE JOINTS

 AND GASKETS SHALL CONFORM TO ANSI A21.11/AWWA
 C11 RUBBER GASKET JOINTS FOR DUCTILE IRON
 PRESSURE PIPE AND FITTINGS
- 9) ALL WATER LINES SHALL BE DISINFECTED AND PRESSURE TESTED TO THE APPROVAL OF THE SEWER COMMISSION. MIN. TEST PRESSURE 150 PSI OR 1 1/2 TIMES THE WORKING PRESSURE WHICH EVER IS GREATER.

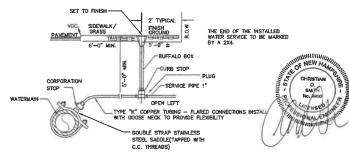


TYPICAL WATER SERVICE CONNECTION

| REVISED PER REVIEW COMMENTS | 5/24/17 |
|-----------------------------|---------|
| REVISED PER REVIEW COMMENTS | 4/17/17 |
| REVISED ROAD PER TRG | 2/2/17 |
| REVISIONS: | DATE: |

UTILITY DETAILS

| DATE: JAN, 2017 | SCALE: NTS | | |
|------------------|--------------------|--|--|
| PROJ. NO: NH-860 | SHEET NO. 37 OF 38 | | |

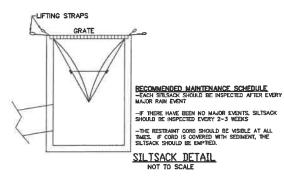

EROSION PROTECTION TYPE E

TEMPORARY ERUSION CONTROL MEASURES

- THE SMALLEST PRACTICAL AREA SHALL BE DISTURBED DURING CONSTRUCTION, BUT NO MORE THAN 5 ACRES OF LAND SHA BE EXPOSED BEFORE DISTURBED AREAS ARE STABILIZED.
 EROSION, SEDIMENT AND DETERMINE MEASURES SHALL BE INSTALLED AS SHOWN ON THE PLANS AND AT LOCATIONS AS REQUIRED OR DIRECTED BY THE ENGINEER ALL DISTURBED AREAS SHALL BE RETURNED TO ORIGINAL GRADES AND ELEVATIONS
- 3. DISTURBED AREAS SHALL BE LOAMED WITH A MINIMUM OF 4" OF LOAM AND SEEDED WITH NOT LESS THAN 1.10 POUNDS OF SEED PER 1000 SQUARE FEET OF AREA. (48 POUNDS PER ACRE) SEE SEED SPECIFICATIONS THIS SHEET.
 4. SILT FENCES AND OTHER EROSION CONTROLS SHALL BE INSPECTED WEEKLY AND AFTER EVERY RAIN EVENT GREATER THAN
- 0.25" DURING THE LIFE OF THE PROJECT, ALL DAMAGED AREAS SHALL BE REPAIRED, SEDIMENT DEPOSITS SHALL PERIODICALLY BE REMOVED AND DISPOSED OF.
- BE REMOVED AND DISPOSED OF.

 5. AFTER ALL DISTURBED AREAS HAVE BEEN STABILIZED, THE TEMPORARY EROSION CONTROL MEASURES ARE TO BE REMOVED AND
- 5. AFTER ALL DISTURBED AREAS HARE BEEN STABILIZED, THE TEMPORARY EROSION CONTROL MEASURES ARE TO BE REMOVED AND THE AREA DISTURBED BY THE REMOVAL SMOOTHED AND RE-VEGETARD.

 8. AREAS MUST BE SEEDED AND MULCHED IMMEDIATELY UPON FINAL CRADING, PERMANENTLY STABILIZED WITHIN 14 DAYS OF FINAL GRADING, OR TEMPORARILY STABILIZED WITHIN 30 DAYS OF INITIAL DISTURBANCE OF SOIL (MIMIDIATELY MEANS AS SSOIN AS PRACTICABLE, BUT NO LATER THAN THE BEN OF THE NEXT WORK DAY, FOLLOWING THE DAY EARTH DISTURBING ACTIVITIES TEMPORARILY OR PERMANENTLY CEASED. * AN AREA SMALL BE CONSIDERED STABLE IF ONE OF THE FOLLOWING HAS
 - BASE COURSE GRAVELS HAVE BEEN INSTALLED IN AREAS TO BE PAVED. - A MINIMUM OF 85% VEGETATED GROWTH HAS BEEN ESTABLISHED.
 - A MINIMUM OF 3 INCHES OF NON-EROSIVE MATERIAL SUCH AS RIPRAP HAS BEEN INSTALLED.
 - ON CONTROL BLANKETS HAVE BEEN PROPERLY INSTALLED.

CONSTRUCTION SPECIFICATIONS

- A STRUCTURES SHALL BE INSTALLED ACCORDING TO THE DIMENSIONS SHOWN ON THE PLANS AT THE APPROPRIATE SPACING.

 2. CONSTRUCTION OPERATIONS SHALL BE CARRIED OUT IN SUCH A MANNER SO THAT EROSION AND AIR AND
- WATER POLLUTION WILL BE MINIMIZED.

 3. WHEN HAY BALES ARE USED, THE BALES SHALL BE EMBEDDED AT LEAST 4 INCHES INTO THE SOIL WHEN
- TIMBER STRUCTURES ARE USED, THE TIMBER SHALL EXTEND AT LEAST 18" INTO THE SOIL.

 4. HAY OR STRAW BALES SHALL BE ANCHORED INTO THE SOIL USING 2" X 2" STAKES DRIVEN THROUGH THE BALES AND AT LEAST 18 INCHES TO 11 TO THE SOIL.

 5. SEEDING, FERTILIZING, AND MULCHING SHALL CONFORM TO THE RECOMMENDATIONS IN THE APPROPRIATED
- SECEDITION FERTILIZED AND ADDRESS OF THE CHANNEL WHEN THEIR USEFUL LIFE HAS BEEN COMPLETED.

 7. THROUGHOUT THE DURATION OF CONSTRUCTION ACTIVITIES THE CONTRACTOR SHALL TAKE PRECAUTIONS AND INSTRUCTIONS FROM THE PLANNING DEPARTMENT IN ORDER TO PREVENT, ABATE AND CONTROL THE EMISSION OF FUGITIVE DUST INCLUDING BUT NOT LIMITED TO WETTING, COVERING, SHIELDING, OR
- VACUUMING.

 8. THE NH COMMISSIONER OF AGRICULTURE PROHIBITS THE COLLECTION, POSSESSION, IMPORTATION, TRANSPORTATION, SALE, PROPAGATION, TRANSPLANTATION, OR CULTIVATION OF PLANTS BANNED BY NH LAW RSA 430: 53 AND NH CODE ADMINISTRATIVE RULES AGR 3800. THE PROJECT SHALL MEET ALL REQUIREMENTS AND THE INTENT OF . RSA 430: 53 AND AGR 3800 RELATIVE TO INVASIVE SPECIES 9. THIS PROJECT IS REGULATED UNDER EPA NPDES CONSTRUCTION GENERAL PERMIT. THE CONSTRUCTION
- SITE OPERATOR AND OWNER SHALL SUBMIT A NOTICE OF INTENT (NOI) TO USEPA, WASHINGTON, DC, STORMWATER NOTICE PROCESSING CENTER AT LEAST SEVEN DAYS PRIOR TO COMMENCEMENT OF WO ON SITE. EPA WILL POST THE NOI AT http://cfpubl.epa.gov/npdes/stormwater/noi/noisearch.cfm. AUTHORIZATION IS GRANTED UNDER THE PERMIT ONCE THE NOI IS SHOWN IN "ACTIVE STATUS".

CONSTRUCTION SEQUENCE

- CONSTRUCTION SEQUENCE

 1. CUT AND REMOVE TREES IN CONSTRUCTION AREAS AS REQUIRED OR DIRECTED.

 2. CONSTRUCT AND/OR INSTALL TEMPORARY AND PERMANENT SEDIMENT EROSION AND DETENTION CONTROL FACILITIES AS REQUIRED. EROSION, SEDIMENT AND DETENTION CONTROL FACILITIES SHALL BE INSTALLED AND STABILIZED PRIOR TO ANY EARTH MOVING OPERATION AND PRIOR TO DIRECTING RUNOFF TO THEM.

 3. CLEAR, CUT, GRUB AND DISPOSED OF DEERS IN APPROVED FACILITIES, STUMPS AND DEBRIS ARE TO BE REMOVED FROM SITE AND DISPOSE OF PERSIS IN APPROVED FACILITIES, STUMPS AND DEBRIS ARE TO BE REMOVED FROM SITE AND DISPOSED OF PER STATE AND LOCAL REGULATIONS IN PHASES AS DIRECTED.

 4. EXCAVATE AND STOCKPILE TOPSOIL /LOAM, STOCKPILING SHALL NOT TAKE PLACE ON SLOPES GREATER THAN 10%, ALL AREAS SHALL BE STABILIZED IMMEDIATELY AFTER GRADING.

 5. CONSTRUCT THE ROADWAY/ORIVEWAYS AND ITS ASSOCIATED DRAINAGE STRUCTURES. ALL ROADWAYS, PARKING AREAS, AND CUT/FILL SLOPES SHALL BE STRUBLIZED AND/OR LOAMED AND SEEDED WITHIN 72—HOURS OF ACHIENING FINISH GRADE AS APPLICABILE.

 7. INSTALL PIPE AND CONSTRUCTION ASSOCIATED APPURTENANCES AS REQUIRED OR DIRECTED. ALL DISTURBED AREAS SHALL STABILIZED IMMEDIATELY AFTER GRADING.

 8. EGGIN PERMANENT AND TEMPORARY SEEDED WILL SHORT AFTER GRADING.

 8. EGGIN PERMANENT AND TEMPORARY SEEDED AND EARD AND CONSTRUCTION ASSOCIATION AND MULTING AND MULCHING. ALL CUT AND FILL SLOPES AND DISTURBED AREAS SHALL STABILIZED IMMEDIATELY AFTER GRADING.

 8. EGGIN PERMANENT AND TEMPORARY SEEDIL AND AND MICHOLORY OR SIRCUIRED, OR DIRECTED.

 9. DALY OR AS REQUIRED, CONSTRUCTED TEMPORARY SERVING, DRAINAGE CHECK DAMS, DITCHES, SEDIMENT TRAPS, ETC. TO PREVENT EROSION ON THE STE AND PREVENT ANY SILTATION OF ABUTTING WATERS OR PROPERTY.

 10. INSPECT AND MAINTAIN ALL EROSION AND SEDIMENT CONTROL MEASURES DURING CONSTRUCTION

- PROPERTY.

 IN PROPERTY.

 IN PROPERTY.

 IN INSPECT AND MAINTAIN ALL EROSION AND SEDIMENT CONTROL MEASURES DURING CONTINUATION

 IN INSPECT AND MAINTAIN ALL EROSION AND SEDIMENT CONTROL MEASURES DURING CONTINUATION


 IN COMPLETE PERMANENT SEEDING AND LANDSCAPING

 THEMSELVES TO NO LESS THEN 85%, AS DETERMINED BY THE CITY OF LACONIA PLANNING DEPARTMENT IN COMUNICATION WITH THE SITE ENGINEER, NO EROSION CONTROL DEVICES CAN BE REMOVED UNLESS INSPECIED BY THE ENGINEER AND PLANNING DEPARTMENT.

 IS ALL SWALES AND DRAINAGE STRUCTURES WILL BE CONSTRUCTED AND STABILIZED PRIOR TO HAVING RUNOFF DIRECTED TO THEM.

 14. FINISH PAVING ALL ROADWAYS/DRIVWAYS.

 LOT DISTURBANCE OTHER THAN THAT SHOWN ON THE APPROVED PLANS SHALL NOT COMMENCE UNTIL THE ROADWAY HAS THE BASE COURSE TO DESIGN ELEVATION AND THE ASSOCIATED DRAINAGE IS COMPLETE AND STABILE.

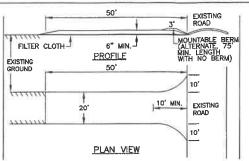

STONE FOR A STABILIZED CONSTRUCTION ENTRANCE SHALL BE MIN. 3 INCH STONE, RECLAIMED STONE,
OR RECYCLED CONCRETE EQUIVALENT.
 THE LENGTH OF THE STABILIZED ENTRANCE SHALL NOT BE LESS THAN 50-FEET (3"-6" MOUNTABLE
BERM REQUIRED), EXCEPT FOR A SINGLE RESIDENTIAL LOT WHERE A 30 FOOT MINIMUM LENGTH WOULD

BERM REQUIRED), EXCEPT FOR A SINGLE RESIDENTIAL LOT WHERE A 30 FOOT MINIMUM LENGTH WOULD APPLY.

3. THE THICKNESS OF THE STONE FOR THE STABILIZED ENTRANCE SHALL NOT BE LESS THAN 6 INCHES.

4. THE WIDTH OF THE ENTRANCE SHALL NOT BE LESS THAN THE FULL WIDTH OF THE ENTRANCE WHERE INGRESS OR ECRESS OCCURS OR 10 FEET, WHICH EVER IS GREATER.

5. GEOTEXTILE FILTER CLOTH SHALL BE PLACED OVER THE ENTRINE AREA PRIOR TO PLACING THE STONE. FILTER CLOTH IS NOT REQUIRED FOR A SINGLE FAMILY RESIDENCE LOT.

6. ALL SURFACE WATER THAT IS FLOWING TO OR DIVERTED TOWARD THE CONSTRUCTION ENTRANCE SHALL BE PIPED BENEATH THE ENTRANCE. IF PIPING IS IMPRACTICAL, A BERN WITH 5:1 SLOPES THAT CAN BE CROSSED BY VEHICLES MAY BE SUBSTITUTED FOR THE PIPE.

7. THE ENTRANCE SHALL BE MAINTAINED IN A CONDITION THAT WILL PREVENT TRACKING OR FLOWING OF SEDIMENT ONTO PUBLIC RIGHTS—OF—WAY. THIS MAY REQUIRE PERIODIC TOP DRESSING WITH ADDITIONAL STONE ASSURES LISTED TO TRAP

STONE AS CONDITIONS DEMAND AND REPAIR AND/OR CLEAN OUT OF ANY MEASURES USED TO TRAP SEDIMENT. ALL SEDIMENT SPILLED, WASHED, OR TRACKED ONTO PUBLIC RIGHT-OF-WAY MUST BE REMOVED

STABILIZED CONSTRUCTION ENTRANCE

WINTER MAINTENANCE

1. ALL DISTURBED AREAS THAT DO NOT HAVE AT LEAST 85% VEGETATIVE COVERAGE PRIOR TO OCTOBER 15TH, SHALL BE STABILIZED BY APPLYING MULCH AT A RATE OF 3-4 TONS PER ACRE. ALL SIDE SLOPES, STEEPER THAN 4:1, THAT ARE NOT DIRECTED TO SWALES OR DETENTION BASINS, SHALL BE LINED WITH BIODEGRADBLE/PHOTODEGRADBLE "JUTE MATTING" (EXCELSIOR'S CURLEX II OR EQUAL). ALL OTHER SLOPES SHALL BE MULCHED AND TACKED AT A RATE OF 3-4 TONS PER ACRE. THE APPLICATION OF MULCH AND/OR JUTE MATTING SHALL NOT OCCUR OVER EXISTING SNOW COVER. IF THE SITE IS ACTIVE AFTER NOVEMBER 15TH, ANY SNOW THAT ACCUMULATES ON DISTURBED AREAS SHALL BE REMOVED. PRIOR TO SPRING THAW ALL AREAS WILL BE STABILIZED, AS DIRECTED ABOVE.

2. ALL SWALES THAT DO NOT HAVE FULLY ESTABLISHED VEGETATION SHALL BE EITHER LINED WITH NORTH AMERICAN GREEN MAITING OR TEMPORARY STONE CHECK DAMS (APPROPRIATELY SPACED). STONE CHECK DAMS WILL BE MAINTAIL THROUGHOUT THE WINTER MONTHS. IF THE SWALES ARE TO BE MAITTED WITH PERMANDEL LINERS OR RIPRAP WITH ENGINEERING FABRIC, THIS SHALL BE COMPLETED PRIOR TO WINTER SHUTDOWN OR AS SOON AS THEY ARE PROPERLY GRADED AND SHAPED.

3. PRIOR TO NOV. 15TH ALL ROADWAY AND PARKING AREAS SHALL BE BROUGHT UP TO AND THROUGH THE BANK RUN GRAVEL APPLICATION. IF THESE AREAS' ELEVATIONS ARE PROPOSED TO REMAIN BELOW THE PROPOSED SUBGRADE ELEVATION, THE SUBGRADE MATERIAL SHALL BE ROUGHLY CROWNED AND A 3" LAYER OF CRUSHED GRAVEL SHALL BE PLACED AND COMPACTED. THIS WILL ALLOW THE SUBGRADE TO SHED RUNOFF AND WILL REDUCE ROADWAY EROSION. THIS CRUSHED GRAVEL DOES NOT HAVE TO CONFORM TO NH DOT 304-3, BUT SHALL HAVE BETWEEN 15-25% PASSING THE #200 SEVE AND THE LARGEST STONE SIZE SHALL BE 2". IF THE SITE IS ACTIVE AFTER NOVEMBER 15TH, ANY ACCUMULATED SNOW SHALL BE REMOVED FROM ALL ROADWAY AND PARKING AREAS.

4. AFTER OCTOBER 15TH, THE END OF NEW HAMPSHIRE'S AVERAGE GROWING SEASON, NO ADDITIONAL LOAM SHALL BE SPREAD ON SIDE SLOPES AND SWALES. THE STOCKPILES THAT WILL BE LEFT UNDISTURBED UNTIL SPRING SHALL BE SEEDED BY THIS DATE. AFTER OCTOBER 15TH, ANY NEW OR DISTURBED PILES SHALL BE MULCHED AT A RATE OF 3-4 TONS PER ACRE. ALL STOCKPILES THAT WILL REMAIN THROUGHOUT THE WINTER SHALL BE SURROUNDED WITH SILT FENCING.

SEEDING SPECIFICATIONS

1. GRADING AND SHAPING

3. ESTABLISHING A STAND

- A SLOPES SHALL NOT BE STEEPER THAN 2:1;3:1 SLOPES OR FLATTER ARE PREFERRED. WHERE MOWING WILL BE DONE, 3:1 SLOPES OR FLATTER ARE RECOMMENDED. 2. SEEDBED PREPARATION
- A. SURFACE AND SEEPAGE WATER SHOULD BE DRAINED OR DIVERTED FROM THE SITE TO PREVENT DROWNING OR WINTER
- KILLING OF THE PLANTS.

 B. STONES LARGER THAN 4 INCHES AND TRASH SHOULD BE REMOVED BECAUSE THEY INTERFERE WITH SEEDING AND FUTURE MAINTENANCE OF THE AREA. WHERE FEASIBLE, THE SOIL SHOULD BE TILLED TO A DEPTH OF ABOUT 4 INCHES TO PREPARE A SEEDBED AND MIX FERTILIZER AND LIME INTO THE SOIL THE SEEDBED SHOULD BE LEFT IN REASONABLY FIRM AND SMOOTH CONDITION. THE LAST TILLAGE OPERATION SHOULD BE PERFORMED ACROSS THE SLOPE WHEREVER PRACTICAL.
- ESTABLISHMON A STAND

 A. LIME AND FERTILIZER SHOULD BE APPLIED PRIOR TO OR AT THE TIME OF SEEDING AND INCORPORATED INTO THE SOIL KINDS AND AMOUNTS OF LIME AND FERTILIZER SHOULD BE BASED ON AN EVALUATION OF SOIL TESTS. WHEN A SOIL TEST IS NOT AVAILABLE, THE FOLLOWING MINIMUM AMOUNTS SHOULD BE APPLIED. AGRICULTURAL LIMESTONE, 2 TONS PER ACRE OR 100 LBS PER 1,000 SQ. FT..
- NITROGEN(N), 50 LBS PER ACRE OR 1, 1 LBS PER 1,000 SQ.FT.
- PHOSPHATE(P205), 100 LBS PER ACRE OR 2, 2 LBS PER 1,000 SQ.FT.
- POTASH(K20), 100 LBS PER ACRE OR 2, 2 LBS PER 1,000 SQ.FT.
- (NOTE: THIS IS THE EQUIVALENT OF 500 LBS PER ACRE OF 10-20-20 FERTILIZER OR 1,000 LBS PER ACRE OF 5-10-10.)
- B. SEED SHOULD BE SPREAD UNIFORMLY BY THE METHOD MOST APPROPRIATE FOR THE SITE. METHODS INCLUDE: BROADCASTING, DRILLING AND HYDROSEEDING, WHERE BROADCASTING IS USED, COVER SEED WITH .25 INCH OF SOIL OR LESS, BY CULTIPACKING OR RAKING.
- C. REFER TO TABLE(G-E1 THIS SHEET) FOR APPROPRIATE SEED MIXTURES AND TABLE(H-E1 THIS SHEET) FOR RATES OF SEEDING. ALL LEGUMES (CROWN VETCH, BIRDS FOOT TREFOIL, AND FLAT PEA) MUST BE INOCULATED WITH THEIR SPECIFIC INOCULATION.
- D. WHEN SEEDED AREAS ARE MULCHED, PLANTINGS MAY BE MADE FROM EARLY SPRING TO EARLY OCTOBER. WHEN SEEDED AREAS ARE NOT MULCHED, PLANTINGS SHOULD BE MADE FROM EARLY SPRING TO MAY 20 OR FROM AUGUST

4. MULCH

- . HAY, STRAW, OR OTHER MULCH, WHEN NEEDED, SHOULD BE APPLIED IMMEDIATELY AFTER SEEDING.
- B. MULCH WILL BE HELD IN PLACE USING APPROPRIATE TECHNIQUES FROM THE BEST MANAGEMENT PRACTICE FOR MULCHING, HAY OR STRAW MULCH SHALL BE PLACED AT A RATE OF 90 LBS PER 1000 SQ. FT.

5. MAINTENANCE TO ESTABLISH A STAND

- A. PLANTED AREA SHOULD BE PROTECTED FROM DAMAGE BY FIRE, GRAZING, TRAFFIC, AND DENSE WEED GROWTH-B. FERTILIZATION NEEDS SHOULD BE DETERMINED BY ONSITE INSPECTIONS. SUPPLEMENTAL FERTILIZER IS USUALLY THE KEY TO FULLY COMPLETE THE ESTABLISHMENT OF THE STAND BECAUSE MOST PERENNIAL STAKE 2 TO 3 YEARS TO BECOME ESTABLISHMENT.
- C. IN WATERWAYS, CHANNELS, OR SWALES WHERE UNIFORM FLOW CONDITIONS ARE ANTICIPATED, OCCASIONAL MOWING MAY BE NECESSARY TO CONTROL GROWTH OF WOODLY VEGETATION.

KEY STONE INTO CHANNEL BANKS AND EXTEND BEYOND ABUTMENTS A WINIMUM OF 18" TO PREVENT FLOW AROUND THE DAM. L= THE DISTANCE SUCH THAT POINTS A AND B ARE OF EQUAL ELEVATION. THE THE PARTY OF T 2"-3" STONE FLOW SPACING BETWEEN STRUCTURES

MAINTENANCE

TEMPORARY GRADE STABILIZATION STRUCTURES SHOULD BE CHECKED AFTER EACH RAINFALL AND AT LEAST DAILY DURING PROLONGED STORUS. ANY NECESSARY REPAIRS SHOULD BE MADE INMEDIATELY. PARTICULAR ATTENION SHOULD BE GIVEN TO BEN DRIVE AND EROSON AT THE DOWNSTREAM TOE OF THE STRUCTURE. WHEN THE STRUCTURES ARE REMOVED, THE DISTURBED PORTION SHOULD BE BROUGHT TO THE EXISTING CHANNEL GRADE AND THE AREAS REPRARED, SECIED AND MULCHED. WHILE THIS PRACTICE IS NOT INTENDED TO BE USED PRIMARILY FOR SEDIMENT TRAPPING, SOME SEDIMENT WILL ACCUMULATE BEHIND THE STRUCTURES. SEDIMENT SHALL BE REMOVED FROM BEHIND THE STRUCTURES WHEN IT HAS ACCUMULATED TO ONE HALF OF THE ORIGINAL HEIGHT OF THE STRUCTURE.

REMOVAL. AFTER VEGETATION HAS STABILIZED, THESE TEMPORARY STRUCTURES SHALL BE REMOVED WITH SPECIAL CARE AS TO AVOID DISTURBING ANY UNDERLYING EROSION CONTROL FABRIC AND/OR EXISTING VEGETATION TEMPORARY STONE CHECK DAM

> WOVEN WIRE FENCE W\
> PROPEX-SILT STOP
> SEDIMENT CONTROL FABRIC
> OR APPROVED EQUAL Section A - A 6" MIN. De la successión HARDWOOD POST SILT FENCE

CONSTRUCTION SPECIFICATIONS

SILI FENCE

1. WOVEN WIRE FENCE TO BE FASTENED SECURELY TO FENCE POSTS WITH WIRE TIES OR STAPLES AND FILTER CLOTH SHALL BE FASTENED TO WOVEN WIRE EVERY 24" AT TOP MID AND BOTTOM SECTIONS AND BE EMBEDDED INTO GROUND A MINIMUM OF 8". 2. THE FENCE

AND BOTTOM SECTIONS AND BE EMBEDDED INTO GROUND A MINIMUM OF 8.2. THE FENCE POSTS SHALL BE A MINIMUM 48" LONG, SPACED A MAXIMUM 10" APART, AND DRIVEN A MINIMUM OF 16" INTO THE GROUND.

3. WHEN TWO SECTIONS OF FILTER CLOTH ADJOIN EACH OTHER, THE ENDS OF THE FABRIC SHALL BE OVERLAPPED BY SIX INCHES, FOLDED AND STAPLED TO PREVENT SEDIMENT FROM BY-PASSING.

BY-PASSING.

4. MAINTENANCE SHALL BE PERFORMED AS NEEDED AND SEDIMENT REMOVED WHEN "BULGES" DEVELOP IN THE SILIT FENCE AND PROPERLY DISPOSED OF.

5. PLACE THE ENDS OF THE SILIT FENCE UP CONTOUR TO PROVIDE FOR SEDIMENT STORAGE.

6. SILIT FENCES SHALL BE REMOVED WHEN NO LONGER NEEDED AND THE SEDIMENT COLLECTED SHALL BE DISPOSED AS DIRECTED BY THE ENGINEER. THE AREA DISTURBED BY THE REMOVAL SHALL BE SMOOTHED AND RE-VEGETATED

HAINIENARKE. . SILT FENCES SHALL BE INSPECTED IMMEDIATELY AFTER EACH RAINFALL AND AT LEAST HALLY DURING PROLONGED RAINFALL. ANY REPAIRS THAT ARE REQUIRED SHALL BE MADE


DAILY DURING PROLONGED RAINFALL ANY REPAIRS THAT ARE REQUIRED SHALL BE MADE IMMEDIATELY.

IF THE FABRIC ON A SILT FENCE SHOULD DECOMPOSE OR BECOME INEFFECTIVE DURING THE EXPECTED LIFE OF THE FENCE, THE FABRIC SHALL BE REPLACED PROMPTLY.

3. SEDIMENT DEPOSITS SHOULD BE INSPECTED AFTER EVERY STORM EVENT. THE DEPOSITS SHOULD BE REMOVED WHEN THEY REACH APPROXIMATELY ONE HALF THE HEIGHT OF THE BARRIER.

A. SEDIMENT DEPOSITS THAT ARE REMOVED OR LEFT IN PLACE AFTER THE FABRIC HAS BEEN REMOVED SHALL BE GRADED TO CONFORM WITH THE EXISTING TOPOGRAPHY AND VEGETATED.

SEEDING GUIDE

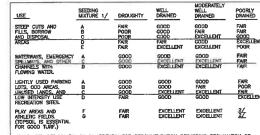

GRAVEL PIT, SEE NH-PM-24 IN APPENDIX FOR RECOMMENDATION REGARDING RECLAMATION OF SAID AND GRAVEL PITS. 1/ refer to seeding mixtures and rates in Table 7-36.
27 Poorly Drained soils are not desirable for use as playing area and athletic fields.


NOTE: TEMPORARY SEED MIX FOR STABILIZATION OF TURF SHALL BE WINTER RYE OR DATS AT A RATE OF 2.5 LBS. PER 1000 S.F. AND SHALL BE PLACED PRIOR TO DOT. 15, IF PERMANENT SEEDING NOT YET COMPLETE.

PREPARED FOR:

MAKRIS R.E. DEVELOPMENT, LLC 11 WENTWORTH TERRACE DOVER, NH 03820

BEALS · ASSOCIATES PLLC

70 PORTSMOUTH AVE, STRATHAM, N.H. 03885 PHONE: 603-583-4860, FAX. 603-583-4863

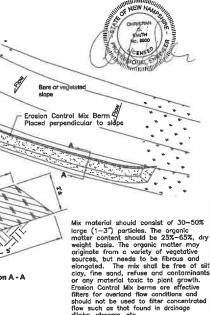

Erosion Control Mix Berm

| | SEEDING | RATES | |
|---|--|---------------------|------------------------------|
| | MIXTURE | POUNDS PER ACRE | POUNDS PER |
| | A. TALL FESCUE CREEPING RED FESCUE RED TOP TOTAL | 20 20 2 42 | 0.45 0.45 0.05 0.95 |
| | B. TALL FESCUE CREEPING RED FESCUE CROWN VETCH OR | 15 10 15 | 0.35 0.25 0.35 |
| | FLAT PEA TOTAL | 30 40 OR 55 | 0.75 0.95 OR 1.35 |
| k | C. TALL FESCUE CREEPING RED FESCUE BIRDS FOOT TREFOIL TOTAL | 20 20 8 48 | 0.45 0.45 0.20 1.10 |
| | D. TALL FESCUE FLAT PEA TOTAL | 20 30 50 | 0.45 0.75 1.20 |
| | E. CREEPING RED FESCUE 1/ KENTUCKY BLUEGRASS 1/ TOTAL | 50 50 100 | 1.15 1.15 2.30 |
| | F. TALL FESCUE 1 | 150 | 3.60 |
| | F. TALL FESCUE 1 1/ FOR HEAVY USE ATHLETIC FIT NEW HAMPSHIRE COOPERATIVE EX CURRENT WARIETIES AND SEEDING | ELDS CONSULT TH | E UNIVERSITY |

DATE: REVISIONS:

EROSION & SEDIMENTATION

BIRCHWOOD PONDS RESIDENTIAL DEVELOPMENT CHESLEY HILL ROAD ROCHESTER, NH

DATE: JAN, 2017 SCALE: NTS SHEET NO. 38 OF 38 PROJ. NO: NH-860