

85 Portsmouth Avenue, PO Box 219, Stratham, NH 03885 603.772.4746 - JonesandBeach.com

January 18, 2022


Rochester Planning Board Attn. Nel Sylvian 31 Wakefield Street Rochester, NH 03867

**RE:** Response Letter

19 Old Gonic Road, Rochester, NH

Tax Map 131, Lot 1 JBE Project No. 21090

Dear Mr. Sylvian,

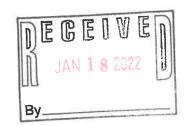

We are in receipt of comments from Ryan O'Connor, Conservation Commission dated December 2, 2021. We are also in receipt of comments from Shanna Saunders, City Planner dated December 13, 2021. We are also in receipt of comments from Dana Webber, Assistant City Engineer, Dated December 16, 2021. Review comments are listed below with our responses in bold.

## **CONSERVATION COMMISSION COMMENTS:**

1. "Verify stormwater drainage from pond two is outside of the 50' buffer from the brook. If not, a Conditional Use Permit would be needed.

RESPONSE: Stormwater drainage from pond two is outside of the 50' buffer from the brook.

2. The silt fence is delineated on the plans but since you're up against the buffer in several places we would need those areas protected with orange construction fence as well to try and clearly separate those areas.

RESPONSE: We have added orange construction fence along the organic filter berm when disturbance is near the wetland buffer.

3. When you submit your SWPPP you'll go into more detail for the phasing of the earth work, temp stormwater plans but as far as the site plan drawings could you include where your stockpiles are planned to be. Especially for winter, those piles can't be within 100 feet of any wetland or water source.

RESPONSE: The location for the stockpiles have been added to the plans.

Consider submitting a certified winter stabilization plan. If not from Oct 15<sup>th</sup> to May 15<sup>th</sup> you're limited to one acre of ground disturbance. Outside of winter, any disturbance within 100 feet of wetlands or water must be stabilized within 5 days.

RESPONSE: A certified winter stabilization note #2 has been added to sheet OVRG.

- 4. It would be good to see some type of invasive species plan, because of the size of the clear cut we like to have some plan in place in case this is an issue later.
  RESPONSE: An invasive species section of notes is included with this submission and can be found on the landscape plans.
- 5. For perimeter controls, my recommendation would be a mulch berm around the project opposed to the silt fence. Because this could be a longer project, it would be good to have something that might require less maintenance.

  RESPONSE: We have switched all silt fence to organic filter berm.
- 6. I saw you included a landscaping plan, but is there any opportunity to save trees in

between some of the units or increase vegetation in unused open space to stabilize runoff leading to the river?

RESPONSE: The remaining treeline is shown on the plan OVRG and other overview sheets. There are substantial wooded areas remaining along the river and no wetland buffer impact. Within the developed area of the site, the grading requires the removal of most of the trees in the middle of the site. The field area will remain and be used as a recreation field.

- 7. Please try and shift snow storage away from wetlands, there's only two areas that are getting close to the buffer but with the slop of the land, it would be good to see that moved elsewhere or minimized in those spots.
  - RESPONSE: Snow storage has been revised and is shown on the site plans.
- 8. The phasing plans for the project will be important. Please include temporary stormwater management and indicate how water will flow prior to the permanent stormwater system being stabilized."

RESPONSE: Phasing plan has been provided. Temporary sediment ponds will be outlined in the SWPPP and modified as needed during construction. SWPPP inspections will be required as part of this development as well.

## **PLANNING DEPARTMENT COMMENTS:**

- 1. As we talked about at TRG Traffic will be one of the major issues on this site. Traffic considerations must be made not only within the adjacent residential neighborhoods but at either end of Brock Street and the impact of additional traffic on those intersections. Pedestrian traffic and connection to existing pedestrian sidewalks must also be considered. Offsite improvements may be required. Construction traffic must also be taken into consideration when looking at overall site traffic.
  - RESPONSE: A traffic analysis is included along with this submission. We have dedicated our Old Gonic Road connection as exit only have added Do Not Enter signs. The location of these signs should be discussed. We have added a sidewalk and striped crosswalks from Brock Street, all of Emerson and all the way to Old Gonic Road. For Offsite improvements, we have a sidewalk on Emerson, upgraded waterline on Emerson and a bypass lane on Brock Street.
- 2. Utility impact, water, sewer and stormwater must also be carefully reviewed to make sure there is capacity.

RESPONSE: These items are being reviewed and consulted with Third Party firms.



- 3. Phasing was discussed at TRG. Please provide a proposed phasing plan. RESPONSE: A proposed phasing plan is included with this submission.
- 4. Please add a key to the Landscaping Plan identifying which image is which kind of plant. RESPONSE: A key has been added to the Landscaping Plan identifying which image is which kind of plant.
- Per Section 5.B.12 of the Site Plan Regs 25% of the entire lot must be unaltered or landscaped. Please make sure you meet this requirement.
   RESPONSE: The unaltered or landscaped area is labeled in Note #2 on Sheet OVRS.
- 6. Per Section 5.D landscape buffers are required on the front and side of the lot. RESPONSE: Landscape buffers have been added to the front and side of the lot.
- Per Section 5.E speaks to parking lot landscaping including landscaped peninsula and shade trees.
   RESPONSE: All parking areas are now enclosed with landscaped peninsula at least as wide as the parking spaces. Landscape trees are all around the parking areas as well.
- 8. Please add bike racks to the plan per Section 11.B. RESPONSE: 2 Bike racks have been added to the plans.
- This amount of residential unit requires some sort of amenities. Trails, Playground, picnic areas, patios are all options.
   RESPONSE: Every unit has a deck; we have added a proposed trail that connects to an existing trail onsite near the river and a proposed recreation field located in the front of the site near Old Gonic Road.
- 10. All lighting, both parking lot and building must be downcast and fully shielded to prevent glare. Please add fixture type to plan.
  RESPONSE: A fixture type has been added to Sheet L4 for the poles and the wall packs on the building. All are dark sky compliant and are noted as such on the plan.
- 11. The architectural needs some work. Although I appreciate the New England style window and door casings, and placement, that is really the only good thing about the design. Please break up the building massing with variation and depth. Extensive areas of visible roof should be broken up. Broad expanses of blank walls are inappropriate (such as the sides of the buildings). Much attention should be given to create an attractive façade including horizontal sections like belt courses, vertical corner embellishments such as corner boards or quoins, vertical articulation such as columns or pilasters. Garages should be subordinate to the main building by reducing it in size, and recessing it beyond the main section of the building.

RESPONSE: The architectural plans have been revised and are submitted along with this response letter.



## **SEWER COMMENTS:**

- 1. The city reviewed the Sewer Report prepared by Weston & Samson and send comments via email to Jones and Beach. The email included additional field investigation and draw down testing performed by the city which should be used to update the report RESPONSE: Weston & Samson submitted a report to the City regarding the sewer capacity. This was reviewed and additional comments were provided by DPW and those are being addressed by W/S. They will submit their revised report under separate cover.
- NHDES Sewer Connection Permit required, Rochester Sewer Connection Permit and Sewer Assessment Application required.
   RESPONSE: We will submit this to the State as soon as we can.

## **WATER COMMENTS:**

1. A master water meter vault or above grade structure will be required at the connection to the city water system. If two connections are proposed two master meters will be required, each with backflow prevention devices

RESPONSE: A water meter has been shown on Sheet U2 near the connection at Emerson.

2. Hydraulic evaluation by W-P is needed to assess impact on the water system and determine recommended upgrades. Determine water supply and pressure needs for the development, and model hydraulically. The hydraulic analysis must also look at effects on water supply, water quality and pressure in the surrounding neighborhood. Water infrastructure in the adjacent neighborhood is aged unlined cast iron, mainly 6-inch. The applicant will be required to improve the water main(s) in Emerson and Old Gonic depending upon final water connection layout.

RESPONSE: We have solicited a proposal from Wright/Pierce and plan on working with them for the water system model. We are showing the watermain on Emerson being upgraded to an 8" line from Brock Street.

3. NHDES Drinking Water Division will need to review water system extension prior to construction. Water Service Connection Permit required.

**RESPONSE:** We will submit the utilities plans to the NHDES Drinking Water Division.

## **TRAFFIC AND ROADS COMMENTS:**

1. A traffic study is required with projected trip generation and evaluation of impacts to Brock Street intersections, Columbus Ave intersections and school traffic. Upon receipt of the traffic study, the City will coordinate 3rd party review. Escrow for the cost of the review will be required

RESPONSE: A Traffic Impact Analysis is included along with this letter.



2. DPW forwarded traffic counts performed along Columbus Ave in November 2018 to Jones and Beach.

**RESPONSE:** These have been incorporated into the Traffic Report.

3. NHDOT will also review the traffic study.

RESPONSE: We have sent the traffic study to NHDOT for their review.

4. Sidewalks connecting the development to Brock Street may be required as an off-site improvement

RESPONSE: This sidewalk has been added on Emerson.

- 5. Off-site roadway improvements such as width or layout modifications, may be required due to traffic impacts, sidewalk installation and/or infrastructure replacements. Improvements may require overlay or roadway reconstruction of impacted streets. RESPONSE: We have added a bypass lane on Brock Street to assist with cars turning left onto Emerson Ave.
- 6. Sidewalks or other pedestrian or bicycle accommodations are not shown on the submitted plans. Adding sidewalks is supported by DPW. Drainage calculations would need to be updated for the added impervious and potential changes in grading.
  RESPONSE: We have added a sidewalk along from Emerson Ave. from the site to Brock Street. We have elected to have the Old Gonic Road access way be an exit only.
- 7. Excavation Permits required for any work performed in the City right of way RESPONSE: This note has been added to Sheet OVRS.

## **STORMWATER COMMENTS:**

1. The development stormwater management and erosion control design must meet Rochester Chapter 218 Stormwater Ordinance. Drainage will be reviewed by 3rd party consultant, Geosyntec. Escrow for review fee is required and there is a two-week turnaround for review

RESPONSE: Compliance with Chapter 218 Stormwater Ordinance has been reviewed. We understand that the plans and drainage have been sent to GeoSyntec for a Third-Party Review. Escrow fees were provided already.

2. Provide status of state environmental permits. The City requires copies of all permit applications, review comments and responses, and issued permits. If review by state or federal agencies requires modifications to the plans, the city will need to review the changes in a revised submittal.

RESPONSE: We will be submitting State permits shortly after this submittal is made.

3. DPW Stormwater Permit required prior to construction RESPONSE: This note has been added to Sheet OVRS.



## Included with this response letter are the following:

- 1. Three (3) Full Size Plan Sets.
- 2. Sixteen (16) 11x17 Plan Sets (Folded).
- 3. 3 Traffic Impact Analysis
- 4. Revised Architectural Plans.

Thank you very much for your time.

Very truly yours, **JONES & BEACH ENGINEERS, INC.** 

Joseph Coronati


Joseph Coronati Vice President


cc: Green & Company (via email)
John O'Neil (via email)
Jim Gove, Gove Environmental Services (via email)
Steve Pernaw, Traffic Consultant (via email)
John Sykora, Weston & Sampson (via email)
Chris Berg, Wright-Pierce (via email)










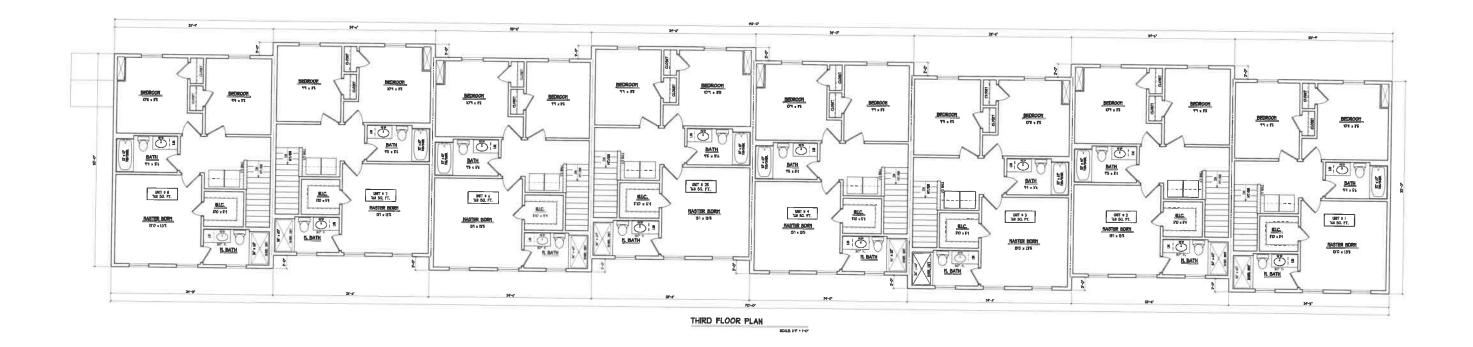

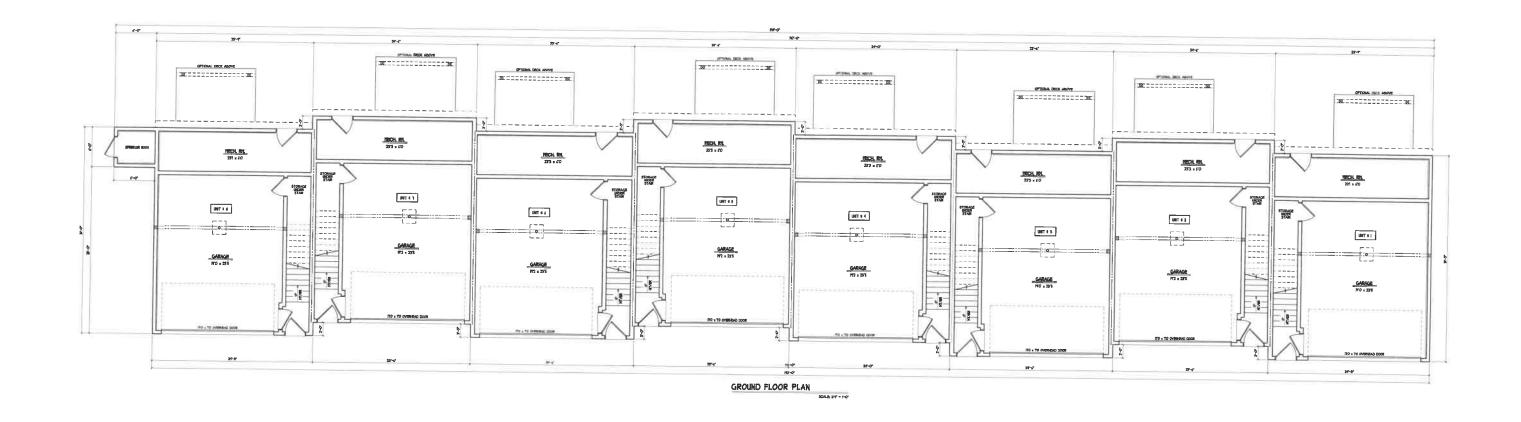


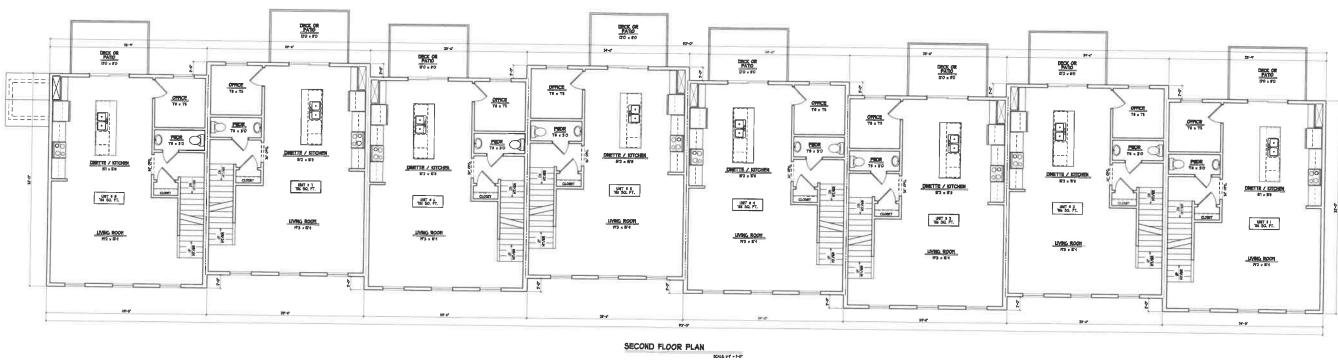


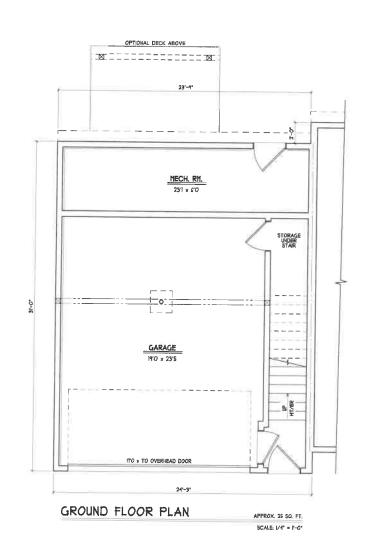


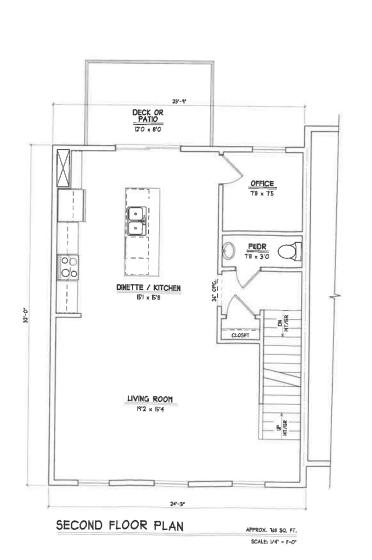




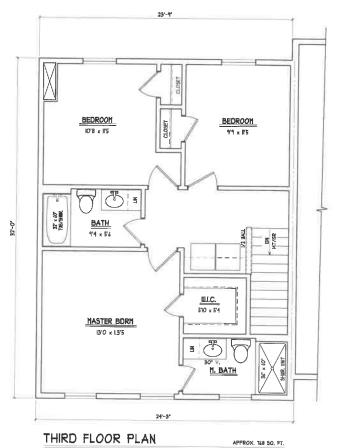

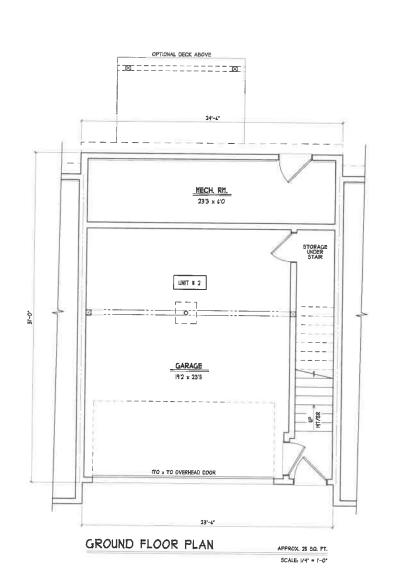


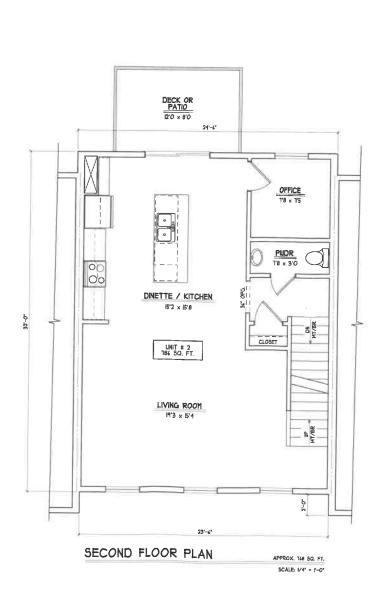

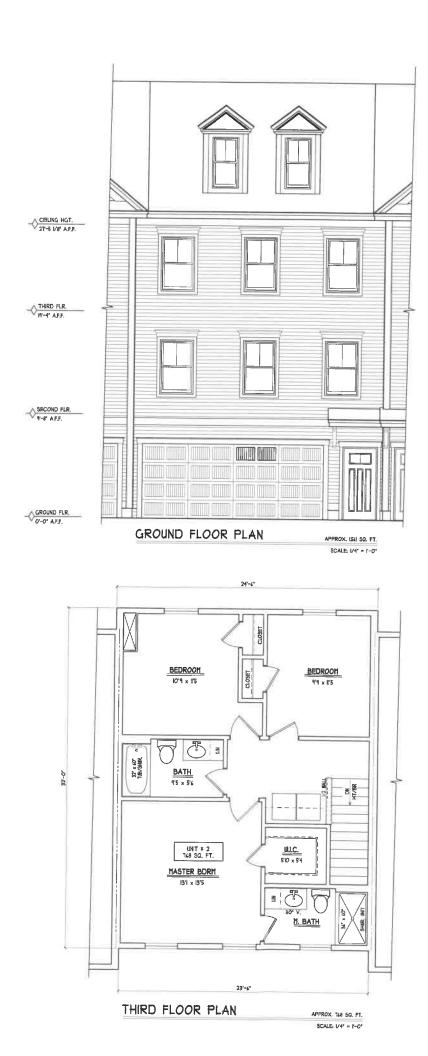

# **GENERAL LEGEND** 99.50 4K SEPTIC AREA XXXXX VEGETATED FILTER STRIP OPEN WATER **4 4 4** .... CONCRETE SNOW STORAGE

# PROPOSED SITE PLAN "BAYBERRY COMMONS" TAX MAP 131, LOT 1 19 OLD GONIC ROAD, ROCHESTER, NH

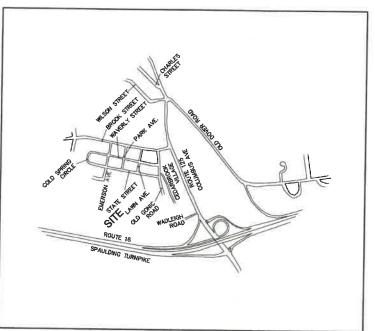

LOCUS MAP SCALE 1" = 2000'

CIVIL ENGINEER / SURVEYOR
JONES & BEACH ENGINEERS, INC.
85 PORTSMOUTH AVENUE
PO BOX 219
STRATHAM, NH 03885
(603) 772-4746
CONTACT: JOSEPH CORONATI
EMAIL: JCORONATI@JONESANDBEACH.COM

TRAFFIC ENGINEER
STEPHEN G. PERNAW & COMPANY, INC.
P.O. BOX 1821
CONCORD, NH 03302
(603) 731-8500
CONTACT: STEPHEN G. PERNAW
EMAIL: SGP@PERNAW.COM

WETLAND CONSULTANT
GOVE ENVIRONMENTAL SERVICES, INC.
8 CONTINENTAL DR., BUILDING 2, UNIT H
EXETER, NH 03833-7526
(603) 778-0644
CONTACT: JAMES GOVE
EMAIL: JGOVE@GESINC.BIZ

## LANDSCAPE DESIGNER

LM LAND DESIGN, LLC
11 SOUTH ROAD
BRENTWOOD, NH 03833
(603) 770-7728
CONTACT: LISE MCNAUGHTON
LMLANDDESIGN@GMAIL.COM

WATER AND SEWER
ROCHESTER DEPARTMENT OF PUBLIC WORKS
45 OLD DOVER ROAD
ROCHESTER, NH 03867
(603) 332-4096
CONTACT: MICHAEL BEZANSON, P.E.

ELECTRIC
EVERSOURCE ENERGY
74 OLD DOVER ROAD
ROCHESTER, NH 03867
(603) 555-5334
CONTACT: MARK BOUCHER

# SHEET INDEX

**COVER SHEET** 

OVEX EXISTING CONDITIONS OVERVIEW PLAN

C1-C4 EXISTING CONDITIONS PLAN

DM1 DEMOLITION PLAN

OVRS OVERVIEW SITE PLAN

C5-C8 SITE PLANS

C9-C11 GRADING AND DRAINAGE PLAN

OVERVIEW GRADING PLAN

OVRU OVERVIEW UTILITY PLAN

U1-U2 UTILITY PLAN

L1-L2 LANDSCAPE PLAN

L3-L4 LIGHTING PLAN

P1-P6 ROAD PLAN AND PROFILE

P7-P10 SEWER PROFILE

OFF-1-5 OFFSITE IMPROVEMENT PLANS

D1-D4 DETAIL SHEETS

E1 EROSION AND SEDIMENT CONTROL DETAILS

PH PHASING PLAN

DEGEIVED
JAN 1 8 2022

By
JAN
By

PROJECT PARCEL CITY OF ROCHESTER TAX MAP 131, LOT 1

APPLICANT
GREEN AND COMPANY
11 LAFAYETTE ROAD
NORTH HAMPTON, NH 03862

1,309,695 SQ. FT. ± 30.07 ACRES ±

APPROVED - ROCHESTER, NH PLANNING BOARD

PLANNING BOARD

DATE:

Dasign: JAC Draft: LAZ Date: 04/28/21
Checked: JAC Scale: AS NOTED Project No.: 21090
Drawing Name: 21090-PLAN.dwg

THIS PLAN SHALL NOT BE MODIFIED WITHOUT WRITTEN
PERMISSION FROM JONES & BEACH ENGINEERS, INC. (JBE).
ANY ALTERATIONS, AUTHORIZED OR OTHERWISE, SHALL BE
AT THE USER'S SOLE RISK AND WITHOUT LUBILITY TO JBE.



1	1/18/22	REVISED PER CITY COMMENTS	LAZ
0	11/23/21	ISSUED FOR REVIEW	LAZ
REV.	DATE	REVISION	BY

Jones & Beach Engineers, Inc.

**TELEPHONE** 

(603) 427-5525

CABLE TV

(603) 679-5695

NATURAL GAS

325 WEST ROAD

(603) 294-5261

UNITIL SERVICE CORP.

PORTSMOUTH, NH 03801

MACLEAND@UNITIL..COM

1575 GREENLAND ROAD

CONTACT: JOE CONSIDINE

GREENLAND, NH 03840

334-B CALEF HIGHWAY

EPPING, NH 03042-2325

CONSOLIDATED COMMUNICATIONS

COMCAST COMMUNICATION CORPORATION

mouth Ave. Civil Engineering Services 603-772-4748
219 FAX: 603-772-0227
n, NH 03885 E-MAIL: JBE@JONESANDBEACH.COM

Plan Name:

COVER SHEET

Project:

BAYBERRY COMMONS
19 OLD GONIC ROAD, ROCHESTER, NH

Cwner of Record:


LEO P. LACOUTURE REV. TRUST & WILLIAN B. LACOUTURE
19 OLD GONIC RD., ROCHESTER, NH 03867 BK 4093 PG 148

CS
SHEET 1 OF 48
BE PROJECT NO. 21090

NAME AND LOCATION



RMISSION FROM JONES & BEACH ENGINEERS, INC. (JBE). ANY ALTERATIONS, AUTHORIZED OR OTHERWISE, SHALL BE AT THE USER'S SOLE RISK AND WITHOUT HABILITY TO JIRE

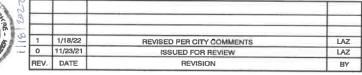


FAX: 603-772-0227

85 Portsmouth Ave. Civil Engineering Services E-MAIL: JBE@JONESAND8EACH.COM


## Project:

LEO P. LACOUTURE REV. TRUST & WILLIAN B. LACOUTURE 19 OLD GONIC RD., ROCHESTER, NH 03867 BK 4093 PG 148 Owner of Record:

SHEET 2 OF 48 JBE PROJECT NO. 21090

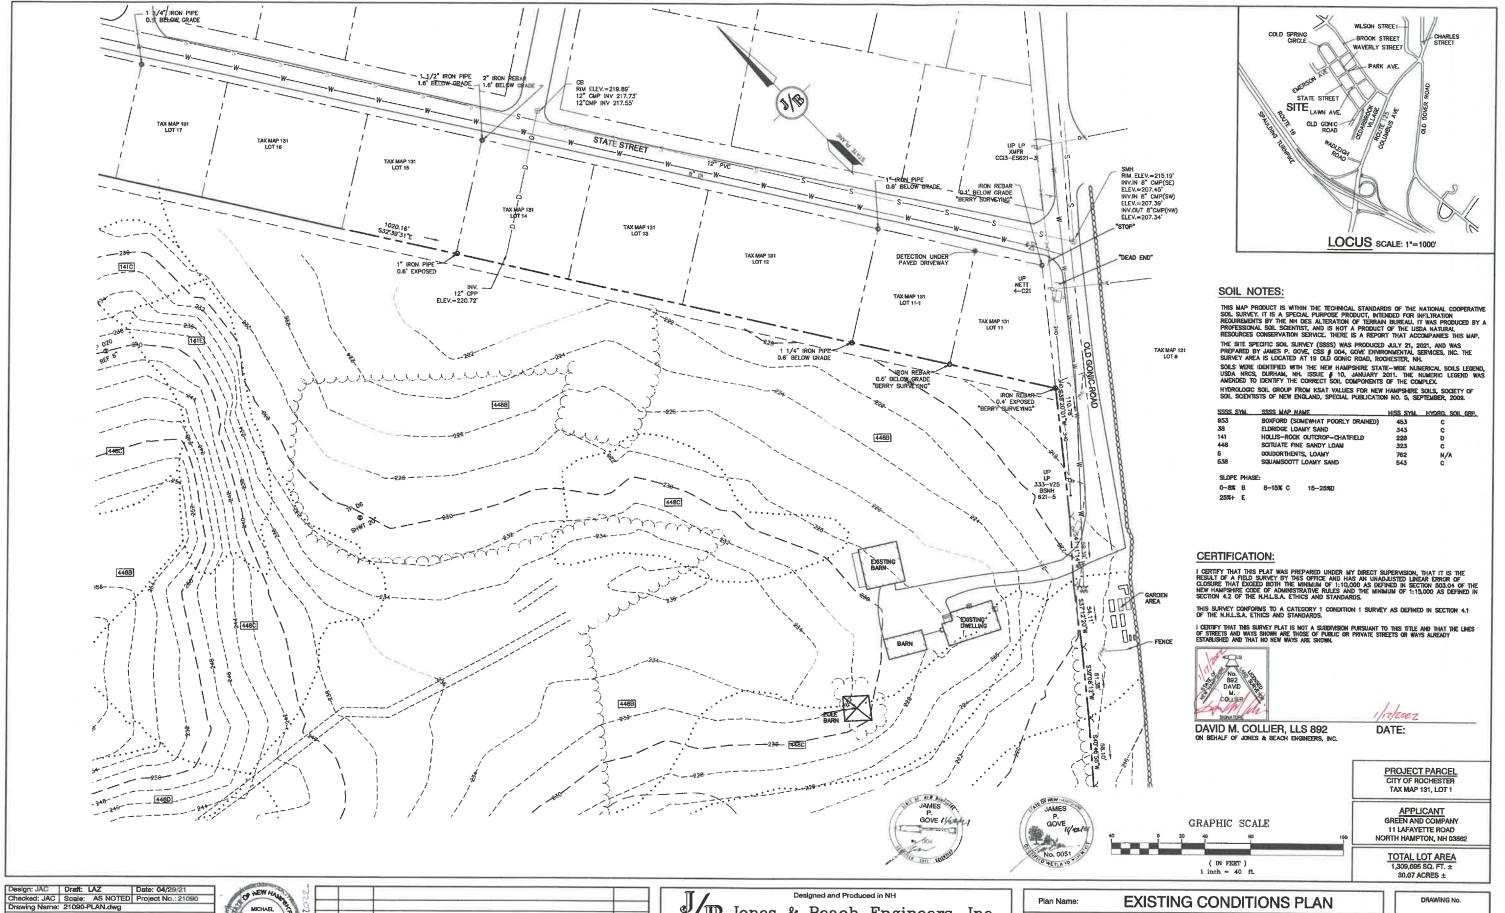

THIS PLAN SHALL NOT BE MODIFIED WITHOUT WRITTEN PERMISSION FROM JONES & BEACH ENGINEERS, INC. (JBE). ANY ALTERATIONS, AUTHORIZED OR OTHERWISE, SHALL BE AT THE USER'S SOLE RISK AND WITHOUT LIABILITY TO JBE.

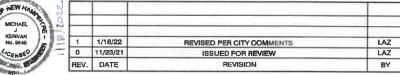

Jones & Beach Engineers, Inc.


85 Portsmouth Ave. Civil Engineering Services
PO Box 219
Stratham, NH 03885
E-MAIL: JBE@ 603-772-4746 FAX: 603-772-0227 E-MAIL: JBE@JONESANDBEACH.COM


BAYBERRY COMMONS 19 OLD GONIC ROAD, ROCHESTER, NH

Owner of Record: LEO P. LACOUTURE REV. TRUST & WILLIAN B. LACOUTURE 19 OLD GONIC RD., ROCHESTER, NH 03867 BK 4093 PG 148

Project:

SHEET 3 OF 46 JBE PROJECT NO. 21090

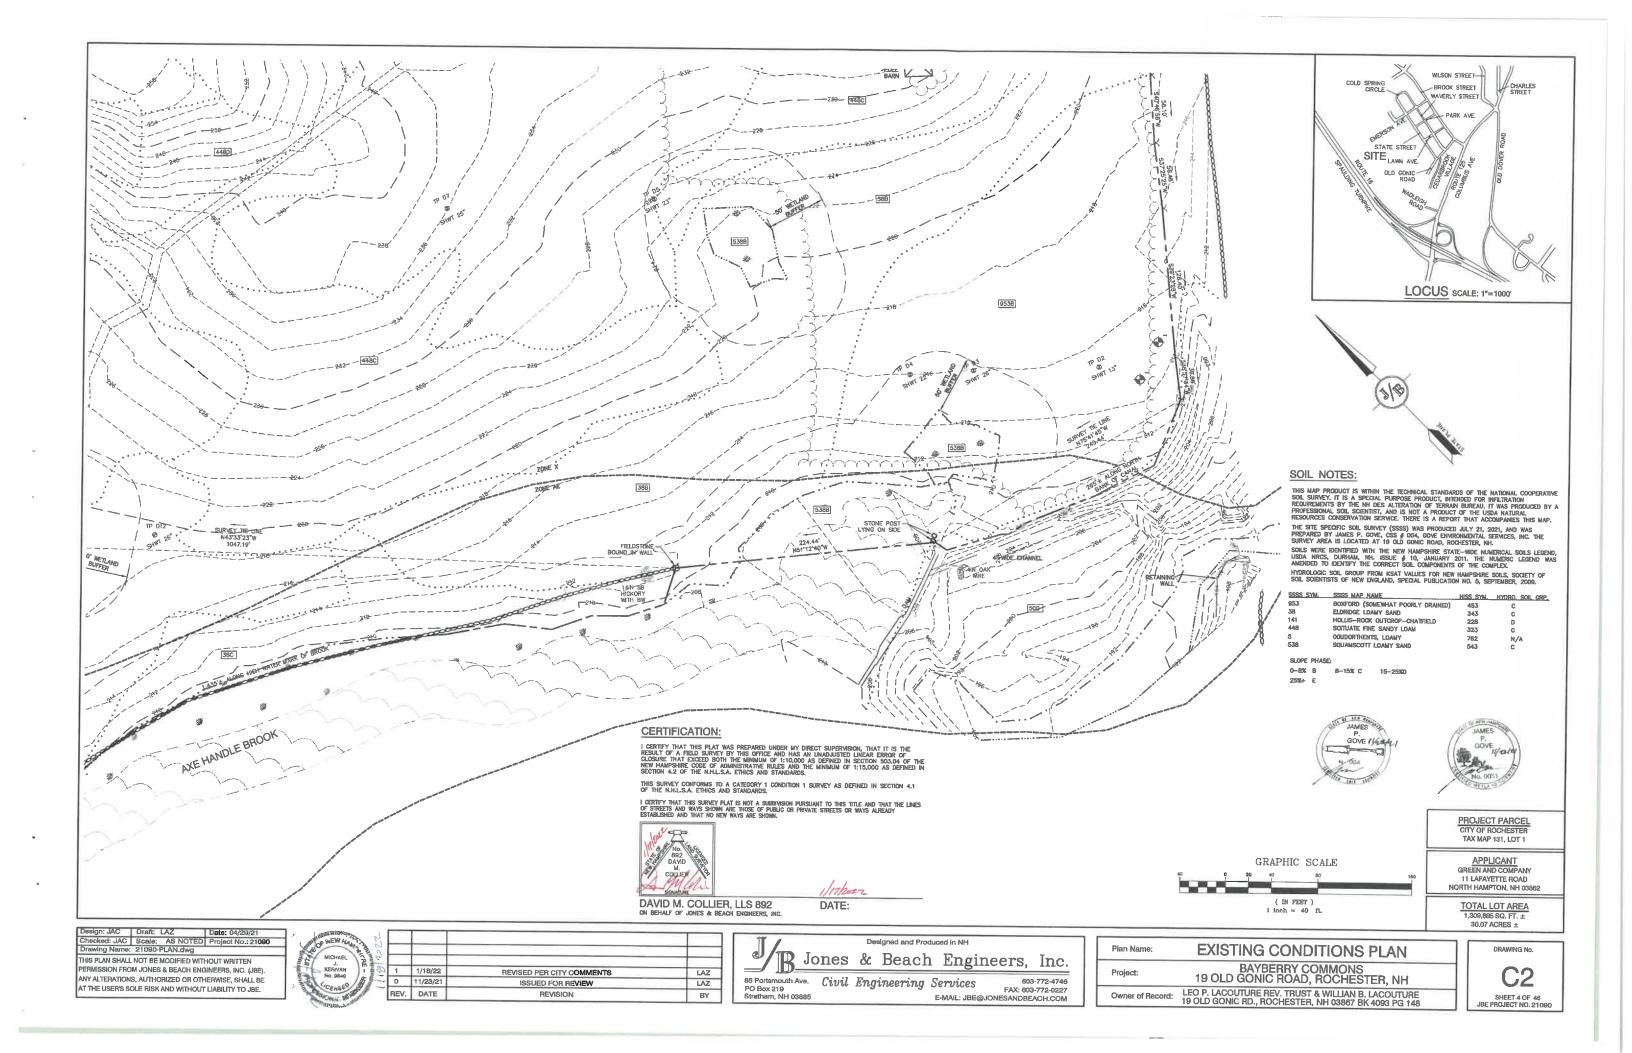

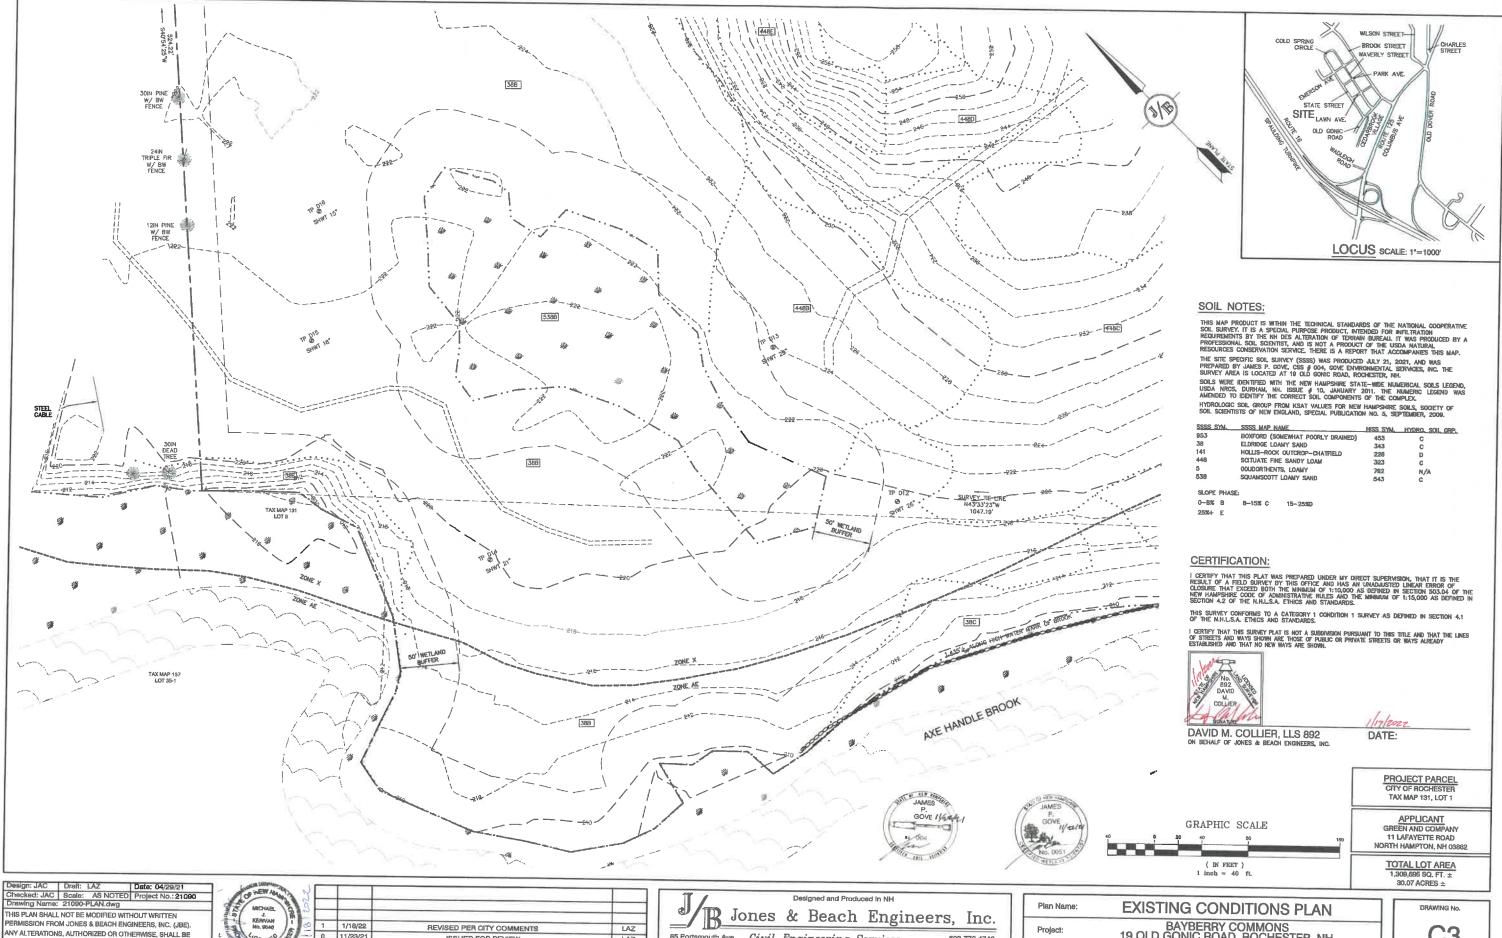


AT THE USER'S SOLE RISK AND WITHOUT LIABILITY TO JBE.


REVISED PER CITY COMMENTS 0 11/23/21 ISSUED FOR REVIEW LAZ REV. DATE BY

85 Portsmouth Ave. Civil Engineering Services 603-772-4746 FAX: 603-772-0227 PO Box 219 Stratham, NH 03885 E-MAIL: JBE@JONESANDBEACH.COM BAYBERRY COMMONS 19 OLD GONIC ROAD, ROCHESTER, NH

LEO P. LACOUTURE REV. TRUST & WILLIAN B. LACOUTURE 19 OLD GONIC RD., ROCHESTER, NH 03867 BK 4093 PG 148

**C3** SHEET 5 OF 48 JBE PROJECT NO. 21090

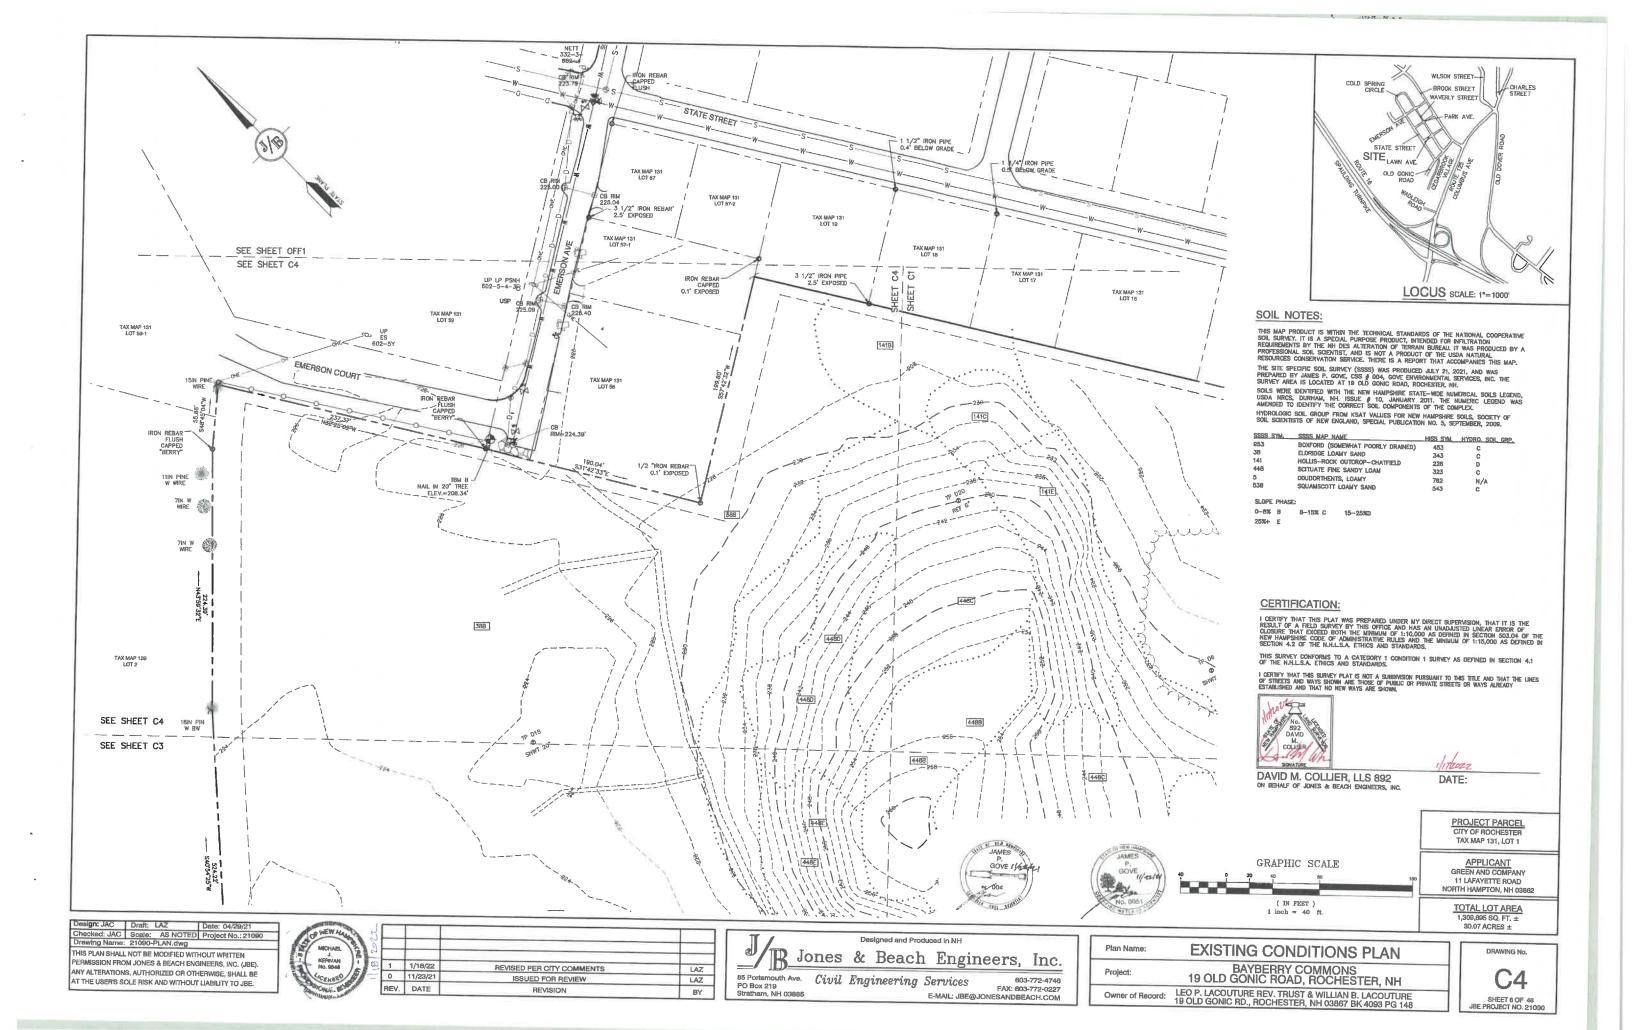

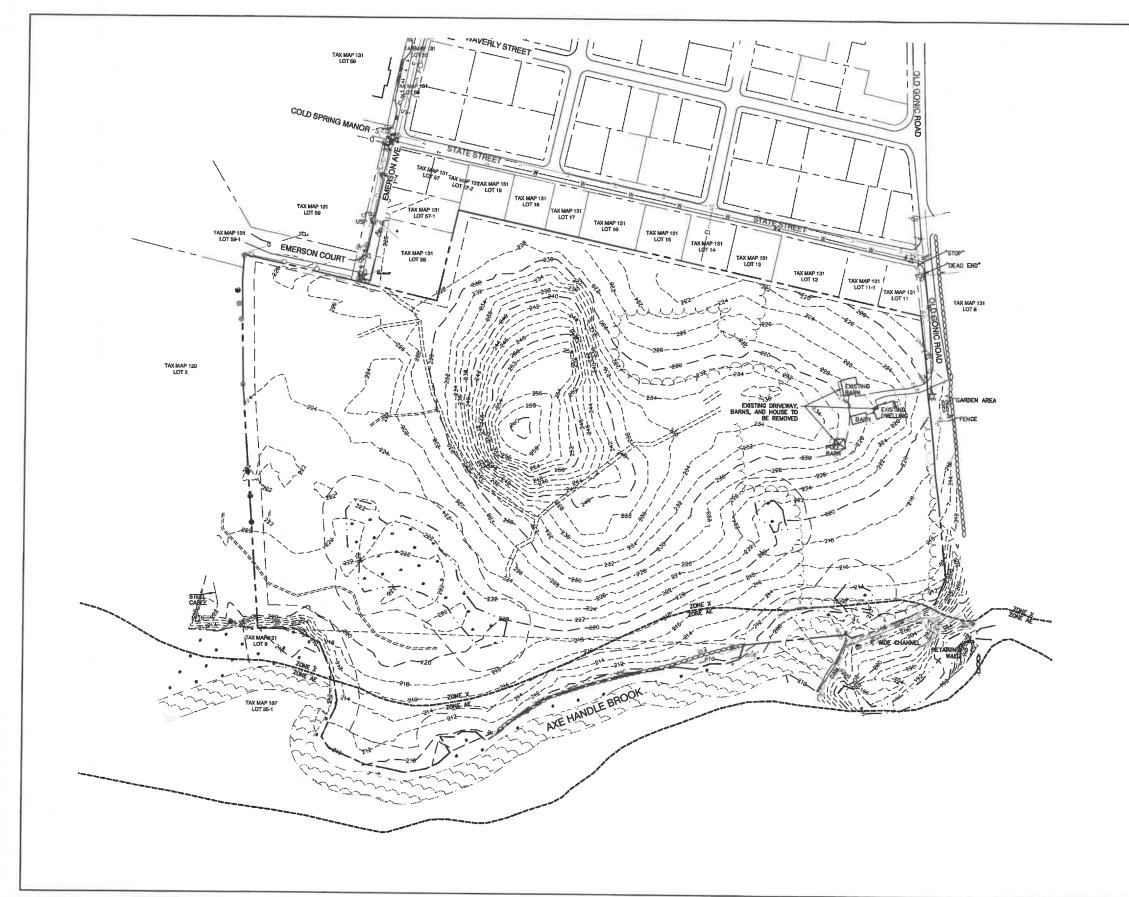

## **DEMOLITION NOTES:**

- THIS PLAN IS INTENDED TO PROVIDE MINIMUM GUIDELINES FOR SITE DEMOLITION. IT SHOULD BE NOTED THAT ALL MANMADE FEATURES, PAVEMENT, SIGNS, POLES, CURRING, CONCRETE WALKS, UTULTIES, ETC., SHALL BE REMOVED AS NECESSARY TO CONSTRUCT WORK, UNITESS OTHERWISE NOTED TO REMAIN. THROUGHOUT THE CONSTRUCTION PROCESS, THE CONTRACTOR SHALL INFORM THE ENGINEER IMMEDIATELY OF ANY FIELD DISCREPANCIES FROM DATA AS SHOWN ON DESIGN PLANS. THIS INCLIDES ANY UNFORESSEN CONTITIONS, SUBSURFACE OF OTHERWISE FOR EVALUATION AND RECOMMENDATIONS. ANY CONTRACTION BETWEEN ITEMS OF THIS PLAN/PLAN SET, OR BETWEEN THE PLANS AND ON—SITE CONDITIONS MUST BE RESOLVED BEFORE RELATED CONSTRUCTION HAS BEEN NITIATED.
- 2. A TEMPORARY CULVERT AND ROADBED SHALL BE IN PLACE PRIOR TO ANY USE OF A WETLAND
- WETLAND IMPACTS SHALL NOT OCCUR UNTIL ALL PERMITS HAVE BEEN ACQUIRED AND IMPACT MITIGATION REQUIREMENTS HAVE BEEN SATISFIED.

- 6. ALL EGSTING PAVED SURFACES WITHIN THE LIMITS OF WORK THAT ARE TO REMAIN SHALL BE RECLAIMED TO MINIMUM DEPTH OF 12" AND RECRADED AS SHOWN ON THE GRADING AND DRAIMAGE PLAN. RECLAIMED ASPHALT SHALL CONFORM TO STATE SPECIFICATIONS. PROOF TO REMOVAL, PAVEMENT SHALL BE SAWCUT AT ALL ENTRAICES AND LIMITS OF REMOVAL.
- ALL EXISTING GRANITE CURBING TO BE REMOVED SHALL BE STOCKPILED IN AN AREA TO BE
  DESIGNATED BY THE OWNER OR OWNER'S REPRESENTATIVE. THE OWNER SHALL INSPECT GRANTE
  CURBING TO BE REST AND APPROVE LOCATION OF RESET CURBING. THE CONTRACTOR SHALL NOT
  INSTALL USED CURBING AT ANY ENTRANCE LOCATIONS.
- 9. EXISTING WATERLINES AND HYDRANTS TO BE REMOVED SHALL BE CAPPED AT EXISTING WATERMAIN
- 10. EXISTING GAS SERVICE LINES ARE TO BE REMOVED ON-SITE UP TO EXISTING GASMAIN LINES OR VALVES
- THE CONTRACTOR SHALL REMOVE AND PROPERLY DISPOSE OF ALL CONTAMINATED MATERIAL LOCATED IN THE AREA OF EXISTING LEACHFIELDS IN ACCORDANCE WITH LOCAL AND STATE REGULATIONS.
- 13. SEE LANDSCAPE PLAN FOR "TREES TO BE SAVED" AND DETAILS ASSOCIATED WITH LANDSCAPED AREAS.
- THE CONTRACTOR SHALL OBTAIN TREE CLEARING PERMIT FROM LOCAL AND STATE AUTHORITIES PRIOR TO START OF CONSTRUCTION (IF REQUIRED).
- 15. CONTRACTOR SHALL HAVE THE OPTION TO REMOVE DRAINAGE/SEWER STRUCTURES, OR REMOVE MANHOLE FRAME AND GRATE/COVER TO A MINIMUM OF 36" BELDW FINISH GRADE, FRACTURE BOTTOM AND FILL WITH COMPACTED BORROW.

- 18. EROSION AND SEDIMENTATION CONTROL MEASURES SHALL BE INSTALLED PRIOR TO CONSTRUCTION AND ANY EARTH MOVING OPERATIONS. SILT FENCE SHALL BE INSTALLED AT THE LIMITS OF IMPACT AREAS ACCORDING TO THE DETAILS SHOWN ON SHEET ET.
- EXCAVATED MATERIALS WILL BE PLACED WITHIN UPLAND AREAS AS FILL MATERIAL OR HAULED OFF—SITE FOR DISPOSAL IN AN APPROPRIATE UPLAND LOCATION.

PROJECT PARCEL CITY OF ROCHESTER TAX MAP 131, LOT 1

11 LAFAYETTE ROAD NORTH HAMPTON, NH 03862

TOTAL LOT AREA 1,309,695 SQ. FT. ±

30.07 ACRES ±

Design: JAC Draft: LAZ Date: 04/29/21
Checked: JAC Scale: AS NOTED Project No.: 21090
Drawling Name: 21090-PLAN.dwg

THIS PLAN SHALL NOT BE MODIFIED WITHOUT WRITTEN PERMISSION FROM JONES & BEACH ENGINEERS, INC. (JBE). ANY ALTERATIONS, AUTHORIZED OR OTHERWISE, SHALL BE AT THE USER'S SOLE RISK AND WITHOUT LIABILITY TO JBE.



1	1/18/22	REVISED PER CITY COMMENTS	LAZ
0	11/23/21	ISSUED FOR REVIEW	LAZ
REV.	DATE	REVISION	BY

Designed and Produced in NH Jones & Beach Engineers, Inc.


85 Portsmouth Ave. Civil Engineering Services PO Box 219 Stratham, NH 03885 FAX: 603-772-0227 E-MAIL: JBE@JONESANDBEACH.COM

BAYBERRY COMMONS 19 OLD GONIC ROAD, ROCHESTER, NH Project: Owner of Record: LEO P. LACOUTURE REV. TRUST & WILLIAN B. LACOUTURE 19 OLD GONIC RD., ROCHESTER, NH 03867 BK 4093 PG 148

Plan Name:

**DEMOLITION PLAN** 

DRAWING No DM-1 SHEET 7 OF 46 JBE PROJECT NO. 21090

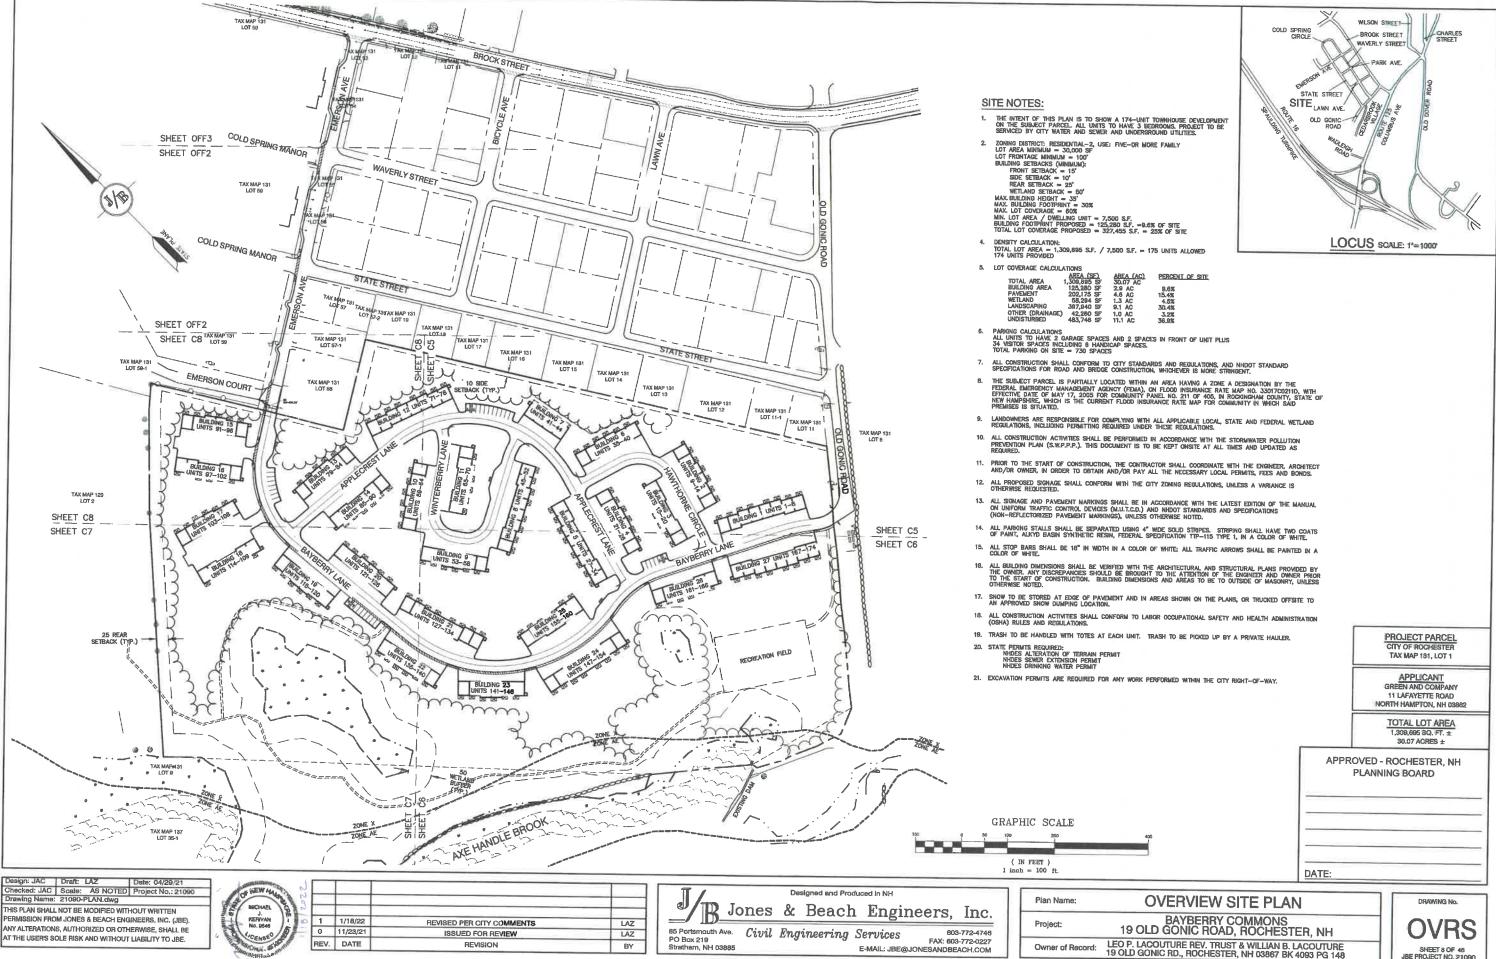

**OVRS** SHEET 8 OF 46 JBE PROJECT NO. 21090

Owner of Record:

E-MAIL: JBE@JONESANDBEACH.COM



Drawing Name: 21090-PLAN.dwg

This PLAN SHALL NOT BE MODIFIED WITHOUT WRITTEN
PERMISSION FROM JONES & BEACH ENGINEERS, INC. (JBE).
ANY ALTERATIONS, AUTHORIZED OR OTHERWISE, SHALL BE
AT THE USER'S SOLE RISK AND WITHOUT LIABILITY TO JBE.



1	1/18/22	REVISED PER CITY COMMENTS	LAZ
0	11/23/21	ISSUED FOR REVIEW	LAZ
REV.	DATE	REVISION	BY

Jones & Beach Engineers, Inc.

85 Portsmouth Ave.
PO Box 219
Stratham, NH 03885

Designed and Produced in NH

Beach Engineers, Inc.

603-772-4746
FAX: 603-772-0227


E-MAIL: JBE@JONESANDBEACH.COM


Plan Name: SITE PLAN

Project: BAYBERRY COMMONS
19 OLD GONIC ROAD, ROCHESTER, NH

Owner of Record: LEO P. LACOUTURE REV. TRUST & WILLIAN B. LACOUTURE
19 OLD GONIC RD., ROCHESTER, NH 03867 BK 4093 PG 148

C5
SHEET B OF 48
JBE PROJECT NO. 21090

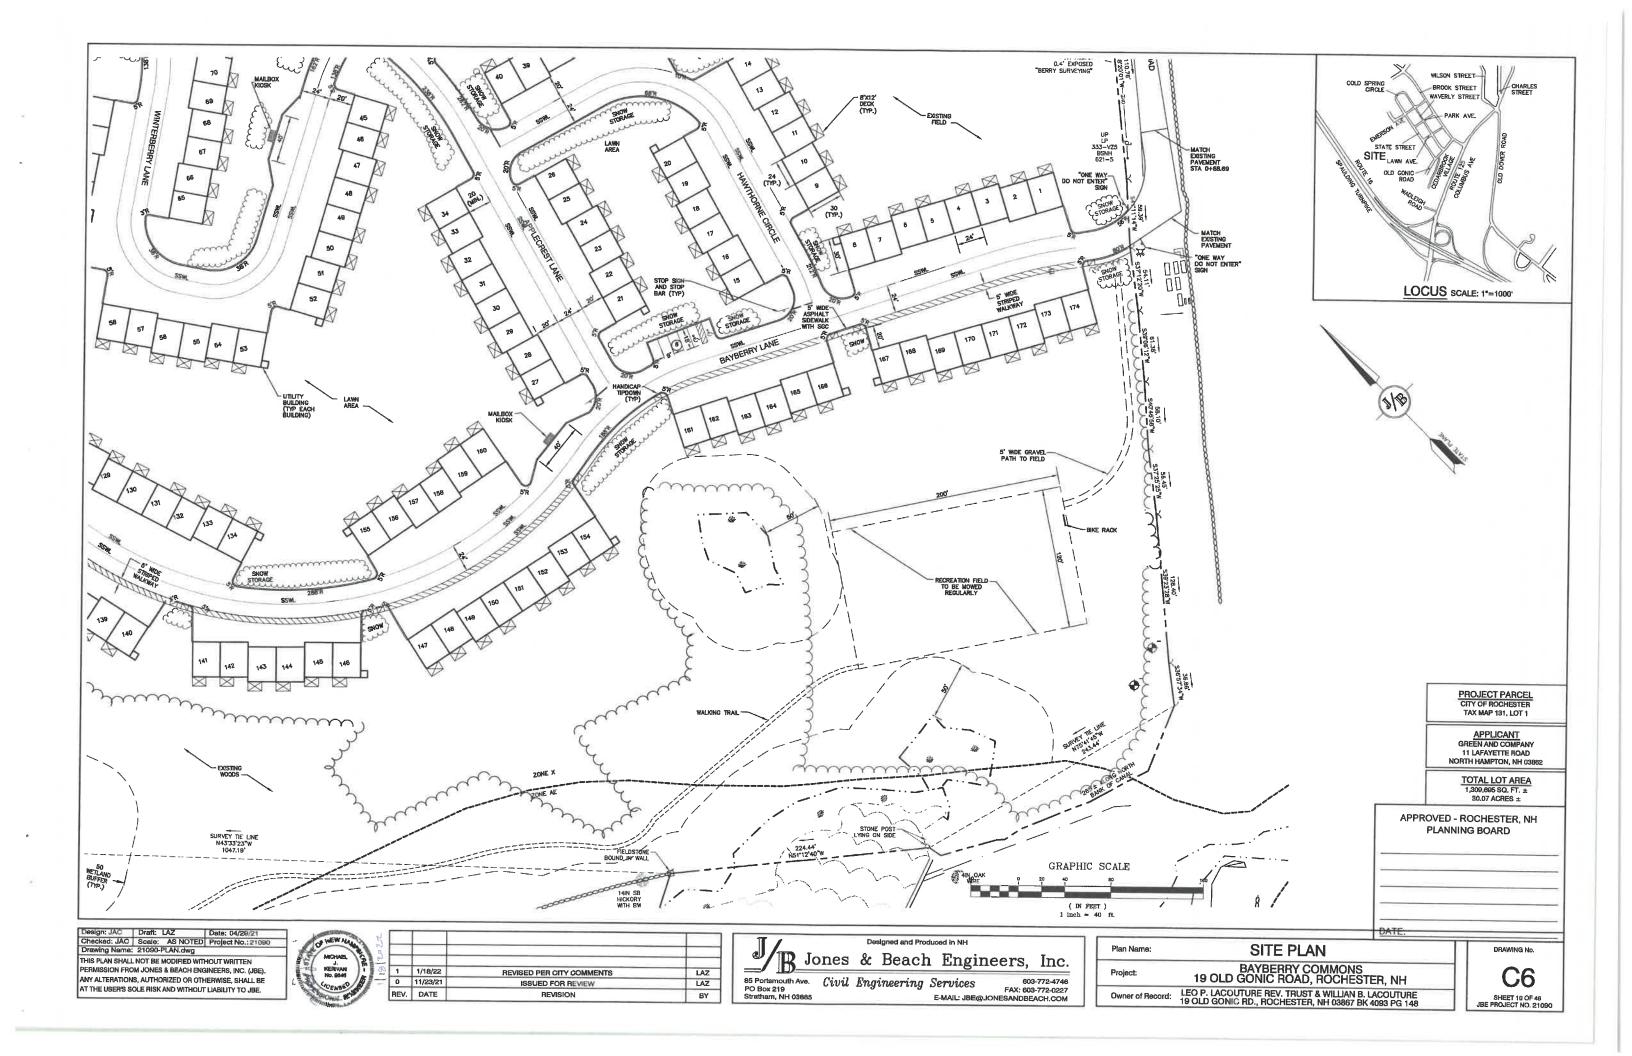

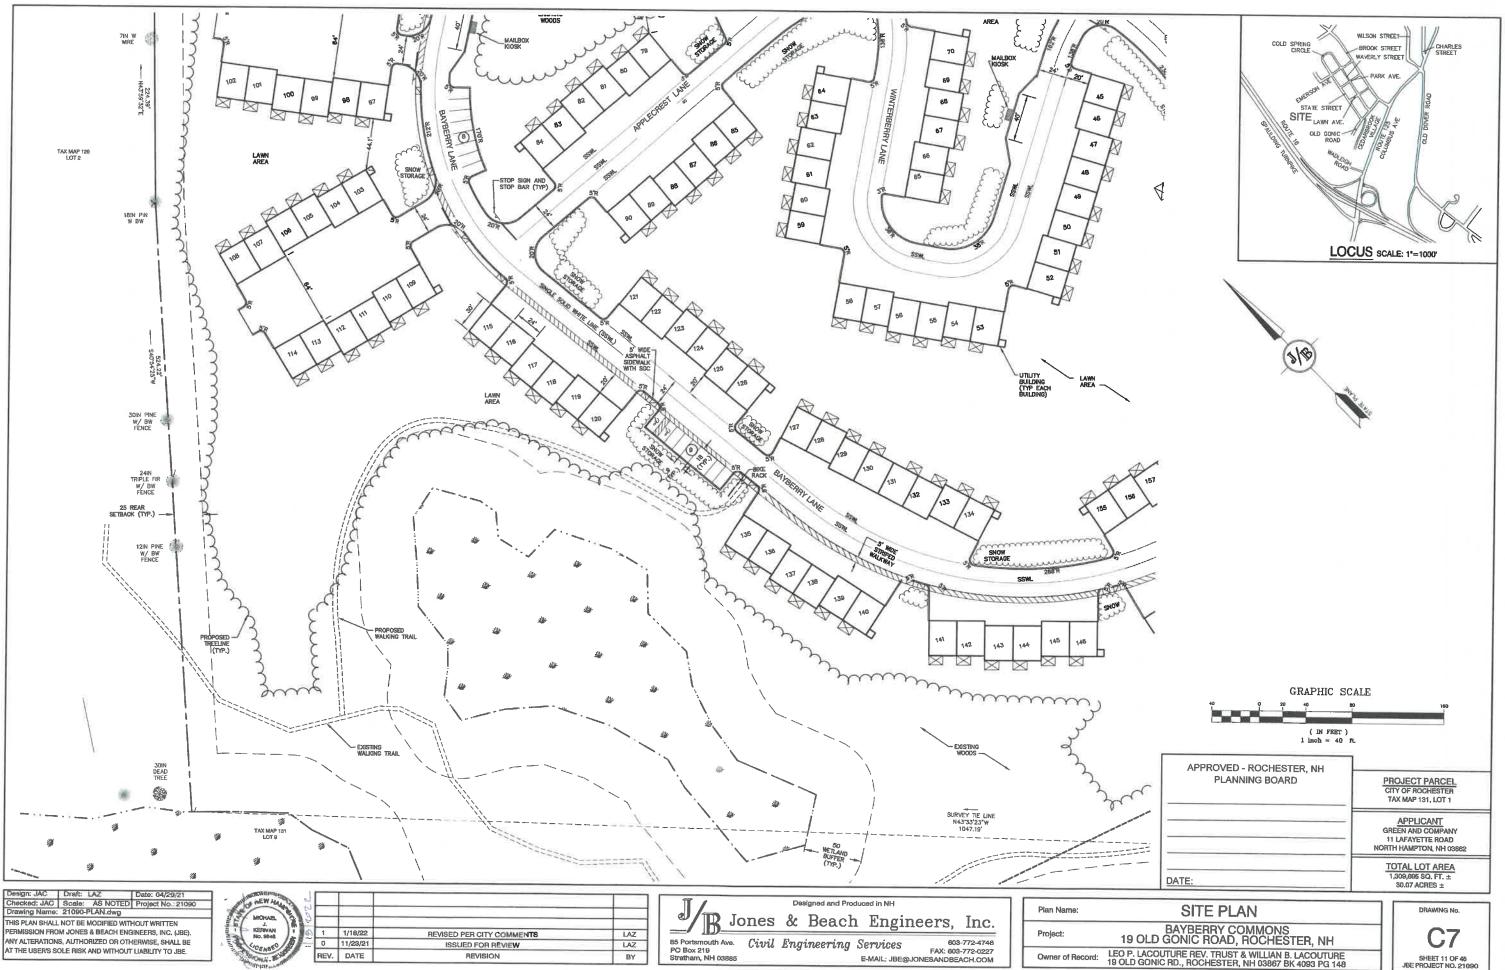

ANY ALTERATIONS, AUTHORIZED OR OTHERWISE, SHALL BE AT THE USER'S SOLE RISK AND WITHOUT LIABILITY TO JBE.



REVISION BY

85 Portsmouth Ave. Civil Engineering Services
PO Box 219
Stratham, NH 03885

E-MAIL: JBE® Services 603-772-4748 FAX: 603-772-0227 E-MAIL: JBE@JONESANDBEACH.COM SHEET 11 OF 48 JBE PROJECT NO. 21090



THIS PLAN SHALL NOT BE MODIFIED WITHOUT WRITTEN PERMISSION FROM JONES & BEACH ENGINEERS, INC. (JBE). ANY ALTERATIONS, AUTHORIZED OR OTHERWISE, SHALL BE AT THE USER'S SOLE RISK AND WITHOUT LIABILITY TO JBE.



1	1/18/22	REVISED PER CITY COMMENTS	LAZ
0	11/23/21	ISSUED FOR REVIEW	LAZ
REV.	DATE	REVISION	BY


Jones & Beach Engineers, Inc.

B5 Portsmouth Ave. Civil Engineering Services
PO Box 219
Stratham, NH 09885
E-MAIL: JBE@ Services 603-772-4746 FAX: 603-772-0227 E-MAIL: JBE@JONESANDBEACH.COM

Plan Name:	SITE PLAN
	BAYRERRY COMMONS

19 OLD GONIC ROAD, ROCHESTER, NH Owner of Record: LEO P. LACOUTURE REV. TRUST & WILLIAN B. LACOUTURE 19 OLD GONIC RD., ROCHESTER, NH 03867 BK 4093 PG 148

**C8** SHEET 12 OF 48 JBE PROJECT NO. 21090

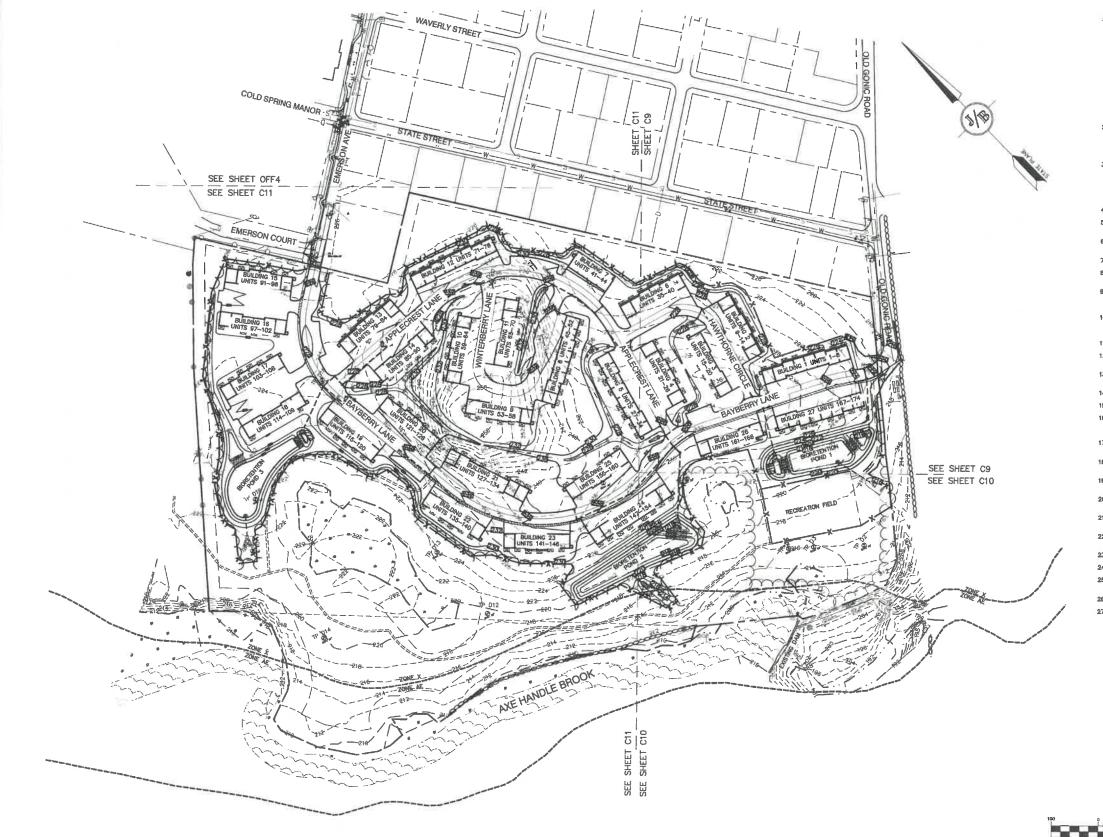

LAZ

LAZ

BY

## **GRADING AND DRAINAGE NOTES:**

- THIS SITE WILL REQUIRE A USEPA NPDES PERMIT FOR STORMWATER DISCHARGE FOR THE CONSTRUCTION SITE.

  THE CONSTRUCTION SITE OPERATOR SHALL DEVELOP AND IMPLEMENT A CONSTRUCTION STORM WATER POLLUTION
  PREVENTION PLAN (SWPPP), WHICH SHALL REDAIN ON SITE AND BE MADE ACCESSIBLE TO THE PUBLIC. THE
  CONSTRUCTION SITE OPERATOR SHALL SUBMIT A NOTICE OF HITEMY (NO!) TO THE EPA RECIONAL OFFICE SEVEN
  DAYS PRIOR TO COMMENCEMENT OF ANY WORK ON SITE EPA WILL POST THE NOI AT
  HITTP://CPPUBLEPA.GOV/APPOES/STORMWATER/NO/NOSSARCH-CHAIN, AUTHORIZATION IS GRANTED UNDER THE
  PERMIT ONCE THE NOI IS SHOWN IN "ACTIVE" STATUS ON THIS WEBSITE. A COMPLETED NOTICE OF TERMINATION
  SHALL BE SUBMITTED TO THE MPDES PERMITTING AUTHORITY WITHIN 30 DAYS AFTER ETHER OF THE FOLLOWING
  CONDITIONS HAVE BEEN MET:

  A. FIRML STABILIZATION HAS BEEN ACHIEVED ON ALL PORTIONS OF THE SITE FOR WHICH THE PERMITTEE IS
  RESPONSIBLE, OR
  B. ANOTHER OPERATOR/PERMITTEE HAS ASSUMED CONTROL OVER ALL AREAS OF THE SITE THAT
  HAVE NOT BEEN FINALLY STABILIZED. PROVIDE DPW WITH A COPY OF THE NOTICE OF

  - TERMINATION (NOT).
- IF THIS CONSTRUCTION SITE IS NOT STABILIZED WITH PAVEMENT, A ROAD GRAVEL BASE, 85 % MATURE VEGETATION COVER, OR RIPRAP BY OCTOBER 15, THEN THE SITE MUST BE PROTECTED WITH OVER-WINTER STABILIZATION. THE WINTER CONSTRUCTION PERIOD IS FROM OCTOBER 15 THROUGH MAY 15, WINTER EXCAVATION AND EARTHWORK ACTIVITIES SHALL BE LIMITED IN EXTENT AND DURATION, TO MINIMIZE POTENTIAL EROSION AND SEMBENTATION IMPACTS.
- UNDERGROUND FACILITIES, UTILITIES AND STRUCTURES HAVE BEEN PLOTTED FROM FIELD OBSERVATION AND THEIR LOCATION MUST BE CONSIDERED APPROXIMATE ONLY, NEITHER, LONES & BEACH ENGINEERS, INC., NOR ANY OF THEIR ENDIPOYEES TAKE RESPONSIBILITY FOR THE LOCATION OF ANY UNDERGROUND STRUCTURES AND/OR UTILITIES NOW THAT MAY EXOST. IT IS THE RESPONSIBILITY OF THE CONTRACTOR TO HAVE ALL UNDERGROUND STRUCTURES AND/OR UTILITIES LOCATED PRIOR TO EXCAVATION WORK BY CALLING 888-01G-SAFE (888-344-7233).
- 4. ALL BENCHMARKS AND TOPOGRAPHY SHOULD BE FIELD VERIFIED BY THE CONTRACTOR.
- SITE GRADING SHALL NOT PROCEED UNTIL EROSION CONTROL MEASURES HAVE BEEN INSTALLED, SEE CONSTRUCTION SEQUENCE ON SHEET E1.
- PRIOR TO THE START OF CONSTRUCTION, THE CONTRACTOR IS REQUIRED TO HAVE THE PROJECT'S LAND SURVEYOR STAKE OR FLAG CLEARING LIMITS. A MINIMUM OF 48 HOURS NOTICE IS REQUIRED.
- ALL SWALES AND DETENTION PONDS ARE TO BE STABILIZED PRIOR TO DIRECTING RUNOFF TO THEM.
- PROPOSED RIM ELEVATIONS OF DRAINAGE STRUCTURES ARE APPROXIMATE. FINAL ELEVATIONS ARE TO BE SET FLUSH WITH FINISH GRADES.
- ALL SWALES AND ANY SLOPES GREATER THAN 3.1 SHALL BE STABILIZED WITH NORTH AMERICAN GREEN STS
  EROSION CONTROL BLANKETS (OR AN EQUIVALENT APPROVED IN WRITING BY THE ENGINEER), UNLESS OTHERWISE
  SPECIFIED.
- ALL DRAINAGE AND SANITARY STRUCTURE INTERIOR DIAMETERS (4' MIN) SHALL BE DETERMINED BY THE MANUFACTURER BASED ON THE PIPE CONFIGURATIONS SHOWN ON THESE PLANS. CATCH BASINS SHALL HAVE 3' DEEP SUMPS WITH GREASE HOODS, UNLESS OTHERWISE NOTED.
- 11. ALL DRAINAGE STRUCTURES SHALL BE PRECAST, UNLESS OTHERWISE SPECIFIED.
- 12. ALL DRAINAGE STRUCTURES AND STORM SEWER PIPES SHALL MEET HEAVY DUTY TRAFFIC H2D LOADING AND SHALL BE INSTALLED ACCORDINGLY.
- 13. THE CONTRACTOR SHALL INSTALL GRANGE CONSTRUCTION FENCING ALONG PROPERTY LINES AND ALONG WETLAND BUFFERS.
- 14. ALL DRAINAGE PIPE SHALL BE NON-PERFORATED ADS N-12 OR APPROVED EQUAL.
- 15. STONE INLET PROTECTION SHALL BE PLACED AT ALL CATCH BASINS. SEE DETAIL WITHIN THE DETAIL SHEETS.
- 18. LAND DISTURBING ACTIVITIES SHALL NOT COMMENCE UNTIL APPROVAL TO DO SO HAS BEEN RECEIVED BY ALL GOVERNING AUTHORITIES. THE GENERAL CONTRACTOR SHALL STRICTLY ADHERE TO THE EPA SWPPP DURING CONSTRUCTION OPERATIONS.
- ALL EXPOSED AREAS SHALL BE SEEDED AS SPECIFIED WITHIN 3 DAYS OF FINAL GRADING AND ANYTIME CONSTRUCTION STOPS FOR LONGER THAN 3 DAYS.
- MAINTAIN EROSION CONTROL MEASURES AFTER EACH RAIN EVENT OF 0.5" OR GREATER IN A 24 HOUR PERIOD AND AT LEAST ONCE A WEEK.
- THIS PLAN SHALL NOT BE CONSIDERED ALL INCLUSIVE, AS THE GENERAL CONTRACTOR SHALL TAKE ALL NECESSARY PRECAUTIONS TO PREVENT SEDIMENT FROM LEAVING THE SITE.
- 20. CONSTRUCTION VEHICLES SHALL UTILIZE THE STABILIZED CONSTRUCTION ENTRANCE TO THE EXTENT POSSIBLE THROUGHOUT CONSTRUCTION.
- IF INSTALLATION OF STORM DRAINAGE SYSTEM SHOULD BE INTERRUPTED BY WEATHER OR NIGHTFALL, THE PIPE ENDS SHALL BE COVERED WITH FILTER FABRIC.
- 22. THE GENERAL CONTRACTOR SHALL BE RESPONSIBLE TO TAKE WHATEVER MEANS NECESSARY TO ESTABLISH PERMANENT SOIL STABILIZATION,
- 23. SEDIMENT SHALL BE REMOVED FROM ALL SEDIMENT BASINS BEFORE THEY ARE 25% FULL.
- 24. ALL WORK SHALL BE DONE IN STRICT ACCORDANCE WITH PROJECT SPECIFICATIONS.
- ADDITIONAL EROSION AND SEDIMENT CONTROL MEASURES SHALL BE INSTALLED, IF DEEMED NECESSARY BY ON-SITE INSPECTION BY ENGINEER AND/OR REGULATORY OFFICIALS.
- 26. SEE ALSO EROSION AND SEDIMENT CONTROL SPECIFICATIONS ON SHEET EL.
- 27. PRIOR TO CLEARING OR GRADING DISTURBANCE, THE CONTRACTOR SHALL IDENTIFY ALL AREAS OF TYPE 2 INVASIVE SPECIES AS DEFINED BY NHOOT AND ADHERE TO THE PRACTICES DUTLINED IN <u>BEST MANAGEMENT</u> PRACTICES FOR THE CONTROL OF INVASIVE AND NOOLOUS PLANT SPECIES. MHOOT, 2018. THE PRACTICES SHALL BE: FOLLOWED FOR THE ENTIRE CONSTRUCTION TERM INCLUDING ESTABLISHMENT OF LANDSCAPPIG. AS THE STEERE—VEGETATES AFERE CONSTRUCTION, LANDSCAPPIG CONTRACTOR TO INFORM THE OWNER IF ANY INVASIVE SPECIES START TO GROW. OWNER SHALL CONTACTOR QUALIFIED REMOVAL COMPANY AND FOLLOW NHOES BEST MANAGEMENT PRACTICES.

GRAPHIC SCALE ( IN FEET ) 1 inch = 100 ft.

PROJECT PARCEL **TAX MAP 131, LOT 1** 


**APPLICANT** GREEN AND COMPANY 11 LAFAYETTE ROAD NORTH HAMPTON, NH 03862

> TOTAL LOT AREA 30.07 AGRES ±

Design: JAC | Draft: LAZ Checked: JAC Scale: AS NOTED Project No.: 21090 Drawing Name: 21090-PLAN.dwg THIS PLAN SHALL NOT BE MODIFIED WITHOUT WRITTEN PERMISSION FROM JONES & BEACH ENGINEERS, INC. (JBE).

ANY ALTERATIONS, AUTHORIZED OR OTHERWISE, SHALL BE

AT THE USER'S SOLE RISK AND WITHOUT LIABILITY TO JIBE.

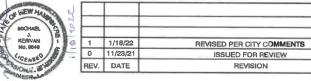


Designed and Produced in NH Jones & Beach Engineers, Inc.


85 Portsmouth Ave. Civil Engineering Services PO Box 219 Stratham, NH 03885 FAX: 603-772-0227 E-MAIL: JBE@JONESANDBEACH.COM

**OVERVIEW GRADING PLAN** Plan Name: BAYBERRY COMMONS 19 OLD GONIC ROAD, ROCHESTER, NH


LEO P. LACOUTURE REV. TRUST & WILLIAN B. LACOUTURE 19 OLD GONIC RD., ROCHESTER, NH 03867 BK 4093 PG 148 Owner of Record:

**OVRG** SHEET 18 OF 48 JBE PROJECT NO. 21090

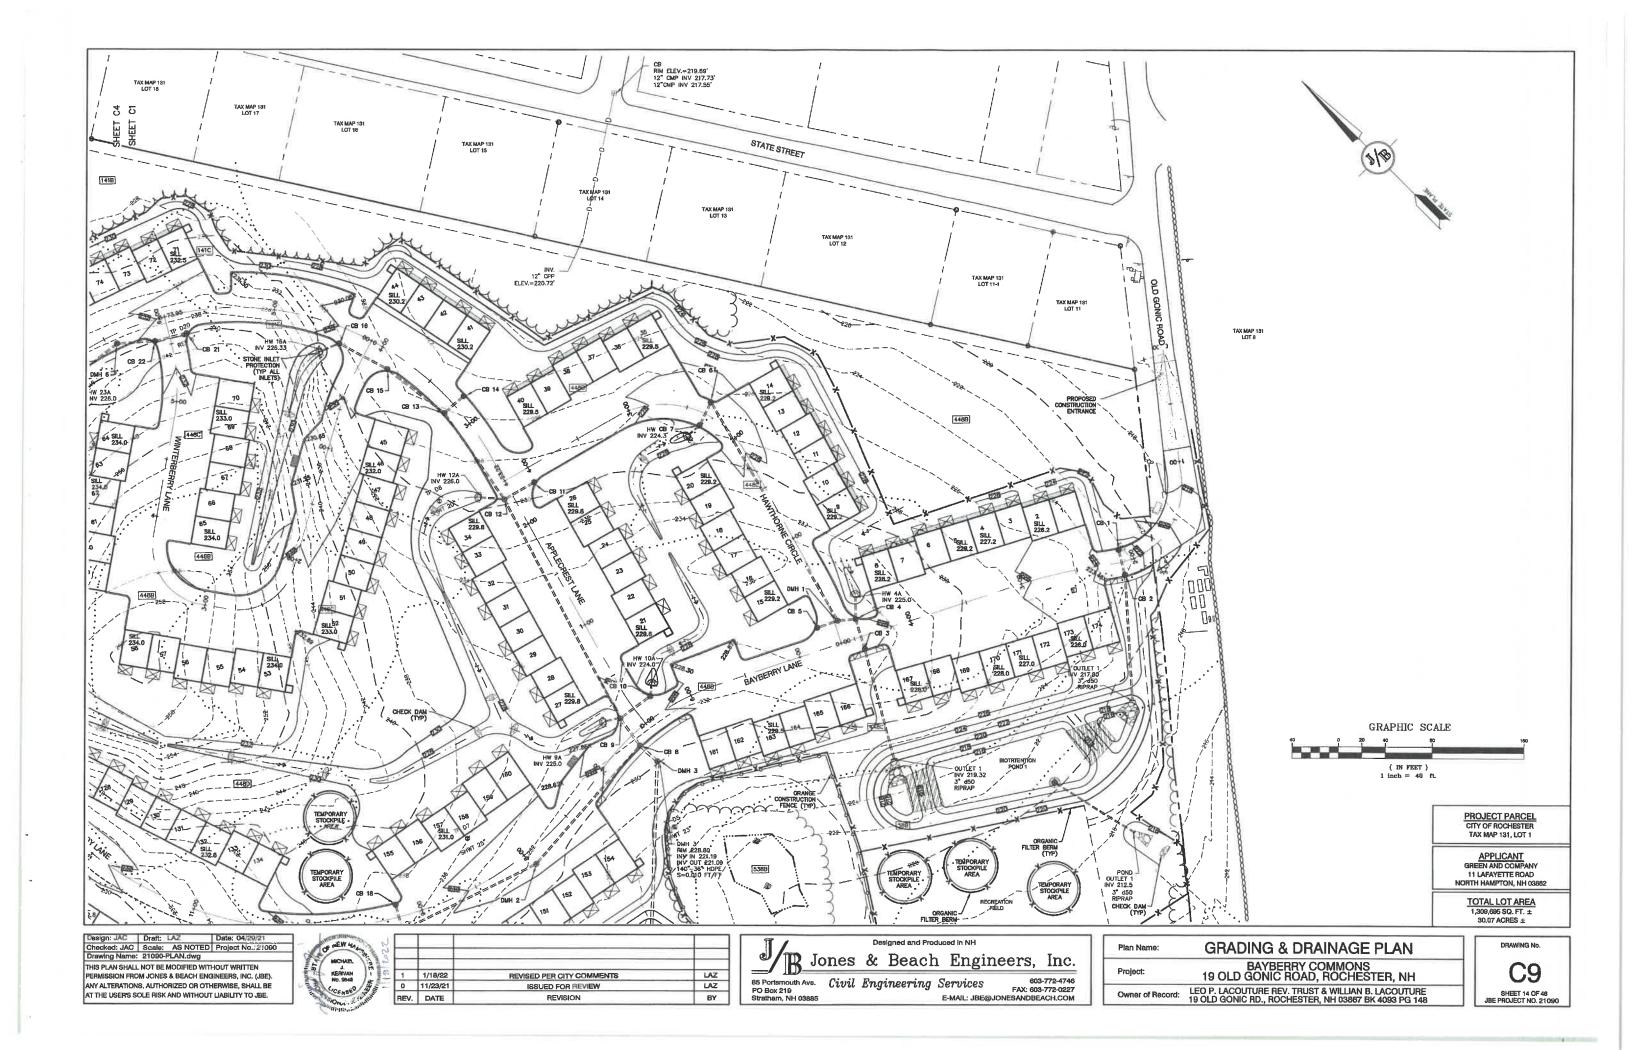

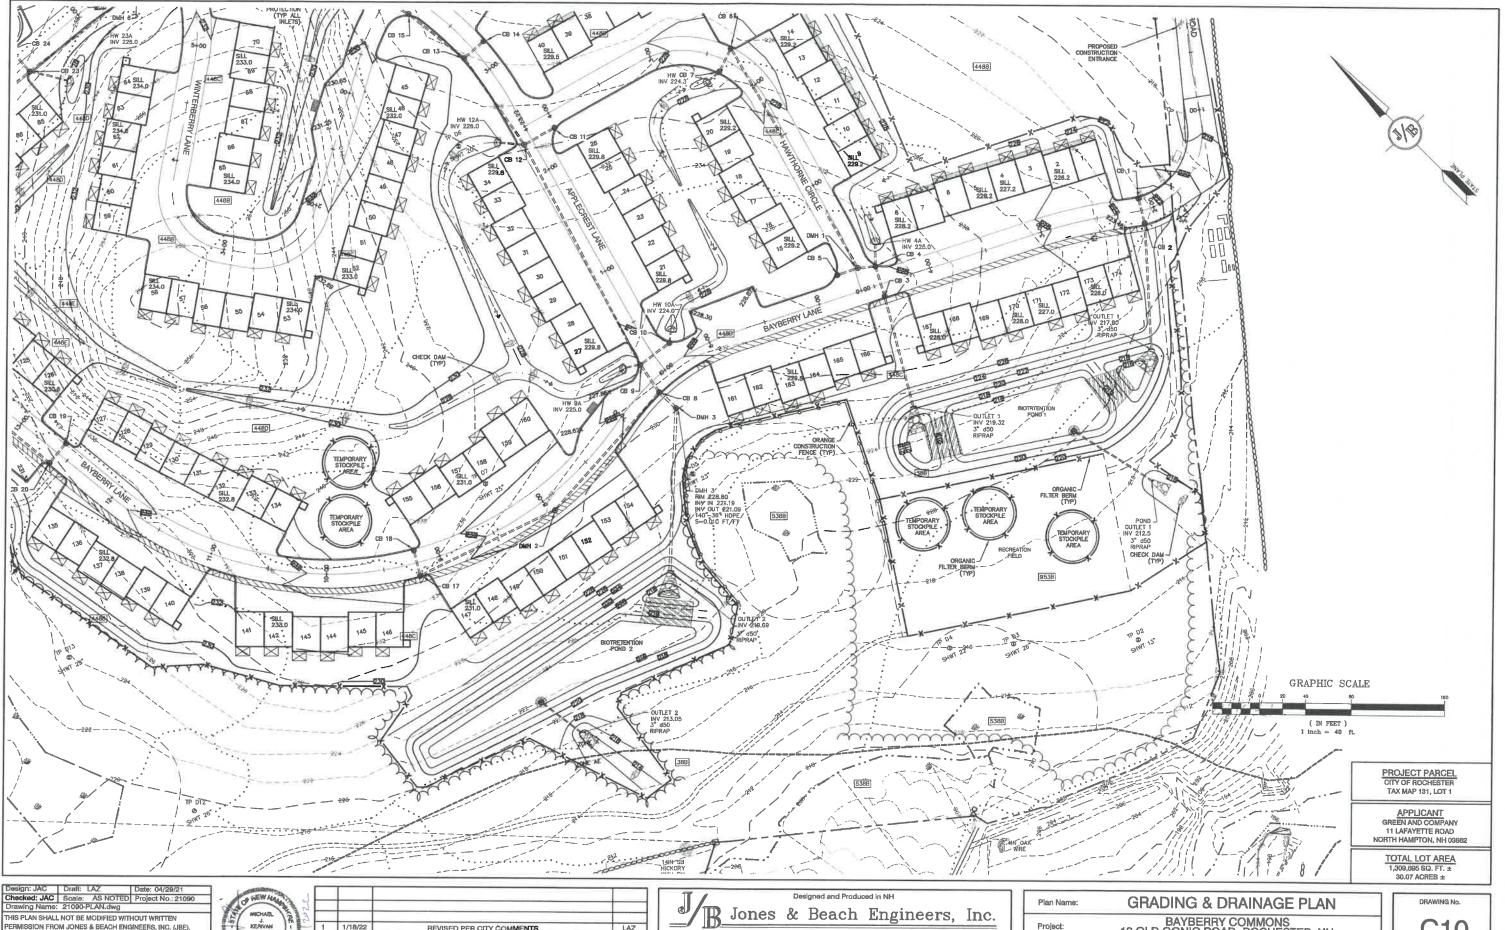

THIS PLAN SHALL NOT BE MODIFIED WITHOUT WRITTEN PERMISSION FROM JONES & BEACH ENGINEERS, INC. (JBE). ANY ALTERATIONS, AUTHORIZED OR OTHERWISE, SHALL BE AT THE USER'S SOLE RISK AND WITHOUT LIABILITY TO JBE.

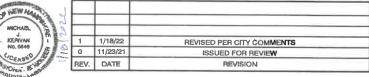

LAZ


BY

Services 603-772-4748 FAX: 603-772-0227 E-MAIL: JBE@JONESANDBEACH.COM 85 Portsmouth Ave. PO Box 219
Stratham, NH 03885

Civil Engineering Services
E-MAIL: JBE@

BAYBERRY COMMONS 19 OLD GONIC ROAD, ROCHESTER, NH Owner of Record: LEO P. LACOUTURE REV. TRUST & WILLIAN B. LACOUTURE 19 OLD GONIC RD., ROCHESTER, NH 03867 BK 4093 PG 148

C10 SHEET 15 OF 46 JBE PROJECT NO. 21090

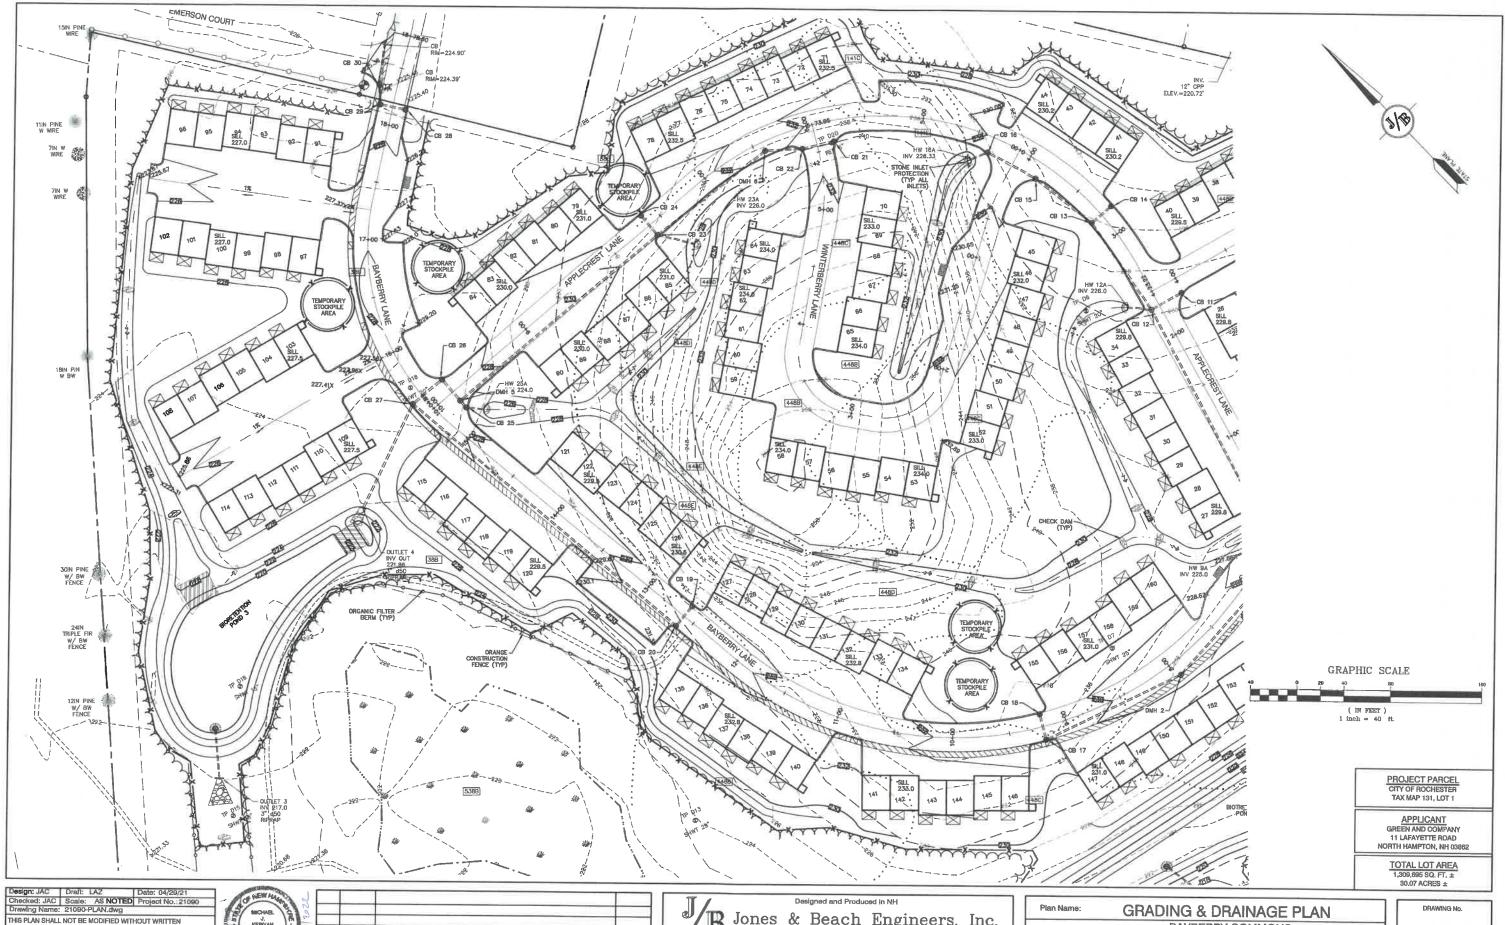

THIS PLAN SHALL NOT BE MODIFIED WITHOUT WRITTEN PERMISSION FROM JONES & BEACH ENGINEERS, INC. (JBE). ANY ALTERATIONS, AUTHORIZED OR OTHERWISE, SHALL BE AT THE USER'S SOLE RISK AND WITHOUT LIABILITY TO JBE.


1/18/22 REVISED PER CITY COMMENTS LAZ 0 11/23/21 ISSUED FOR REVIEW LAZ REV. DATE BY

B Jones & Beach Engineers, Inc.


85 Portsmouth Ave. Civil Engineering Services
PO Box 218
Stratham, NH 03885
E-MALI: JBE@ Services 603-772-4746 FAX: 603-772-0227 E-MAIL: JBE@JONESANDBEACH.COM BAYBERRY COMMONS 19 OLD GONIC ROAD, ROCHESTER, NH

LEO P. LACOUTURE REV. TRUST & WILLIAN B. LACOUTURE 19 OLD GONIC RD., ROCHESTER, NH 03867 BK 4093 PG 148 Owner of Record:

SHEET 16 OF 48 JBE PROJECT NO. 21090

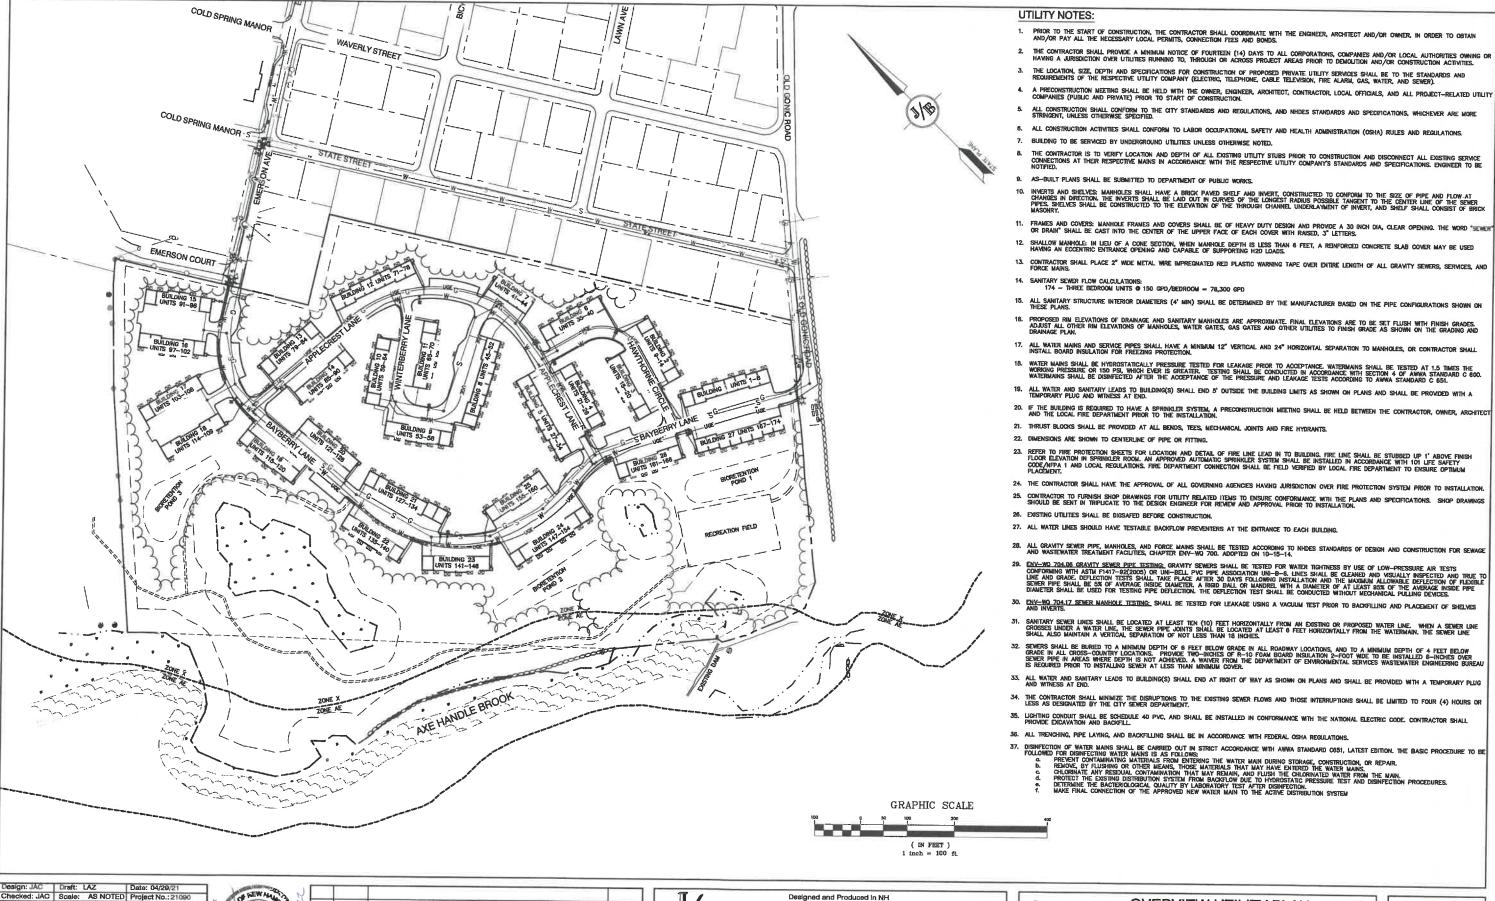

Checked: JAC Scale: AS NOTED Project No.: 210K Drawing Name: 21090-PLAN.dwg THIS PLAN SHALL NOT BE MODIFIED WITHOUT WRITTEN PERMISSION FROM JONES & BEACH ENGINEERS, INC. (JBE). ANY ALTERATIONS, AUTHORIZED OR OTHERWISE, SHALL BE AT THE USER'S SOLE RISK AND WITHOUT LIABILITY TO JBE.

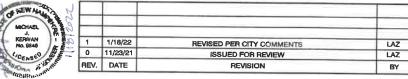

Jones & Beach Engineers, Inc.

85 Portsmouth Ave. Civil Engineering Services PO Box 219 E-MAIL: JBE@JONESANDBEACH.COM

## **OVERVIEW UTILITY PLAN** Plan Name:


Project:


FAX: 603-772-0227

BAYBERRY COMMONS 19 OLD GONIC ROAD, ROCHESTER, NH


LEO P. LACOUTURE REV. TRUST & WILLIAN B. LACOUTURE 19 OLD GONIC RD., ROCHESTER, NH 03867 BK 4093 PG 148 Owner of Record:

**OVRU** SHEET 17 OF 46 JBE PROJECT NO. 21090

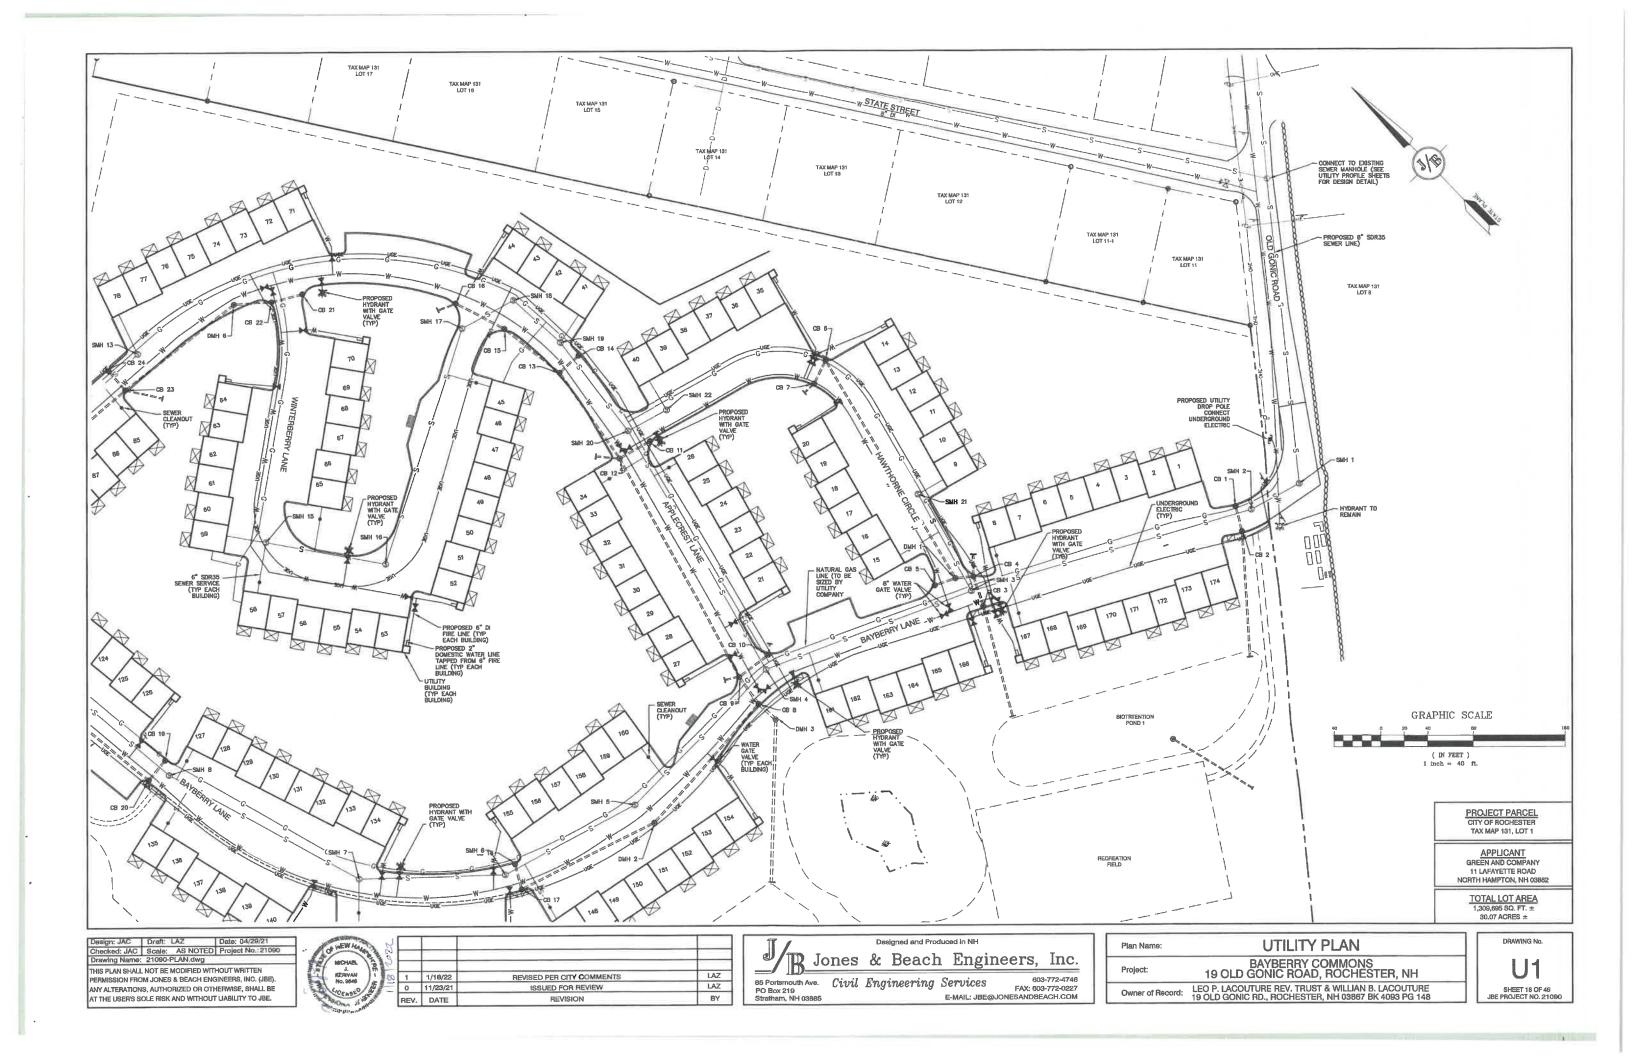

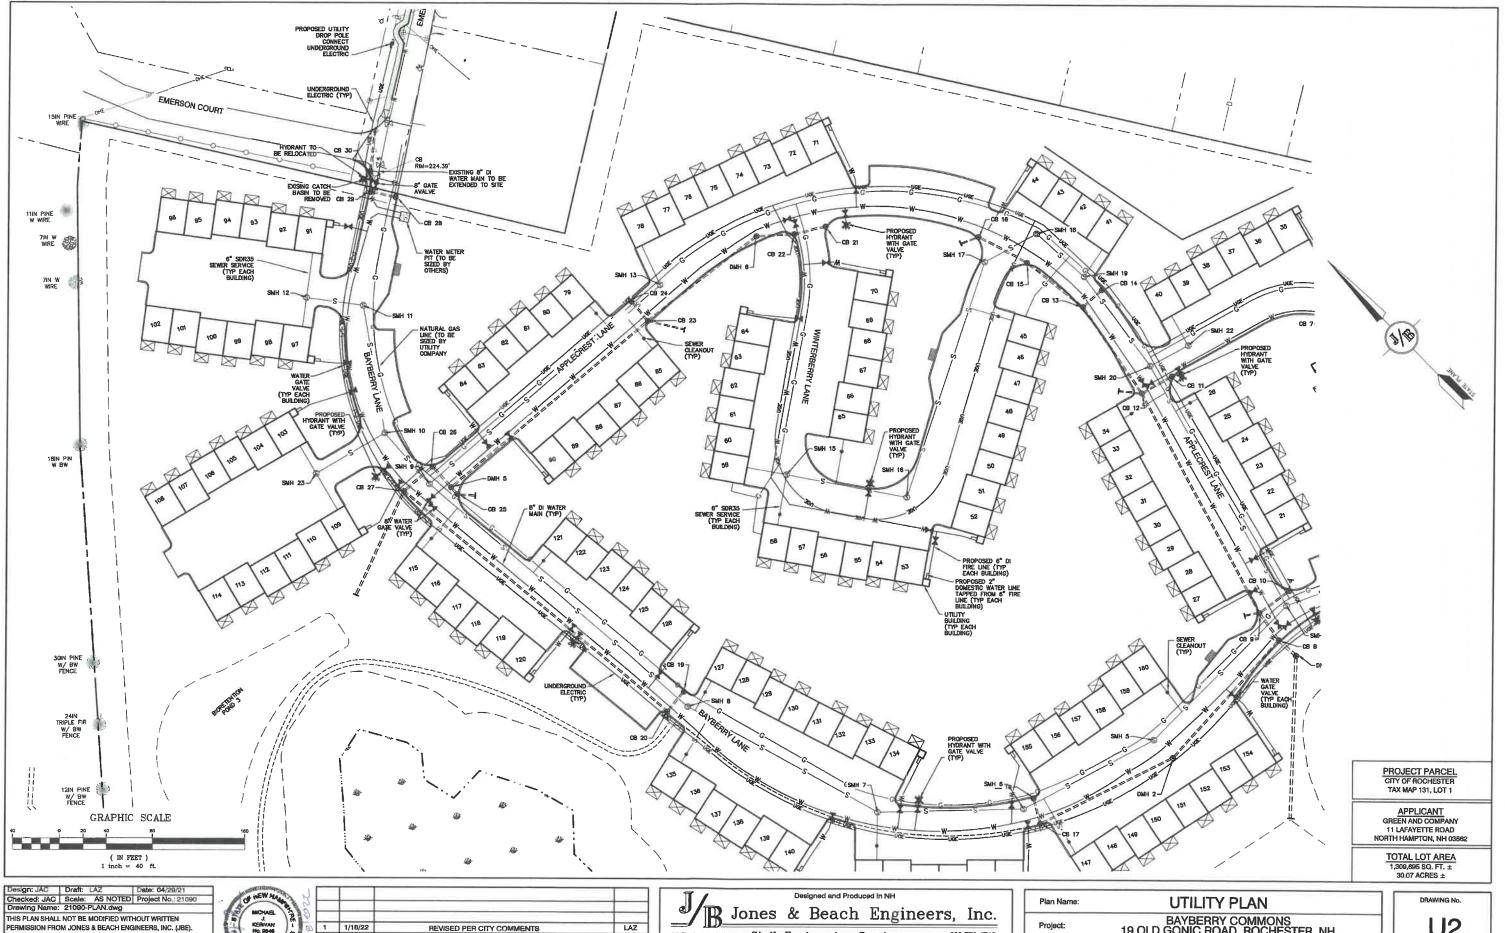


PERMISSION FROM JONES & BEACH ENGINEERS, INC. (JBE).
ANY ALTERATIONS, AUTHORIZED OR OTHERWISE, SHALL BE
AT THE USER'S SOLE RISK AND WITHOUT LIABILITY TO JBE.

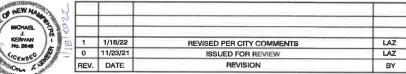


B5 Portsmouth Ave. Civil Engineering Services
PO Box 219
Stratham, NH 03885
E-MAIL: JBE@ Services 603-772-4746 FAX: 603-772-0227 E-MAIL: JBE@JONESANDBEACH.COM

BAYBERRY COMMONS 19 OLD GONIC ROAD, ROCHESTER, NH Owner of Record: LEO P. LACOUTURE REV. TRUST & WILLIAN B. LACOUTURE 19 OLD GONIC RD., ROCHESTER, NH 03867 BK 4093 PG 148

SHEET 19 OF 46 JBE PROJECT NO. 21090

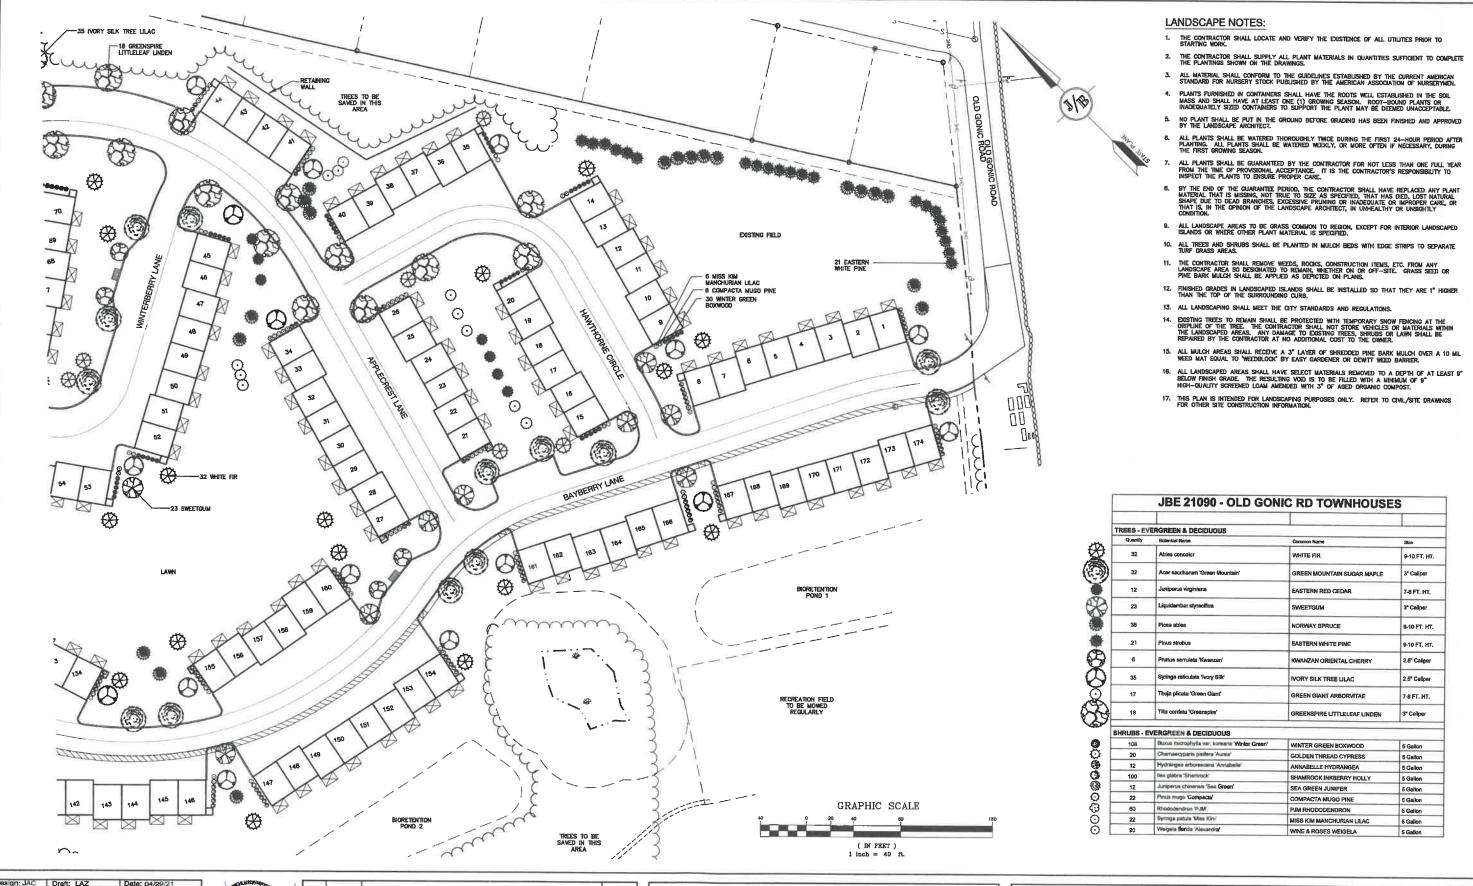

Design: JAC	Draft: LAZ	Date: 04/29/21
Checked: JAC	Scale: AS NOTED	Project No.: 21090
Drawing Name:	21090-PLAN.dwg	
THIS PLAN SHALL	NOT BE MODIFIED WIT	THOUT WRITTEN
PERMISSION FRO	M JONES & BEACH EN	GINEERS, INC. (JBE).
	S, AUTHORIZED OR OT	
	OLE RISK AND WITHOU	

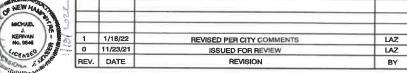



Designed and Produced in NH B Jones & Beach Engineers, Inc. \_\_/ 85 Port PO Box Stratha

rtsmouth Ave.	Cinal	Engineering	Samianas	603-772-47
ox 219	0 40 00	Bity titeer tity	Delottes	FAX: 603-772-02
am, NH 03885			E-MAIL: JBE@.	ONESANDBEACH.CO

Plan Name:	LANDSCAPE PLAN
Project:	BAYBERRY COMMONS 19 OLD GONIC ROAD, ROCHESTER, NH
Owner of Record:	LEO P. LACOUTURE REV. TRUST & WILLIAN B. LACOUTURE 19 OLD GONIC RD., ROCHESTER, NH 03867 BK 4093 PG 148

DRAWING No. SHEET 20 OF 46 JBE PROJECT NO. 21090

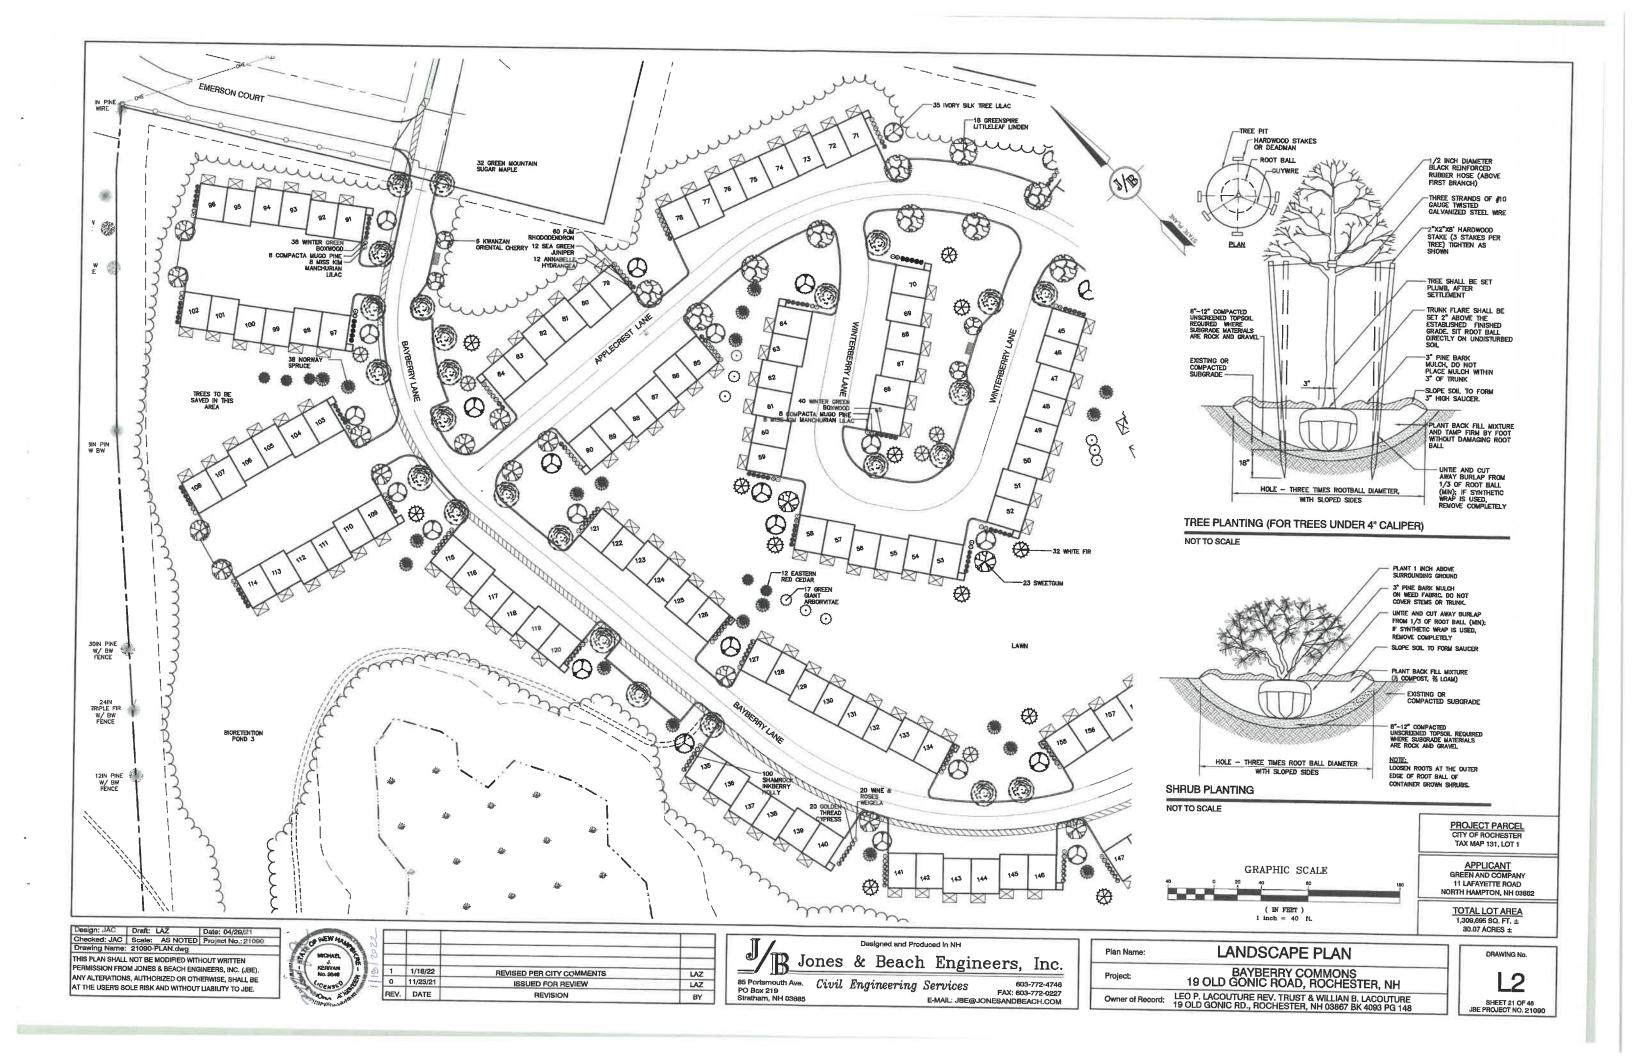

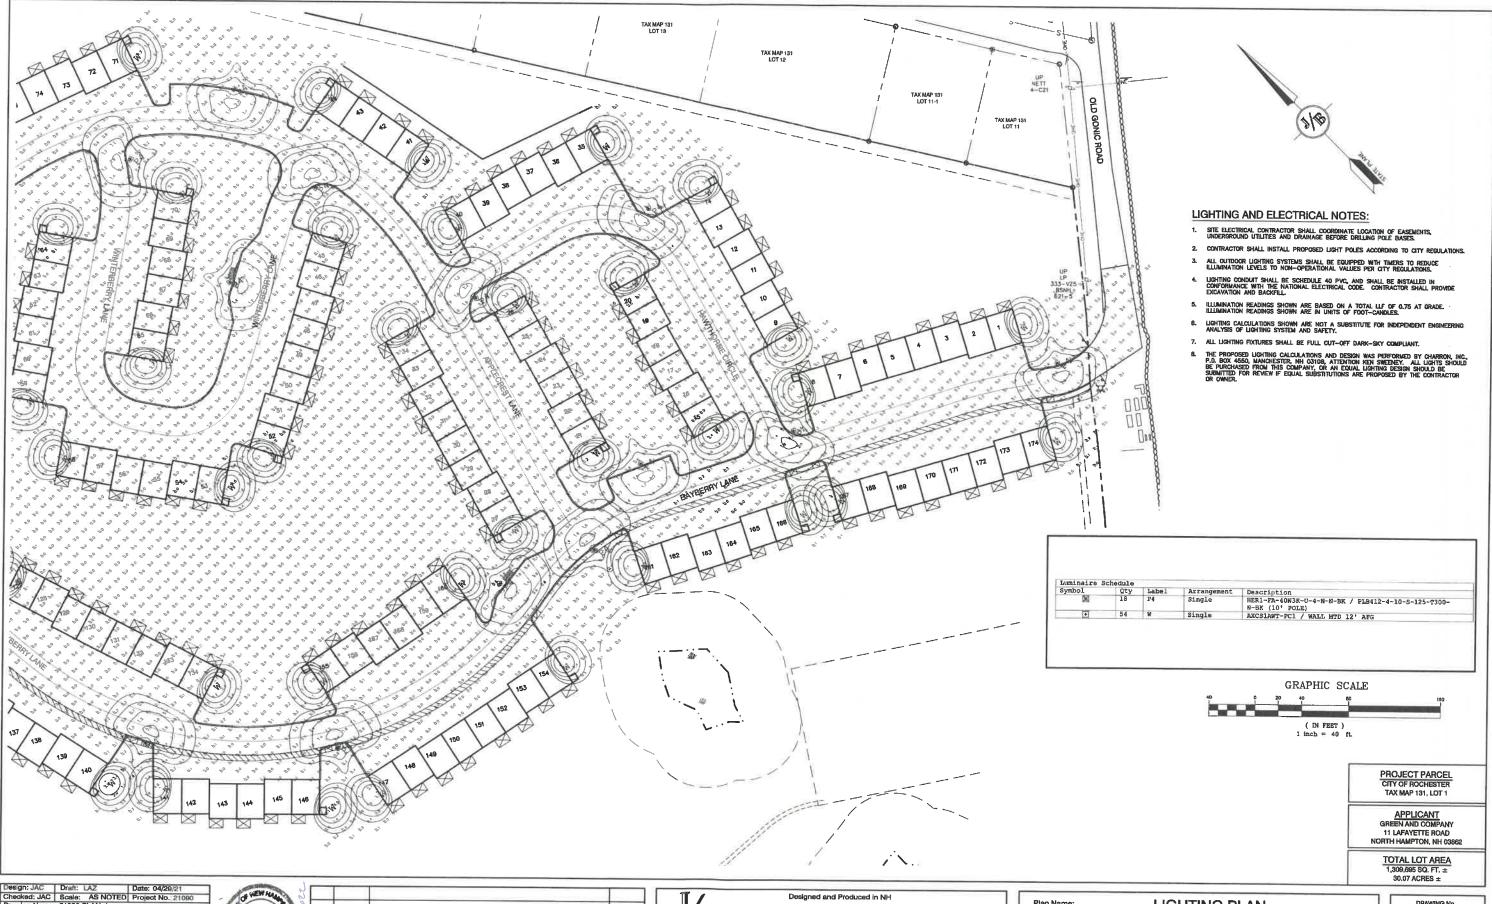

Dealgit. JAC	DIBIT. DAZ	Date: 04/29/21	- 1
	Scale: AS NOTED	Project No.: 21090	-1
Drawing Name:	21090-PLAN.dwg		83
THIS PLAN SHALL	NOT BE MODIFIED WIT	HOUT WRITTEN	1 2 2
PERMISSION FRO	M JONES & BEACH EN	GINEERS, INC. (JBE).	製具
ANY ALTERATION:	S, AUTHORIZED OR OT	HERWISE, SHALL BE	1
	DLE RISK AND WITHOU		100



1	1/18/22	REVISED PER CITY COMMENTS	LAZ
0	11/23/21	ISSUED FOR REVIEW	LAZ
REV.	DATE	REVISION	BY

Jones & Beach Engineers, Inc.


85 Portsmouth Ave. Civil Engineering Services
PO Box 219
Stratham, NH 03885
E-MAIL: JBE@ Services 603-772-4748 FAX: 603-772-0227 E-MAIL: JBE@JONESANDBEACH.COM

LIGHTING PLAN

Project: BAYBERRY COMMONS
19 OLD GONIC ROAD, ROCHESTER, NH

Owner of Record: LEO P. LACOUTURE REV. TRUST & WILLIAN B. LACOUTURE
19 OLD GONIC RD., ROCHESTER, NH 03867 BK 4093 PG 148

SHEET 22 OF 46 JBE PROJECT NO. 21090

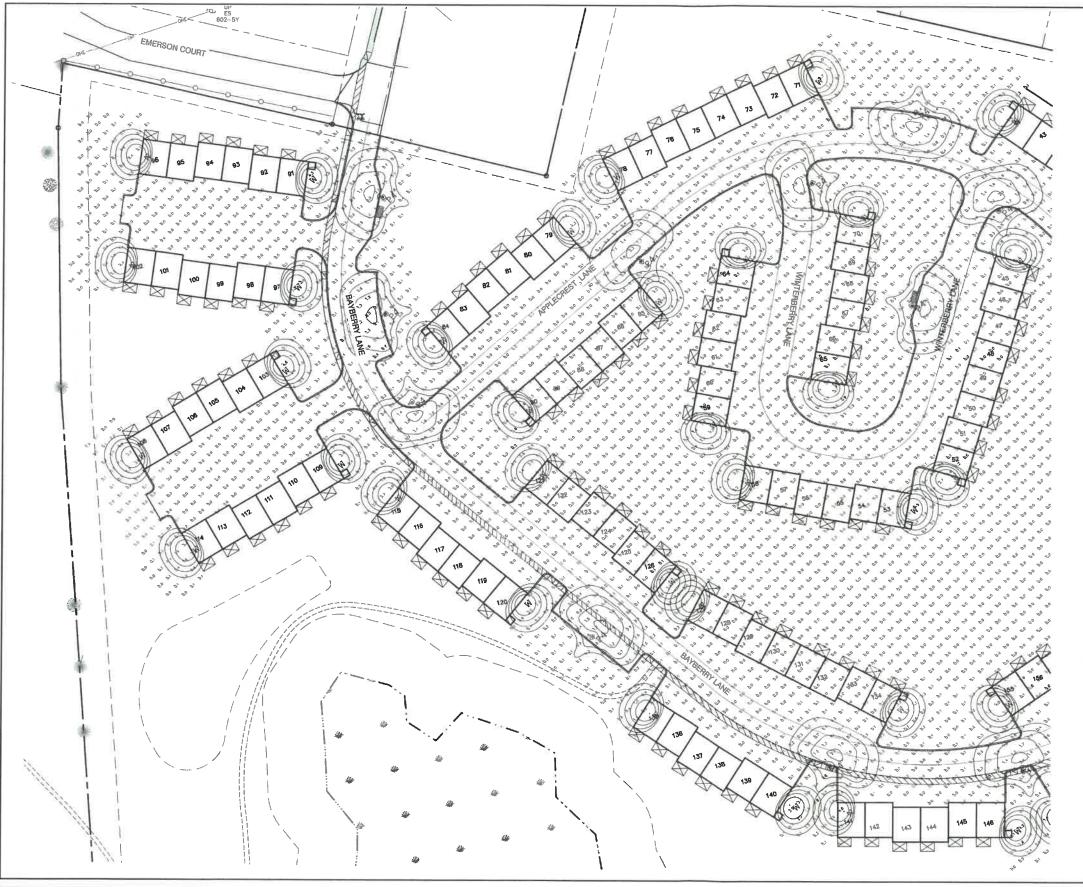


LAZ

LAZ

BY





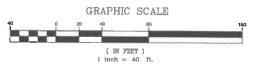

PROJECT PARCEL CITY OF ROCHESTER TAX MAP 131, LOT 1

APPLICANT GREEN AND COMPANY 11 LAFAYETTE ROAD NORTH HAMPTON, NH 0385

> TOTAL LOT AREA 1,309,695 SQ, FT. ± 30.07 ACRES ±

Design: JAC	Draft: LAZ	Date: 04/29/21
Checked: JAC	Scale: AS NOTED	Project No.: 21090
Drawing Name:	21090-PLAN.dwg	
THIS PLAN SHALL		OUT WRITTEN
	NOT BE MODIFIED WITH	
PERMISSION FRO		INEERS, INC. (JBE).

and the same			
WEW ALL	J		
	7		
HICHAEL 12	3		
KERIVAN I	න <b>1</b>	1/18/22	REVISED PER CITY COMMENTS
100	0	11/23/21	ISSUED FOR REVIEW
CENSE OF STREET	REV.	DATE	REVISION
Fileson Carrie	_		

B Jones & Beach Engineers, Inc.

B5 Portsmouth Ave. Civil Engineering Services 603-772-4746
PO Box 219
Strathsm, NH 03885 6-MAIL: JBE@JONESANDBEACH.COM


Plan Name:	LIGHTING PLAN
Project:	BAYBERRY COMMONS 19 OLD GONIC ROAD, ROCHESTER, NH
Owner of Record:	LEO P. LACOUTURE REV. TRUST & WILLIAN B. LACOUTURE 19 OLD GONIC RD., ROCHESTER, NH 03867 BK 4093 PG 148

DRAWING No.

L4

SHEET 23 OF 46

JBE PROJECT NO. 21090

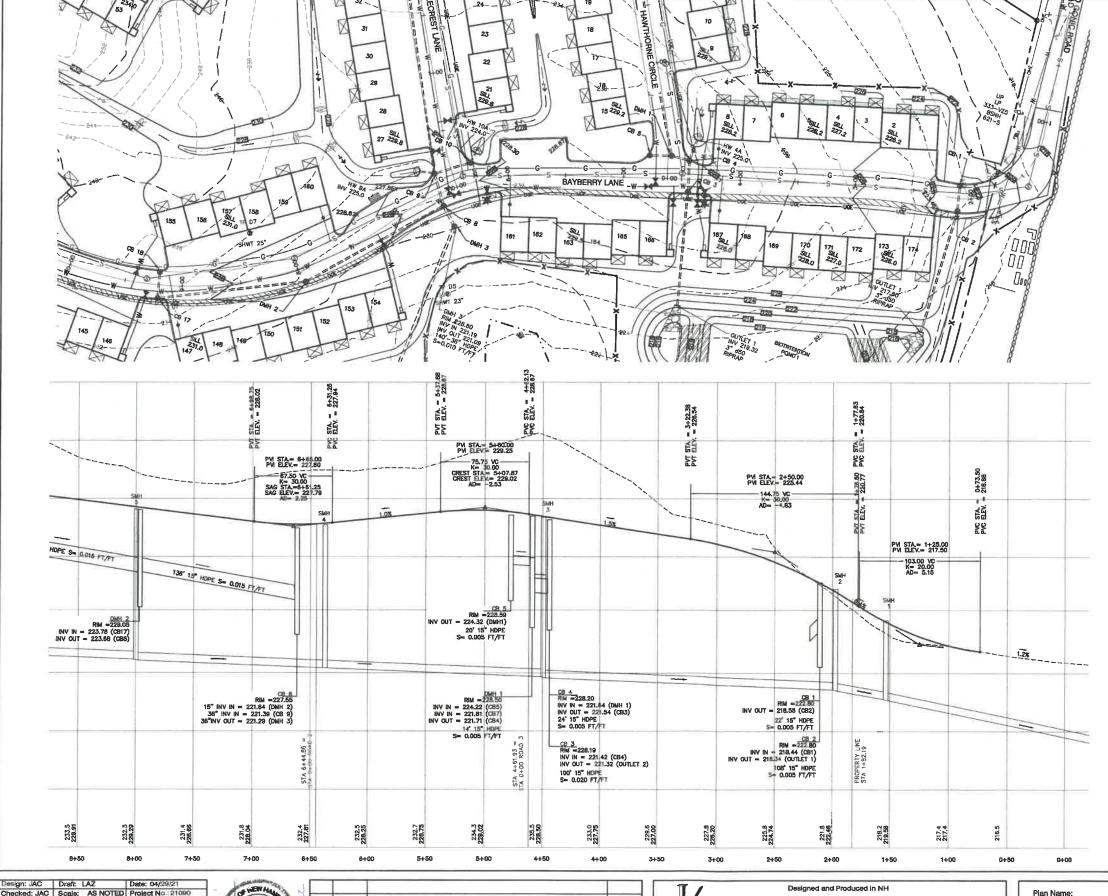

#### NOTES:

- 2. AS-BUILT PLANS TO BE SUBMITTED TO THE CITY PRIOR TO ACCEPTANCE OF THE ROADWAY.
- DEVELOPER IS RESPONSIBLE FOR COMPLYING WITH ALL APPLICABLE LOCAL, STATE AND FEDERAL WETLAND REGULATIONS, INCLUDING ANY PERMITTING AND SETBACK REQUIREMENTS REQUIRED UNDER THESE REGULATIONS.
- CONTRACTOR TO COORDINATE AND COMPLETE ALL WORK REQUIRED FOR THE RELOCATION AND/OR INSTALLATION OF ELECTRIC, CATV, TELEPHONE, AND FIRE ALARM PER UTILITY DESIGN AND STANDARDS. LOCATIONS SHOWN ARE APPROXIMATE. LOW PROFILE STRUCTURES SHALL BE USED TO THE GREATEST EXTENT POSSIBLE.
- THIS PLAN HAS BEEN PREPARED BY JONES & BEACH ENGINEERS, INC. FOR MUNICIPAL AND STATE APPROVALS AND FOR CONSTRUCTION BASED ON DATA OBTAINED FROM ON-STE FIELD SURVEY AND EXISTING MUNICIPAL RECORDS. THROUGHOUT THE CONSTRUCTION PROCESS, THE CONTRACTOR SHALL INFORM THE ENGINEER IMMEDIATELY OF ANY FIELD DISCREPANCY FROM DATA SHOWN ON THE DESIGN PLANS. THIS INCLUDES ANY UNFORESEEN CONDITIONS, SUBSURFACE OR OTHERWISE, FOR EVALUATION AND RECOMMENDATIONS. ANY CONTRADICTION BETWEEN ITEMS OF THIS PLAN/PLAN SET, OR SETIMEN THE PLANS AND ON-SITE CONDITIONS MUST BE RESOLVED BEFORE RELATED CONSTRUCTION HAS BEEN INITIATED.
- SILTATION AND EROSION CONTROLS SHALL BE INSTALLED PRIOR TO CONSTRUCTION, SHALL BE MAINTAINED DURING CONSTRUCTION, AND SHALL REMAIN UNTIL SITE HAS BEEN STRABILIZED WITH PERMANENT VEGETATION SEE DETAIL SHEET EI FOR ADDITIONAL NOTES ON EROSION CONTROL.
- ALL DISTURBED AREAS NOT STABILIZED BY NOVEMBER 1st SHALL BE COVERED WITH AN EROSION CONTROL BLANKET. PRODUCT TO BE SPECIFIED BY THE ENGINEER.
- FINAL DRAINAGE, GRADING AND EROSION PROTECTION MEASURES SHALL CONFORM TO REGULATIONS OF THE PUBLIC WORKS DEPARTMENT.
- 9. CONTRACTOR TO VERIFY EXISTING UTILITIES AND TO NOTIFY ENGINEER OF ANY DISCREPANCY (MMEDIATELY
- ROADWAY INTERSECTIONS WITH SLOPE GRANITE CURB SHALL EXTEND AROUND RADIUS WITH 6' STRAIGHT PIECE ALONG TANGENT.
- RETAINING WALLS SHALL BE DESIGNED AND STAMPED BY A LICENSED PROFESSIONAL ENGINEER CONTRACTOR SHALL COORDINATE WITH MANUFACTURER PRIOR TO INSTALLATION.
- 6" PERFORATED ADS UNDER DRAIN PLACEMENT TO BE DETERMINED BY THE ENGINEER DURBING TIME OF SUBGRADE INSPECTION, CONTRACTOR TO ADJUST LOCATION IN THE FIELD ONLY WITH PRIOR APPROVAL OF PROJECT ENGINEER OR PUBLIC WORKS DEPARTMENT.
- 13. ALL DRIVEWAYS TO BE CONSTRUCTED MAXIMUM 10% SLOPE. SEE DETAIL SHEET. ALL DRIVEWAYS TO HAVE CULVERTS UNLESS APPROVED BY THE CITY ROAD AGENT.
- 14. SIDEWALK TO BE INSTALLED AT TIME OF TOP COURSE PAYING ALONG WITH DRIVEWAY APRONS.
- DRAINAGE INSPECTION AND MAINTENANCE SCHEDULE: SILT FENCING WILL BE INSPECTED DURRING AND AFTER STORM EVENTS TO ENSURE THAT THE FENCE STILL HAS INTEGRITY AND IS NOT ALLOWING SEDMENT TO PASS. SEDMENT BUILD UP IN SWALES WILL BE REDVOED IF IT IS DEEPER THAN SX NOCHES, AND IS TO BE REMOVED FROM SUMPS BELOW THE INLET OF CULVERTS SEMIANIMALLY, AS WELL AS FROM CATCH BASINS FOLLOWING MAJOR STORM EVENTS, THE STAGE DISSANDANCE COULDE TSRUCTURES ARE TO BE INSPECTED AND ANY DEBRIS REMOVED PROM THE CRIPICE, TRASH TRACK AND EMERGENCY SAIL WAY. INFREQUENTLY, SEDIMENT MAY ALSO HAVE TO BE REMOVED FROM THE SUMP OF THE STRUCTURES.
- 17. DETENTION PONDS REQUIRE TIMELY MAINTENANCE AND SHOULD BE INSPECTED AFTER EVERY MAJOR STORM EVENT, AS WELL AS FREQUENTLY DURING THE FIRST YEAR OF OPERATION, AND ANNUALLY THEREAFTER. EVERY PIVE YEARS, THE SERVICES OF A PROFESSIONAL ENGINEER SHOULD BE RETAINED TO PERFORM A THOROUGH INSPECTION OF THE DETENTION POND AND ITS INFRASTRUCTURE. ANY DEBRIS AND SEDIMENT THOROUGH INSPECTION OF THE DETENTION POND AND ITS INFRASTRUCTURE. ANY DEBRIS AND SEDMENT ACCUMULATIONS SHOULD BE FREMOVED FROM THE OUTLET STRUCTURES, AND BEFRENCY SPLINAYS) AND DISPOSED OF PROPERLY. DETENTION POND BERMS SHOULD BE MOWED AT LEAST DAKE ANNUALLY SO AS DISPOSED OF PROPERLY. DETENTION POND BERMS SHOULD BE MOWED AT LEAST DAKE ANNUALLY SO AS THE PREVAIL THE ESTABLISHMENT OF WOODY VEGETATION. THESE SHOULD HEVER BE ALLOWED TO GROW ON A DETENTION POND BERM, AS THEY MAY DESTABLIZE THE STRUCTURE AND NOREASE THE POTENTIAL FOR FAILURE. AREAS SHOWING SIGNS OF BROSON OR THIN OR DYING VEGETATION SHOULD BE REPARED IMMEDIATELY BY WHATEVER MEANS NECESSARY, WITH THE EXCEPTION OF FERTILIZER, RODENT BORROWS SHOULD BE REPAIRED IMMEDIATELY AND THE ANIMALS SHOULD BE TRAPPED AND RELOCATED IF THE PROBLEM PERSISTS.
- THE DETENTION PONDS ARE TO BE CONSTRUCTED PRIMARILY THROUGH EXCAVATION. IN THOSE AREAS WHERE THE BERMS MUST BE CONSTRUCTED BY THE PLACEMENT OF FILL, THE ENTIRE EMBANGMENT AREA OF THE DETENTION PONDS SHALL BE EXCAVATED TO PROPOSED GRADE, STREPPED OF ALL ORGANIC MATERIAL. COMPACTED TO AT LEAST 95% AND SCAMPEDE PIOR TO THE PLACEMENT OF THE EMBANGMENT MATERIAL. IN THE EVENT THE FOURDATION MATERIAL EXPOSED DICES NOT ALLOW THE SPECIFED COMPACTION, AN ADDITIONAL ONE FOOT (17) OF EXCAVATION AND THE PLACEMENT OF A ONE FOOT (17) THE CAVANTION AND THE PLACEMENT OF A ONE FOOT (17) THE CAVANTION AND THE PLACEMENT OF A ONE FOOT (17) THE CAVANTION AND THE PLACEMENT OF A ONE FOOT (17) THE CAVANTION AND THE PLACEMENT OF A ONE FOOT (17) THICK, THEY FOOT (12) WHOE PLACE OF THE MATERIAL DESCRIBED IN THE NOTE BELOW, COMPACTED TO 95% OF ASTIM D-1557 MAY BE RICESSARY, PLACEMENT AND COMPACTION SHOULD DOCUR AT A MOSTURE CONTENT OF OPTIMUM PLUS OR MINUS 3%, AND NO FROZEN OR ORGANIC MATERIAL SHOULD BE PLACED WITHIN FOR ANY REASON.
- 19. EMBANKMENT MATERIAL FOR THE BERMS SHALL BE CLEAN MINERAL SOIL WITH A CLAY COMPONENT FREE OF ROOTS, ORGANIC MATTER, AND OTHER DELETERIOUS SUBSTANCES, AND SHALL CONTAIN NO ROCKS OR LUMPS OVER FOUR INCHES (4") IN DIAMETER. THIS MATERIAL SHOULD BE INSTALLED IN 6" LIFTS AND COMPACTED TO 95% OS ASTM 0-1557, AND SHOULD MEET THE FOLLOWING SPECIFICATIONS: 4" PASSING 100%, §4 SIEVE 25-70%, §200 SIEVE 10-29% (IN TOTAL SAMPLE).
- 20. EMBANKMENT IS TO HAVE 3:1 SIDE SLOPES (MAX.) AND IS TO BE BROUGHT TO SPECIFIED GRADES PRIOR TO THE ADDITION OF LOAM (4" MINIMUM) SO AS TO ALLOW FOR THE COMPACTION OF THE STRUCTURE OVER TIME WHILE MAINTAINING THE PROPER BERN ELEVATION.
- 21. COMPACTION TESTING SERVICES (I.E. NUCLEAR DENSITY TESTS) ARE TO BE PERFORMED BY AN INDEPENDENT GEOTECHNICAL ENGINEER RETAINED BY THE CONTRACTOR FOR ROADWAY CONSTRUCTION, AND ON THE FOUNDATION OF THE BERM AND ON EVERY UIF OF NEWLY PLACED MATERIAL.
- 22. SLOPED GRANITE CURB TO BE TIPPED DOWN AT ALL DRIVEWAY ENTRANCES BY THE CONTRACTOR

GRAPHIC SCALE ( IN FEET ) 1 inch = 40 ft Horiz. 1 inch = 4 ft Vert.

**BAYBERRY LANE** 

Checked: JAC Scale; AS NOTED Project No.: 21090 Drawing Name: 21090-PLAN.dwg THIS PLAN SHALL NOT BE MODIFIED WITHOUT WRITTEN ERMISSION FROM JONES & BEACH ENGINEERS, INC. (JBE). ANY ALTERATIONS, AUTHORIZED OR OTHERWISE, SHALL BE

AT THE USER'S SOLE RISK AND WITHOUT LIABILITY TO JBE.

	WEN SEA	Ph.
1	MICHAEL	11
	J. KERIVAN No. 9848	
30	COENSED	200


1	1/18/22	REVISED PER CITY COMMENTS	LAZ
0	11/23/21	ISSUED FOR REVIEW	LAZ
REV.	DATE	REVISION	BY

#### Designed and Produced in NH B Jones & Beach Engineers, Inc. 85 Portsmouth Ave. Civil Engineering Services


Project: FAX: 603-772-0227 E-MAIL: JBE@JONESANDBEACH.COM

PLAN AND PROFILE BAYBERRY COMMONS 19 OLD GONIC ROAD, ROCHESTER, NH LEO P. LACOUTURE REV. TRUST & WILLIAN B. LACOUTURE 19 OLD GONIC RD., ROCHESTER, NH 03867 BK 4093 PG 148

SHEET 24 OF 48 JBE PROJECT NO.21090

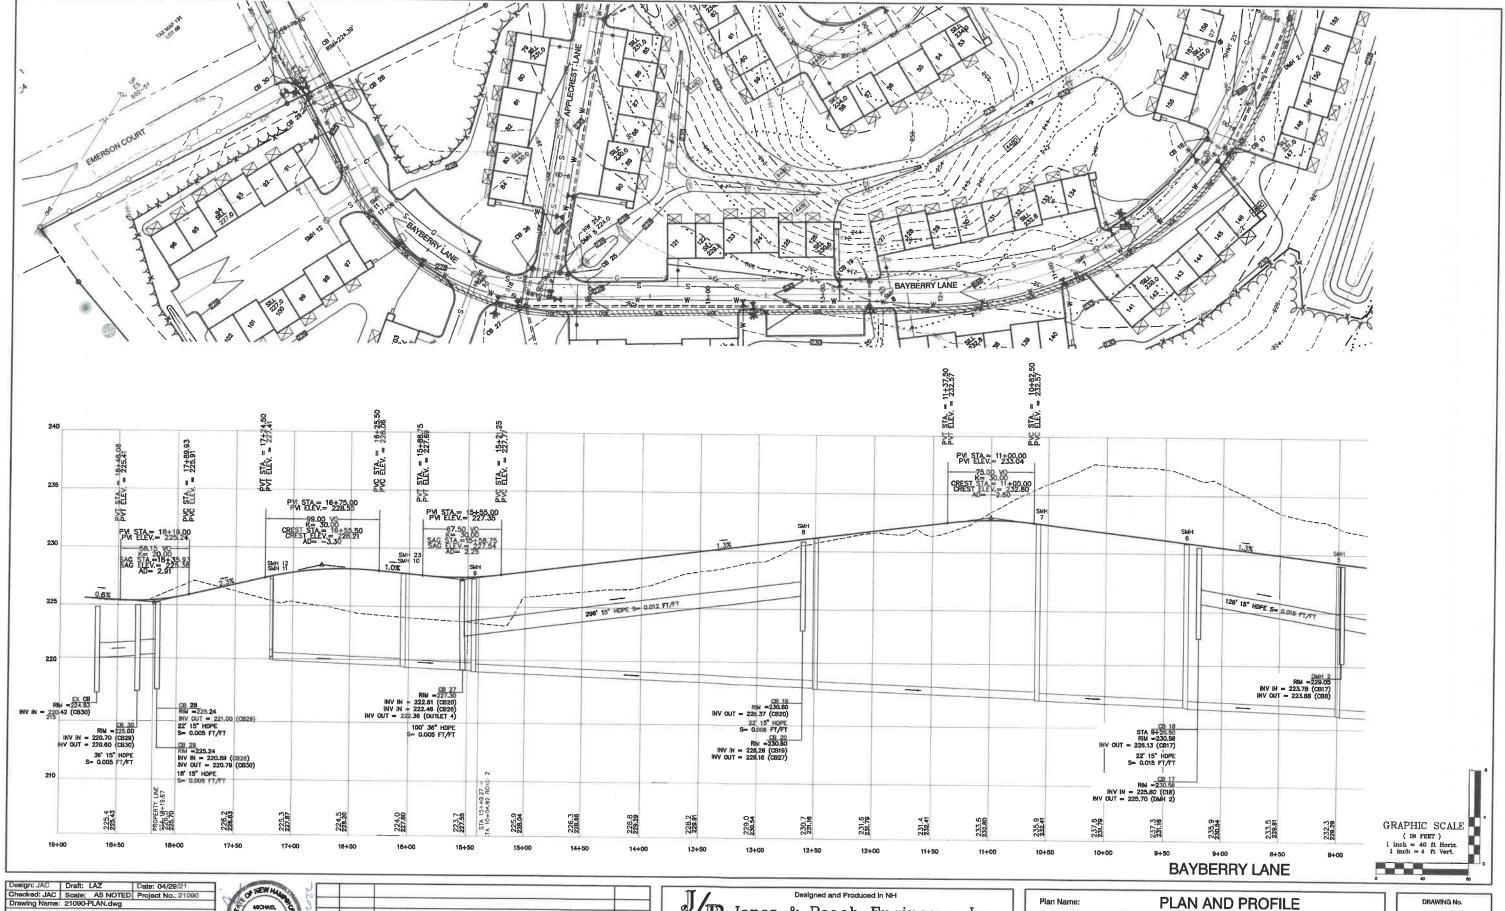

Checked: JAC Soale: AS NOTED Project No.: 21090
Drawing Name: 21090-PLAN.dwg
THIS PLAN SHALL NOT BE MODIFIED WITHOUT WRITTEN
PERMISSION FROM JONES & BEACH ENGINEERS, INC. (JBE).
ANY ALTERATIONS, AUTHORIZED OR OTHERWISE, SHALL BE
AT THE USERS SOLE RISK AND WITHOUT LIABILITY TO JBE.

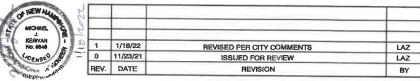


Jones & Beach Engineers, Inc.

85 Portsmouth Ave. PO Box 219 Stratham, NH 03885 Civil Engineering Services 603-772-4746 FAX: 603-772-0227 E-MAIL: JBE@JONESANDBEACH.COM

Plan Name:	PLAN AND PROFILE
Project:	BAYBERRY COMMONS 19 OLD GONIC ROAD, ROCHESTER, NH
Owner of Record:	LEO P. LACOUTURE REV. TRUST & WILLIAN B. LACOUTURE 19 OLD GONIC RD., ROCHESTER, NH 03867 BK 4093 PG 148

P2
SHEET 25 OF 46
JBE PROJECT NO.21090

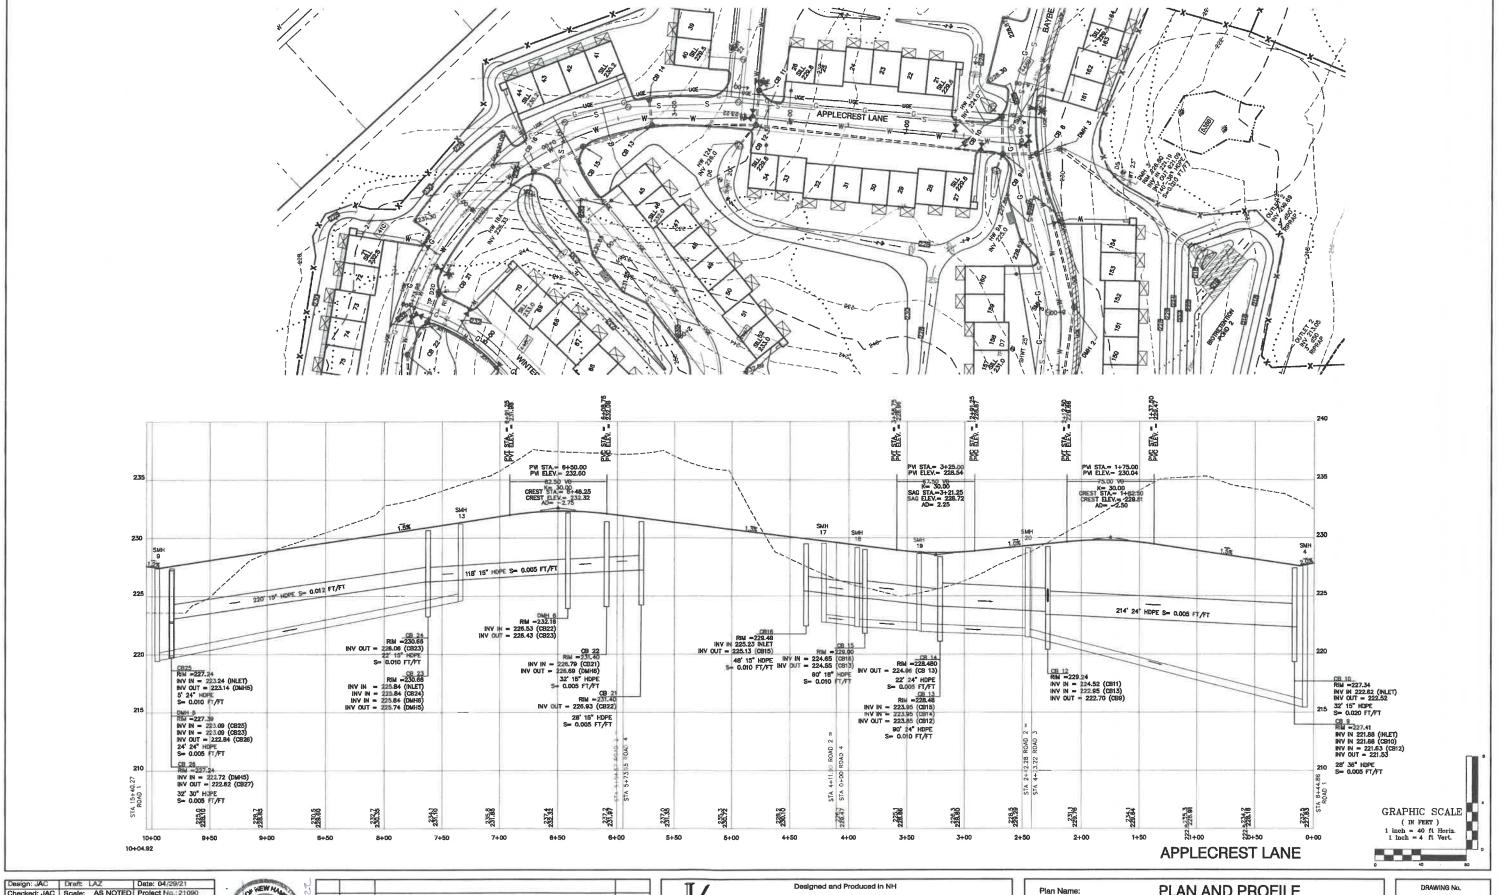

Design: JAC Draft: LAZ Date: 04/29/21
Checked: JAC Scale: AS NOTED Project No.: 21090
Drawing Name: 21090-PLAN.dwg
THIS PLAN SHALL NOT BE MODIFIED WITHOUT WRITTEN
PERMISSION FROM JONES & BEACH ENGINEERS, INC. (JBE).
ANY ALTERATIONS, AUTHORIZED OR OTHERWISE, SHALL BE
AT THE USER'S SOLE RISK AND WITHOUT LIABILITY TO JBE.



1	1/18/22	REVISED PER CITY COMMENTS	LAZ
0	11/23/21	ISSUED FOR REVIEW	LAZ
REV.	DATE	REVISION	BY

B Jones & Beach Engineers, Inc.

85 Portsmouth Ave. PO Box 219
Strathem, NH 03886

Designed and Produced in NH


Reach Engineers, Inc.

603-772-4746
FAX: 603-772-4720227


E-MAIL: JBE@JONESANDESANDESACH.COM

Plan Name:	PLAN AND PROFILE
Project:	BAYBERRY COMMONS 19 OLD GONIC ROAD, ROCHESTER, NH
Owner of Record:	LEO P. LACOUTURE REV. TRUST & WILLIAN B. LACOUTURE

P3
SHEET 26 OF 46
JBE PROJECT NO. 21090

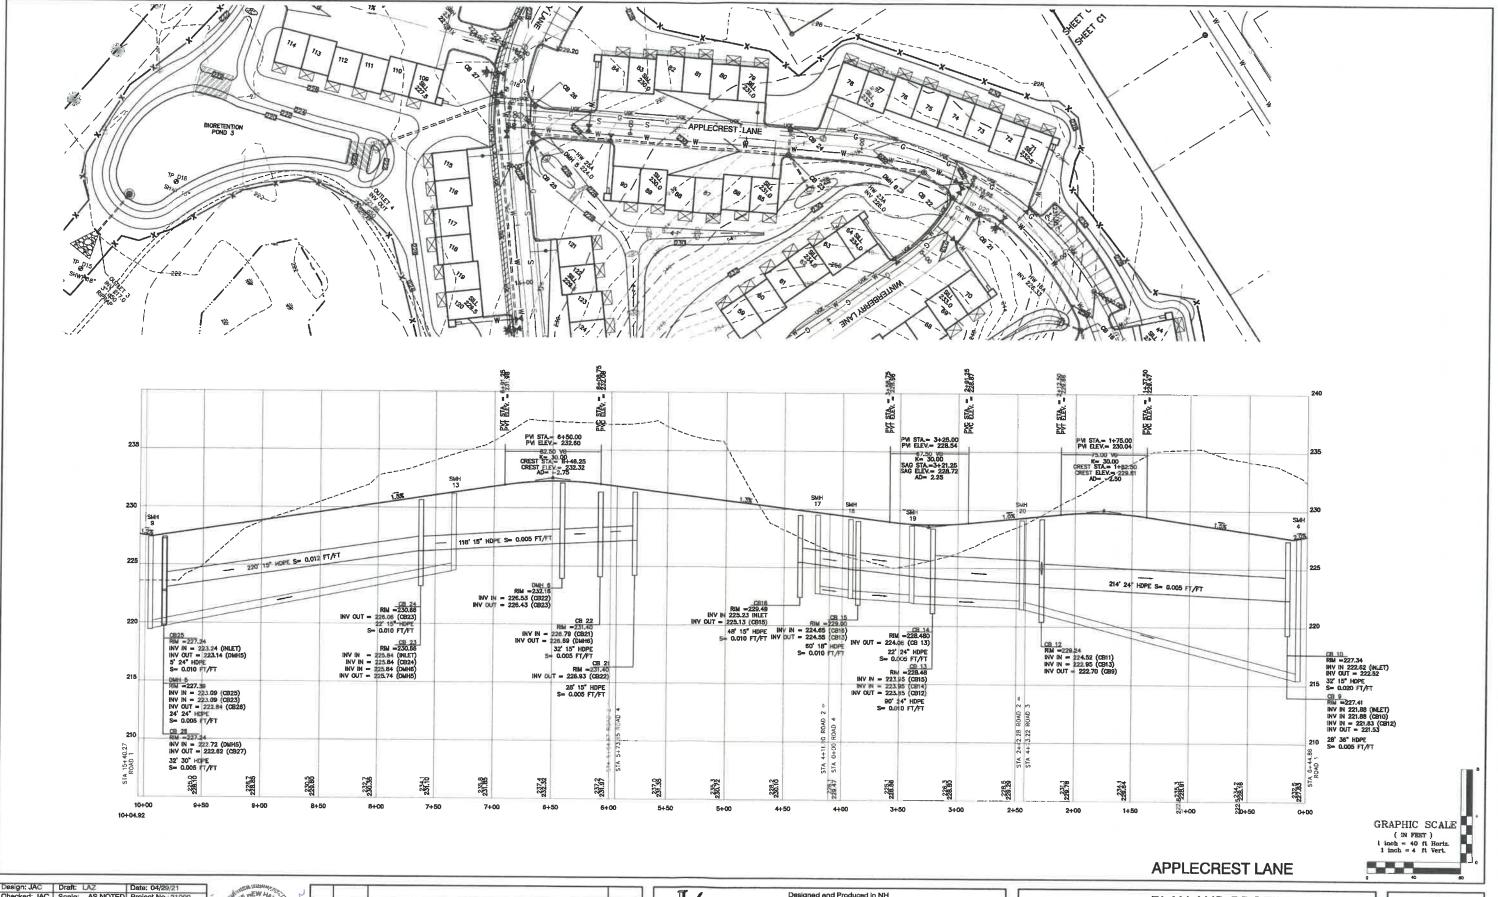

Design: JAC Draft: LAZ Date: 04/29/21
Checked: JAC Scale: AS NOTED Project No.: 21090
Drawing Name: 21090-PLAN.dwg
THIS PLAN SHALL NOT BE MODIFIED WITHOUT WRITTEN
PERMISSION FROM JONES & BEACH ENGINEERS, INC. (JBE).
ANY ALTERATIONS, AUTHORIZED OR OTHERWISE, SHALL BE
AT THE USER'S SOLE RISK AND WITHOUT LIABILITY TO JBE.

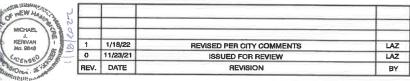


Designed and Produced in NH


Jones & Beach Engineers, Inc.

85 Portsmouth Ave. PO 8ox 219 Stratham, NH 03885	Civil	Engineering	603-772-4746 FAX: 603-772-0227 DNESANDBEACH.COM

5 8			
	Plan Name:	PLAN AND PROFILE	
	Project:	BAYBERRY COMMONS 19 OLD GONIC ROAD, ROCHESTER, NH	
	Owner of Record:	LEO P. LACOUTURE REV. TRUST & WILLIAN B. LACOUTURE 19 OLD GONIC RD., ROCHESTER, NH 03867 BK 4093 PG 148	



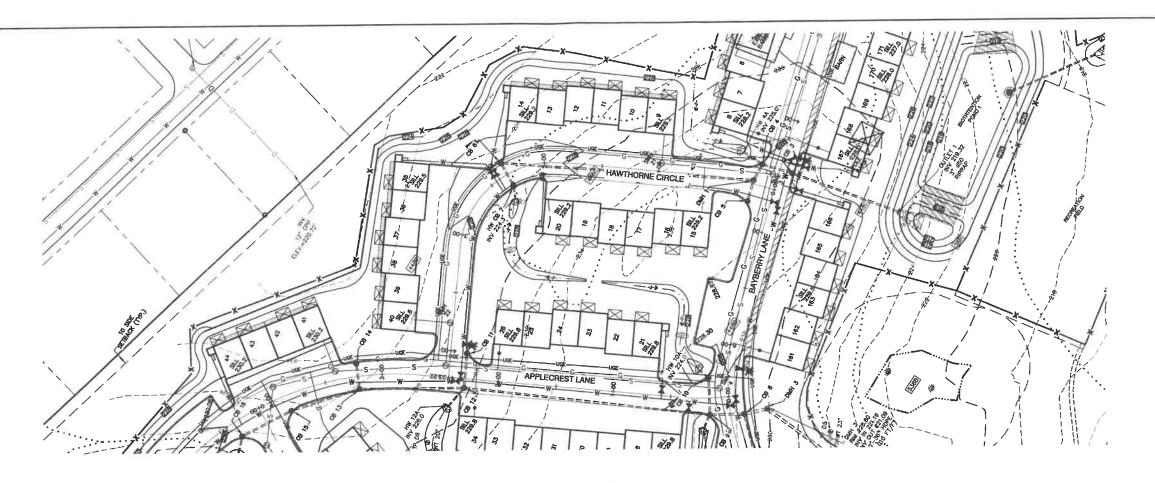

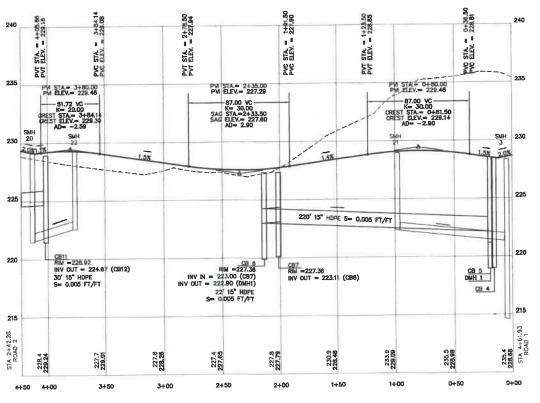

GRAPHIC SCALE
(IN FEET)
1 inch = 40 ft Hortz.
1 inch = 4 ft Vert.

#### HAWTHORNE CIRCLE

 Design: JAC
 Draft: LAZ
 Date: 04/29/21

 Checked: JAC
 Scale: AS NOTED
 Project No.: 21080

 Drawing Name: 21090-PLAN.dwg

THIS PLAN SHALL NOT BE MODIFIED WITHOUT WRITTEN PERMISSION FROM JONES & BEACH ENGINEERS, INC. (JBE). ANY ALTERATIONS, AUTHORIZED OR OTHERWISE, SHALL BE AT THE USER'S SOLE RISK AND WITHOUT LUBILITY TO JBE.



_	1/18/22	REVISED PER CITY COMMENTS	LAZ
0	11/23/21	ISSUED FOR REVIEW	LAZ
REV.	DATE	REVISION	BY

Designed and Produced in NH

Jones & Beach Engineers, Inc.

55 Bottomouth Ave. Civil Engineering Services 603-772-4748

B5 Portsmouth Ave. Civil Engineering Services
PO Box 219
Stratham, NH 03885


Services 603-772-4748 FAX: 803-772-0227 E-MAIL: JBE@JONESANDBEACH.COM


Plan Name:	PLAN AND PROFILE
	BAYBERRY COMMONS

Project: 19 OLD GONIC ROAD, ROCHESTER, NH

Owner of Record: LEO P. LACOUTURE REV. TRUST & WILLIAN B. LACOUTURE 19 OLD GONIC RD., ROCHESTER, NH 03867 BK 4093 PG 148

P5
SHEET 28 OF 46
JBE PROJECT NO. 21090

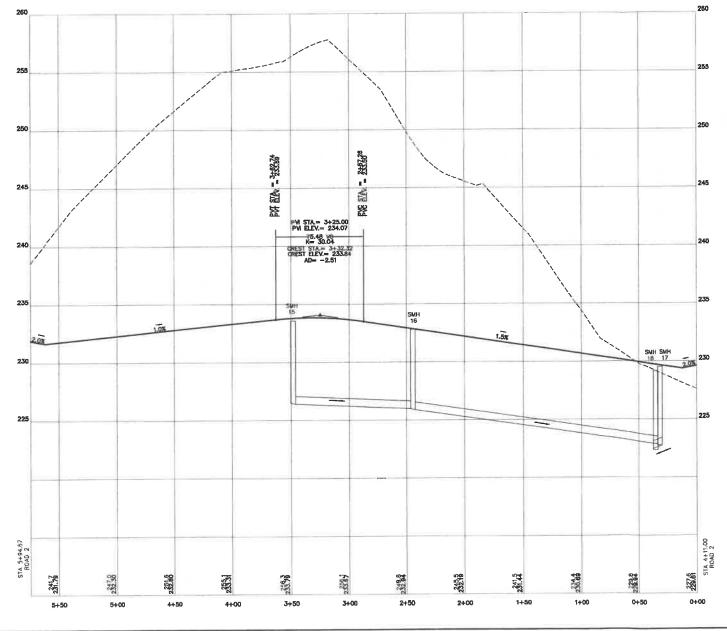

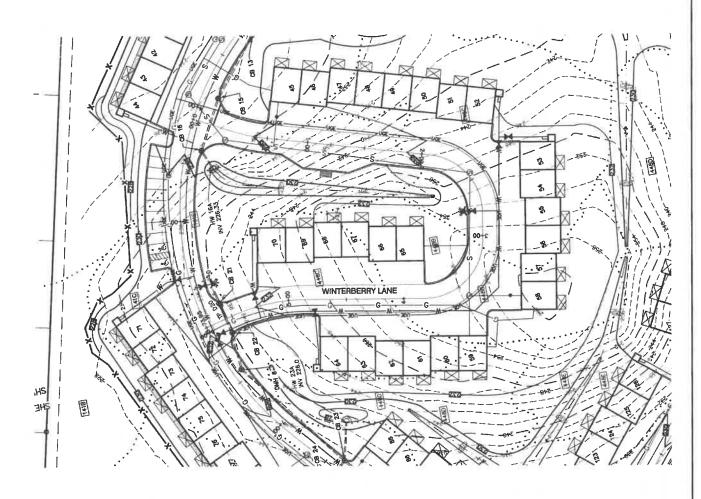

GRAPHIC SCALE ( IN FEET )

1 inch = 40 ft Horiz.
1 inch = 4 ft Vert.

WINTERBERRY LANE

Design: JAC Draft: LAZ Date: 04/29/21
Checked: JAC Scale: AS NOTED Project No.: 21090
Drawing Name: 21090-PLAN.dwg THIS PLAN SHALL NOT BE MODIFIED WITHOUT WRITTEN

PERMISSION FROM JONES & BEACH ENGINEERS, INC. (JBE). ANY ALTERATIONS, AUTHORIZED OR OTHERWISE, SHALL BE AT THE USER'S SOLE RISK AND WITHOUT LIABILITY TO JBE.

J.	SEW AL	ال جود
A.	MICHAEL	113
1	No. 9648	0
300	ENING C	WHITH BYEN

2		1411-1411	
0 1	1/18/22	REVISED PER CITY COMMENTS	LAZ
0	11/23/21	ISSUED FOR REVIEW	LAZ
REV	. DATE	REVISION	BY


Designed and Produced in NH B Jones & Beach Engineers, Inc.

85 Portsmouth Ave. Civil Engineering Services
PO Box 219
Stratham, NH 03885
E-MAIL: JBE@. Services 603-772-4746 FAX: 603-772-0227 E-MAIL: JBE@JONESANDBEACH.COM

Plan Name:	PLAN AND PROFILE
Project:	BAYBERRY COMMONS

BAYBERRY COMMONS 19 OLD GONIC ROAD, ROCHESTER, NH LEO P. LACOUTURE REV. TRUST & WILLIAN B. LACOUTURE 19 OLD GONIC RD., ROCHESTER, NH 03867 BK 4093 PG 148 Owner of Record:

DRAWING No. **P6** 

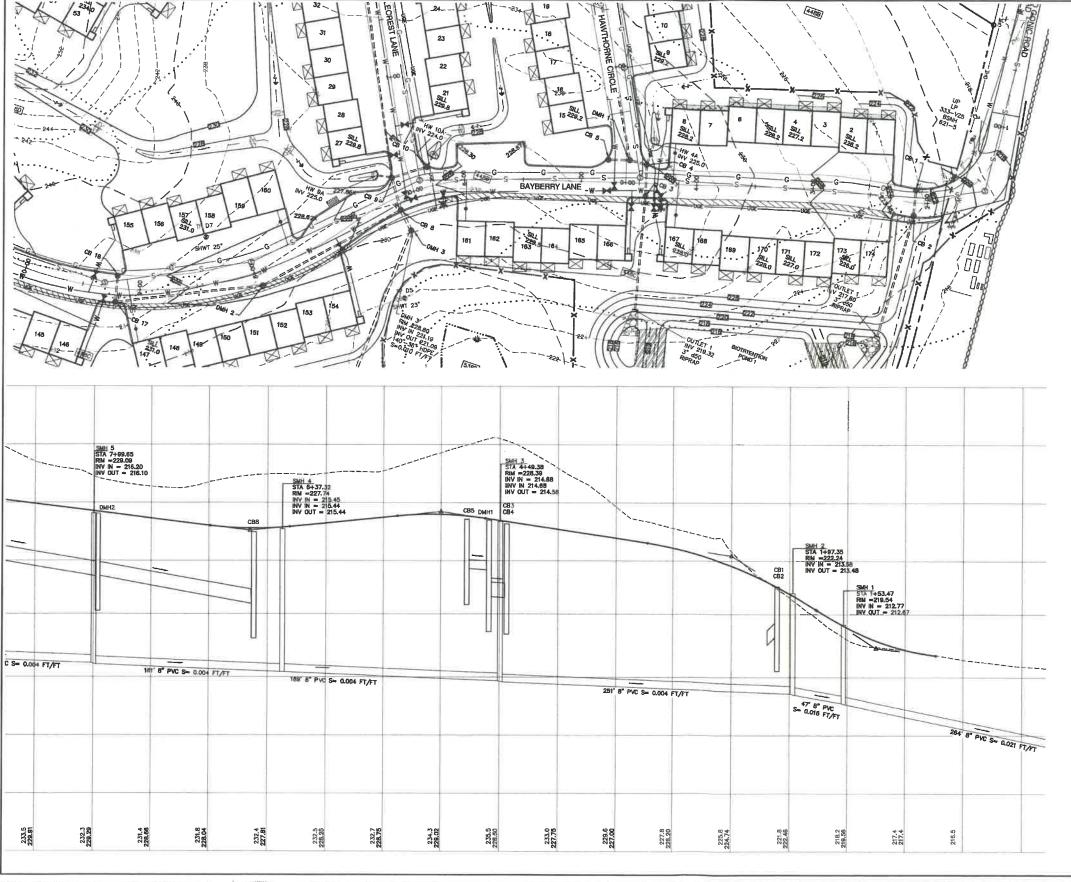

GRAPHIC SCALE
(IN FEET)
1 inch = 40 ft Horiz
1 inch = 4 ft Vert.

**BAYBERRY LANE** 

Design: JAC Draft: LAZ Date: 04/29/21
Checked: JAC Scale: AS NOTED Project No.: 21090
Drawing Name: 21090-PLAN.dwg
THIS PLAN SHALL NOT BE MODIFIED WITHOUT WRITTEN

THIS PLAN SHALL NOT BE MODIFIED WITHOUT WRITTEN PERMISSION FROM JONES & BEACH ENGINEERS, INC. (JIBE). ANY ALTERATIONS, AUTHORIZED OR OTHERWISE, SHALL BE AT THE USER'S SOLE RISK AND WITHOUT LIABILITY TO JBE.

d	OF REW HALL	
4	MICHAEL	
4	No. 9649	1
1	ICENSEO CONTRACTOR	RI

1	1/18/22	REVISED PER CITY COMMENTS	LAZ
0	11/23/21	ISSUED FOR REVIEW	LAZ
REV.	DATE	REVISION	BY

11			signed and Prod		
	Jones	80	Beach	Engineers,	Inc.
OF Contaments A	02-21	<i>E</i> 7		G	19.772.4748

35 Portsmouth Ave.	Cinnil	Engineering	Somices	603-772-4746
PO Box 219	00000	Dieg tracer trug	Der 0 0003	FAX: 603-772-0227
Stratham, NH 03885			E-MAIL: JBE@	JONESANDBEACH.COM


Plan Name:	SEWER PLAN AND PROFILE
Project:	BAYBERRY COMMONS 19 OLD GONIC ROAD, ROCHESTER, NH
Owner of Record:	LEO P. LACOUTURE REV. TRUST & WILLIAN B. LACOUTURE 19 OLD GONIC RD., ROCHESTER, NH 03867 BK 4093 PG 148

DRAWING No.

P7

SHEET SO OF 48

JBE PROJECT NO.21090

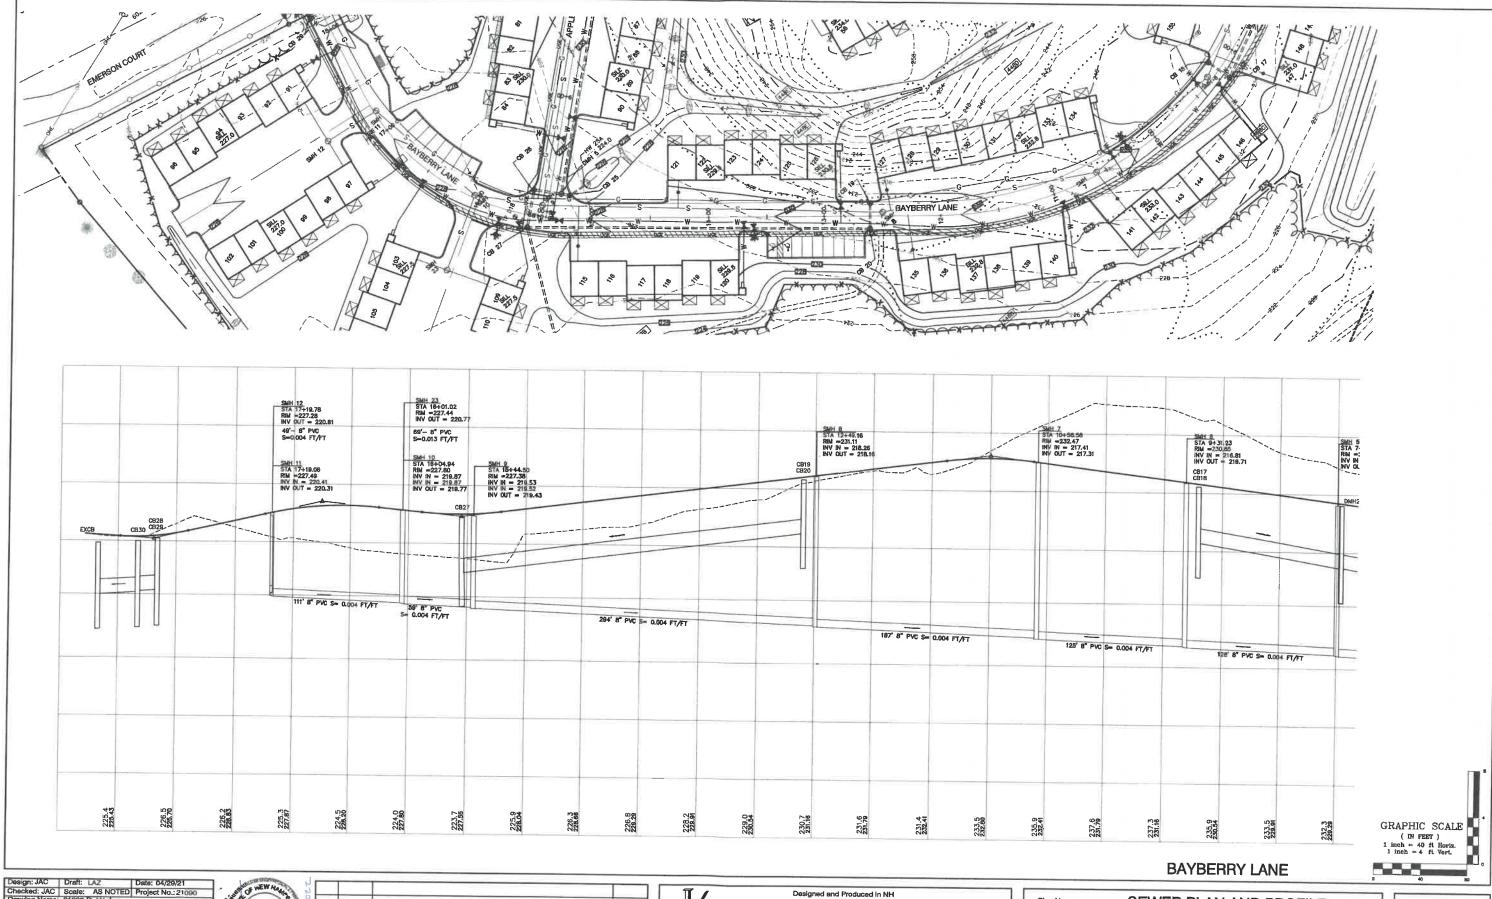

Design: JAC Draft: LAZ Date: 04/29/21
Checked: JAC Scale: AS NOTED Project No.: 21090
Drawing Name: 21090-PLANL-dwg
THIS PLAN SHALL NOT BE MODIFIED WITHOUT WRITTEN
PERMISSION FROM JONES & BEACH ENGINEERS, INC. (JBE),
ANY ALTERATIONS, AUTHORIZED OR OTHERWISE, SHALL BE

AT THE USER'S SOLE RISK AND WITHOUT LIABILITY TO JBE.



-			
1	1/18/22	REVISED PER CITY COMMENTS	LAZ
0	11/23/21	ISSUED FOR REVIEW	LAZ
REV.	DATE	REVISION	BY

Designed and Produced in NH


Jones & Beach Engineers, Inc.


85 Portsmouth Ave. Civil Engineering Semulates 803-772-4748

85 Portsmouth Ave. Civil Engineering Services 603-772-4748
PO Box 219
Stratham, NH 03885 E-MAIL: JBE@JONESANDBEACH.COM


Plan Name:	SEWER PLAN AND PROFILE
Project:	BAYBERRY COMMONS 19 OLD GONIC ROAD, ROCHESTER, NH
Owner of Record:	LEO P. LACOUTURE REV. TRUST & WILLIAN B. LACOUTURE 19 OLD GONIC RD., ROCHESTER, NH 03867 BK 4093 PG 144

P8
SHEET 31 OF 46
JBE PROJECT NO. 21090

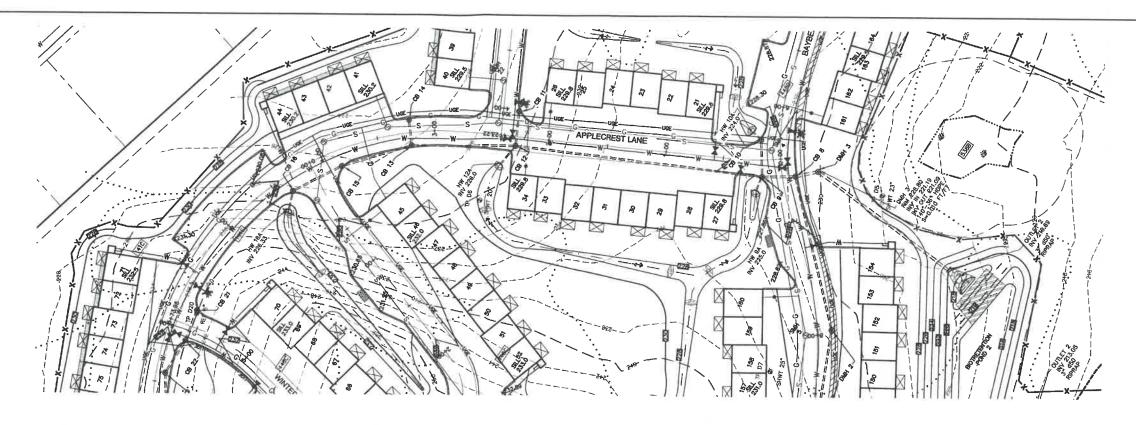

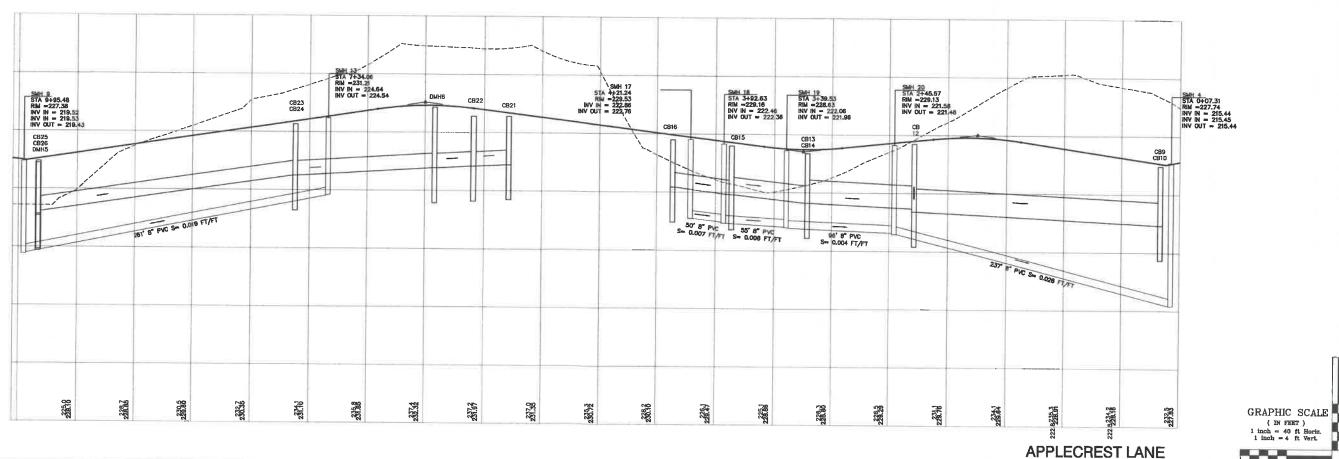

Design: JAC Draft: LAZ Date: 04/29/21
Checked: JAC Scale: AS NOTED Project No.: 21090
Drawing Name: 21090-PLAN.dwg
THIS PLAN SHALL NOT BE MODIFIED WITHOUT WRITTEN
PERMISSION FROM JONES & BEACH ENGINEERS, INC. (JBE).
ANY ALTERATIONS, AUTHORIZED OR OTHERWISE, SHALL BE
AT THE USER'S SOLE RISK AND WITHOUT LIABILITY TO JBE.

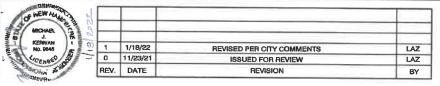


Jones & Beach Engineers, Inc.

85 Portsmouth Ave. Civil Engineering Services 603-772-4746
PO Box 219 FAX: 603-772-0227
Stratham, NH 03885 E-MAIL: JBE@JONESANDBEACH.COM

Plan Name;	SEWER PLAN AND PROFILE		
Project:	BAYBERRY COMMONS 19 OLD GONIC ROAD, ROCHESTER, NH		
Owner of Record:	LEO P. LACOUTURE REV. TRUST & WILLIAN B. LACOUTURE 19 OLD GONIC RD., ROCHESTER, NH 03867 BK 4093 PG 148		

P9
SHEET 32 OF 48
JBE PROJECT NO. 21090

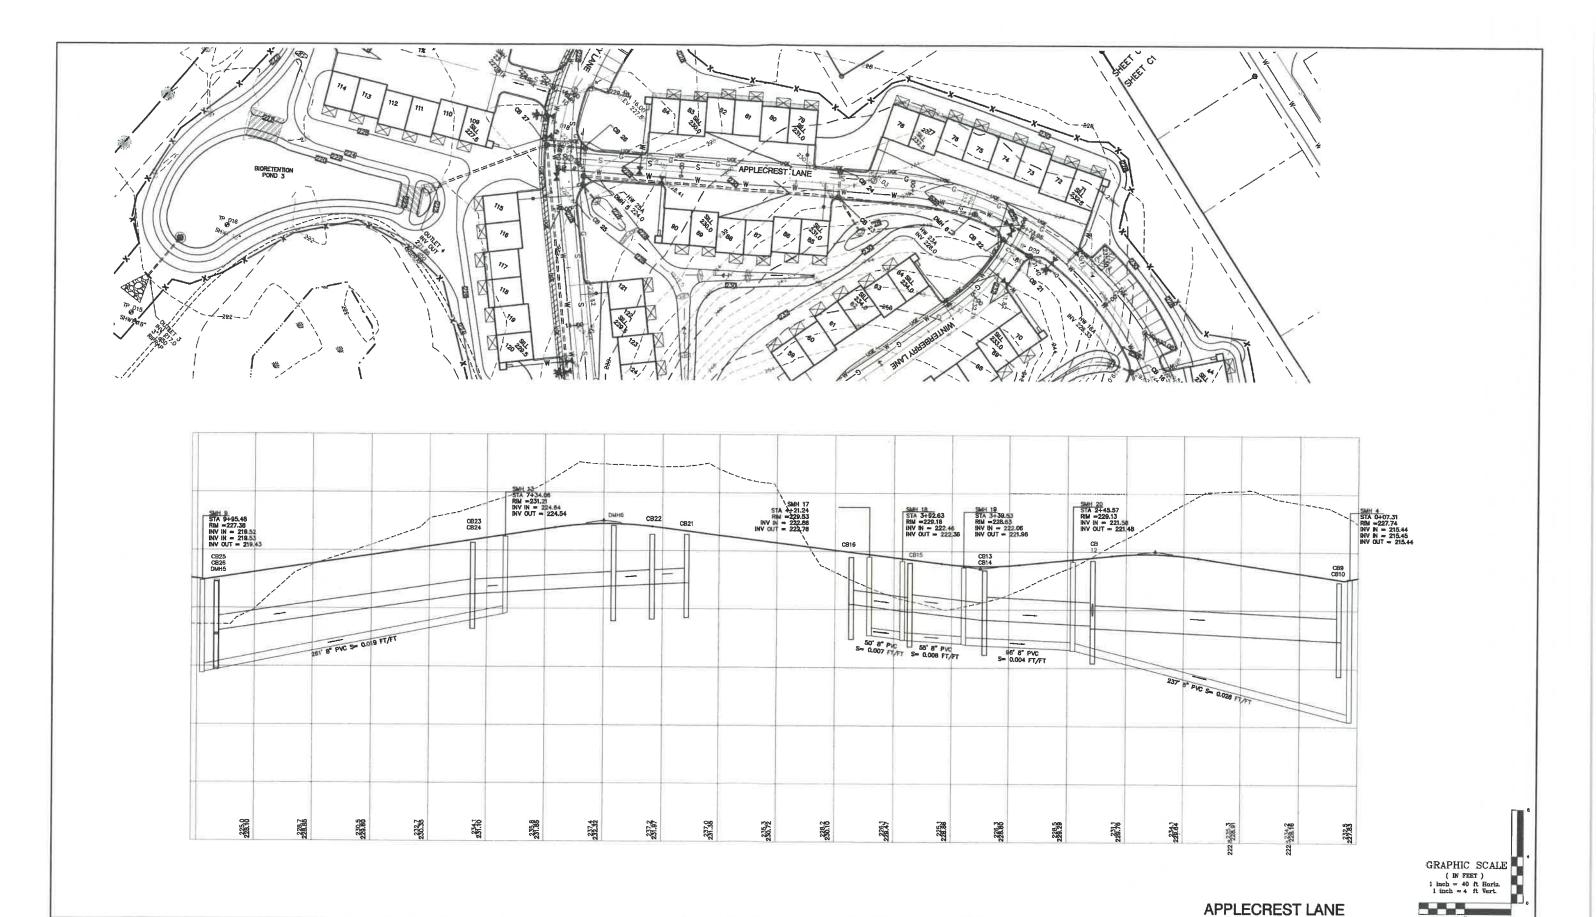

Design: JAC Draft: LAZ Date: 04/29/21
Checked: JAC Scale: AS NOTED Project No.:21090
Drawing Name: 21090-PLAN.dwg
THIS PLAN SHALL NOT BE MODIFIED WITHOUT WRITTEN
PERMISSION FROM JONES & BEACH ENGINEERS, INC. (JBE).
ANY ALTERATIONS, AUTHORIZED OR OTHERWISE, SHALL BE
AT THE USER'S SOLE RISK AND WITHOUT LIABILITY TO JBE.



1	_	<del>                                     </del>		
)[	1	1/18/22	REVISED PER CITY COMMENTS	LAZ
	0	11/23/21	ISSUED FOR REVIEW	LA2
1	REV.	DATE	REVISION	BY

Designed and Produced In NH

Jones & Beach Engineers, Inc.

85 Portsmouth Ave. PO Box 219
Stratham, NH 03885


Designed and Produced In NH


Engineers, Inc.

803-772-4748
FAX: 603-772-0227
FAX: 603-772-0227
E-MAIL: JBE@JONESANDBEAGH.COM

Plan Name:	PLAN AND PROFILE	
Project:	BAYBERRY COMMONS 19 OLD GONIC ROAD, ROCHESTER, NH	
Owner of Record:	LEO P. LACOUTURE REV. TRUST & WILLIAN B. LACOUTURE 19 OLD GONIC RD., ROCHESTER, NH 03867 BK 4093 PG 14	

P10
SHEET SS OF 46
JBE PROJECT NO. 21080

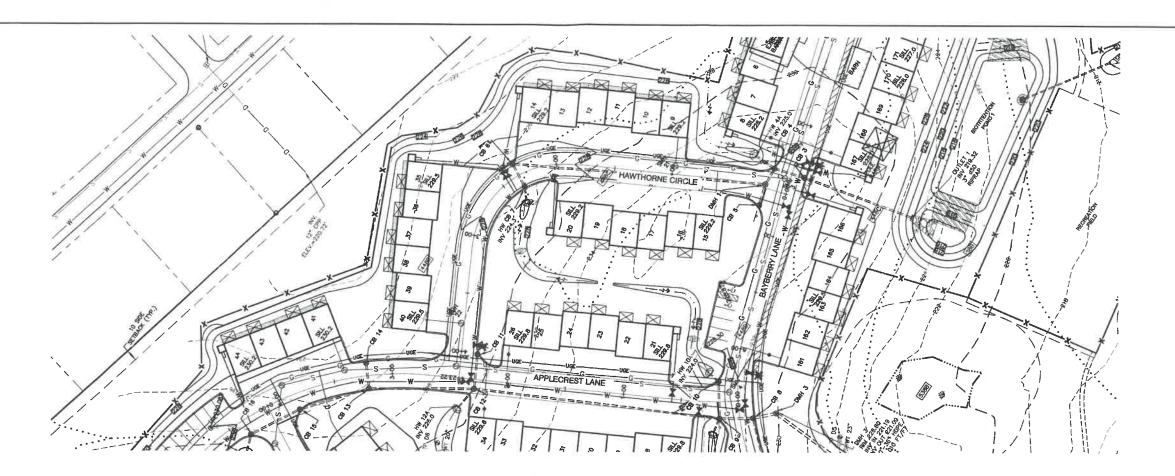

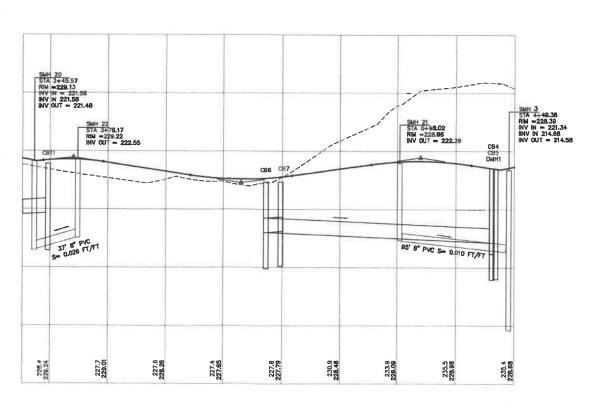

GRAPHIC SCALE
(IN FEET)
1 inch = 40 ft Horiz.
1 inch = 4 ft Vert.

## HAWTHORNE CIRCLE

Liesign, and	DIAIL DAZ	Date: 04/29/21
Checked: JAC	Scale: AS NOTED	Project No.: 21090
Drawing Name:	21090-PLAN.dwg	
THIS PLAN SHALL	NOT BE MODIFIED WIT	HOUT WRITTEN
PERMISSION FRO	M JONES & BEACH ENG	SINEERS, INC. (JBE).
ANY ALTERATION	S, AUTHORIZED OR OTH	HERWISE, SHALL BE
	OLE RISK AND WITHOUT	



1	1/18/22	REVISED PER CITY COMMENTS	LAZ
0	11/23/21	ISSUED FOR REVIEW	LAZ
REV.	DATE	REVISION	BY

Designed and Produced In NH

Jones & Beach Engineers, Inc.

85 Portsmouth Ave. PO Box 21:9
Strethan, NH 03885

Designed and Produced In NH

Beach Engineers, Inc.

603-772-4746
FAX: 603-772-0227
FAX: 603-772-0227
E-MAIL: JBE@JONESANDBEACH.COM


Plan Name:	SEWER PLAN AND PROFILE
Project:	BAYBERRY COMMONS 19 OLD GONIC ROAD, ROCHESTER, NH
Owner of Record:	LEO P. LACOUTURE REV. TRUST & WILLIAN B. LACOUTURE 19 OLD GONIC RD., ROCHESTER, NH 03867 BK 4093 PG 148


DRAWING No.

P11

SHEET 34 OF 48

JBE PROJECT NO. 21090

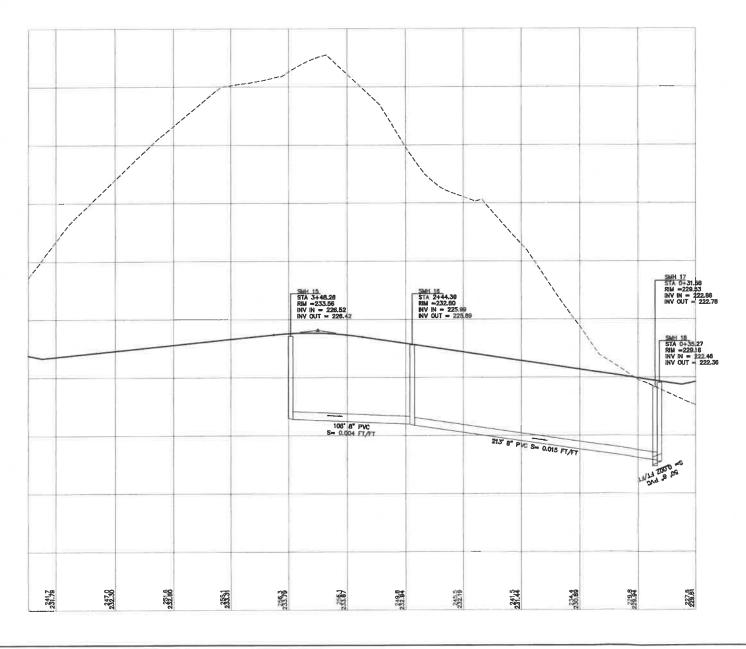

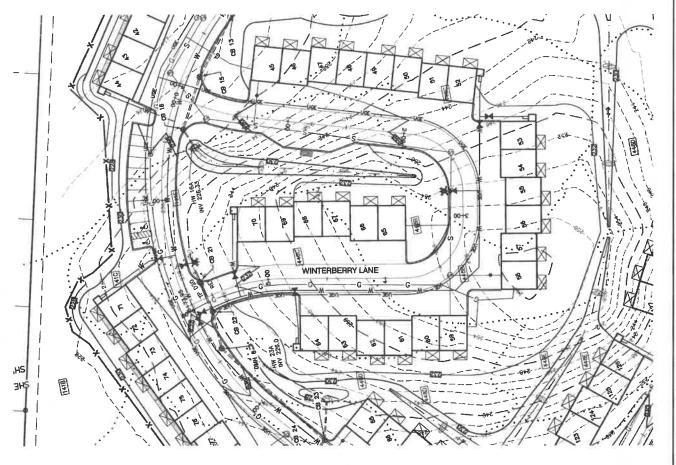

GRAPHIC SCALE
(IN FEET)
1 inch = 40 ft Horiz.
1 inch = 4 ft Vert.

WINTERBERRY LANE

Design: JAC	Draft: LAZ	Date: 04/29/21
Checked: JAC	Scale: AS NOTED 21090-PLAN.dwg	Project No.: 21090
Drawing Name	21090-PLAN.dwg	

PERMISSION FROM JONES & BEACH ENGINEERS, INC. (JBE).
ANY ALTERATIONS, AUTHORIZED OR OTHERWISE, SHALL BE
AT THE USER'S SOLE RISK AND WITHOUT LIABILITY TO JBE.



	1/18/22	REVISED PER CITY COMMENTS	LAZ
0	11/23/21	ISSUED FOR REVIEW	LAZ
REV.	DATE	REVISION	BY

Designed and Produced in NH Designed and Produced in NH

Jones & Beach Engineers, Inc.

85 Portsmouth Ave. PO Box 219
Stratham, NH 03885

Designed and Produced in NH


Beach Engineers, Inc.

603-772-4746
FAX: 603-772-40227
E-MAIL: JBE@JONESANDBEACH.COM


rtsmouth Ave.	Canal	Engineering	Samiros	603-772-4746
ox 219	CLUED	Dieg viveer vieg	Delogoes	FAX: 603-772-0227
nam, NH 03885			E-MAIL: JBE@J	ONESANDBEACH.COM

Plan Name:	SEWER PLAN AND PROFILE
Project:	BAYBERRY COMMONS 19 OLD GONIC ROAD, ROCHESTER, NH
Owner of Record:	LEO P. LACOUTURE REV. TRUST & WILLIAN B. LACOUTURE 19 OLD GONIC RD., ROCHESTER, NH 03867 BK 4093 PG 148

SHEET 35 OF 46 JBE PROJECT NO.21090

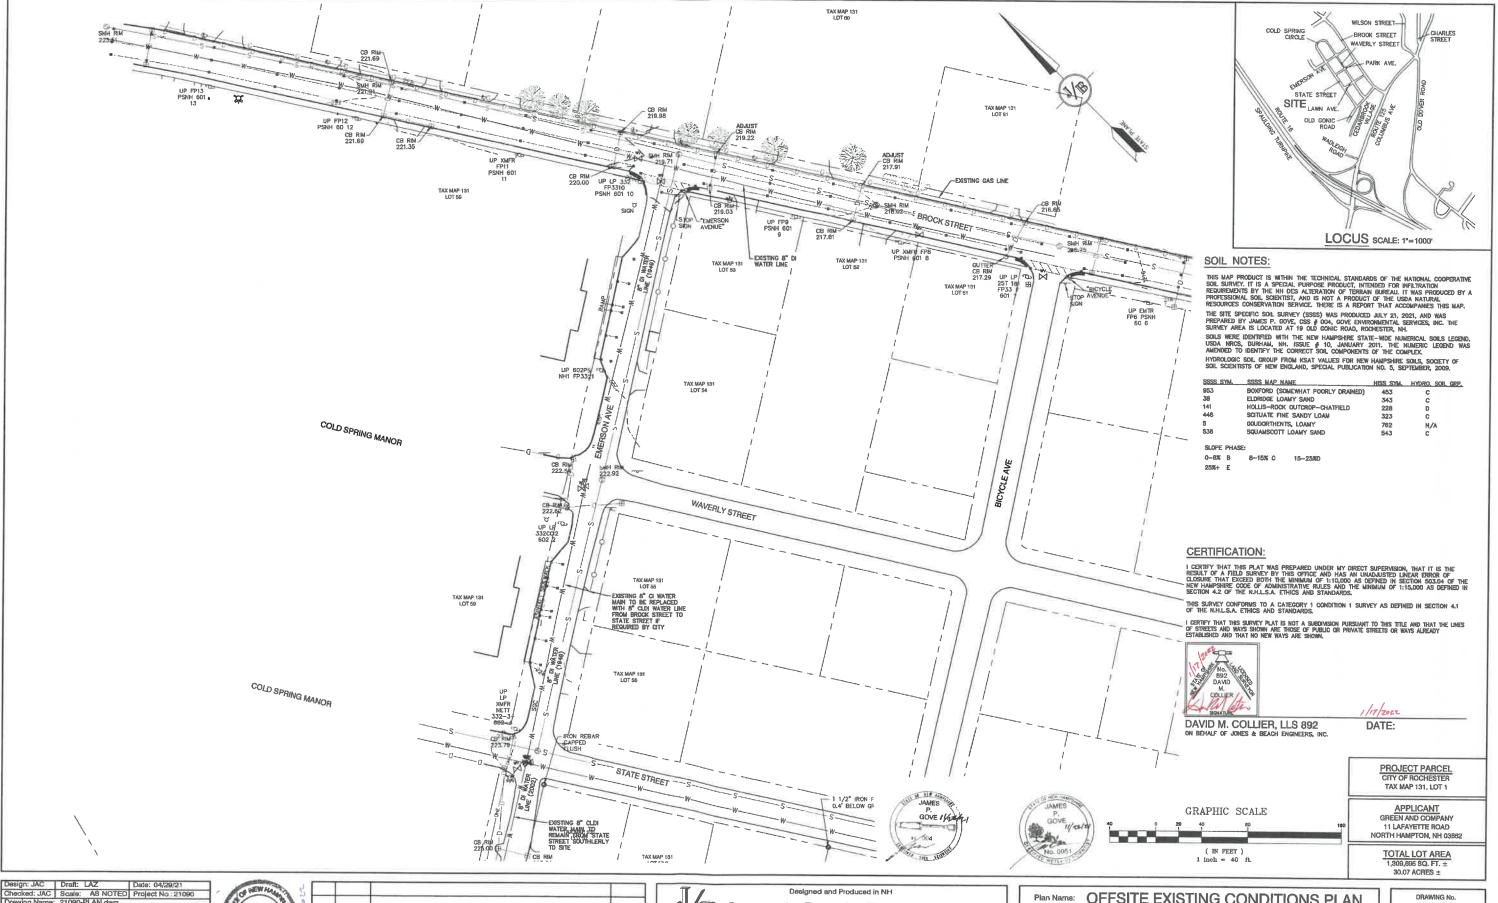

esign: JAC	Draft: LAZ	Date: 04/29/21	100	-De
	Scale: AS NOTED	Project No.: 21090		SEE ALVERTON
rawing Name:	21090-PLAN.dwg		1 55/	MICHAEL
IIS PLAN SHALL	NOT BE MODIFIED WITH	HOUT WRITTEN	\$ 50	J.
RMISSION FRO	M JONES & BEACH ENG	SINEERS, INC. (JBE).	量	No. 9848
Y ALTERATION	IS, AUTHORIZED OR OTH	IERWISE, SHALL BE	581	co -0//
THE USER'S S	OLE RISK AND WITHOUT	LIABILITY TO JBE.		ENO.
				CHINAL STREET

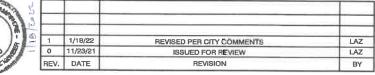

Jones & Beach Engineers, Inc.


85 Portsmouth Ave. Civil Engineering Services
PO Box 219
Stratham, NH 03885 E-MAIL: JBE@JONESANDBEACH.COM


## Plan Name: OFFSITE EXISTING CONDITIONS PLAN

BAYBERRY COMMONS 19 OLD GONIC ROAD, ROCHESTER, NH

Owner of Record: LEO P. LACOUTURE REV. TRUST & WILLIAN B. LACOUTURE 19 OLD GONIC RD., ROCHESTER, NH 03867 BK 4093 PG 148



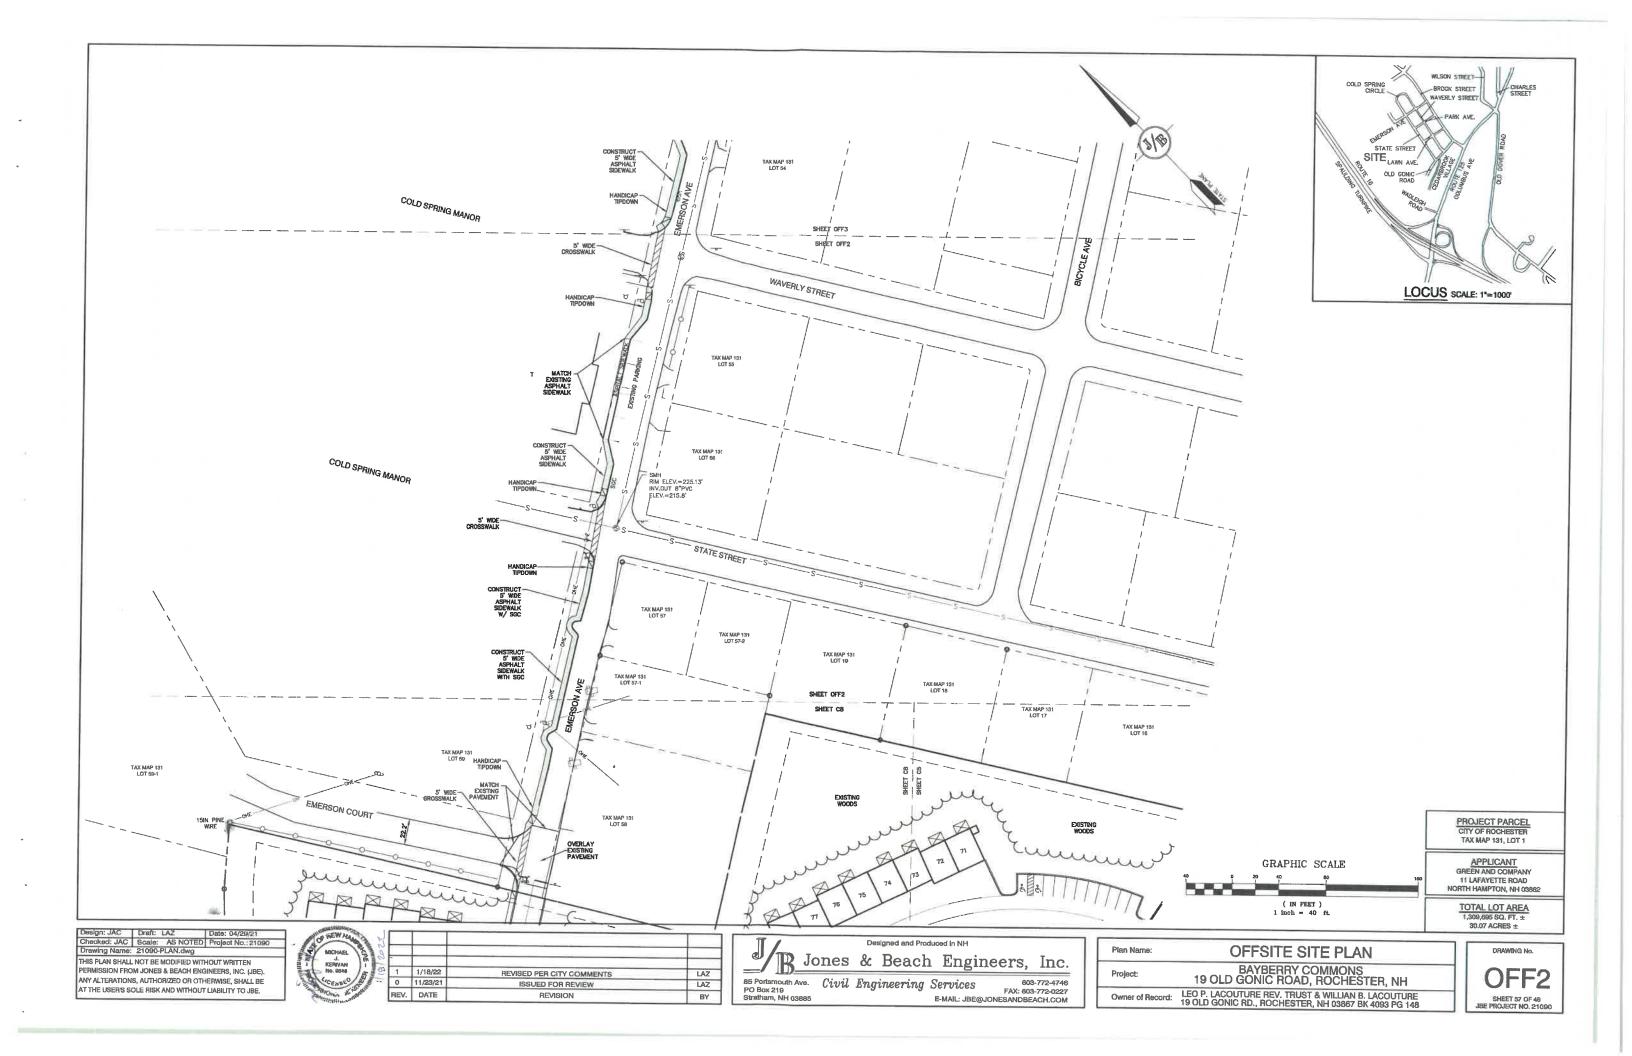

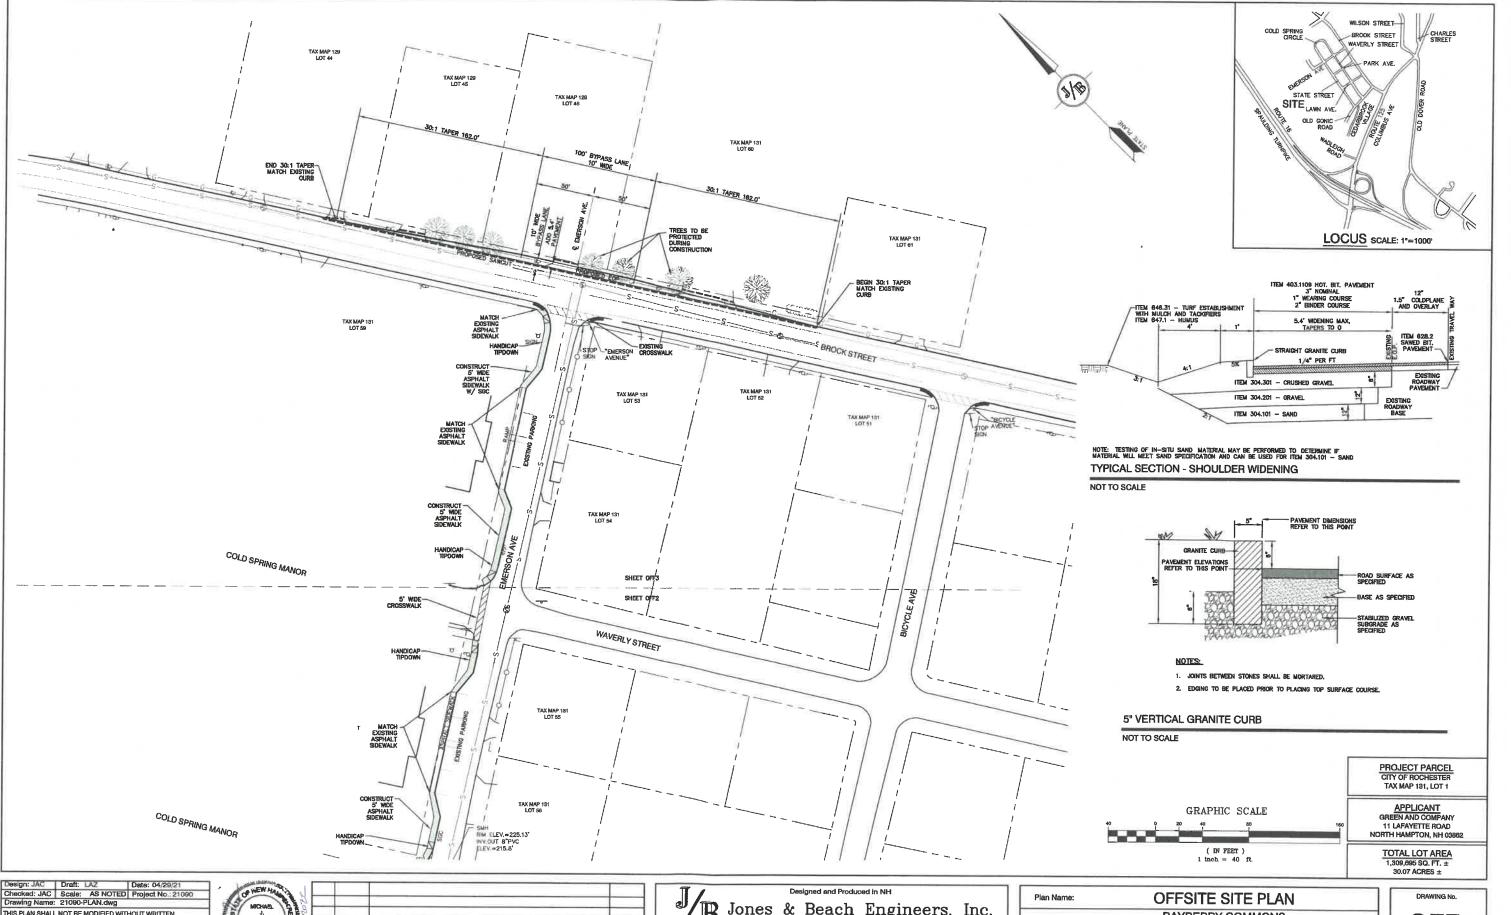

THIS PLAN SHALL NOT BE MODIFIED WITHOUT WRITTEN
PERMISSION FROM JONES & BEACH ENGINEERS, INC. (JBE). ANY ALTERATIONS, AUTHORIZED OR OTHERWISE, SHALL BE AT THE USER'S SOLE RISK AND WITHOUT LIABILITY TO JBE.



-			
1	1/18/22	REVISED PER CITY COMMENTS	LAZ
0	11/23/21	ISSUED FOR REVIEW	LAZ
REV.	DATE	REVISION	BY


Jones & Beach Engineers, Inc.

85 Portsmouth Ave. PO Box 219
Stratham, NH 03886

E-MAIL: JBE@ FAX: 603-772-0227
E-MAIL: JBE@JONESANDBEACH.COM BAYBERRY COMMONS 19 OLD GONIC ROAD, ROCHESTER, NH

Owner of Record: LEO P. LACOUTURE REV. TRUST & WILLIAN B. LACOUTURE 19 OLD GONIC RD., ROCHESTER, NH 03867 BK 4093 PG 148



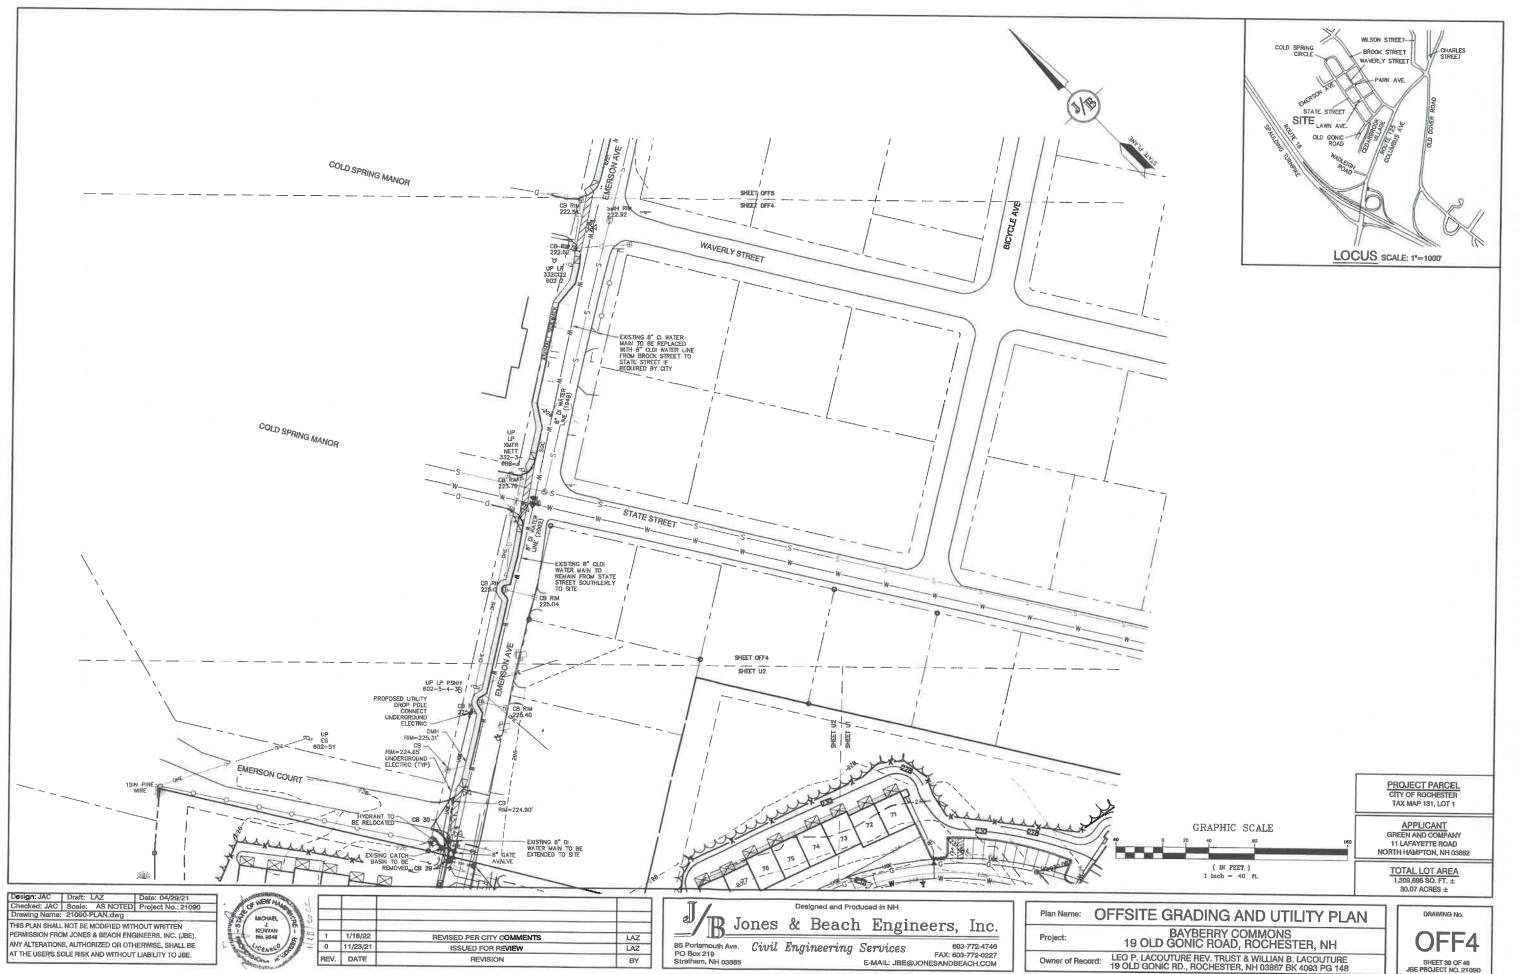

SHEET 39 OF 46 JBE PROJECT NO. 21090



THIS PLAN SHALL NOT BE MODIFIED WITHOUT WRITTEN PERMISSION FROM JONES & BEACH ENGINEERS, INC. (JBE), ANY ALTERATIONS, AUTHORIZED OR OTHERWISE, SHALL BE AT THE USER'S SOLE RISK AND WITHOUT LIABILITY TO JBE.




1	1/18/22	REVISED PER CITY COMMENTS	LAZ
0	11/23/21	ISSUED FOR REVIEW	LAZ
REV.	DATE	REVISION	BY


Jones & Beach Engineers, Inc.

85 Portsmouth Ave. Civil Engineering Services
PO Box 219
Stratham, NH 03885
E-MAIL: JBE@ Services 603-772-4746 FAX: 803-772-0227 E-MAIL: JBE@JONESANDBEACH.COM

BAYBERRY COMMONS 19 OLD GONIC ROAD, ROCHESTER, NH Owner of Record: LEO P. LACOUTURE REV. TRUST & WILLIAN B. LACOUTURE 19 OLD GONIC RD., ROCHESTER, NH 03867 BK 4093 PG 148

OFF5 SHEET 40 OF 46 JBE PROJECT NO. 21090

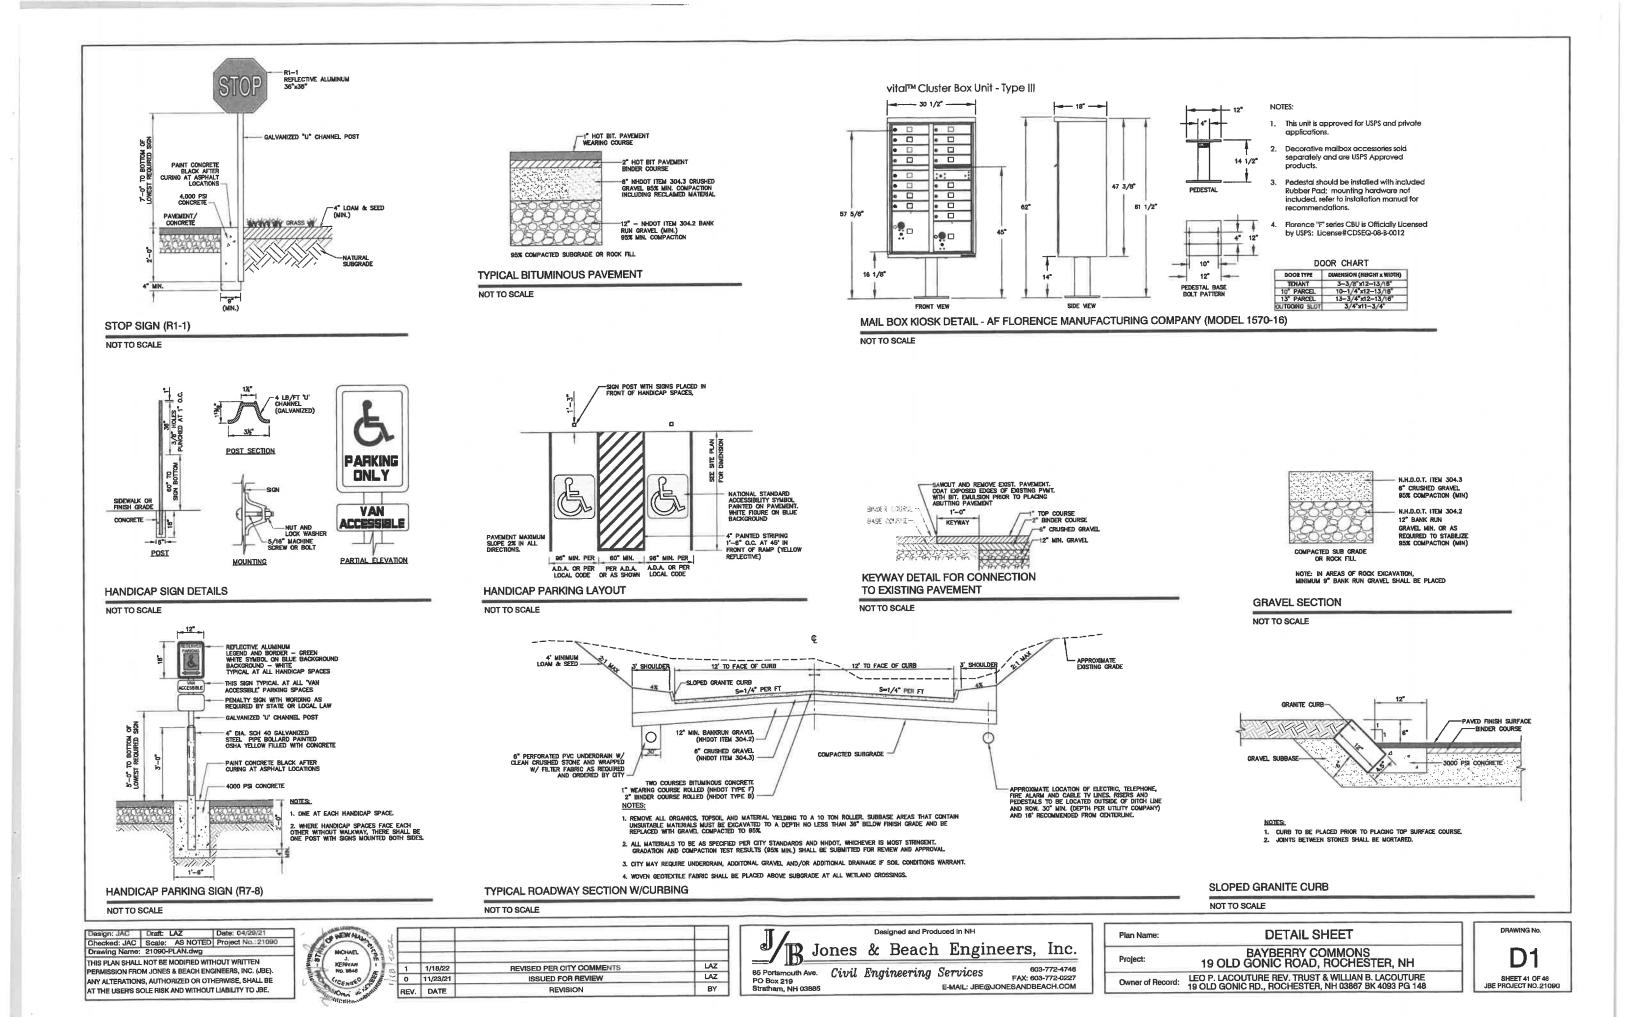

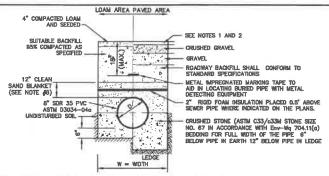


NOTES: 1. PAVEMENT REPAIR IN EXISTING ROADWAYS SHALL CONFORM TO PAVEMENT DETAILS.

- 2. NEW ROADWAY CONSTRUCTION SHALL CONFORM TO SUBDIVISION SPECIFICATIONS.
- TRENCH BACKFILL SHALL CONFORM WITH ENV. Wq 704.11(h) AND BE FREE OF DEBRIS, PAVEMENT, ORGANIC MATTER, TOP SOIL, WET OR SOFT MUCK, PEAT OR CLAY, EXCAVATED LEDGE OR ROCKS OVER SIX INCHES.
- 4. W= MAXIMUM ALLOWABLE TRENCH WIDTH TO A PLANE 12" INCHES ABOVE THE PIPE. FOR PIPES 15 INCHES NOMINAL DIAMETER OR LESS, WIDTH SHALL BE NO MORE THAN 36", FOR PIPES GREATER THAN 15 INCHES NOMINAL DIAMETER, WIDTH SHALL BE 24 INCHES PLUS PIPE O.D. WIDTH SHALL ALSO BE THE PAYMENT WIDTH FOR LEDGE EXCAVATION AND FOR ORDERED EXCAVATION BELOW GRADE.
- 5. RIGID FOAM INSULATION TO BE PROVIDED WHERE COVER IN THE ROADWAY IS LESS THAN 6' AND CROSS COUNTRY IS LESS THAN 4', PURSUANT TO DES WAIVER BEING ISSUED.
- PIPE SAND BLANKET MATERIAL SHALL BE GRADED SAND, FREE FROM ORGANIC MATERIALS, GRADED SUCH THAT 100% PASSES A 1/2 "SIEVE AND A MAXMUM OF 15% PASSES A #200 SIEVE IN ACCORDANCE WITH Env-Wq 704.11(b).
- JOINT SEALS FOR PVC PIPE SHALL BE OIL RESISTANT COMPRESSION RINGS OF ELASTOMERIC MATERIAL AND CERTIFIED BY THE MANUFACTURER AS CONFORMING TO THE ASTIM DS212 STANDARD IN EFFECT WHEN THE JOINT SEALS WERE MANUFACTURED, AND STALL BE PUSH-ON, BELL-AND-SPIGOT TYPE PER Env-Mg 704-05 (6).


#### SEWER TRENCH

#### NOT TO SCALE

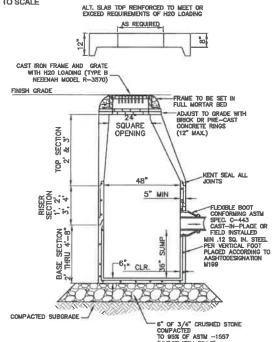


#### NOTES:

- 1. BASE SECTION SHALL BE MONOLITHIC WITH 48" INSIDE DIAMETER.
- 2. ALL SECTIONS SHALL BE DESIGNED FOR H20 LOADING.
- 3. CONCRETE SHALL BE COMPRESSIVE STRENGTH 4000 PSI, TYPE II CEMENT
- 4. FRAMES AND GRATES SHALL BE HEAVY DUTY AND DESIGNED FOR H20 LOADING
- PROVIDE "V" KNOCKOUTS FOR PIPES WITH 2" MAX. CLEARANCE TO OUTSIDE OF PIPE. MORTAR ALL PIPE CONNECTIONS SO AS TO BE WATERTIGHT.
- ALL CATCH BASIN FRAMES AND GRATES SHALL BE NHDOT CATCH BASIN TYPE ALTERNATE 1 OR NEENAH R-3570 OR APPROVED EQUAL (24"x24" TYPICAL).
- STANDARD CATCH BASIN FRAME AND GRATE(S) SHALL BE SET IN FULL MORTAR BED. ADJUST TO GRADE WITH CLAY BRICK AND MORTAR (2 BRICK COURSES THPICALLY, 5 BRICK COURSES MAXIMUM, BUT NO MORE THAN 12"), OR PRECAST CONCRETE "DONUTS".

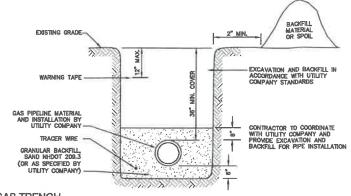


#### **GAS TRENCH**

NOT TO SCALE CROSS-COUNTRY IN PAVEMENT

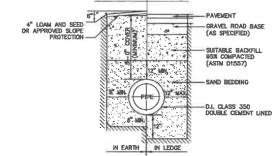

#### WATER SYSTEM TRENCH

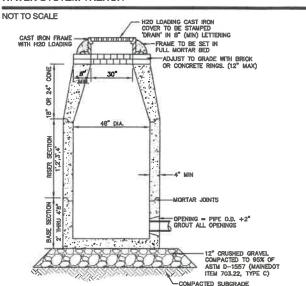


#### NOTES:

- 1. BASE SECTION SHALL BE MONOLITHIC WITH 48" INSIDE DIAMETER.
- 3. CONCRETE SHALL BE COMPRESSIVE STRENGTH 4000 PSI, TYPE II CEMENT,
- 5. PROVIDE "V" KNOCKOUTS FOR PIPES WITH 2" MAX. CLEARANCE TO OUTSIDE OF PIPE, MORTAR ALL PIPE CONNECTIONS SO AS TO BE WATERTIGHT.
- 6. JOINT SEALANT BETWEEN PRECAST SECTIONS SHALL BE BUTYL RUBBER.
- ALL DRAIN MANHOLE FRAMES AND GRATES SHALL BE NEENAH R-1798 OR APPROVED EQUAL (30" DIA. TYPICAL).
- STANDARD FRAME(S) AND GRATE(S) SHALL BE SET IN FULL MORTAR BED. ADJUST TO GRADE WITH CLAY BRICK AND MORTAR (2 BRICK COURSES TYPICALLY, 5 BRICK COURSES MAXIMUM, BUT NO MORE THAN 12"), OR PRECAST CONCRETE DONUTS'.

#### DRAIN MANHOLE (4' DIAM.)

NOT TO SCALE

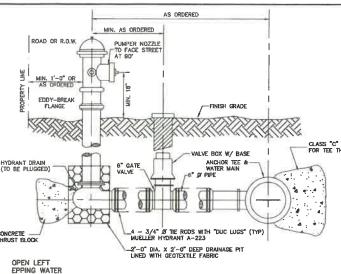

DEPARTMENT SPECS.

- NOTES

  1. ALL PIPE HITINGS TO BE D.I. PRESSURE CLASS 350, THICKNESS CLASS 52.


  2. HYDRANT TO BE PAINTED RED WITH WHITE "REPLECTOR" PAINT ON BOWNET.

  3. MECHANICAL JOINTS SHALL HAVE MEGALLIG RETAINING GLANDS AS MADE BY EBBA OR APPROVED EQUAL.

  4. STEAMER NOZZLE TO BE "STORCH" TYPE.


  5. NATIONAL STANDARD THREAD.

#### HYDRANT INSTALLATION

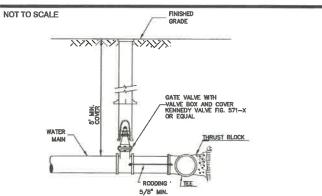

#### **BURIED GATE VALVE DETAIL**

#### NOT TO SCALE

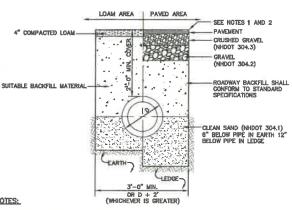


#### NOTES:

- 1. PAVEMENT REPAIR IN EXISTING ROADWAYS SHALL CONFORM TO STREET OPENING REGULATIONS.
- 2. NEW ROADWAY CONSTRUCTION SHALL CONFORM WITH PROJECT AND CITY SPECIFICATIONS.
- 3. ALL NATERIALS ARE TO BE COMPACTED TO 95% OF ASTM 0-1557.


#### DRAINAGE TRENCH

NOT TO SCALE

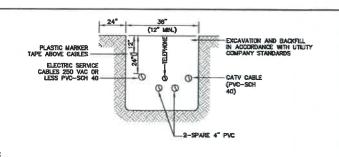

NOTE: ALL UTILITIES SHALL BE REVIEWED AND APPROVED BY APPROPRIATE UTILITY COMPANY.

#### **UTILITY TRENCH**

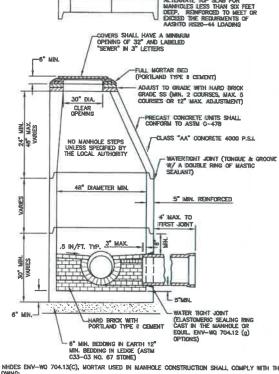

- HOTES: C33-03 NO. 67 STONE)

  PER NHDES ENV-WO 704.13(c), MORTAR USED IN MANHOLE CONSTRUCTION SHALL COMPLY WITH THE FOLLOWING:

  MORTAR SHALL BE COMPOSED OF TYPE II PORTLAND CEMENT AND SAND WITH OR WITHOUT HAVE BEEN SHALL BE COMPOSED OF TYPE II PORTLAND CEMENT AND SAND WITH OR WITHOUT HAVE COMPOSED IN MORTAR OF PARTS BY VOLUMES SHALL BE PER TAPLE 704-4:

  (1) AS PARTS SAND AND 1.5 PARTS SCHENT; OR

  (2) AS PARTS SAND, ONE PART CEMENT AND 0.5 PART HYDRATED LUME;

  C. CALENT SHALL BE TYPE II PORTLAND CEMENT THAT IS CERTIFIED BY ITS MANUFACTURER AS CONFORMING TO THE ASTIN CISO/CISOM STANDARD IN EFFECT AT THE TIME THE CEMENT WAS MANUFACTURED AS CONFORMING TO THE ASTIN CISO/CISOM STANDARD IN EFFECT AT THE TIME THE WITHER AS CONFORMING TO THE ASTIN CISO/CISOM STANDARD THAT IS CERTIFIED BY ITS MANUFACTURER AS CONFORMING TO THE ASTIN CISO/CISOM STANDARD IN EFFECT AT THE TIME THE HYDRATED LIME WAS PROCESSED BY STANDARD SPECIFICATIONS FOR CONCRETE, FIRE AGORGATES BY STANDARD SPECIFICATIONS FOR CONCRETE, FIRE AGORGATISED BY STANDARD SPECIFICATIONS FOR CONCRETE FOR AGORGATISE OF THE ASTIN CISOM STANDARD SPECIFICATIONS FOR CONCRETE FIRE MASSOCRETATIONS STANDARD SPECIFICATIONS FOR CONCRETE FIRE MASSOCRETATIONS STANDARD SPECIFICATIONS FOR CONCRETE FIRE MASSOCRETATIONS STANDARD SPECIFICATIONS FOR CONCRETE FIRE MEDITAL PRESENCE TANDARD SPECIFICATIONS STANDARD SPECIFICATIONS FOR CONCRETE FIRE DEPARTMENT OF TRANSPORTATIONS STANDARD SPECIFICATIONS FOR CONCRETE FIRE DEPARTMENT OF TRANSPORTATIONS STANDARD SPECIFICATIONS FOR CONCRETE FIRE DEPARTMENT OF TRANSPORTATIONS STANDARD SPECIFICATIONS FOR CONSTRUCTION AS AVAILABLE AT:

#### HTTP://WWW.NH.GOV/DOT/ORG/PROJECTDEVELOPMENT/HIGHWAYDESIGN/SPECIFICATIONS/INDEX.HTT

- SHELVES SHALL BE CONSTRUCTED TO THE ELEVATION OF THE HIGHEST PIPE CROWN AND SLOPED TO DRAIN TOWARD THE FLOWING THROUGH CHANNEL IN ACCORDANCE WITH ENV—WQ 704.12 (K).
- ALL MANHOLES SHALL BE TESTED FOR LEAKAGE IN ACCORDANCE WITH ENV-WQ 704.17 (a) THROUGH
- SEWER MANHOLE COVERS SHALL CONFORM TO ASTM A48/48M WITH A CASTING EQUAL TO CLASS 30 IN ACCORDANCE WITH ENV-WQ 704.13 (a) (8).
- ALL PREGAST SECTIONS SHALL BE COATED ON THE EXTERIOR WITH A BITUMINOUS DAMP-PROOFING COATING IN ACCORDANCE WITH ENV-WQ 704.12 (J).
- ALL PRECAST SECTIONS AND BASES SHALL HAVE THE DATE OF MANUFACTURE AND THE NAME OR TRADEMARK OF THE MANUFACTURER IMPRESSED OR INDELIBLY MARKED ON THE INSIDE WALL PER
- 7. BRICK MASONRY SHALL CONFORM TO ASTM C3Z (ENV-WQ 704.12(a)(9))

#### SEWER MANHOLE

NOT TO SCALE

BEVISED PER CITY COMMENTS LAZ LAZ ISSUED FOR REVIEW REVISION BY

Designed and Produced in NH Jones & Beach Engineers, Inc.

85 Portsmouth Ave. Civil Engineering Services PO Box 219 Stratham, NH 03885 FAX: 603-772-0227 E-MAIL: JBE@JONESANDBEACH.COM

Plan Name: **DETAIL SHEET** 

Project:

BAYBERRY COMMONS 19 OLD GONIC ROAD, ROCHESTER, NH

LEO P. LACOUTURE REV. TRUST & WILLIAN B. LACOUTURE 19 OLD GONIC RD., ROCHESTER, NH 03867 BK 4093 PG 148

DRAWING No. SHEET 42 OF 48 JBE PROJECT NO. 21090


**CATCH BASIN** NOT TO SCALE Date: 04/29/21 Design: JAC | Draft: LAZ Checked: JAC Scale: AS NOTED Project No.: 21090 Drawing Name: 21090-PLAN.dwg

FRMISSION FROM JONES & BEACH ENGINEERS, INC. (JBE).

ANY ALTERATIONS, AUTHORIZED OR OTHERWISE, SHALL BE


AT THE USER'S SOLE RISK AND WITHOUT LIABILITY TO JBE.

1 1/18/22 0 11/23/21 REV. DATE

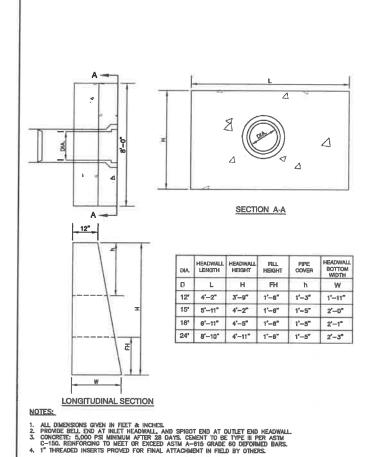

PRECAST CONCRETE HEADWALL

#### NOT TO SCALE

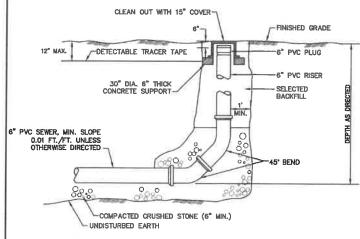

### SEWER CLEAN OUT

Checked: JAC Scale: AS NOTED Project No.:21090 Drawing Name: 21090-PLAN.dwg

PERMISSION FROM JONES & BEACH ENGINEERS, INC. (JBE).

ANY ALTERATIONS, AUTHORIZED OR OTHERWISE, SHALL BE

AT THE USER'S SOLE RISK AND WITHOUT LIABILITY TO JIBE.

THIS PLAN SHALL NOT BE MODIFIED WITHOUT WRITTEN

NOT TO SCALE

Design: JAC | Draft: LAZ

#### NOT TO SCALE 1/18/22 REVISED PER CITY COMMENTS LAZ 0 11/23/21 LAZ ISSUED FOR REVIEW REV. DATE REVISION BY

30" STANDARD MANHOLE FRAME & HWW COVER (H20 LOAD RATING) 6" MIN. FULL MORTAR BED ADJUST TO GRADE WITH CLAY BRICK OR PRECAST CONCRETE RINGS (12" MAX, ADJUSTMENT) CLEAR OPENING WATERTIGHT JOINT (TONGUE & GROOVE W/ BIT. SEAL) (SEE SPEC. SECTIONS) CLASS "AA" CONCRETE 4000 P.S.I. 4. . . . . . . 8" METER 8" BACKFLOW 8" DI STAINLESS STEEL METER SUPPORT BRACKET (TYP.) 8" VALVE (TYP.) WATER TIGHT JOINT (SEE SPEC'S SECTION)

**ELEVATION** 

PLAN VIEW

NOTES

1. METER TO BE SENSUS OMNI C2 OF APPROPRIATE SIZE.

2. BACKFLOW TO BE TESTABLE DOUBLE CHECK VALVE ASSEMBLY WITH CENTER-SHAFT OR TOP HINGE CHECKS (MULKINS JSOAST OR EQUIAL) OF APPROPRIATE SIZE, IF APPLICATION IS DESIGNED LOW HAZARO.

3. OPTIONAL BYPASS MY DE SIZED FOR DOMESTIC SERVICE ONLY.

4. VAULT TO HAVE ADEQUATE ANTI-BOUYANCY FEATURES.

5. VAULT COVERS TO BE STAMPED WITH "WATER" AND MATCH EXISTING CITY OF ROCHESTER INFRASTRUCTURE STAMOARDS.

6. ISOLATION VALVES REQUIRED AROUND EQUIPMENT FOR MAINTENCE, TESTING AND SERVICE.


7. IF APPLICATION IS DESIGNATED HIGH HAZARO, THE ASSEMBLY MUST USE REZ BACKFLOW DEVICES AND SELOCATED IN AN ABOVE GRADE, HEATED AND RISULATED BECLOSURE TO ALLOW FOR DRAINING.

8. VAULT AND ACCESS NATCHES SHALL BE SIZED TO ALLOW ENTRY FOR INSPECTION, TESTING AND COMPLETE REPLACEMENT OF DEVICES.

BYPASS USAGE: 8. F OPTIONAL BYPASS LINE IS INSTALLED, WHEN MAIN FEED IS TAKEN OFLINE AND BYPASS ENGAGED, OWNER SHALL CALL 330-7128 TO COORDINATE LOW FLOW CONDITION WITH ROCHESTER FIRE DEPARTMENT AND ROCHESTER PUBLIC WORKS

#### WATER METER PIT ROCHESTER

#### NOT TO SCALE

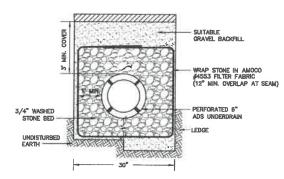

#### NOTES:


- 1. PAVEMENT REPAIR IN EXISTING ROADWAYS SHALL CONFORM TO STREET OPENING REGULATIONS
- 2. NEW ROADWAY CONSTRUCTION SHALL CONFORM TO PROJECT AND CITY SPECIFICATIONS.
- 3. SLOPE UNDERDRAIN PIPE TO DAYLIGHT.

#### **ROADWAY UNDERDRAIN TRENCH**

WIDTH VARIES SEE SITE PLANS VERTICAL GRANITE CURB 1.5" BASE COURSE 1/4" PER FT. FINISH SURFACE 6" BANK RUN COMPACTED SUBGRADE OR ROCK FILL

#### BIT. SIDEWALK W/ VERTICAL GRANITE CURB

#### NOT TO SCALE

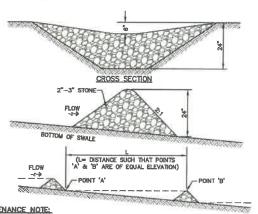

#### MAINTENANCE NOTE:

1. STONE CHECK DAMS SHOULD BE CHECKED AFTER EACH RAINFALL AND AT LEAST DAILY DURING PROLONGED RAINFALL. ANY NICESSARY REPAIRS SHOULD BE MADE IMMEDIATELY. PARTICULAR ATTENTION SHOULD BE GIVEN TO BUD RUM AND EROSION AT THE DOWNSTREAM TOE OF THE STRUCTURE, WHEN THE STRUCTURES ARE REMOVED, THE DISTURBED PORTION SHOULD BE BROUGHT TO THE EDSTING CHANNEL. GRADE AND THE AREAS PREPARED, SEEDED AND MULCHED. WHILE THIS PRACTICE IS NOT INTEDDED TO BE USED PRIMARILY FOR SEDIMENT TRAPPING, SOME SEDIMENT WILL ACCUMULATE BEHIND THE STRUCTURES. SEDIMENT SHALL BE REMOVED FROM BEHIND THE STRUCTURES WHEN IT HAS ACCUMULATED TO ONE HALF OF THE ORIGINAL HEIGHT OF THE STRUCTURE.

#### STONE CHECK DAM


NOT TO SCALE

## CONCRETE BLOCKS -FILTERED WATER MAINTENANCE NOTE:

1. ALL STRUCTURES SHOULD BE INSPECTED AFTER EVERY RAINFALL AND REPAIRS MADE AS NECESSARY, SEDIMENT SHOULD BE REMOVED FROM TRAPPING DEVICES AFTER THE SEDIMENT HAS REACHED A MAXMUM OF ONE HALF THE DEPTH OF THE TRAP. THE SEDIMENT SAULD BE RESPOSED IN A SUITABLE UPLAND AREA AND PROTECTED FROM EROSION BY ETHER STRUCTURE OR VEGETATIVE MEANS. THE TEMPORARY TRAPS SHOULD BE REMOVED AND THE AREA REPAIRED AS SOON AS THE CONTRIBUTING DRAWAGE AREA TO THE BILET HAS BEEN COMPLETELY STABILIZED.

#### TEMPORARY CATCH BASIN INLET PROTECTION (Block and Gravel Drop Inlet Sediment Filter)

NOT TO SCALE

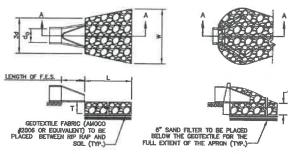

SECTION A-A PIPE OUTLET TO FLAT AREA WITH NO DEFINED CHANNEL SECTION A-A PIPE OUTLET TO WELL-DEFINED

				CHANN
TABLE 7-24R	COMMENDED	RIP RAP GR	ADATIO	RANGES
THICKNESS OF RI	P RAP = 1.	5 FEET		
d50 SIZE=	0.50	FEET	6 1	NCHES
% OF WEIGHT SM. THAN THE GIVEN		SIZE OF	STONE	(INCHES)
100%		9		12
85%		8		11
50%		6		9
15%		2		3


- 1. THE SUBGRADE FOR THE GEOTEXTILE FABRIC AND RIP RAP SHALL BE PREPARED TO THE LINES AND GRADES SHOWN ON THE PLANS.
- 3. GEOTEXTILE FABRICS SHALL BE PROTECTED FROM PUNCTURE OR TEARING DURING THE PLACEMENT OF THE ROCK RIP. DAMAGED AREAS IN THE FABRIC SHALL BE REPARRED BY PLACING A PIECE OF FABRIC OVER THE DAMAGED AREA OR BY COMPLETE REPLACEMENT OF THE FABRIC, ALL OVERLAPS REQUIRED FOR REPAIRS OR JOINING TWO PIECES OF FABRIC SHALL BE A MINIMUM OF 12 INCHES.
- 4. STONE FOR THE RIP RAP MAY BE PLACED BY EQUIPMENT AND SHALL BE CONSTRUCTED TO THE FULL LAYER THICKNESS IN ONE OPERATION AND IN SUCH A MANNER AS TO PREVENT SEGREGATION OF THE STONE SIZES.
- 5. DUTLETS TO A DEFINED CHANNEL SHALL HAVE 2:1 OF FLATTER SIDE SLOPES AND SHOULD BEGIN AT THE TOP OF THE CULVERY AND TAPER DOWN TO THE CHANNEL BOTTOM THROUGH THE LENGTH OF THE APRON.
- 6. MAINTENANCE: THE OUTLET PROTECTION SHOULD BE CHECKED AT LEAST ANNUALLY AND AFTER EVERY MAJOR STORM. IF THE RIP RAP HAS BEEN DISPLACED, UNDERMINED OR DAMAGED, IT IS SHOULD BE REPAIRED IMMEDIATELY. THE CHANNEL MIMEDIATELY BELOW THE OUTLET SHOULD BE CHECKED TO SEE THAT EROSION IS NOT OCCURRING. THE DOWNSTREAM CHANNEL SHOULD BE KEPT GLEAR OF OBSTRUCTIONS SUCH AS FALLEN TREES, DEERNS, AND SEDIMENT THAT COULD CHANGE FLOW PATTERNS. AND/OR TAILWATER DEPTHS ON THE PIPES. REPAIRS MUST BE CARRIED OUT IMMEDIATELY TO AVOID ADDITIONAL DAMAGE TO OUTLET PROTECTION.

#### **RIP RAP OUTLET PROTECTION APRON**

NOT TO SCALE

Designed and Produced in NH  In Iones & Roach Engineers Inc.	Plan Name: DETAIL SHEET
Jones & Beach Engineers, Inc.  85 Portsmouth Ave. Civil Engineering Services  603-772-4746  85 Portsmouth Ave. Civil Engineering Services	Project: BAYBERRY COMMONS 19 OLD GONIC ROAD, ROCHESTER, NH
PO Box 219 FAX: 603-772-0227 Stratham, NH 03885 E-MAIL: JBE@JONESANDBEACH.COM	Owner of Record: LEO P. LACOUTURE REV. TRUST & WILLIAN B. LACOUTURE 19 OLD GONIC RD., ROCHESTER, NH 03867 BK 4093 PG 148

DRAWING No. SHEET 43 OF 46

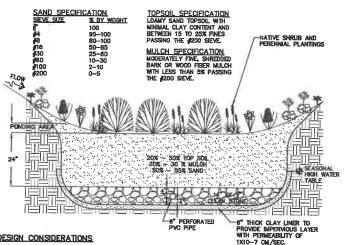

#### DESIGN CONSIDERATIONS


- DO NOT PLACE BIORETENTION SYSTEMS INTO SERVICE UNTIL THE BMP HAS BEEN PLANTED AND ITS CONTRIBUTING AREAS HAVE BEEN FULLY STABILIZED.
- DO NOT DISCHARGE SEDIMENT-LADEN WATERS FROM CONSTRUCTION ACTIVITIES (RUN-OFF, WATER FROM EXCAVATIONS) TO THE BIORETENTION AREA DURING ANY STAGE OF CONSTRUCTION.
- DO NOT TRAFFIC EXPOSED SOIL SURFACE WITH CONSTRUCTION EQUIPMENT. IF FEASIBLE, PERFORM EXCAVATIONS WITH EQUIPMENT OUTSIDE THE LIMITS OF THE INFILTRATION COMPONENTS OF THE SYSTEM.

#### MAINTENANCE REQUIREMENTS:

- SYSTEMS SHOULD BE INSPECTED AT LEAST TWICE ANNUALLY, AND FOLLOWING ANY RAINFALL EVENT EXCEEDING 2.5 INCHES IN A 24 HOUR PERIOD, WITH MAINTENANCE OR REHABILITATION CONDUCTED AS WARRANTED BY SUCH INSPECTION.
- PRETREATMENT MEASURES SHOULD BE INSPECTED AT LEAST TWICE ANNUALLY, AND CLEANED OF ACCUMULATED SEDIMENT AS WARRANTED BY INSPECTION, BUT NO LESS THAN ONCE ANNUALLY.
- TRASH AND DEBRIS SHOULD BE REMOVED AT EACH INSPECTION.
- AT LEAST ONCE ANNUALLY, SYSTEM SHOULD BE INSPECTED FOR DRAWDOWN TIME. IF BIORETENTION SYSTEM DOES NOT DRAIN WITHIN 72 HOURS FOLLOWING A RAINFALL EVENT, THEN A QUALIFIED PROFESSIONAL SHOULD ASSESS THE CONDITION OF THE FACILITY TO DETERMINE MEASURES REQUIRED TO RESTORE FILTRATION FUNCTION OR INFILTRATION FUNCTION (AS APPLICABLE), INCLUDING BUT NOT LIMITED TO REMOVAL OF ACCUMULATED SEDIMENTS OR RECONSTRUCTION OF THE FILTER MEDIA.
- VEGETATION SHOULD BE INSPECTED AT LEAST ANNUALLY, AND MAINTAINED IN HEALTHY CONDITION, INCLUDING PRUNING, REMOVAL AND REPLACEMENT OF DEAD OR DISEASED VEGETATION, AND REMOVAL CONTRACTOR CONTROL OF THE PROPERTY OF THE PROPERTY
- 6. CLAY LINER MATERIAL SHALL BE CLEAN SILTY—CLAY BORROW FREE OF ROOTS, ORCANIC MATTER, AND OTHER DELETERIOUS SUBSTANCES, AND SHALL CONTAIN NO ROCKS OR LUMPS OVER THREE INCHES (3") IN DIAMETER. THIS MATERIAL SHALL BE INSTALLED IN 6" LIFTS COMPACTED TO 82% OF ASTM D-1557, AND SHALL MEET THE FOLLOWING SPECIFICATIONS: 6" PASSING 100%, 4" SIEVE 85-100%, 4" OSEVE 40-80%, 9"200 SIEVE 25-45% (OF THE FRACTION PASSING THE 4" SIEVE). THE CLAY COMPONENT SHALL HAVE A PLASTICITY INDEX OF AT LEAST 8 AND A HYDRAULIC CONDUCTIVITY OF 10 TO THE -6 CM/SEC.
- COMPACTION AND MATERIALS TESTING SERVICES SHALL BE PERFORMED BY AN INDEPENDENT GEOTECHNICAL ENGINEER RETAINED BY THE OWNER.

#### BIORETENTION SYSTEM (with clay bottom and pipe)


#### NOT TO SCALE

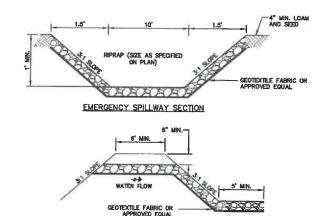

EMERGENCY SPILLWAY PROFILE

#### **EMERGENCY SPILLWAY**

NOT TO SCALE esign: JAC | Draft: LAZ

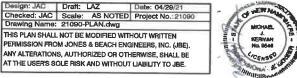

1	1/18/22	REVISED PER CITY COMMENTS	LAZ
0	11/23/21	ISSUED FOR REVIEW	LAZ
REV.	DATE	REVISION	BY

STAINLESS STEEL HINGE - FO REBAR @ 4"a.c. A B C D C POND 1 3.5" 213.25 213.25 12" 219.00 POND 2 3.5" 213.25 213.25 12" 219.00 POND 3 5.0° 217.25 217.25 12° 223.00

POND TABLE

Designed and Produced in NH


85 Portsmouth Ave. Civil Engineering Services

PO Box 219

Jones & Beach Engineers, Inc.


603-772-4748

FAX: 603-772-0227
E-MAIL: JBE@JONESANDBEACH.COM

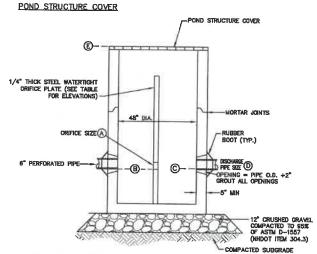


#### CATCH BASIN CONTROL STRUCTURE (CBCS)


#### NOT TO SCALE

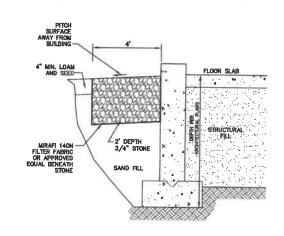

#### DRIP EDGE DETAIL

#### NOT TO SCALE

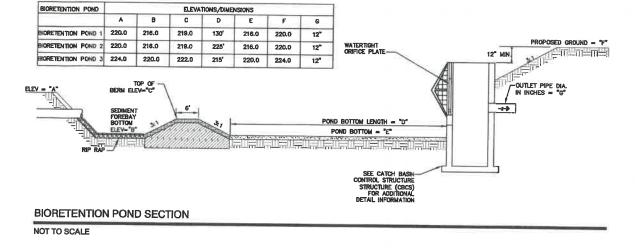

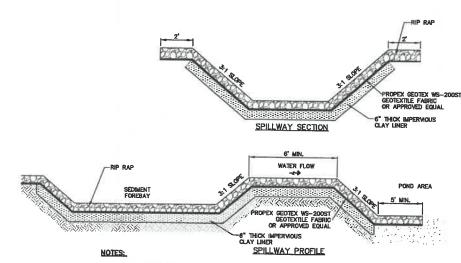


- A 6" THICK IMPERVIOUS CLAY LINER IS TO BE PLACED LINDER ENTIRE SEDIMENT FOREBAY AND SPILLWAY AND ONLY AROUND THE SIDES OF THE ENTIRE BIORETENTION AREA.
- SEDIMENT SHALL BE REMOVED FROM BEHIND THE STRUCTURE WHEN IT HAS ACCUMULATED TO ONE HALF THE ORIGINAL HEIGHT OF THE STRUCTURE.
- 3. EMBANKMENT MATERIAL SHALL BE CLEAN MINERAL SOIL FREE OF ROOTS, ORGANIC MATTER, AND OTHER DELETERIOUS SUBSTANCES. IT SHALL CONTAIN NO ROCKES OR LUMPS OVER FOUR MODIES (4") IN DAMETER. THIS MATERIAL SHALL BE INSTALLED IN 6" JUFTS COMPACTED TO 925 OF ASTM O-1857, AND SHALL MEET THE FOLLOWING SPECIFICATIONS: 6" PASSING 100%, \$4" SIEVE 40-80%, \$40 SIEVE 50-80%, \$100 SIEVE 28-40%, \$200
- 4. 6" THICK IMPERVIOUS CLAY LINER MATERIAL SHALL BE CLEAN SLTY-CLAY BORROW FREE OF ROOTS, ORGANIC MATTER, AND OTHER DELETERIOUS SUBSTANCES, AND SHALL CONTAIN NO ROCKS OR LUMBE OVER THREE RICHES (3") IN DIAMETER THIS MATERIAL SHALL BE INSTALLED IN 6" LIFTS COMPACTED TO 92% OF SATU D-1557, AND SHALL MEET THE FOLLOWING SPECIFICATIONS: 6" PASSING 100% 4" STEVE 95-100%, 4" O STEVE 60-90%, 9" DO STEVE 60-90%, 9" DO STEVE 30-90%, 9" DO STEVE 30-9
- COMPACTION AND MATERIALS TESTING SERVICES SHALL BE PERFORMED BY AN INDEPENDENT GEOTECHNICAL ENGINEER RETAINED BY THE OWNER.

#### SEDIMENT FOREBAY SPILLWAY

NOT TO SCALE

Plan Name: **DETAIL SHEET** BAYBERRY COMMONS 19 OLD GONIC ROAD, ROCHESTER, NH Project: LEO P. LACOUTURE REV. TRUST & WILLIAN B. LACOUTURE 19 OLD GONIC RD., ROCHESTER, NH 03867 BK 4093 PG 148 Owner of Record:

DRAWING No. **D4** SHEET 44 OF 46 JBE PROJECT NO. 21090

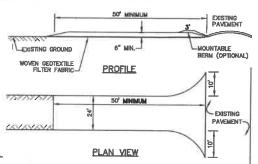

- NOTICES:

  1. STONE FOR STABILIZED CONSTRUCTION ENTRANCE SHALL BE 1 TO 2 INCH STONE, RECLAIMED STONE, OR RECYCLED CONGRETE EQUIVALENT.

  1. STONE FOR STABILIZED ENTRANCE SHALL NOT BE LESS THAN 50 FEET, EXCEPT FOR A SINGLE RESIDENTIAL LOT WHERE A 30 FOOT MINIMUM LENGTH WOULD APPLY.

  3. THICKNESS OF THE STONE FOR THE STABILIZED ENTRANCE SHALL HOT BE LESS THAN 6 INCHES.

  4. THE WIDTH OF THE ENTRANCE SHALL NOT BE LESS THAN THE FULL WOTH OF THE ENTRANCE WHERE INGRESS OR EGRESS COCURS, OR 10 FEET, WHICHEVER IS GREATED.

  5. GEOTEXTILE FILTRE FABRIC SHALL BE PLACED OVER THE ENTIRE AREA PROOR TO PLACING THE STONE.


  6. FLIETE FABRIC IS NOT REQUIRED FOR A SINGLE FAMILY RESIDENTIAL LOT.

  6. ALL SURFACE WHEN THAT IS FLOWING TO OR DIVERTED TOWARD THE CONSTRUCTION ENTRANCE SHALL BE PRED BENEATH THE DISTRINGLE OF THE PRINCE IS THAT CAN BE PRED BENEATH THE DISTRINGLE STONE.

  7. THE ENTRANCE SHALL BE VIEW THAT IS SURSTITUTED FOR THE PRINCE FOR PERSONE OF PLACING OF FLOWING OF SEDIMENT ONTO THE PUBLIC RIGHT—OF—WAY. THIS MAY REQUIRE PERSONED FOR PERSONE WITH ADDITIONAL STONE AS CONDITIONS DEMAND AND REPAIR AND/OR CLEAN OUT OF ANY MEASURES USED TO TRAP REMOVED PROMPTLY.

#### STABILIZED CONSTRUCTION ENTRANCE

NOT TO SCALE

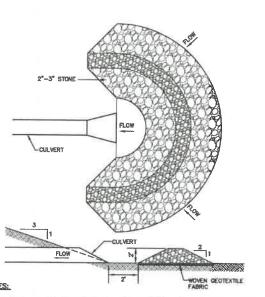

- TEMPORARY CULVERT INLET PROTECTION CHECK DAMS SHALL BE CONSTRUCTED OF 2-3° STONE OVER WOVEN GEOTEXTILE FABRIC.
- NLET PROTECTION MEASURES SHALL BE INSTALLED AT THE OPENINGS OF ALL EXISTING AND PROPOSED CULPRITS LOCATED BELOW (DOWNSTREAM) FROM AND WITHIN 100" OF THE PROLECT STE.
- SEDIMENT SHALL BE REMOVED FROM BEHIND THE STRUCTURE WHEN IT HAS ACCUMULATED TO ONE HALF THE ORIGINAL HEIGHT OF THE STRUCTURE.
- STRUCTURES SHALL BE REMOVED WHEN THE SITE IS STABILIZED WITH VEGETATION AND THE CHANNEL SHALL BE SMOOTHED AND REVEGETATED.

#### TEMPORARY CULVERT INLET PROTECTION CHECK DAM

NOT TO SCALE

1 1/18/22 REVISED PER CITY COMMENTS 0 11/23/21 REV. DATE

- TEMPORARY EROSION CONTROL NOTES

  1. THE SMALLEST PRACTICAL AREA OF LAND SHALL BE EXPOSED AT ANY ONE TIME. AT NO TIME SHALL AN AREA IN EXCESS OF 5 ACRES BE EXPOSED AT ANY ONE TIME BEFORE DISTURBED AREAS ARE STABILIZED.
- EROSION, SEDIMENT AND DETENTION MEASURES SHALL BE INSTALLED AS SHOWN ON THE PLANS AND AT LOCATIONS AS REQUIRED, DIRECTED BY THE ENGINEER.
- ALL DISTURBED AREAS (INCLIDING POND AREAS BELOW THE PROPOSED WATERLINE) SHALL BE RETURNED TO PROPOSED GRADES AND ELEVATIONS. DISTURBED AREAS SHALL BE LOAMED WITH A MINIMUM OF 8° OF SCREENED ORGANIC LOAM AND SEEDED WITH SEED MIXTURE "C" AT A RATE NOT LESS THAN 1.10 POUNDS OF SEED PER 1,000 S.F. OF AREA (48 LBS. / ACRE).
- 4. SLT FENCES AND OTHER BARRIERS SHALL BE INSPECTED EVERY SEVEN CALENDAR DAYS AND WITHIN 24 HOURS OF A RAINFALL OF 0.5" OR GREATER. ALL DAMAGED AREAS SHALL BE REPAIRED, AND SEDIMENT DEPOSITS SHALL PERIODICALLY BE REMOVED AND DISPOSED OF.
- AFTER ALL DISTURBED AREAS HAVE BEEN STABILIZED, THE TEMPORARY EROSION CONTROL MEASURES SHALL BE REMOVED AND
  THE AREA DISTURBED BY THE REMOVAL SMOOTHED AND RE-VEGETATED.
- AREAS MUST BE SEEDED AND MULCHED OR OTHERWISE PERMANENTLY STABILIZED WITHIN 3 DAYS OF FINAL GRADING, OR TEMPORARILY STABILIZED WITHIN 14 DAYS OF THE INITIAL DISTURBANCE OF SOIL ALL AREAS SHALL BE STABILIZED WITHIN 45 DAYS OF WITHAL DISTURBANCE.
- 7. ALL PROPOSED VEGETATED AREAS THAT DO NOT EXHIBIT A MINIMUM OF 85 PERCENT VEGETATIVE GROWTH BY OCTOBER 15, OR WHICH ARE DISTURBED AFTER OCTOBER 15, SHALL BE STABILIZED BY SEEDING AND INSTALLING NORTH AMERICAN GREEN \$75 EROSION CONTROL BLANGETS (OR AN EQUIVALENT APPROVED IN WRITING BY THE ENGINEEY) ON SLOPES GREATER THAN 3.1, AND SEEDING AND PLACING 3 TO 4 TONS OF MULCH PER ACRE, SECURED WITH ANCHORED NETTING SEEDING THE INSTALLATION OF EROSION CONTROL BLANKETS OR MULCH AND METTING SHALL NOT OCCUR OVER ACCUMULATED SNOW OR ON FROZEN GROUND AND SHALL BE COMPLETED IN ADVANCE OF THAW OR SPRING MELT EVENTS.
- ALL DITCHES OR SWALES WHICH DO NOT EXHIBIT A MINIMUM OF B5 PERCENT VEGETATIVE GROWTH BY OCTOBER 15, OR WHICH ARE DISTURBED AFTER OCTOBER 15, SHALL BE STABILIZED TEMPORABILY WITH STONE OR EROSION CONTROL BLANKETS APPROPRIATE FOR THE DESIGN FLOW CONDITIONS.
- AFTER OCTOBER 15th, INCOMPLETE ROAD OR PARKING SURFACES, WHERE WORK HAS STOPPED FOR THE WINTER SEASON, SHALL BE PROTECTED WITH A MINIMUM OF 3" OF CRUSHED GRAVEL PER NHDOT ITEM 304.3.
- 10. AN AREA SHALL BE CONSIDERED STABLE IF ONE OF THE FOLLOWING HAS OCCURRED

  - b. A MINIMUM OF 85% VEGETATED GROWTH HAS BEEN ESTABLISHED:
  - C. A MINIMUM OF 3" OF NON-EROSIVE MATERIAL SUCH STONE OR RIPRAP HAS BEEN INSTALLED; OR
  - d. EROSION CONTROL BLANKETS HAVE BEEN PROPERLY INSTALLED.
- FUGITIVE DUST CONTROL IS REQUIRED TO BE CONTROLLED IN ACCORDANCE WITH ENV-A 1000, AND THE PROJECT IS TO MEET THE REQUIREMENTS AND INTENT OF RSA 430:53 AND AGR 3800 RELATIVE TO INVASIVE SPECIES.
- 12. PRIOR TO BEGINNING CONSTRUCTION, THE CONTRACTOR'S NAME, ADDRESS, AND PHONE NUMBER SHALL BE SUBMITTED TO DES
- 14. IN ORDER TO ENSURE THE STABILITY OF THE SITE AND EFFECTIVE IMPLEMENTATION OF THE SEDIMENT AND EROSION CONTROL MEASURES SPECIFED IN THE PLANS FOR THE DURATION OF CONSTRUCTION. THE CONTRACTOR SHALL BE IN STRICT COMPLIANCE WITH THE FOLLOWING IMPSECTION AND MAINTENANCE REQUIREMENTS IN ADDITION TO THOSE CHELD FOR IN THE SWPPP.
  - a. A CERTIFIED PROFESSIONAL IN EROSION AND SEDIMENT CONTROL <u>or</u> a professional engineer licensed in the state of new hampshire ("Monitor") shall be employed to inspect the site from the start of alteration of terrain activities until the site is in full compliance with the site specific permit ("Permit").
  - b. During this period, the monitor shall inspect the subject site at least once a week, and if possible, during any ½ inch or greater rain event (i.e. ½ inch of precipitation or more within a 24 hour period), if unable to be present during such a storm, the monitor shall inspect the site within 24 hours of this event.
  - c. THE MONITOR SHALL PROVIDE TECHNICAL ASSISTANCE AND RECOMMENDATIONS TO THE CONTRACTOR ON THE APPROPRIATE BEST MANAGEMENT PRACTICES FOR EROSION AND SEDMENT CONTROLS REQUIRED TO MEET THE REQUIREMENTS OF RSA 485 A17 AMO ALL APPLICABLE DES PERMIT CONDITIONS.
  - d. WITHIN 24 HOURS OF EACH INSPECTION, THE MONITOR SHALL SUBMIT A REPORT TO DES VIA EMAIL (RIDGELY MAJCK AT: RIDGELY.MAJCK@DES.NH.GOV).
  - THE MONITOR SHALL MEET WITH DES TO DECIDE UPON A REPORT FORMAT. THE REPORT FORMAT SHALL BE REVIEWED AND APPROVED BY DES PRIOR TO THE START OF CONSTRUCTION.

# Earth Berm PLAN VIEW

CROSS SECTION

**Earth Berry** 

Vin. 2:1 Silde Sign

#### **TEMPORARY SEDIMENT BASIN**

NOT TO SCALE

SEEDING SPECIFICATIONS

- . GRADING AND SHAPING
  A. SLOPES SHALL NOT BE STEEPER THAN 2:1 WITHOUT APPROPRIATE EROSION CONTROL MEASURES AS SPECIFIED ON THE PLANS (3:1 SLOPES OR FLATTER ARE PREFERRED).
  B. WHERE MOWING WILL BE DONE, 3:1 SLOPES OR FLATTER ARE RECOMMENDED.

- 2. SEEDBED\_PREPARATION.
  A. SURFACE AND SEEPAGE WATER SHOULD BE DRAINED OR DIVERTED FROM THE SITE TO PREVENT DROWNING OR WINTER WILLING OF THE PLANTS.
  B. STONES LARGER THAN 4. INCHES AND TRASH SHOULD BE REMOVED BECAUSE THEY INTERFERE WITH SEEDING AND FUTURE MAINTENANCE OF THE AREA. WHERE FEASIBLE, THE SOIL SHOULD BE TILED TO A DEPTH OF ABOUT 4. INCHES TO PREPARE A SEEDBED AND FERTILIZER AND LIME MIXED INTO THE SOIL THE SEEDBED SHOULD BE LIFET IN A REASONALELY FIRM AND SMOOTH CONDITION. THE LAST TILLAGE OFERATION SHOULD BE PERFORMED ACROSS THE SLOPE WHEREVER PRACTICAL.

- 3. ESTABLISHING A STAND

  A. LIME AND FERTILIZER SHOULD BE APPLIED PRIOR TO OR AT THE TIME OF SEEDING AND INCORPORATED INTO THE SOIL. TYPES AND AMOUNTS OF LIME AND FERTILIZER SHOULD BE BASED ON AN EVALUATION OF SOIL ESTS. WHEN A SOIL TEST IS NOT AVAILABLE, THE FOLLOWING MINIMUM AMOUNTS SHOULD BE APPLIED:

  AGRICULTURAL LIMESTONE, 2 TONS PER ACRE OR 100 LBS. PER 1,000 SQ.FT.
- INITIODERING, 30 LESS, PER ACRE. ON 1,1 LES, PER 1,000 SQ.FT.

  PHOSPHATE(P205), 100 LESS, PER ACRE. OR 2.2 LES. PER 1,000 SQ.FT.

  POTASH(X20), 100 LESS, PER ACRE. OR 2.2 LES. PER 1,000 SQ.FT.

  (NOTE: THIS IS THE EQUIVALENT OF 500 LESS. PER 1,000 SQ.FT.

  (NOTE: THIS IS THE EQUIVALENT OF 500 LESS. PER ACRE. OF 10-20-20 PERTILIZER OR 1,000 LESS. PER ACRE. OF 5-10-10.)

  SEED SHOULD BE SPREAD UNIFORMLY BY THE METHOD MOST APPROPRIATE FOR THE SITE. METHODS INCLIDE BROADCASTING, DRILLING AND HYDROSEEDING, WHERE BROADCASTING IS USED, COVER SEED WITH 25 MICH. OF SOIL OR LESS, BY CULTIPACKING OR RAGNING.
- REFER TO THE "SEEDING QUIDE" AND "SEEDING RATES" TABLES ON THIS SHEET FOR APPROPRIATE SEED MIXTURES AND RATES OF SEEDING. ALL LEGUNES (CROWNVETCH, BIRDSFOOT, TREFOIL AND FLATPEA) MUST BE INOCULATED WITH THEIR SPECIFIC INOCULANT PRIOR TO THEIR INTRODUCTION TO THE STIE.

  WHEN SEEDED AREAS ARE MUCHED, PLANTINGS MAY BE MADE FROM LEARLY SPRING TO EARLY OFTOGER.
  WHEN SEEDED AREAS ARE NOT MUCHED, PLANTINGS SHOULD BE MADE FROM EARLY SPRING TO MAY 20th OR FROM AUGUST THE TOTAL SPETTURES TO THE TOTAL SEEDED.

MULLIA.

A HAY, STRAW, OR OTHER MULCH, WHEN NEEDED, SHOULD BE APPLIED IMMEDIATELY AFTER SEEDING.

B. MULCH WILL BE HELD IN PLACE USING APPROPRIATE TECHNIQUES FROM THE BEST MANAGEMENT PRACTICE
FOR MULCHING. HAY OR STRAW MULCH SHALL BE PLACED AT A RATE OF 80 LBS PER 1000 S.F.

- 5. MAINTENANCE TO ESTABLISH A STAND

  A. PLANTED AREAS SHOULD BE PROTECTED FROM DAMAGE BY FIRE, GRAZING, TRAFFIC, AND DENSE WEED
- GROWTH.

  B. FERTILIZATION NEEDS SHOULD BE DETERMINED BY ONSITE INSPECTIONS. SUPPLEMENTAL FERTILIZER IS USUALLY THE KEY TO FULLY COMPLETE THE ESTABLISHMENT OF THE STAND BECAUSE MOST PERENNIALS TAKE 2 TO 3 YEARS TO BECOME FULLY ESTABLISHED.

  C. IN WANTERWAYS, CHANNELS, OR SWALES WHERE UNFORM FLOW CONDITIONS ARE ANTICIPATED, ANNUAL MOWING MAY BE NECESSARY TO CONTROL GROWTH OF WOODY VEGETATION.

USE	SEEDING MIXTURE 1/	DROUGHTY	WELL DRAINED	MODERATELY WELL DRAINED	POORLY
STEEP CUTS AND FILLS, BORROW AND DISPOSAL AREAS	A B C	FAIR POOR POOR	G00D G00D G00D	GOOD FAIR EXCELLENT	FAIR FAIR GOOD
	D	FAIR	EXCELLENT	EXCELLENT	POOR -
WATERWAYS, EMERGENCY SPILLWAYS, AND OTHER CHANNELS WITH FLOWING WATER.	Ĉ.	GOOD	GOOD EXCELLENT	GOOD EXCELLENT	FAIR FAIR
LIGHTLY USED PARKING LOTS, ODD AREAS, UNUSED LANDS, AND LOW INTENSITY USE RECREATION SITES.	A B C	G000 G000	GOOD GOOD EXCELLENT	GOOD FAIR EXCELLENT	FAIR POOR FAIR
PLAY AREAS AND ATHLETIC FIELDS. (TOPSOIL IS ESSENTIAL FOR GOOD TURF.)	E F	FAIR FAIR	EXCELLENT	EXCELLENT	2/ 2/

GRAVEL PIT, SEE NH-PM-24 IN APPENDIX FOR RECOMMENDATION REGARDING RECLAMATION OF SAND AND GRAVEL PITS.

1/ REFER TO SEEDING MIXTURES AND RATES IN TABLE BELOW.
2/ POORLY DRAINED SOILS ARE NOT DESIRABLE FOR USE AS PLAYING AREA AND ATHLETIC FIELDS.

NOTE: TEMPORARY SEED MIX FOR STABILIZATION OF TURF SHALL BE WINTER RYE OR OATS AT A RATE OF 2.5 LBS. PER 1000 S.F. AND SHALL BE PLACED PRIOR TO OCTOBER 15th, IF PERMAKENT SEEDING NOT

#### SEEDING GUIDE

PER ACRE	POUNDS PER 1.000 Sq. F
20	0.46
20	0.45
2	0.05
42	0.95
15	0.35
10	0.25
15	0.35
30	0.75
40 OR 55	0.95 OR 1.35
20	0.45
20	0.45
8	0.20
48	1.10
20	0.45
30	0.75
50	1.20
50	1.15
50	1.15
100	2.30
150	3.60
	20 20 22 42 15 10 15 15 30 40 OR 55 20 8 48 48


**SEEDING RATES** 

E-MAIL: JBE@JONESANDBEACH.COM

FAX: 603-779-0997

#### CONSTRUCTION SEQUENCE

- PRIOR TO THE START OF ANY ACTIVITY, IT IS THE RESPONSIBILITY OF THE SITE'S SITE DEVELOPER (OR OWNER) TO FILE A NOTICE OF BITENT (NOL) FORM WITH THE ENVIRONMENTAL PROTECTION AGENCY (EPA.) IN ORDER TO GAIN COVERAGE UNDER THE NPOES GENERAL PERMIT FOR STORM WATER DISCHARGES FROM CONSTRUCTION ACTIVITIES. A PRE-CONSTRUCTION MEETING IS TO BE HELD WITH ALL DEPARTMENT HEADS PRIOR TO THE START OF CONSTRUCTION MEETING IS TO BE HELD WITH ALL DEPARTMENT HEADS
- WETLAND BOUNDARIES ARE TO BE CLEARLY MARKED PRIOR TO THE START OF CONSTRUCTION.
- 3. CUT AND REMOVE TREES IN CONSTRUCTION AREA AS REQUIRED OR DIRECTED.
- INSTALL SILT FENCING, HAY BALES AND CONSTRUCTION ENTRANCES PRIOR TO THE START OF CONSTRUCTION. HIESE ARE TO BE MAINTAINED UNTIL THE FINAL PAVEMENT SURFACING AND LANDSCAPING AREAS ARE ESTABLISHED.
- CLEAR, CUT, GRUB AND DISPOSE OF DEBRIS IN APPROVED FACILITIES. THIS INCLUDES ANY REQUIRED DEMOLITION OF EXISTING STRUCTURES, UTILITIES, ETC.
- CONSTRUCT AND/OR INSTALL TEMPORARY OR PERMANENT SEDIMENT AND/OR DETENTION BASIN(S) AS REQUIRED. THESE FACILITIES SHALL BE INSTALLED AND STABILIZED PRIOR TO DIRECTING RUN-OFF TO
- STRIP LOAM AND PAVEMENT, OR RECLAIM EGISTING PAVEMENT WITHIN LIMITS OF WORK PER THE RECOMMENDATIONS OF THE PROJECT ENGINEER AND STOCKPILE EXCESS MATERIAL. STABILIZE STOCKPILE AS NECESSARY.
- PERFORM PREJAMINARY SITE GRADING IN ACCORDANCE WITH THE PLANS, INCLUDING THE CONSTRUCTION OF ANY RETAINING WALLS.
- 9. PREPARE BUILDING PAD(S) TO ENABLE BUILDING CONSTRUCTION TO BEGIN.
- INSTALL THE SEMER AND DRAINAGE SYSTEMS FIRST, THEN ANY OTHER UTILITIES IN ACCORDANCE WITH THE PLAN AND DETAILS, ANY CONFLICTS BETWEEN UTILITIES ARE TO BE RESOLVED WITH THE INVOLVEMENT AND APPROVAL OF THE ENGINEER.
- 11. INSTALL INLET PROTECTION AT ALL CATCH BASINS AS THEY ARE CONSTRUCTED IN ACCORDANCE WITH
- ALL SWALES AND DRAINAGE STRUCTURES ARE TO BE CONSTRUCTED AND STABILIZED PRIOR TO HAVING RUN-OFF DIRECTED TO THEM.
- 13. DAILY, OR AS REQUIRED, CONSTRUCT TEMPORARY BERMS, DRAINAGE DITCHES, CHECK DAMS, SEDIMENT TRAPS, ETC., TO PREVENT EROSION ON THE SITE AND PREVENT ANY SILTATION OF ABUTTING WATERS AND/OR PROPERTY.
- 14. PERFORM FINAL FINE GRADING, INCLUDING PLACEMENT OF 'SELECT' SUBGRADE MATERIALS.
- 15. PAVE ALL PARKING LOTS AND ROADWAYS WITH INITIAL "BASE COURSE".
- 16. PERFORM ALL REMAINING SITE CONSTRUCTION (Le BUILDING, CURBING, UTILITY CONNECTIONS, ETC.).
- LOAM AND SEED ALL DISTURBED AREAS AND INSTALL ANY REQUIRED SEDIMENT AND EROSION CONTROL FACILITIES (I.m. RIP RAP. EROSION CONTROL BLANKETS, ETC.).
- 18. FINISH PAVING ALL ROADWAYS AND PARKING AREAS WITH "FINISH" COURSE.
- ALL ROADWAYS AND PARKING LOTS SHALL BE STABILIZED WITHIN 72 HOURS OF ACHIEVING FINISHED GRADE.
- 20. ALL CUT AND FILL SLOPES SHALL BE SEEDED/LOAMED WITHIN 72 HOURS OF ACHIEVING FINISHED GRADE.
- 21. COMPLETE PERMANENT SEEDING AND LANDSCAPING.
- 22. REMOVE TEMPORARY EROSION CONTROL MEASURES AFTER SEEDING AREAS HAVE BEEN 75%-85% ESTABLISHED AND SITE IMPROVEMENTS ARE COMPLETE, SMOOTH AND RE-VEGETATE ALL DISTURBED AREAS.
- 23. CLEAN SITE AND ALL DRAINAGE STRUCTURES, PIPES AND SUMPS OF ALL SILT AND DEBRIS.
- 24. INSTALL ALL PAINTED PAVEMENT MARKINGS AND SIGNAGE PER THE PLANS AND DETAILS.
- 25. ALL EROSION CONTROLS SHALL BE INSPECTED WEEKLY AND AFTER EVERY HALF-INCH OF RAINFALL.
- 26. UPON COMPLETION OF CONSTRUCTION, IT IS THE RESPONSIBILITY OF THE CONTRACTOR TO NOTIFY ANY RELEVANT PERMITTING AGENCIES THAT THE CONSTRUCTION HAS BEEN FINISHED IN A SATISFACTORY MANNER.

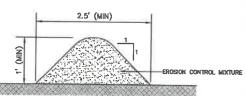

- 1. ORGANIC FILTER BERMS MAY BE UTILIZED IN LIEU OF SILT FENCE, UNLESS OTHERWISE SPECIFIED.
- THE EROSION CONTROL MIX USED IN THE FILTER BERMS SHALL BE A WELL-GRADED MIXTURE OF PARTICLE SIZES, MAY CONTAIN ROCKS LESS THAN 4" IN DIAMETER, STUMP GRINDINGS, SHEDDED OR COMPOSEDED BARK, OR ACCEPTABLE MANUFACTURED PRODUCTS, AND SHALL BE FREE OF REPUSE, PHYSICAL CONTAINANTS, AND MATERIAL TOXIC TO PLANT GROWTH, AND SHALL MEET THE FOLLOWING STANDARDS:

- THE ORGANIC CONTENT SHALL BE 80-100% OF DRY WEIGHT.
   PARTICLE SIZE BY WEIGHT SHALL BE 100% PASSING A 6" SCREEN, AND 70-85% PASSING A 0.75" SCREEN.
   THE ORGANIC PORTION SHALL BE FIBROUS AND ELONGATED.
   LARGE PORTIONS OF SILTS, CLAYS, OR FINE SANDS SHALL NOT BE INCLUDED IN THE MIXTURE.
- ORGANIC FILTER BERMS SHALL BE INSTALLED ALONG A RELATIVELY LEVEL CONTOUR. IT MAY BE NECESSARY TO CUT TALL GRASSES OR WOODY VEGETATION TO AVOID CREATING VOIDS AND BRIDGES THAT WOULD ENABLE FINES TO WASH UNDER THE BERN.
- 4. ON SLOPES LESS THAN 5%, OR AT THE BOTTOM OF SLOPES STEEPER THAN 3:1, UP TO 20' LONG, THE BERM SHALL BE A MINIMUM OF 12" HIGH (AS MEASURED ON THE UPHILL SIDE), AND A MINIMUM OF 38" WIDE. ON LONGER OR STEEPER SLOPES, THE BERM SHALL BE WIDER TO ACCOMMODATE THE POTENTIAL ADDITIONAL RUNGET.
- 5. FROZEN GROUND, OUTCROPS OF BEDROCK, AND VERY ROOTED FORESTED AREAS PRESENT THE MOST PRACTICAL AND EFFECTIVE LOCATIONS FOR ORGANIC FILTER BERMS. OTHER BRIP'S SHOULD BE USED AT LOW POINTS OF CONCENTRATOR RUNDET, BELOW CILLWEST OUTLET APRONS, AROUND CATCH BASINS, AND AT THE BOTTOM OF STEEP PERIMETER SLOPES THAT HAVE A LARGE CONTRIBUTION AREA.
- SEDIMENT SHALL BE REMOVED FROM BEHIND THE STRUCTURES WHEN IT HAS ACCUMULATED TO ONE HALF THE ORIGINAL HEIGHT OF THE STRUCTURE.
- 7. STRUCTURES MAY BE LEFT IN PLACE ONCE THE SITE IS STABILIZED.

#### **ORGANIC FILTER BERM**

NOT TO SCALE

Plan Name: EROSION AND SEDIMENT CONTROL DETAILS BAYBERRY COMMONS 19 OLD GONIC ROAD, ROCHESTER, NH

LEO P. LACOUTURE REV. TRUST & WILLIAN B. LACOUTURE Owner of Record:

SHEET 45 OF 46 JBE PROJECT NO. 21090

Design: JAC | Draft: LAZ Date: 04/29/21 Checked: JAC Scale: AS NOTED Project No. 21090
Drawing Name: 21090-PLAN.dwg THIS PLAN SHALL NOT BE MODIFIED WITHOUT WRITTEN ERMISSION FROM JONES & BEACH ENGINEERS, INC. (JBE).

ANY ALTERATIONS, AUTHORIZED OR OTHERWISE, SHALL BE


AT THE USER'S SOLE RISK AND WITHOUT LIABILITY TO JBE

LAZ BY

Designed and Produced in NH Jones & Beach Engineers, Inc.

85 Portsmouth Ave. Civil Engineering Services



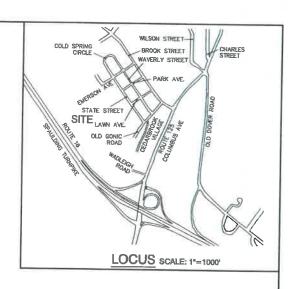

#### PHASING NOTES:

- PHASING IS MANDATORY PER NEW HAMPSIRE DEPARTMENT OF ENVIRONMENT SERVICES AND NEW HAMPSHIRE DEPARTMENT OF ENVIRONMENTAL SERVICES ALTERATION OF TERRAIN SHALL BE NOTIFIED OF ANY ALTERATION OF THE PHASING PLAN.
- 2. EACH PHASE MUST BE STABILIZED BEFORE PROCEEDING TO SUCCESSIVE PHASES.
- 3. AN ENVIRONMENTAL MONITOR SHALL BE EMPLOYED TO EVALUATE THE SITE DURING CONSTRUCTION.
- 4. AREAS MUST BE STABILIZED PRIOR TO WINTER CONSTRUCTION SEASON FROM OCTOBER 15 THROUGH MAY 15 PURSUANT TO Env-Wq 1505.08 (1 AC OPEN) UNLESS A WINTER CONSTRUCTION/STABILIZATION PLAN IS SUBMITTED AND APPROVED.

#### PHASING SCHEDULE:

PHASE 1

CONSTRUCT: BAYBERRY LANE
ALL BUILDINGS FRONTING ON BAYBERRY LANE
ALL PONDS

PHASE 2 3.4 AC

CONSTRUCT: APPLECREST LANE
ALL BUILDINGS FRONTING ON APPLECREST LANE

PHASE 3 4.0 ACRES

CONSTRUCT: HAWTHORNE CIRCLE AND WINTERBERRY LANE
ALL BUILDINGS PRONTING ON HAWTHORNE CIRCLE AND
WINTERBERRY LANE.

PROJECT PARCEL CITY OF ROCHESTER TAX MAP 181, LOT 1

APPLICANT GREEN AND COMPANY 11 LAFAYETTE ROAD NORTH HAMPTON, NH 03862

TOTAL LOT AREA 1,309,695 SQ, FT. ± 30.07 ACRES ±

Design: JAC Draft LAZ Date: 04/29/21
Checked: JAC Scale: AS NOTED Project No.: 21090
Drawing Name: 21090-PLAN.dwg

THIS PLAN SHALL NOT BE MODIFIED WITHOUT WRITTEN PERMISSION FROM JONES & BEACH ENGINEERS, INC. (JBE). ANY ALTERATIONS, AUTHORIZED OR OTHERWISE, SHALL BE AT THE USER'S SOLE RISK AND WITHOUT LIABILITY TO JBE.



_			
1	1/18/22	REVISED PER CITY COMMENTS	LAZ
0	11/23/21	ISSUED FOR REVIEW	LAZ
REV.	DATE	REVISION	BY

## Designed and Produced in NH B Jones & Beach Engineers, Inc.

85 Portsmouth Ave. Civil Engineering Services
PO Box 219
Stratham. NH 03885
E-MAIL: JBE@J Services 603-772-4746 FAX: 603-772-0227 E-MAIL: JBE@JONESANDBEACH.COM

Plan Name:	PHASING PLAN
Project:	BAYBERRY COMMONS 19 OLD GONIC ROAD, ROCHESTER, NH
Owner of Record:	LEO P. LACOUTURE REV. TRUST & WILLIAN B. LACOUTURE 19 OLD GONIC RD., ROCHESTER, NH 03867 BK 4093 PG 148

GRAPHIC SCALE

( IN FEET )

SHEET 46 OF 46 JBE PROJECT NO. 21090