

85 Portsmouth Avenue, PO Box 219, Stratham, NH 03885 603.772.4746 - JonesandBeach.com

March 9, 2022


Rochester Planning Board Attn. Nel Sylvian 31 Wakefield Street Rochester, NH 03867

RE: Waiver Request

19 Old Gonic Road, Rochester, NH

Tax Map 131, Lot 1 JBE Project No. 21090

Dear Mr. Sylvian,

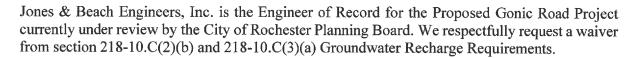

Using multiple stormwater management technologies, we have been able to decrease the post development peak stormwater discharge to be less than the Existing Conditions flow. This is required by both the City and the State Alteration of Terrain bureau, however, we have not been able to also decrease the total volume of stormwater exiting the site. The only way to decrease stormwater volume is through infiltration into existing soil. This site has largely Group C and D soils with very low Ksat values (listed below), which do not infiltrate stormwater well, if at all. Test pits performed on the site have also revealed large areas of ledge and a high water table.

A Site Specific Soil Survey was performed and the soil types found the subject parcel include Hollis-Rock Outcrop-Chatfield Complex (Hydrologic Soil Group D), Eldridge Loamy Sand (HCG C) and Scituate Fine Sand Loam (HSG C) on the majority of the site with areas of Boxford (somewhat poorly drained) (HSG C), occurring along the perimeter and Squamscott loamy sand (HSG C) occurring in mapped wetland areas.

According to "Ksat Values for New Hampshire Soils" sponsored by the Society of Soil Scientists of Northern New England SSSNNE Special Publication No. 5, the saturated hydraulic conductivity (Ksat) values of these soils are as follows:

Hollis Rock Outcrop -0.6-6.0 in/hour in the B horizon; 0.6-6.0 in/hour in the C horizon Eldridge -2.0-6.0 in /hr in the B horizon; 0-0.2 in/hr in the C horizon Scituate -0.6-2.0 in/hour in the B horizon; 0.06-0.2 in/hour in the C horizon Boxford -0.1-0.2 in/hour in the B horizon; 0-0.2 in/hour in the C horizon. Squamscott -6.0-20.0 in/hour in the B horizon; 0.06-0.6 in/hour in the C horizon.

Because of the presence of ledge and a high water table we have decided to utilize Wet Ponds located in three locations around the site for stormwater treatment and storage Wet ponds are designed have some water in them at all times so will not infiltrate the stormwater at all. We are unable to infiltrate stormwater to reduce the total volume leaving the site to the level that exists in existing conditions. This condition is typical of all sites that have poor soils that can't infiltrate.

The site has approximately 2,000 feet of frontage along Axe Handle Brook, which abuts the property. Stormwater from the majority of the project flows to this Brook. There is an existing dam along Axe Handle Brook located southeasterly of the sites site's brook frontage. The three wet ponds located on the site will outlet above this dam. The dam spillway controls flow in the brook which aids in protecting against adverse impacts to downstream properties, infrastructure, aquatic habitat, or water quality degradation in downstream water bodies.

We will also be requesting a waiver from the same Alternation of Terrain requirement for Groundwater Recharge when we apply for that permit. AoT has historically granted these waivers on sites with similar soil conditions.

Thank you very much for your time.

Very truly yours,
JONES & BEACH ENGINEERS, INC.

Joseph Coronati

Joseph Coronati Vice President

cc: Green & Company (via email)
John O'Neil (via email)
Jim Gove, Gove Environmental Services (via email)
Steve Pernaw, Traffic Consultant (via email)
John Sykora, Weston & Sampson (via email)
Chris Berg, Wright-Pierce (via email)





P.O. Box 1721 • Concord, NH 03302 tel: (603) 731-8500 • fax: (866) 929-6094 • sgp@ pernaw.com

Transportation: Engineering • Planning • Design

MEMORANDUM

Ref:

2112A

To:

Michael Green Green & Company

From:


Stephen G. Pernaw, P.E., PTOE

Subject: Proposed Residential Development

Rochester, New Hampshire

Date:

March 14, 2022

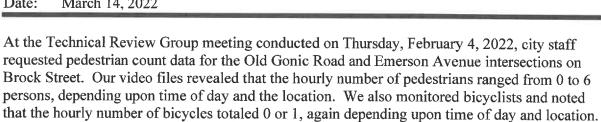

The attached diagrams depict the various travel patterns and frequency of these events at these

intersections.


Attachments

CC: Joseph Coronati, Jones & Beach Engineers, Inc.

CALCULATION SHEET



Project:	Res - Rochester	Job Number:	2112A
Calculated By:	CA	Date:	3/10/2022
Checked By:	SP	Date:	3/10/2022
Sheet No:	11	Of:	1

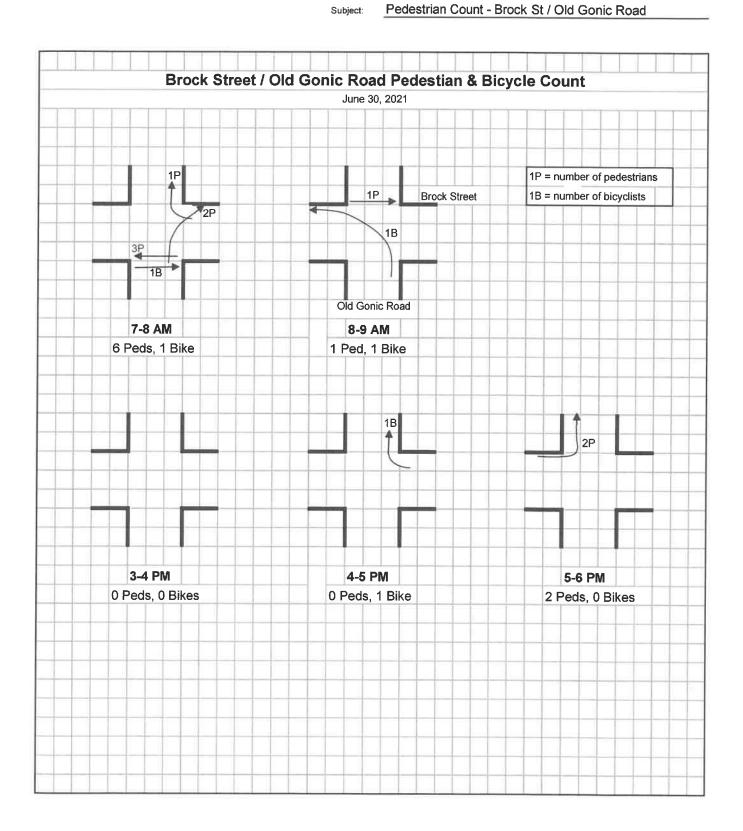


CALCULATION SHEET

	/	\	
/	Δ		
_/	Δ		_
Stanhan G	Dornew	& Company	Inc

Project:	Res - Rochester	Job Number:	2112A
Calculated By:	CA	Date:	3/10/2022
Checked By:	SP	Date:	3/10/2022
Sheet No:	1	Of:	1
Sheet No:	1	Of:	1

Subject: Pedestrian Count - Brock St / Emerson Avenue

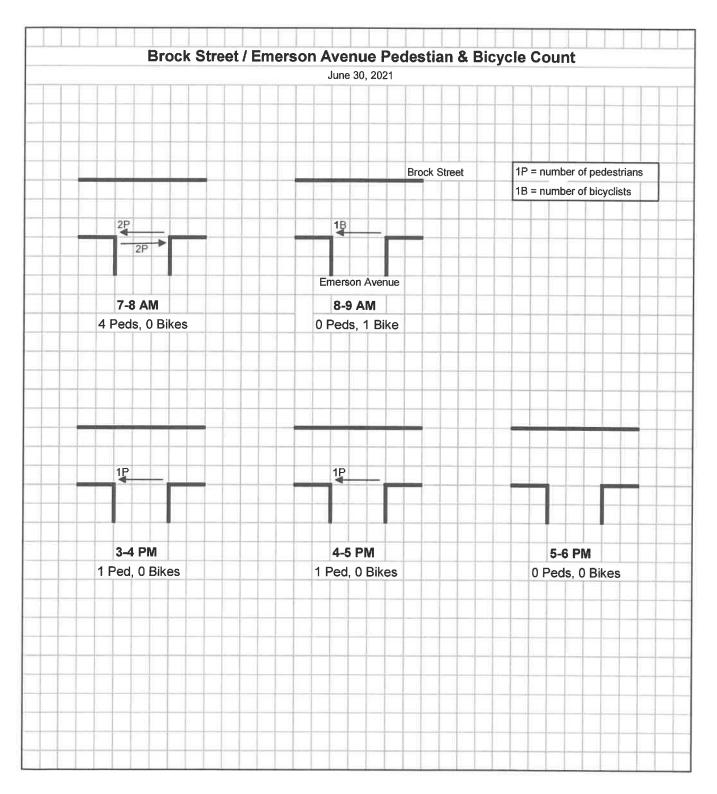



85 Portsmouth Avenue, PO Box 219, Stratham, NH 03885 603.772.4746 - JonesandBeach.com

March 9, 2022

Rochester Planning Board Attn. Nel Sylvian 31 Wakefield Street Rochester, NH 03867

RE: Response Letter

19 Old Gonic Road, Rochester, NH

Tax Map 131, Lot 1 JBE Project No. 21090

Dear Mr. Sylvian,

We are in receipt of comments from Ryan O'Connor, Conservation Commission who had no additional comments. We are also in receipt of comments from Theresa Hervey, Town Assessing Department, Gary Boudreau, Rochester Police Department and from Dana Webber dated March 1, 2022. Review comments are listed below with our responses in bold.

ASSESSING DEPARTMENT COMMENTS:

1. At the first TRG on 12/2/2021 I had said this parcel had 30.07 acres. I want to clarify that we have this parcel at 35.00 acres in our database and on the tax maps.

RESPONSE: The actual survey is coming up at approximately 30.07 acres.

2. This parcel is all in Current Use except for 1 acre. When the lot is cut and stumped, a Land Use Change Tax bill will be issued to the owner. If there is 10 acres or more of Current Use Land that is undisturbed, we will need a new Current Use Map before Planning approves the plan! I will email Joseph Coronati a copy of the Current Use Map we have on file, so he can see where the land is located that was not in Current Use. I noticed on the Preliminary Site Plan Application (4/27/21) that the acreage of the lot is stated 31.53 acres, but the most recent plan that was submitted (2/15/22) says 30.07 acres. Please confirm the acreage of the lot.

RESPONSE: As we move closer to final plans, we see if we still have 10+ acres that we can leave in current use. The design has been changing over the last couple of months based on comments

POLICE DEPARTMENT COMMENTS:

 Move one-way signs closer to State St., waiting on traffic review
 RESPONSE: The one way signs are located at State Street and Old Gonic Road intersection.

DPW COMMENTS:

1. Traffic Review by 3rd party to be complete by 3/11

RESPONSE: No comment

2. Provide pedestrian safety analysis. Old Gonic may be a walking route and does not have sidewalks currently.

RESPONSE: The pedestrian safety analysis will be provided by Steve Pernaw.

3. Extend pavement at the end of Old Gonic to provide a turnaround area within ROW for plows.

RESPONSE: The pavement has been extended at the end of Old Gonic Road.

4. Relocate existing hydrant at end of Old Gonic to location close to intersection with State St. The water main beyond the last service at the corner of State St can be abandoned after existing house is demolished.

RESPONSE: The existing hydrant has been relocated and the water main beyond the last service at the corner of State Street is noted to be abandoned.

5. Provide details for sidewalk, concrete tip downs and cast-iron detector plates. DPW will provide examples if needed.

RESPONSE: The above details have been provided on Sheet D1.

6. Provide striping plan for the project and offsite improvements including intersection of Brock and Emerson for bypass shoulder proposed.

RESPONSE: Road striping for the Site is called out on the Site Plan Sheets as Single Solid While Lines (SSWL). On the Offsite Plans, a note has been added to the Offsite Site Plan 3 to indicate that the existing lane striping is to remain on Brock Street. There is no other road striping proposed.

7. City standard crosswalk striping is continental style.

RESPONSE: The crosswalk striping has been revised to be Continental style crosswalk striping. A detail has been added to Sheet D1.

8. 3rd party stormwater review of responses is ongoing.

RESPONSE: No comment

9. Resubmit waiver request for stormwater with more explanation of technical need and justification as well as analysis of impact to downstream water bodies and properties.

RESPONSE: The stormwater waiver is included with this submission which adds more explanation of technical needs and justification as well as analysis of impact to downstream water bodies and properties

10. To promote one way exit only at the Old Gonic Rd access, narrow the exit drive to single lane.

RESPONSE: The exit drive is now reduced down to a single lane.

11. Sewer capacity impacts are being reviewed by City staff including 3rd party capacity impact memo

RESPONSE: No response.



Included with this response letter are the following:

- 1. Three (3) Full Size Plan Sets.
- 2. Sixteen (16) 11x17 Plan Sets (Folded).
- 3. 3 Traffic Impact Analysis
- 4. Revised Architectural Plans.
- 5. Stormwater Waiver

Thank you very much for your time.

Very truly yours, JONES & BEACH ENGINEERS, INC.

Joseph Coronati


Joseph Coronati Vice President

cc: Green & Company (via email)
John O'Neil (via email)
Jim Gove, Gove Environmental Services (via email)
Steve Pernaw, Traffic Consultant (via email)
John Sykora, Weston & Sampson (via email)
Chris Berg, Wright-Pierce (via email)



GENERAL LEGEND SPOT GRADE PAVEMENT SPOT GRADE 99.50 x 100.00 99.50 TREES AND BUSHES UTILITY POLE LIGHT POLES DRAIN MANHOLE SEWER MANHOLE WETLAND IMPACT XXXXX OPEN WATER 0 0 FRESHWATER WETLANDS **** TIDAL WETLANDS STABILIZED CONSTRUCTION GRAVEL

PROPOSED SITE PLAN "BAYBERRY COMMONS" TAX MAP 131, LOT 10 19 OLD GONIC ROAD, ROCHESTER, NH

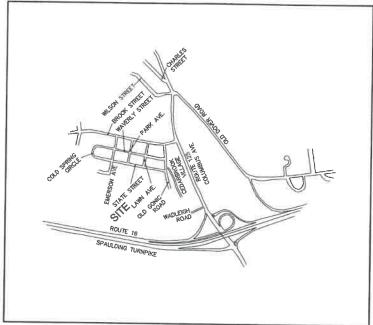

LOCUS MAP SCALE 1" = 2000'

CIVIL ENGINEER / SURVEYOR
JONES & BEACH ENGINEERS, INC.
85 PORTSMOUTH AVENUE
PO BOX 219
STRATHAM, NH 03885
(603) 772-4746
CONTACT: JOSEPH CORONATI
EMAIL: JCORONATI@JONESANDBEACH.COM

TRAFFIC ENGINEER
STEPHEN G. PERNAW & COMPANY, INC.
P.O. BOX 1821
CONCORD, NH 03302
(603) 731-8500
CONTACT: STEPHEN G. PERNAW
EMAIL: SGP@PERNAW.COM

WETLAND CONSULTANT
GOVE ENVIRONMENTAL SERVICES, INC.
8 CONTINENTAL DR., BUILDING 2, UNIT H
EXETER, NH 03833-7526
(603) 778-0644
CONTACT: JAMES GOVE
EMAIL: JGOVE@GESINC.BIZ

LANDSCAPE DESIGNER

LM LAND DESIGN, LLC
11 SOUTH ROAD
BRENTWOOD, NH 03833
(603) 770-7728
CONTACT: LISE McNAUGHTON
LMLANDDESIGN@GMAIL.COM

WATER AND SEWER
ROCHESTER DEPARTMENT OF PUBLIC WORKS
45 OLD DOVER ROAD
ROCHESTER, NH 03867
(603) 332-4096
CONTACT: MICHAEL BEZANSON, P.E.

ELECTRIC
EVERSOURCE ENERGY
74 OLD DOVER ROAD
ROCHESTER, NH 03867
(603) 555-5334
CONTACT: MARK BOUCHER

SHEET INDEX

S COVER SHEET

OVEX EXISTING CONDITINS OVERVIEW PLAN

C1-C4 EXISTING CONDITIONS PLAN

DM1 DEMOLITION PLAN

OVRS OVERVIEW SITE PLAN

C5-C8 SITE PLANS

OVRG OVERVIEW GRADING PLAN

C9-C11 GRADING AND DRAINAGE PLAN

OVRU OVERVIEW UTILITY PLAN

U1-U2 UTILITY PLAN

1-L2 LANDSCAPE PLAN

3-L4 LIGHTING PLAN

P1-P6 ROAD PLAN AND PROFILE

-P10 SEWER PROFILE

DFF-1-5 OFFSITE IMPROVEMENT PLANS

D1-D4 DETAIL SHEETS

ET EROSION AND SEDIMENT CONTROL DETAILS

PH PHASING PLAN

1

PROJECT PARCEL
CITY OF ROCHESTER
TAX MAP 131, LOT 10

APPLICANT
GREEN AND COMPANY
11 LAFAYETTE ROAD
NORTH HAMPTON, NH 03862

TOTAL LOT AREA 1,309,695 SQ. FT. ± 30.07 ACRES ±

APPROVED - ROCHESTER, NH PLANNING BOARD

DATE:

Design: JAC Draft: LAZ Date: 04/29/21
Checked: JAC Scale: AS NOTED Project No.: 21090
Drawing Name: 21090-PLAN.dwg

THIS PLAN SHALL NOT BE MODIFIED WITHOUT WRITTEN PERMISSION FROM JONES & BEACH ENGINEERS, INC. (JBE). ANY ALTERATIONS, AUTHORIZED OR OTHERWISE, SHALL BE AT THE USER'S SOLE RISK AND WITHOUT LIABILITY TO JBE.



3	3/11/22	REVISED PER CITY COMMENTS	LAZ
2	2/14/22	REVISED PER CITY ENGINEERING COMMENTS	LAZ
1	1/18/22	REVISED PER CITY COMMENTS	LAZ
0	11/23/21	ISSUED FOR REVIEW	LAZ
REV.	DATE	REVISION	BY



TELEPHONE

(603) 427-5525

CABLE TV

(603) 679-5695

NATURAL GAS

325 WEST ROAD

(603) 294-5261

UNITIL SERVICE CORP.

PORTSMOUTH, NH 03801

MACLEAND@UNITIL.COM

1575 GREENLAND ROAD

CONTACT: JOE CONSIDING

GREENLAND, NH 03840

334-B CALEF HIGHWAY

EPPING, NH 03042-2325

CONSOLIDATED COMMUNICATIONS

COMCAST COMMUNICATION CORPORATION

85 Ponsmouth Ave. Civil Engineering Services 603-772-4746
PO Box 219 FAX: 603-772-0227
Stratham, NH 03885 E-MAIL: JBE@JONESANDBEACH.COM

Plan Name:

Project:

COVER SHEET

BAYBERRY COMMONS
19 OLD GONIC ROAD, ROCHESTER, NH
LEO P. LACOUTURE REV. TRUST & WILLIAN B. LACOUTURE
19 OLD GONIC RD., ROCHESTER, NH 03867 BK 4093 PG 146

CS SHEET 1 OF 46

46 1090



1 1/18/22 REVISED PER CITY COMMENTS 0 11/23/21 ISSUED FOR REVIEW REV. DATE

ANY ALTERATIONS, AUTHORIZED OR OTHERWISE, SHALL BE

IT THE USER'S SOLE RISK AND WITHOUT LIABILITY TO JBE.

85 Portsmouth Ave. Civil Engineering Services FAX: 603-772-0227 E-MAIL: JBE@JONESANDBEACH.COM PO Box 219

LAZ


BY

603-772-4746

BAYBERRY COMMONS 19 OLD GONIC ROAD, ROCHESTER, NH Project:

LEO P. LACOUTURE REV. TRUST & WILLIAN B. LACOUTURE 19 OLD GONIC RD., ROCHESTER, NH 03867 BK 4093 PG 148 Owner of Record:


OVR SHEET 2 OF 46 JBE PROJECT NO. 21090

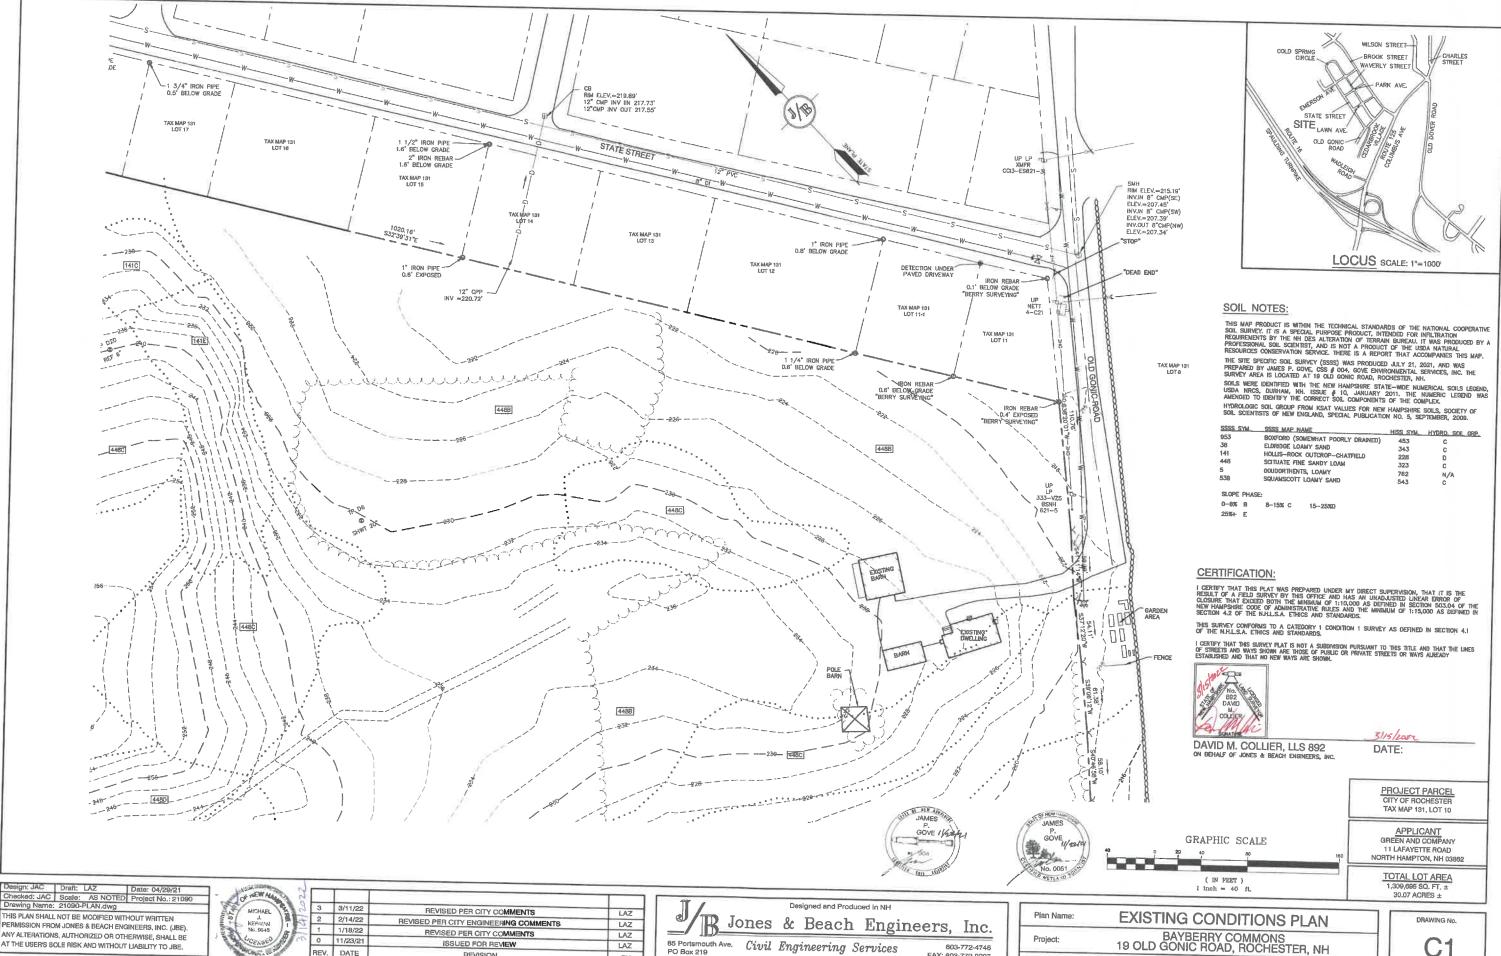


ISSUED FOR REVIEW DATE REVISION BY

85 Portsmouth Ave. Civil Engineering Services PO Box 219 Stratham, NH 03885 E-MAIL: JBE@JONESANDBEACH.COM SHEET 3 OF 46

LEO P. LACOUTURE REV. TRUST & WILLIAN B. LACOUTURE 19 OLD GONIC RD., ROCHESTER, NH 03867 BK 4093 PG 148

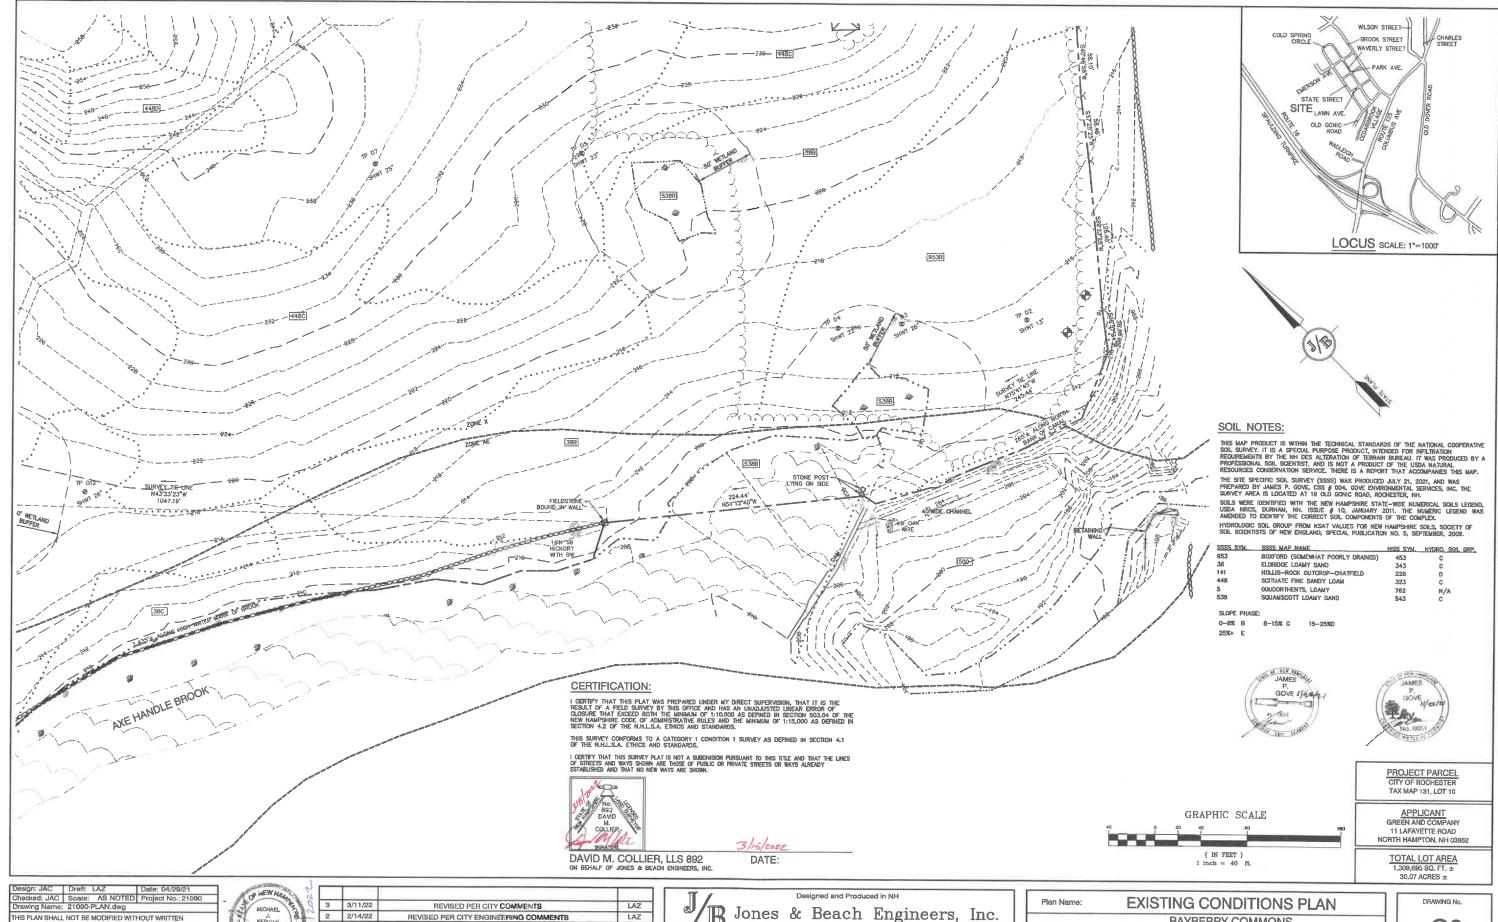

HIS PLAN SHALL NOT BE MODIFIED WITHOUT WRITTEN ERMISSION FROM JONES & BEACH ENGINEERS, INC. (JBE). ANY ALTERATIONS, AUTHORIZED OR OTHERWISE, SHALL BE AT THE USER'S SOLE RISK AND WITHOUT LIABILITY TO JBE.

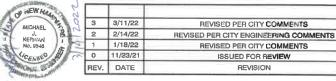

Jones & Beach Engineers, Inc.

85 Portsmouth Ave. Civil Engineering Services
PO Box 219
Stratham, NH 03885
E-MAIL: JBE@ 603-772-4746 FAX: 603-772-0227 E-MAIL: JBE@JONESANDBEACH.COM


LAZ

LAZ


BY

Plan Name:	EXISTING CONDITIONS PLAN
Project:	BAYBERRY COMMONS 19 OLD GONIC ROAD, ROCHESTER, NH
Owner of Record:	LEO P. LACOUTURE REV. TRUST & WILLIAN B. LACOUTURE 19 OLD GONIC RD., ROCHESTER, NH 03867 BK 4093 PG 148

C2 SHEET 4 OF 46 JBE PROJECT NO. 21090

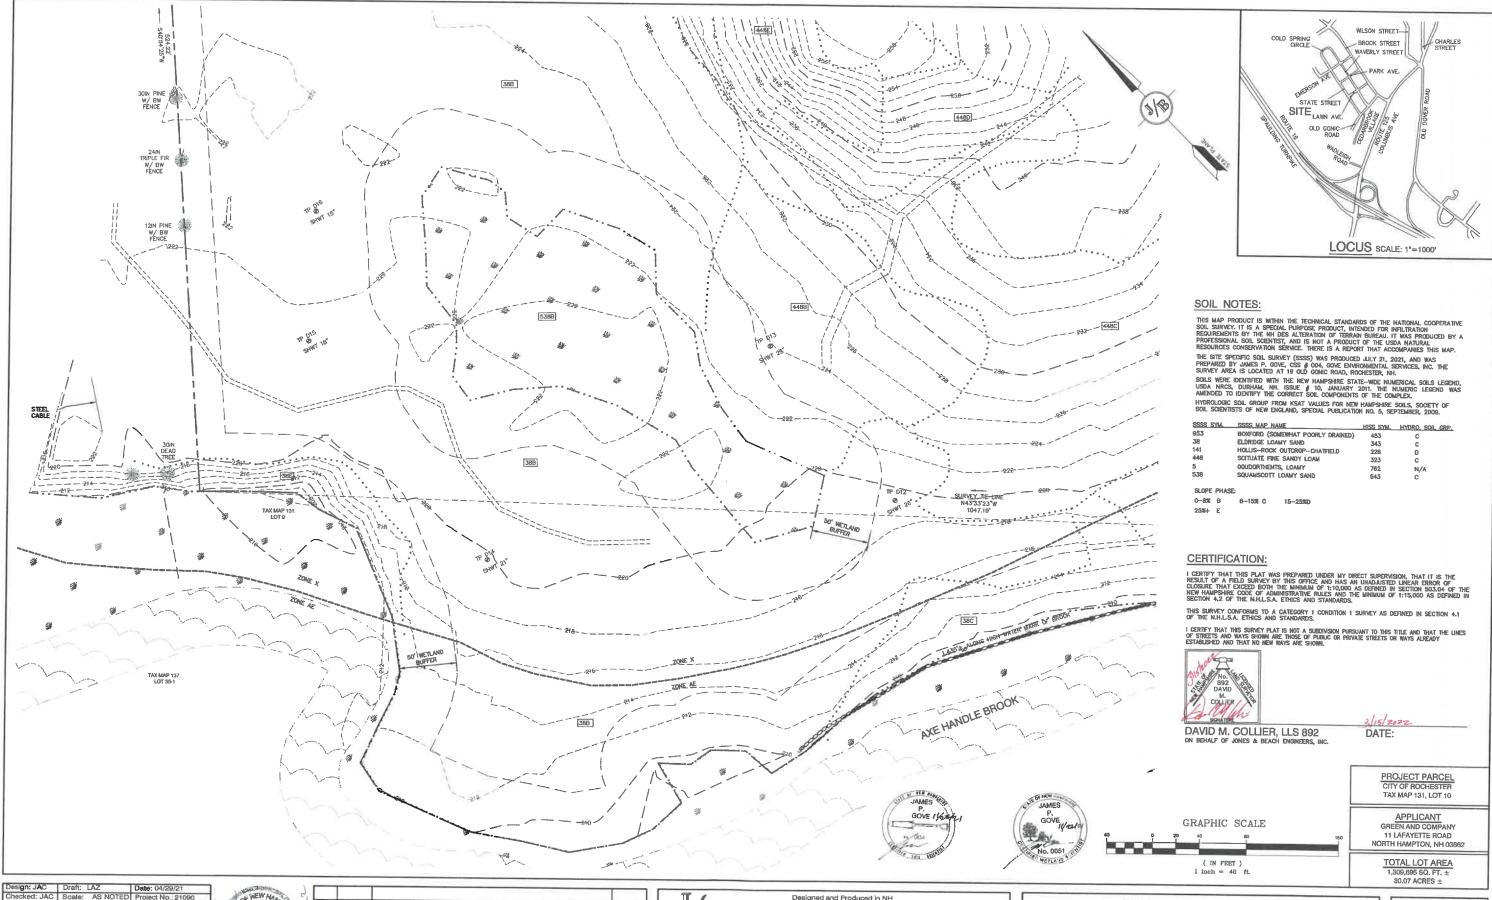

Design: JAC Draft: LAZ Date: 04/29/21
Checked: JAC Scale: AS NOTED Project No.: 21090
Drawling Name: 21090-PLAN.dwg
THIS PLAN SHALL NOT BE MODIFIED WITHOUT WRITTEN
PERMISSION FROM JONES & BEACH ENGINEERS, INC. (JBE).
ANY ALTERATIONS, AUTHORIZED OR OTHERWISE, SHALL BE
AT THE USER'S SOLE RISK AND WITHOUT LIABILITY TO JBE.

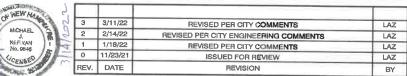

Jones & Beach Engineers, Inc.

85 Portsmouth Ave. PO Box 219
Stratham, NH 03885


Civil Engineering Services

603-772-4746
FAX: 603-772-0227
E-MAIL: JBE@JONESANDBEACH.COM


Plan Name:	EXISTING CONDITIONS PLAN
Project:	BAYBERRY COMMONS 19 OLD GONIC ROAD, ROCHESTER, NH

SHEET 5 OF 46 JBE PROJECT NO. 21090

Owner of Record: LEO P. LACOUTURE REV. TRUST & WILLIAN B. LACOUTURE 19 OLD GONIC RD., ROCHESTER, NH 03867 BK 4093 PG 148

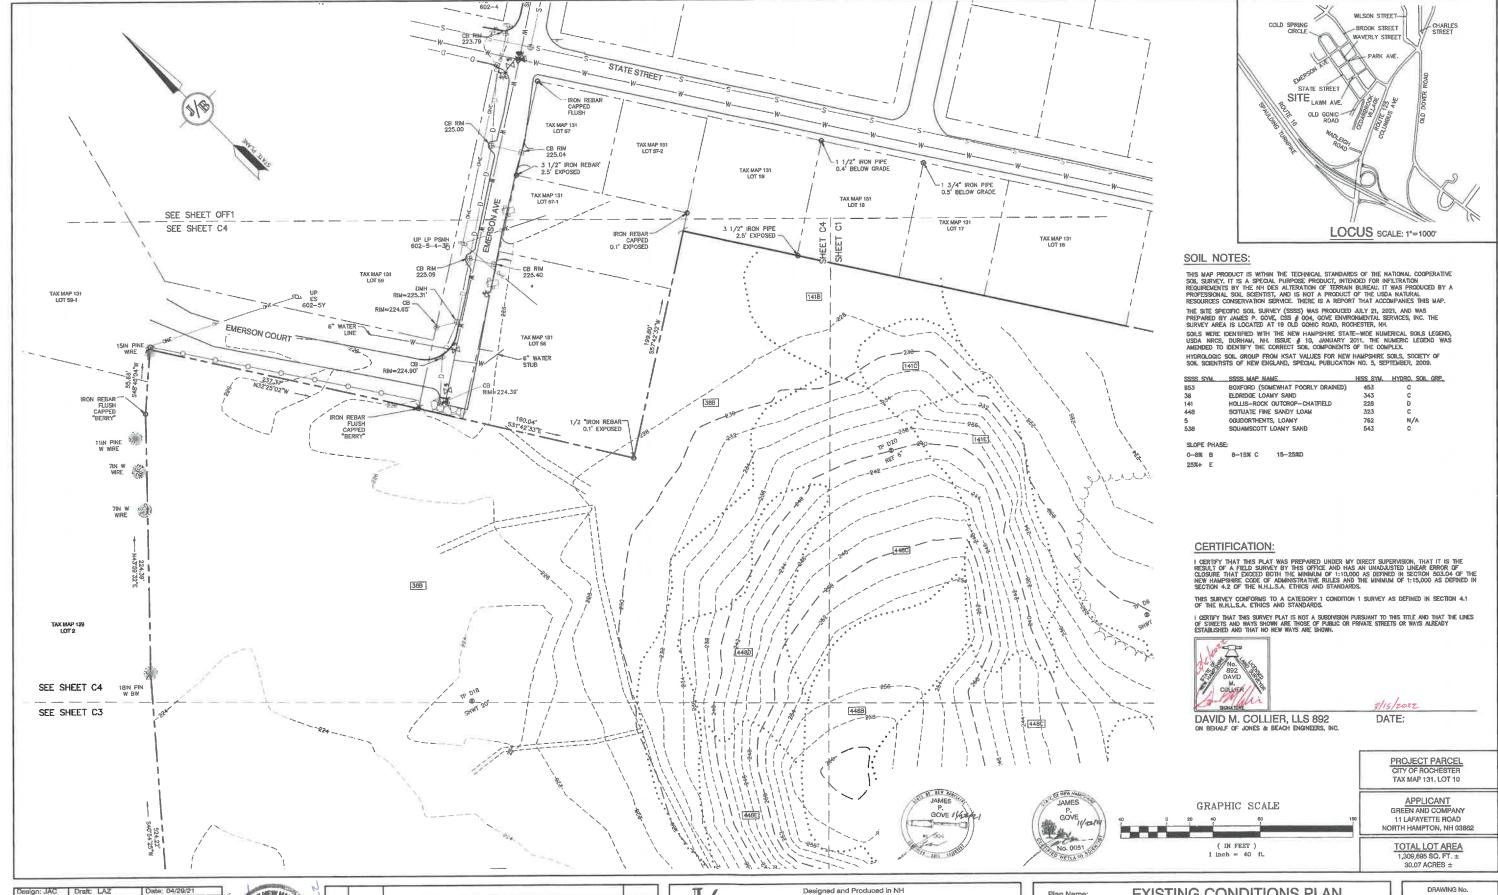

Design: JAC	Draft: LAZ	Date: 04/29/21
Checked: JAC	Scale: AS NOTED	Project No.: 21090
Drawing Name:	21090-PLAN.dwg	
THIS PLAN SHALL	NOT BE MODIFIED WIT	HOUT WRITTEN
PERMISSION FRO	M JONES & BEACH EN	GINEERS, INC. (JBE).
ANY ALTERATION	S, AUTHORIZED OR OT	HERWISE, SHALL BE
AT THE USER'S S	OLE RISK AND WITHOU	T LIABILITY TO JBE.

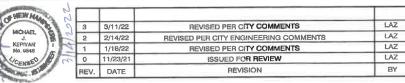

Jones & Beach Engineers, Inc. 603-772-4746 FAX: 603-772-0227

85 Portsmouth Ave. Civil Engineering Services
PO Box 219
Stratham, NH 03885 E-MAIL: JBE@ E-MAIL: JBE@JONESANDBEACH.COM

Plan Name:	EXISTIN

NG CONDITIONS PLAN

BAYBERRY COMMONS 19 OLD GONIC ROAD, ROCHESTER, NH Project:

LEO P. LACOUTURE REV. TRUST & WILLIAN B. LACOUTURE 19 OLD GONIC RD., ROCHESTER, NH 03867 BK 4093 PG 148 Owner of Record:

SHEET 6 OF 46 JBE PROJECT NO. 21090



DEMOLITION NOTES:

- 1. THIS PLAN IS INTENDED TO PROVIDE MINIMUM GUIDELINES FOR SITE DEMOLITION, IT SHOULD BE NOTED THAT ALL MANMADE FEATURES, PAYEMENT, SIGNS, POLES, CURBING, CONCRETE WALKS, UTILITIES, ETC., SHALL BE REMOVED AS NECESSARY TO CONSTRUCT WORK, UNLESS OTHERWISE NOTED TO REMAIN, THROUGHOUT THE CONSTRUCTION PROCESS, THE CONTRACTOR SHALL INFORM THE ENGINEER IMMEDIATELY OF ANY FIELD DISORDEPANCES FROM DATA AS SHOWN ON DESIGN PLANS. THIS INCLUDES ANY UNPORESEEN CONDITIONS, SUBSURFACE OR OTHERWISE FOR EVALUATION AND RECOMMENDATIONS, ANY CONTRACTION BETWEEN ITEMS OF THIS PLAN/PLAN SET, OR BETWEEN THE PLANS AND ON-SITE CONDITIONS MUST BE RESOLVED BEFORE RELATED CONSTRUCTION HAS BEEN INITIATED.
- A TEMPORARY CULVERT AND ROADBED SHALL BE IN PLACE PRIOR TO ANY USE OF A WETLAND CROSSING.
- WETLAND IMPACTS SHALL NOT OCCUR UNTIL ALL PERMITS HAVE BEEN ACQUIRED AND IMPACT MITIGATION REQUIREMENTS HAVE BEEN SATISFIED.
- 4. PRIOR TO THE START OF CONSTRUCTION, THE CONTRACTOR IS REQUIRED TO HAVE THE PROJECT LAND SURVEYOR STAKE OR PLAG CLEARING LIMITS. A MINIMUM OF 43 HOURS NOTICE IS REQUIRED CLEARING LIMITS ARE THE EDGE OF THE PROPERTY AND THE LIMITS OF WORK.
- ALL EXISTING STRUCTURES WITHIN THE CONSTRUCTION AREA, UNLESS OTHERWISE NOTED TO REMAIN SHALL BE REMOVED AND DISPOSED OF OFF-SITE IN ACCORDANCE WITH ALL LOCAL, STATE AND FEDERAL GUIDELINES. ANY SURRING ON-SITE SHALL BE SUBJECT TO LOCAL ORDINANCES.
- ALL EXISTING PAYED SURFACES WITHIN THE LIMITS OF WORK THAT ARE TO REMAIN SHALL BE RECLAIMED TO MINIMUM DEPTH OF 12" AND REGRADED AS SHOWN ON THE GRADING AND DRAINAGE PLAIN, RECLAIMED ASPHALT SHALL CONFORM TO STATE SPECIFICATIONS, FRIOR TO REMOVAL, PAYEMENT SHALL BE SAWOUT AT ALL ENTRANCES AND LIMITS OF REMOVAL.
- ALL EMSTING GRANITE CURBING TO BE REMOVED SHALL BE STOCKPILED IN AN AREA TO BE DESIGNATED BY THE OWNER OR OWNER'S REPRESENTATIVE. THE OWNER SHALL INSPECT GRANITE CURBING TO BE RESET AND APPROVE LOCATION OF RESET CURBING. THE CONTRACTOR SHALL NOT INSTALL USED CURBING AT ANY ENTRANCE LOCATIONS.
- 8. ALL EXISTING UTILITIES SHALL BE TERMINATED AT THE PROPERTY LINE, UNLESS OTHERWISE NOTED ON THE PLANS, IN CONFORMANCE WITH LOCAL, STATE AND UTILITY COMPANY STRUDARDS. SPECIFICATIONS AND DETAILS. THE CONTRACTOR SHALL COORDINATE UTILITY SERVICE DISCONNECTS WITH THE UTILITY REPRESENTATIVES PROPE TO THE STATE? OF WITH STATE OF WITH THE STATE OF WITH T
- 9. EXISTING WATERLINES AND HYDRANTS TO BE REMOVED SHALL BE CAPPED AT EXISTING WATERMAIN.
- EXISTING GAS SERVICE LINES ARE TO BE REMOVED ON—SITE UP TO EXISTING GASMAIN LINES OR VALVES.
- THE CONTRACTOR SHALL REMOVE AND PROPERLY DISPOSE OF ALL CONTAMINATED MATERIAL LOCATED IN THE AREA OF EXISTING LEACHFIELDS IN ACCORDANCE WITH LOCAL AND STATE REGULATIONS.
- ALL CURBING, CONCRETE, PAVEMENT, BUILDINGS AND SUBBASE MATERIALS LOCATED WITHIN PROPOSED LANDSCAPED AREAS SHALL BE REMOVED AND REPLACED WITH LOAM MATERIALS SUITABLE FOR LANDSCAPING IN ACCORDANCE WITH TECHNICAL SPECIFICATIONS. (SEE ALSO LANDSCAPE PLAN).
- 13. SEE LANDSCAPE PLAN FOR "TREES TO BE SAVED" AND DETAILS ASSOCIATED WITH LANDSCAPED AREAS.
- THE CONTRACTOR SHALL OBTAIN TREE CLEARING PERMIT FROM LOCAL AND STATE AUTHORITIES PRIOR TO START OF CONSTRUCTION (IF REQUIRED).
- CONTRACTOR SHALL HAVE THE OPTION TO REMOVE DRAINAGE/SEWER STRUCTURES, OR REMOVE MANHOLE FRAME AND GRATE/COVER TO A MINIMUM OF 38" BELOW FINISH GRADE, FRACTURE BOTTOM AND FILL WITH COMPACTED BORROW.
- 16. IN AREAS WHERE CONSTRUCTION IS PROPOSED ADJACENT TO ABUITING PROPERTIES, THE CONTRACTOR SHALL INSTALL ORANGE CONSTRUCTION FENDING ALONG PROPERTY LINES IN ALL AREAS WHERE SLIT FENDING IS NOT REQUIRED.
- EMSTING SANITARY SEWER LINE AND STRUCTURES LOCATED WITHIN THE EQISTING SEWER EASEMENTS
 SHALL BE MAINTAINED OR MODIFIED AS NOTED ON PLANS. SEWER LINES SHALL BE DISCONNECTED II
 ACCORDANCE WITH LOCAL STANDARDS AND REGULATIONS.
- 18. EROSION AND SEDIMENTATION CONTROL MEASURES SHALL BE INSTALLED PRIOR TO CONSTRUCTION AND ANY EARTH MOVING OPERATIONS. SILT FENCE SHALL BE INSTALLED AT THE LIMITS OF IMPACT AREAS ACCORDING TO THE DETAILS SHOWN ON SHEET EI.
- EXCAVATED MATERIALS WILL BE PLACED WITHIN UPLAND AREAS AS FILL MATERIAL OR HAULED OFF-SITE FOR DISPOSAL IN AN APPROPRIATE UPLAND LOCATION.

CITY OF ROCHESTER TAX MAP 131, LOT 10

APPLICANT GREEN AND COMPANY 11 LAFAYETTE ROAD NORTH HAMPTON, NH 03862

> TOTAL LOT AREA 1,309,695 SQ. FT. ± 30.07 ACRES ±

Design: JAC Draft: LAZ Date: 04/29/21
Checked: JAC Scale: AS NOTED Project No.: 21090
Drawing Name: 21090-PLAN.dwg
THIS PLAN SHALL NOT BE MODIFIED WITHOUT WRITTEN
PERMISSION FROM JONES & BEACH ENGINEERS, INC. (JBE).
ANY ALTERATIONS, AUTHORIZED OR OTHERWISE, SHALL BE
AT THE USER'S SOLE RISK AND WITHOUT LIABILITY TO JBE.



1			
3	3/11/22	REVISED PER CITY COMMENTS	LAZ
2	2/14/22	REVISED PER CITY ENGINEERING COMMENTS	LAZ
1	1/18/22	REVISED PER CITY COMMENTS	LAZ
0	11/23/21	ISSUED FOR REVIEW	LAZ
REV.	DATE	REVISION	BY

Jones & Beach Engineers, Inc.

85 Portsmouth Ave. Civil Engineering Services 603-772-4748
PO Box 219
Stratham, NH 03885
603-772-0227
E-MAIL: JBE@JONESANDBEACH.COM


Plan	Name:	DEMOLITION PLAN
Proj	ect:	BAYBERRY COMMONS 19 OLD GONIC ROAD, ROCHESTER, NH
Owr	er of Record:	LEO P. LACOUTURE REV. TRUST & WILLIAN B. LACOUTURE 19 OLD GONIC RD., ROCHESTER, NH 03867 BK 4093 PG 148


DRAWING No.

DM-1

SHEET 7 OF 46

JBE PROJECT NO. 21090

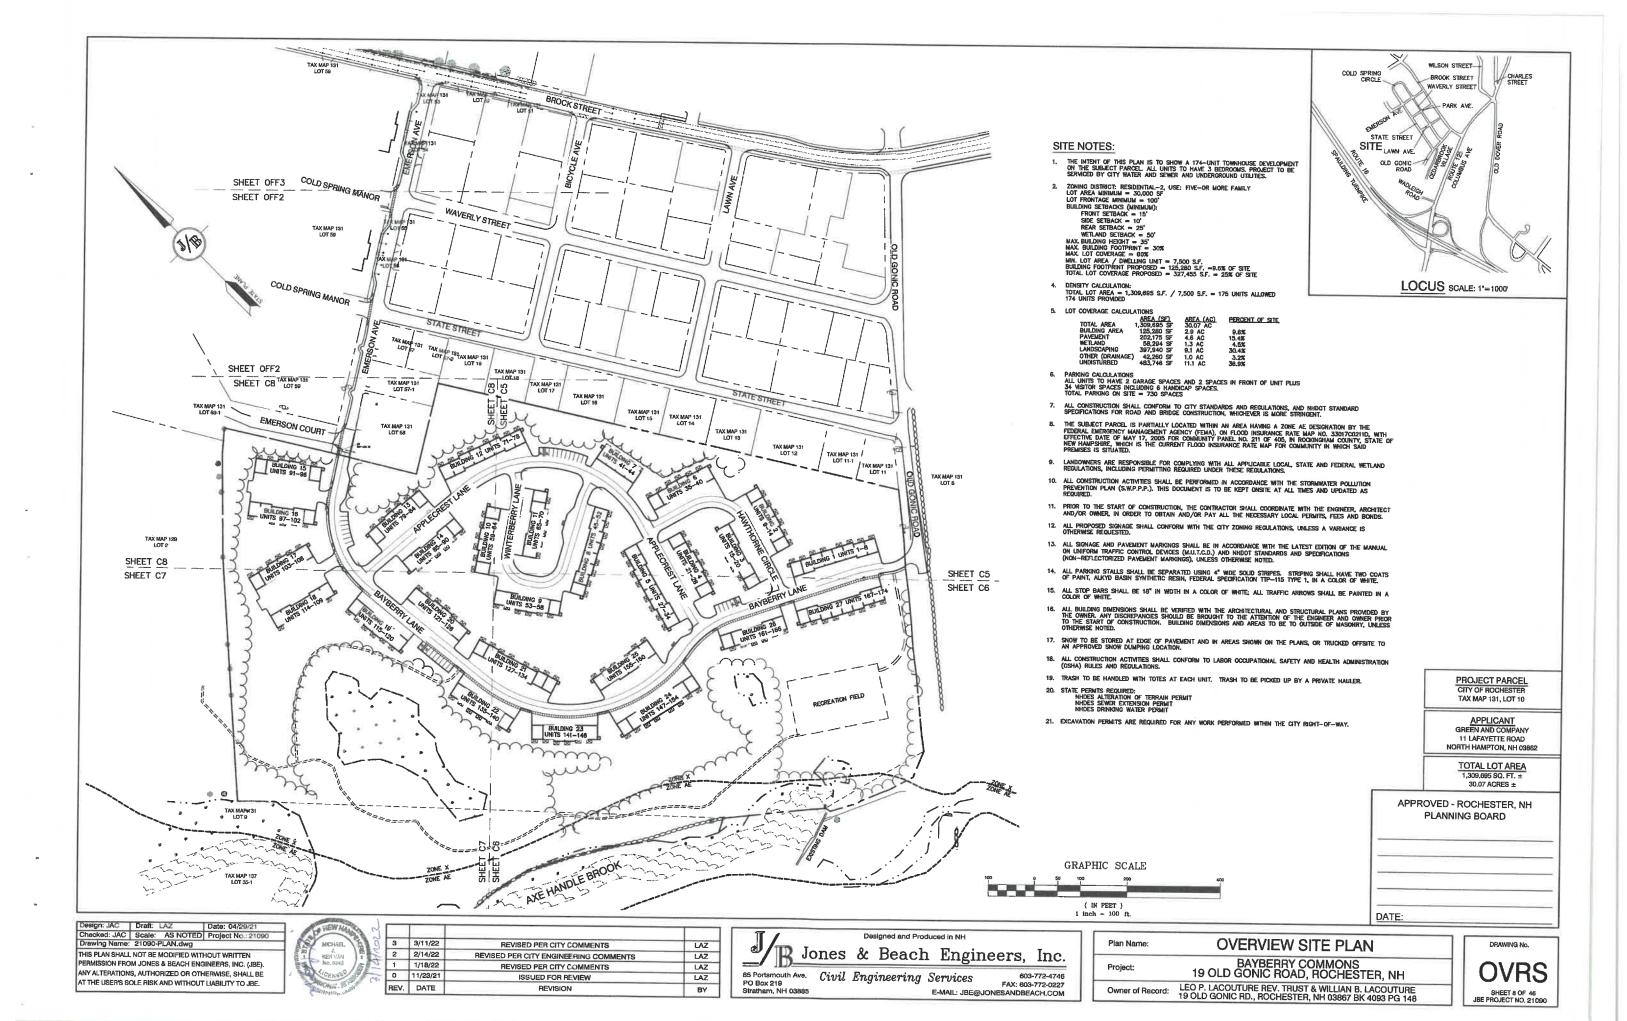

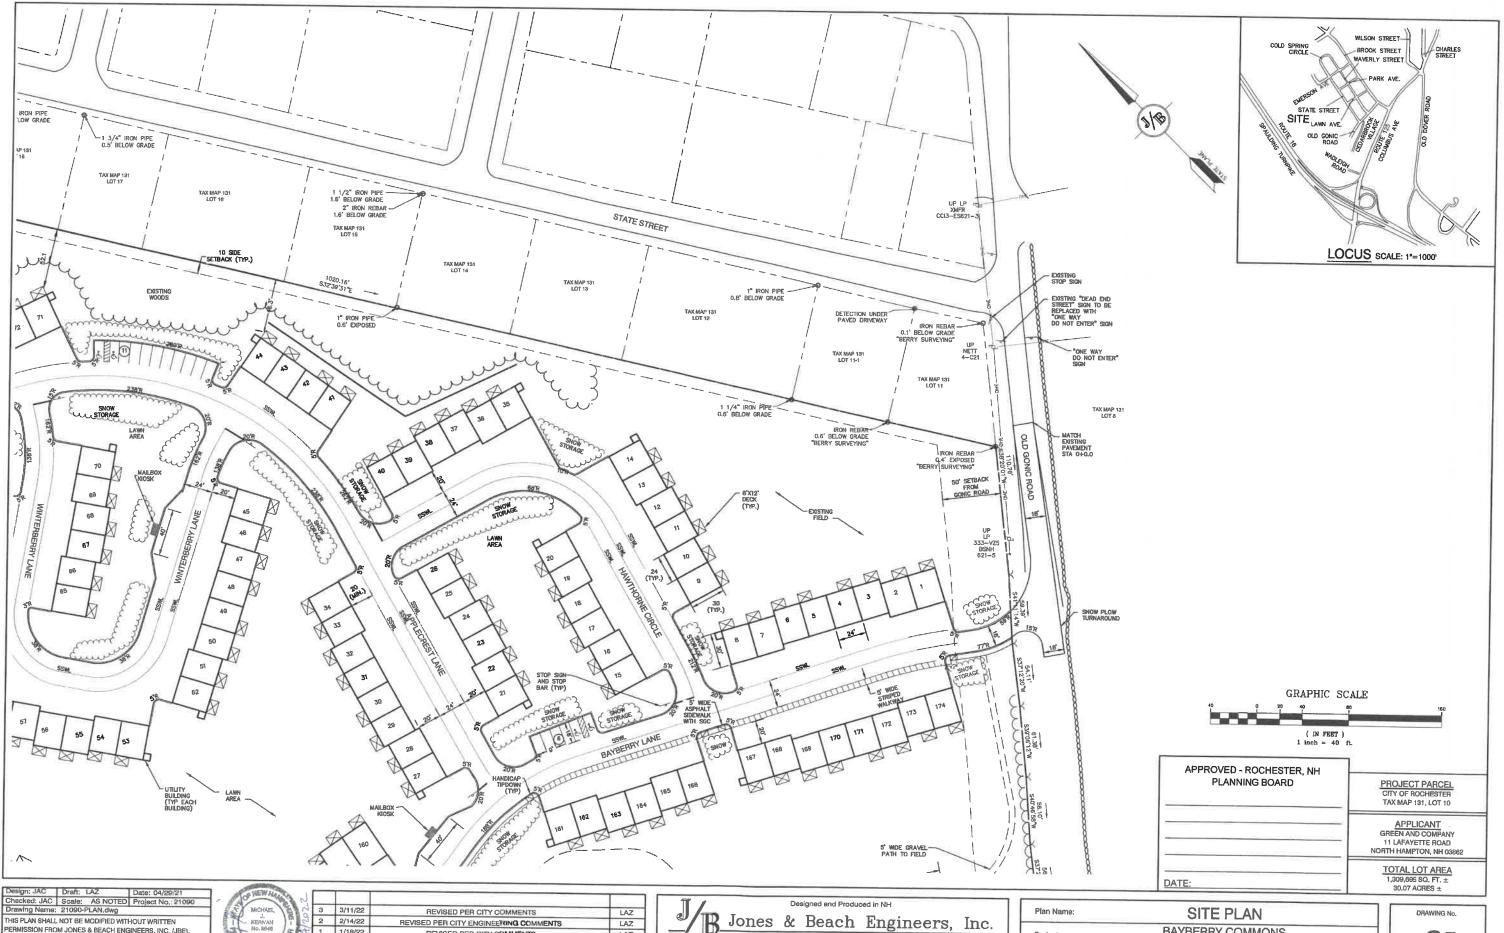

THIS PLAN SHALL NOT BE MODIFIED WITHOUT WRITTEN PERMISSION FROM JONES & BEACH ENGINEERS, INC. (JBE), ANY ALTERATIONS, AUTHORIZED OR OTHERWISE, SHALL BE AT THE USER'S SOLE RISK AND WITHOUT LIABILITY TO JBE.

OF REW Men	J			\neg
C MICHAEL	2 3	3/11/22	REVISED PER CITY COMMENTS	LAZ
KERIVAN I	2 2	2/14/22	REVISED PER CITY ENGINEERING COMMENTS	LAZ
No. 9845	5 1	1/18/22	REVISED PER CITY COMMENTS	LAZ
CENBO	0	11/23/21	ISSUED FOR REVIEW	LAZ
Marie IIII Paragram	REV.	DATE	REVISION	BY

Jones & Beach Engineers, Inc.

85 Portsmouth Ave. PO Box 219
Stratham, NH 03885


Civil Engineering Services

E-MAIL: JBE@ Services 603-772-4746 FAX: 603-772-0227 E-MAIL: JBE@JONESANDBEACH.COM

Plan Name:	SITE PLAN
Project:	BAYBERRY COMMONS 19 OLD GONIC ROAD, ROCHESTER, NH
Owner of Record:	LEO P. LACOUTURE REV. TRUST & WILLIAN B. LACOUTURE 19 OLD GONIC RD., ROCHESTER, NH 03867 BK 4093 PG 148

C₅ SHEET 9 OF 46 JBE PROJECT NO. 21090

Marie Control of the Control of the

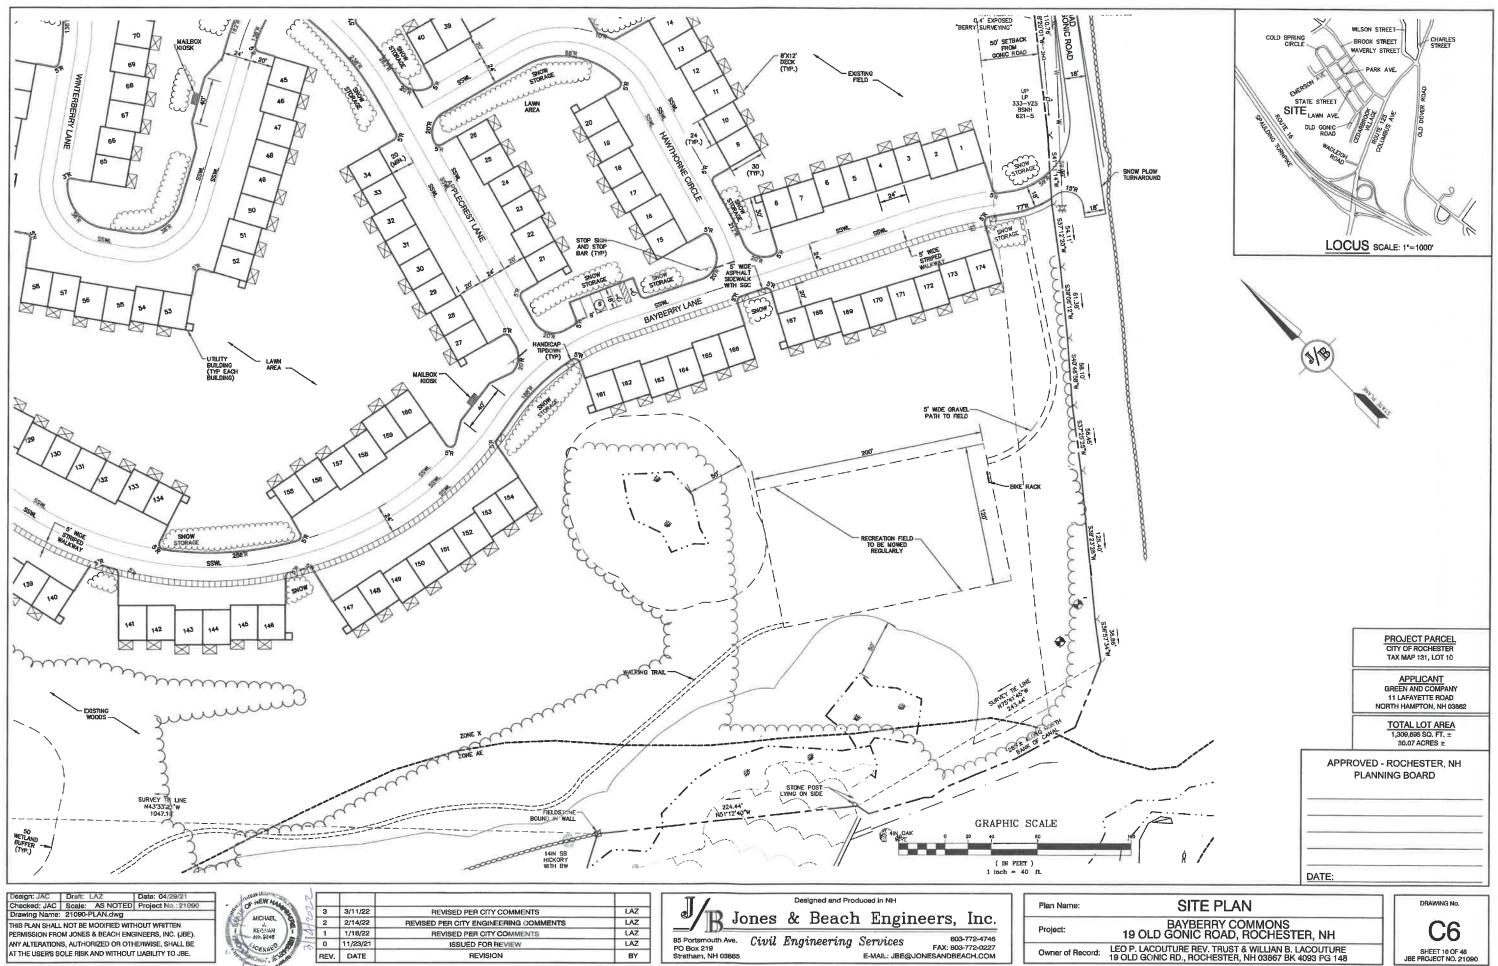

			and the second
ign: JAC	Draft: LAZ	Date: 04/29/21	THE PARTY OF THE P
cked: JAC	Scale: AS NOTED	Project No.: 21090	OF NEW MA
wing Name:	21090-PLAN.dwg		MICHAEL
MISSION FRO	NOT BE MODIFIED WITH M JONES & BEACH ENG	GINEERS, INC. (JBE).	I KERNAN No. 9348
	S, AUTHORIZED OR OTH		CENBED
HE USER'S S	OLE RISK AND WITHOUT	LIABILITY TO JBE.	One a

3	3/11/22	REVISED PER CITY COMMENTS	LAZ
2	2/14/22	REVISED PER CITY ENGINEERING COMMENTS	LAZ
1	1/18/22	REVISED PER CITY COMMENTS	LAZ
0	11/23/21	ISSUED FOR REVIEW	I.AZ
REV.	DATE	REVISION	BY
	3 2 1 0 REV.	1 1/18/22 0 11/23/21	2 2/14/22 REVISED PER CITY ENGINEERING COMMENTS 1 1/18/22 REVISED PER CITY COMMENTS 0 11/23/21 ISSUED FOR REVIEW

Jones & Beach Engineers, Inc. Services 603-772-4746 FAX: 803-772-0227 E-MAIL: JBE@JONESAND8EACH.COM 85 Portsmouth Ave. PO Box 219
Stratham, NH 03885

E-MAIL: JBE@

BAYBERRY COMMONS 19 OLD GONIC ROAD, ROCHESTER, NH Owner of Record: LEO P. LACOUTURE REV. TRUST & WILLIAN B. LACOUTURE 19 OLD GONIC RD., ROCHESTER, NH 03867 BK 4093 PG 148

C6 SHEET 10 OF 46 JBE PROJECT NO. 21090



THIS PLAN SHALL NOT BE MODIFIED WITHOUT WRITTEN PERMISSION FROM JONES & BEACH ENGINEERS, INC. (JBE). ANY ALTERATIONS, AUTHORIZED OR OTHERWISE, SHALL BE AT THE USER'S SOLE RISK AND WITHOUT LIABILITY TO JBE.


15			
REWALL	_	3/11/22	
18 19	3	3/11/22	REVISED PER CITY COMMENTS
MICHAEL 2	2	2/14/22	REVISED PER CITY ENGINEERING COMMENTS
KERIVAN No. 3846	1	1/18/22	REVISED PER CITY COMMENTS
Some Of the	0	11/23/21	ISSUED FOR REVIEW
Oper	REV.	DATE	REVISION
District Control			

Services 603-772-4748 FAX: 603-772-0227 E-MAIL: JBE@JONESANDBEACH.COM 85 Portsmouth Ave. Civil Engineering Services
PO Box 219
Stratham, NH 03885


E-MAIL: JBE@

Plan Name:	SITE PLAN	
Project:	BAYBERRY COMMONS 19 OLD GONIC ROAD, ROCHESTER, NH	
Owner of Record:	LEO P. LACOUTURE REV. TRUST & WILLIAN B. LACOUTURE	

C7

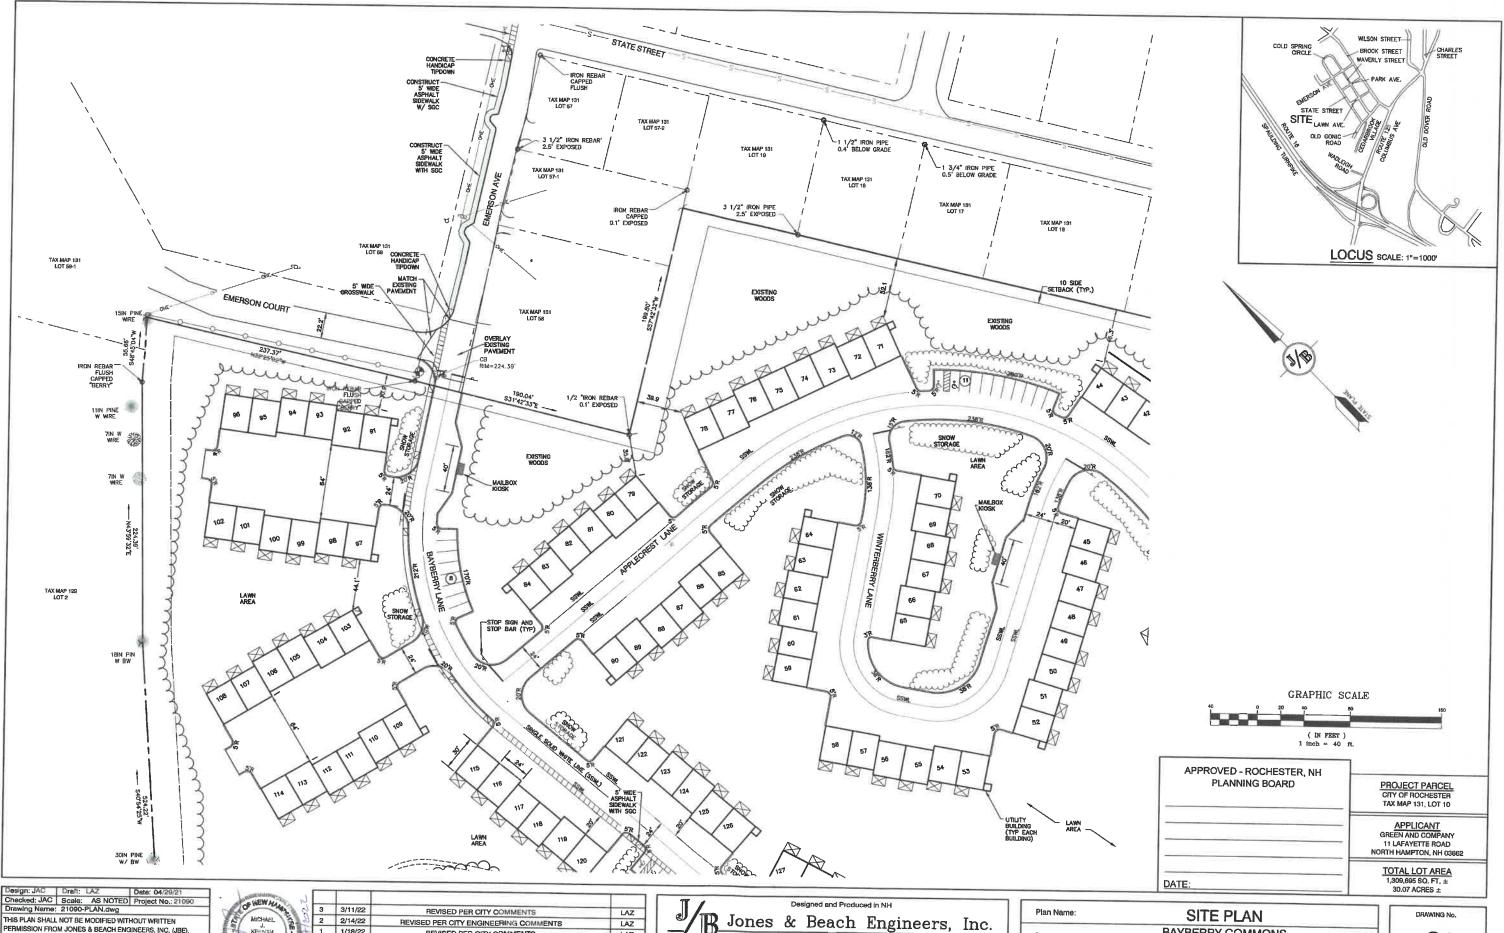

THIS PLAN SHALL NOT BE MODIFIED WITHOUT WRITTEN PERMISSION FROM JONES & BEACH ENGINEERS, INC. (JBE). ANY ALTERATIONS, AUTHORIZED OR OTHERWISE, SHALL BE AT THE USER'S SOLE RISK AND WITHOUT LIABILITY TO JBE.

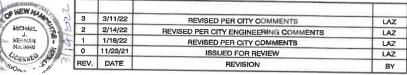


B Jones & Beach Engineers, Inc.

85 Portsmouth Ave. PO Box 219
Stratham, NH 03885

E-MAIL: JBE® Services 603-772-4746 FAX: 603-772-0227 E-MAIL: JBE@JONESANDBEACH.COM

BAYBERRY COMMONS 19 OLD GONIC ROAD, ROCHESTER, NH Project: Owner of Record: LEO P. LACOUTURE REV. TRUST & WILLIAN B. LACOUTURE 19 OLD GONIC RD., ROCHESTER, NH 03867 BK 4093 PG 148

C8 SHEET 12 OF 46 JBE PROJECT NO. 21090

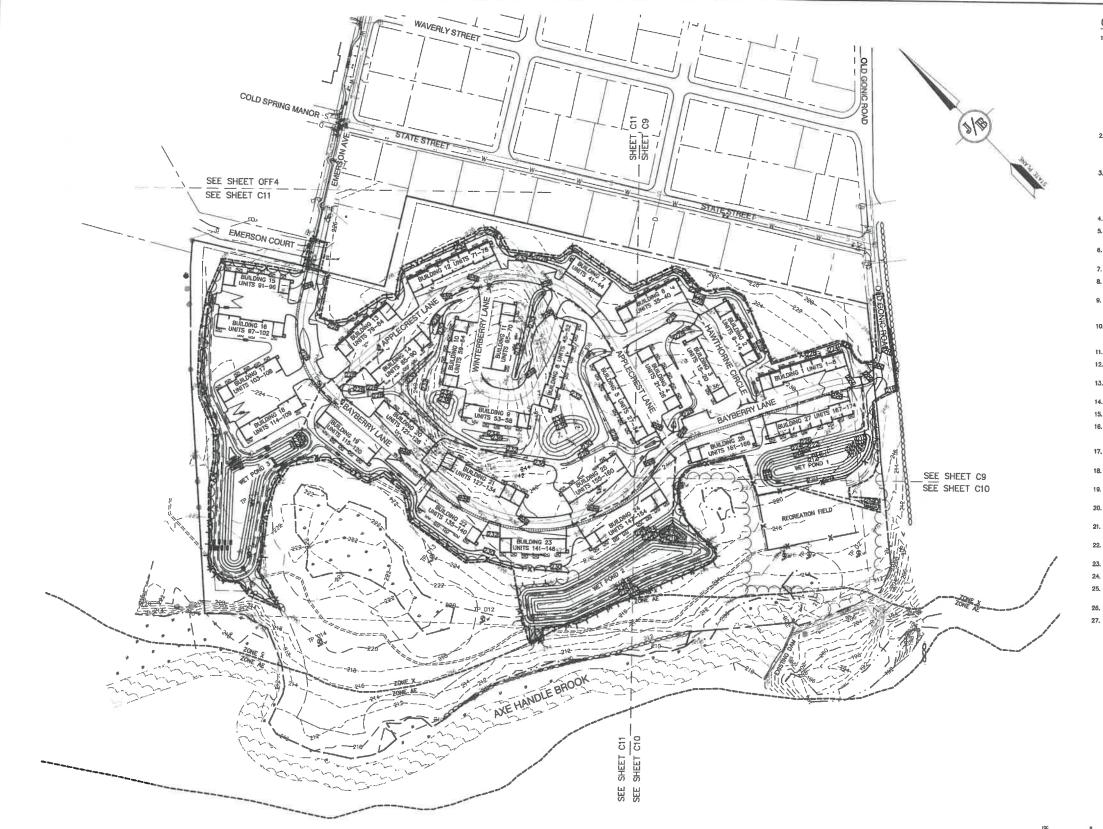

GRADING AND DRAINAGE NOTES:

- THIS SITE WILL REQUIRE A USEPA NPDES PERMIT FOR STORMWATER DISCHARGE FOR THE CONSTRUCTION SITE.

 THE CONSTRUCTION SITE OPERATOR SHALL DEVELOP AND IMPLEMENT A CONSTRUCTION STORM WATER POLLUTION

 PREVENTION OF HIS OWNERPATOR SHALL DEVELOP AND IMPLEMENT A CONSTRUCTION STORM WATER POLLUTION

 CONSTRUCTION OF CONSTRUCTION OF CONSTRUCTION OF THE PUBLIC THE

 CONSTRUCTION OF CONSTRUCTION OF CONSTRUCTION OF THE PUBLIC THE PU
- 2. IF THIS CONSTRUCTION SITE IS NOT STABILIZED WITH PAVEMENT, A ROAD GRAVEL BASE, 85 % MATURE VEGETATION COVER, OR RIPRAP BY OCTOBER 15, THEN THE SITE MUST BE PROTECTED WITH OVER-MINTER STABILIZATION. THE WINTER CONSTRUCTION PERIOD IS FROM OCTOBER 15 THROUGH MAY 15. WHITE EXCAVATION AND EARTHWORK ACTIVITIES SHALL BE LIMITED IN EXTENT AND DURATION, TO MINIMIZE POTENTIAL EROSION AND SEDIMENTATION IMPACTS.
- UNDERGROUND FACILITIES, LITILITIES AND STRUCTURES HAVE BEEN PLOTTED FROM FIELD OBSERVATION AND THEIR LOCATION MUST BE CONSIDERED APPROXIMATE ONLY. NEITHER JONES & BEACH ENGINEERS, INC., NOR AHY OF THEIR EMPLOYEES TAKE RESPONSIBILITY FOR THE LOCATION OF ANY UNDERGROUND STRUCTURES AND/OR UTILITIES SHOWN THAT MAY EXIST. IT IS THE RESPONSIBILITY OF THE CONTRACTOR TO HAVE ALL UNDERGROUND STRUCTURES AND/OR UTILITIES LOCATED PRIOR TO EXCAVATION WORK BY CALLING 888—DIG—SAFE FARM—123—79570
- 4. ALL BENCHMARKS AND TOPOGRAPHY SHOULD BE FIELD VERIFIED BY THE CONTRACTOR.
- SITE GRADING SHALL NOT PROCEED UNTIL EROSION CONTROL MEASURES HAVE BEEN INSTALLED. SEE CONSTRUCTION SEQUENCE ON SHEET EI.
- PRIOR TO THE START OF CONSTRUCTION, THE CONTRACTOR IS REQUIRED TO HAVE THE PROJECT'S LAND SURVEYOR STAKE OR FLAG CLEARING LIMITS. A MINIMUM OF 48 HOURS NOTICE IS REQUIRED.
- 7. ALL SWALES AND DETENTION PONDS ARE TO BE STABILIZED PRIOR TO DIRECTING RUNOFF TO THEM.
- PROPOSED RIM ELEVATIONS OF DRAINAGE STRUCTURES ARE APPROXIMATE, FINAL ELEVATIONS ARE TO BE SET FLUSH WITH FINISH GRADES.
- ALL SWALES AND ANY SLOPES GREATER THAN 3:1 SHALL BE STABILIZED WITH NORTH AMERICAN GREEN S75
 EROSION CONTROL BLANGETS (OR AN EQUIVALENT APPROVED IN WRITING BY THE ENGINEER), UNLESS OTHERWISE
 SPECIFICAL
- ALL DRAINAGE AND SANITARY STRUCTURE INTERIOR DIAMETERS (4" MIN) SHALL BE DETERMINED BY THE MANUFACTURER BASED ON THE PIPE CONFIGURATIONS SHOWN ON THESE PLANS. CATCH BASINS SHALL HAVE 3" DEEP SUMPS WITH GREASE HOODS, UNLESS OTHERWISE NOTED.
- 11. ALL DRAINAGE STRUCTURES SHALL BE PRECAST, UNLESS OTHERWISE SPECIFIED.
- 12. ALL DRAINAGE STRUCTURES AND STORM SEWER PIPES SHALL MEET HEAVY DUTY TRAFFIC H20 LOADING AND SHALL BE INSTALLED ACCORDINGLY.
- 13. THE CONTRACTOR SHALL INSTALL CRANGE CONSTRUCTION FENCING ALONG PROPERTY LINES AND ALONG WETLAND BUFFERS.
- 14. ALL DRAINAGE PIPE SHALL BE NON-PERFORATED ADS N-12 OR APPROVED EQUAL
- 15. STONE INLET PROTECTION SHALL BE PLACED AT ALL CATCH BASINS. SEE DETAIL WITHIN THE DETAIL SHEETS.
- 18. LAND DISTURBING ACTIVITIES SHALL NOT COMMENCE UNTIL APPROVAL TO DO SO HAS BEEN RECEIVED BY ALL GOVERNING AUTHORITIES. THE GENERAL CONTRACTOR SHALL STRICTLY ADHERE TO THE EPA SHIPP DURING CONSTRUCTION OPERATIONS.
- ALL EXPOSED AREAS SHALL BE SEEDED AS SPECIFIED WITHIN 3 DAYS OF FINAL GRADING AND ANYTIME CONSTRUCTION STOPS FOR LONGER THAN 3 DAYS.
- MAINTAIN EROSION CONTROL MEASURES AFTER EACH RAIN EVENT OF 0.5° OR GREATER IN A 24 HOUR PERIOD AND AT LEAST ONCE A WEEK.
- THIS PLAN SHALL NOT BE CONSIDERED ALL INCLUSIVE, AS THE GENERAL CONTRACTOR SHALL TAKE ALL NECESSARY PRECAUTIONS TO PREVENT SEDIMENT FROM LEAVING THE SITE.
- 20. CONSTRUCTION VEHICLES SHALL UTILIZE THE STABILIZED CONSTRUCTION ENTRANCE TO THE EXTENT POSSIBLE
- IF INSTALLATION OF STORM DRAINAGE SYSTEM SHOULD BE INTERRUPTED BY WEATHER OR NIGHTFALL, THE PIPE ENDS SHALL BE COVERED WITH FILTER FABRIC.
- THE GENERAL CONTRACTOR SHALL BE RESPONSIBLE TO TAKE WHATEVER MEANS NECESSARY TO ESTABLISH
 PERMANENT SOIL STABILIZATION.
- SEDIMENT SHALL BE REMOVED FROM ALL SEDIMENT BASINS BEFORE THEY ARE 25% FULL.
- 24. ALL WORK SHALL BE DONE IN STRICT ACCORDANCE WITH PROJECT SPECIFICATIONS.
- 25. ADDITIONAL EROSION AND SEDIMENT CONTROL MEASURES SHALL BE INSTALLED, IF DEEMED NECESSARY BY ON-SITE INSPECTION BY ENGINEER AND/OR REGULATORY OFFICIALS.
- 26. SEE ALSO EROSION AND SEDIMENT CONTROL SPECIFICATIONS ON SHEET E1.
- 27. PRIOR TO CLEARING OR CRADING DISTURBANCE, THE CONTRACTOR SHALL IDENTIFY ALL AREAS OF TYPE 2 INVASIVE SPECIES AS DEFINED BY INDOT AND ADHERE TO THE PRACTICES OUTLINED IN BEST MANAGEMENT PRACTICES FOR THE CONTROL OF INVASIVE AND NOXIOUS PLANT SPECIES, INDOT, 2018. THESE PRACTICES SHALL BE FOLLOWED FOR THE ENTRE CONSTRUCTION TERM INCLUDING ESTABLISHIENT OF MONEGAPHING. AS THE SITE RE-VEGETATES AFTER CONSTRUCTION, LANDSCAPING CONTRACTOR TO INFORM THE OWNER IF ANY INVASIVE SPECIES START TO GROW, OWNER SHALL CONTACT A QUALIFIED REMOVAL COMPANY AND FOLLOW NHD BEST MANAGEMENT PRACTICES.

GRAPHIC SCALE (IN FEET) 1 inch = 100 ft

PROJECT PARCEL CITY OF ROCHESTER TAX MAP 131, LOT 10

APPLICANT GREEN AND COMPANY 11 LAFAYETTE ROAD NORTH HAMPTON, NH 03862

> **TOTAL LOT AREA** 1,309,695 SQ, FT, ± 30.07 ACRES ±

Design: JAC Draft: LAZ Checked: JAC Scale: AS NOTED Project No.: 21090 Drawing Name: 21090-PLAN.dwg

THIS PLAN SHALL NOT BE MODIFIED WITHOUT WRITTEN PERMISSION FROM JONES & BEACH ENGINEERS, INC. (JBE). ANY ALTERATIONS, AUTHORIZED OR OTHERWISE, SHALL BE AT THE USER'S SOLE RISK AND WITHOUT LIABILITY TO JBE.


NEW AL.				
MICHAEL &	3	3/11/22	REVISED PER CITY COMMENTS	LAZ
ERIVAN	2	2/14/22	REVISED PER CITY ENGINEERING COMMENTS	LAZ
0. 4848	1	1/18/22	REVISED PER CITY COMMENTS	LAZ
ENSE	0	11/23/21	ISSUED FOR REVIEW	LAZ
MCL T	REV.	DATE	REVISION	BY

Designed and Produced in NH Jones & Beach Engineers, Inc.

85 Portsmouth Ave. Civil Engineering Services 603-772-4746 E-MAIL: JBE@JONESANDBEACH.COM

Plan Name:	OVERVIEW GRADING PLAN
Project:	BAYBERRY COMMONS 19 OLD GONIC ROAD, ROCHESTER, NH
Owner of Record:	LEO P. LACOUTURE REV. TRUST & WILLIAN B. LACOUTURE 19 OLD GONIC RD., ROCHESTER, NH 03867 BK 4093 PG 148



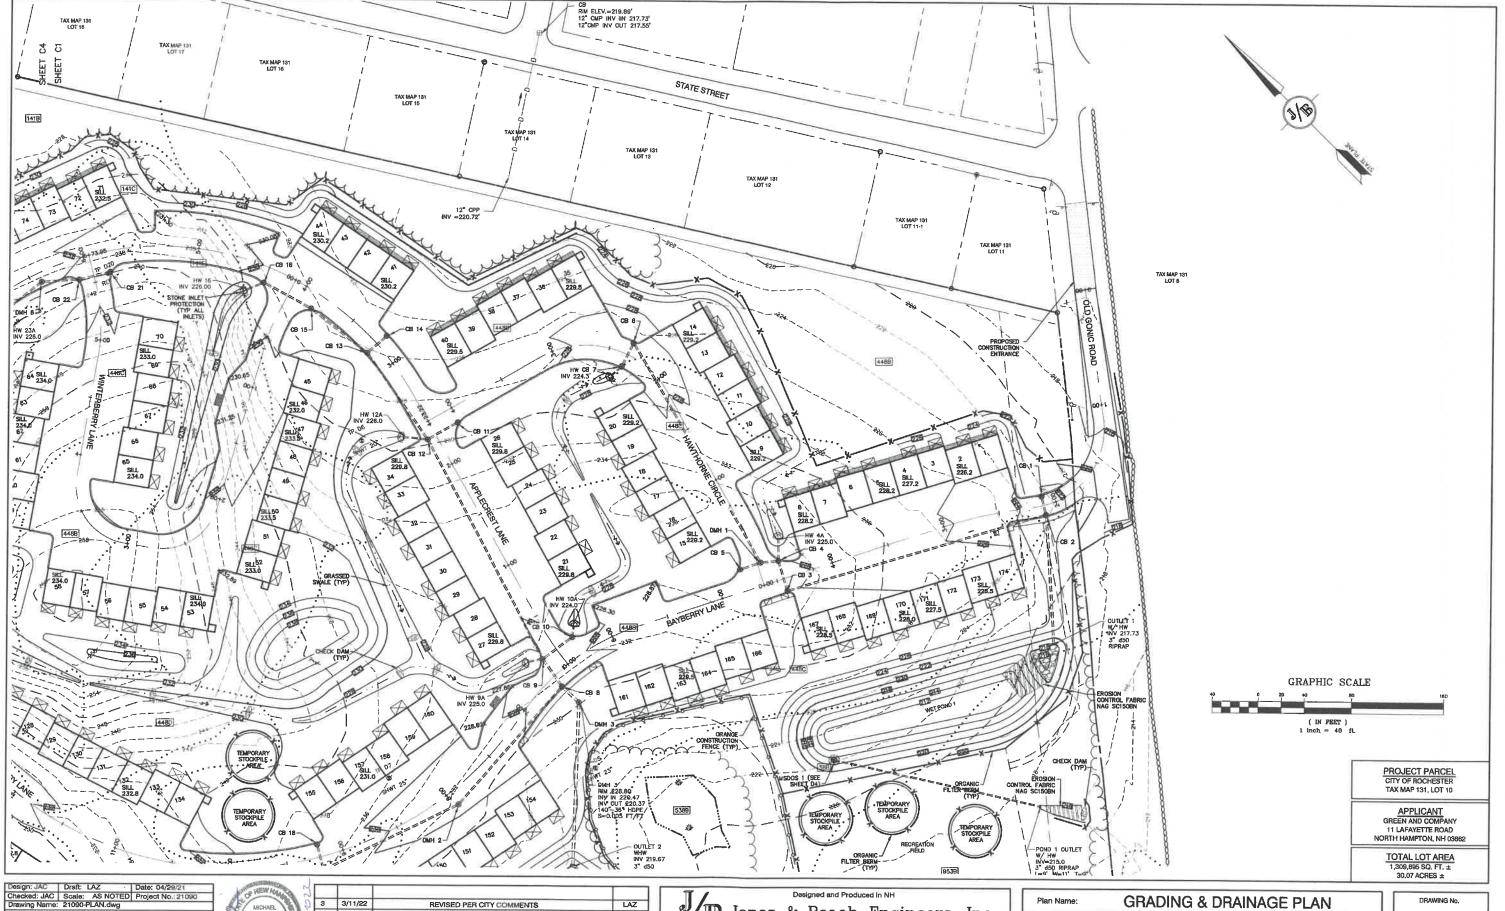

Checked: JAC Scale: AS NOTED Project No.: 21090
Drawing Name: 21090-PLAN.dwg
THIS PLAN SHALL NOT BE MODIFIED WITHOUT WRITTEN
PERMISSION FROM JONES & BEACH ENGINEERS, INC. (JBE).
ANY ALTERATIONS, AUTHORIZED OR OTHERWISE, SHALL BE
AT THE USERS SOLE RISK AND WITHOUT LIABILITY TO JBE.



3	3/11/22	REVISED PER CITY COMMENTS	LAZ
2	2/14/22	REVISED PER CITY ENGINEERING COMMENTS	LAZ
1	1/18/22	REVISED PER CITY COMMENTS	LAZ
0	11/23/21	ISSUED FOR REVIEW	LAZ
REV.	DATE	REVISION	BY

Jones & Beach Engineers, Inc.

B5 Portsmouth Ave. Civil Engineering Services 603-772-4746
PO Box 219
Stretham, NH 03885
603-772-0227
E-MAIL: JBE@JONESANDBEACH.COM

Plan Name:	GRADING & DRAINAGE PLAN
Project:	BAYBERRY COMMONS 19 OLD GONIC ROAD, ROCHESTER, NH

Owner of Record: LEO P. LACOUTURE REV. TRUST & WILLIAN B. LACOUTURE 19 OLD GONIC RD., ROCHESTER, NH 03867 BK 4093 PG 148

DRAWING No.

C9
SHEET 14 OF 46
JBE PROJECT NO. 21090



Checked: JAC Scale: AS NOTED Project No.:21090
Drawing Name: 21090-PLAN.dwg
THIS PLAN SHALL NOT BE MODIFIED WITHOUT WRITTEN
PERMISSION FROM JONES & BEACH ENGINEERS, INC. (JBE).
ANY ALTERATIONS, AUTHORIZED OR OTHERWISE, SHALL BE
AT THE USER'S SOLE RISK AND WITHOUT LIABILITY TO JBE.



3	3/11/22	REVISED PER CITY COMMENTS	LAZ
2	2/14/22	REVISED PER CITY ENGINEERING COMMENTS	LAZ
1	1/18/22	REVISED PER CITY COMMENTS	LAZ
- 0	11/23/21	ISSUED FOR REVIEW	LAZ
REV.	DATE	REVISION	BY

Jones & Beach Engineers, Inc.

85 Portsmouth Ave. PO Box 219
Stretham, NH 03885

Services FAX: 603-772-0227

E-MAIL: JBE@JONESANDBEACH.COM

Project:

BAYBERRY COMMONS
19 OLD GONIC ROAD, ROCHESTER, NH

Owner of Record:

LEO P. LACOUTURE REV. TRUST & WILLIAN B. LACOUTURE
19 OLD GONIC RD., ROCHESTER, NH 03867 BK 4093 PG 148

DRAWING No.

C10
SHEET 15 OF 46
JBE PROJECT NO. 21090



PERMISSION FROM JONES & BEACH ENGINEERS, INC. (JBE).
ANY ALTERATIONS, AUTHORIZED OR OTHERWISE, SHALL BE
AT THE USER'S SOLE RISK AND WITHOUT LIABILITY TO JBE.

WEW HALL			
MICHAEL 0	3	3/11/22	
18 1 18 1 co	2	2/14/22	
No.9848	1	1/18/22	
CENSED M	0	11/23/21	
SHOWL ST	REV.	DATE	


No. 17		1 1		
11/9	3	3/11/22	REVISED PER CITY COMMENTS	LAZ.
1812	2	2/14/22	REVISED PER CITY ENGINEERING COMMENTS	LAZ
14	1	1/18/22	REVISED PER CITY COMMENTS	LAZ
///=	0	11/23/21	ISSUED FOR REVIEW	LAZ
No.	REV.	DATE	REVISION	BY
200				

Services 603-772-4746 FAX: 603-772-0227 E-MAIL: JBE@JONESANDBEACH.COM 85 Portsmouth Ave. Civil Engineering Services
PO Box 219
Stratham, NH 03885
E-MALL: JBE©

BAYBERRY COMMONS 19 OLD GONIC ROAD, ROCHESTER, NH Project:

LEO P. LACOUTURE REV. TRUST & WILLIAN B. LACOUTURE 19 OLD GONIC RD., ROCHESTER, NH 03867 BK 4093 PG 148 Owner of Record:

SHEET 16 OF 46 JBE PROJECT NO. 21090

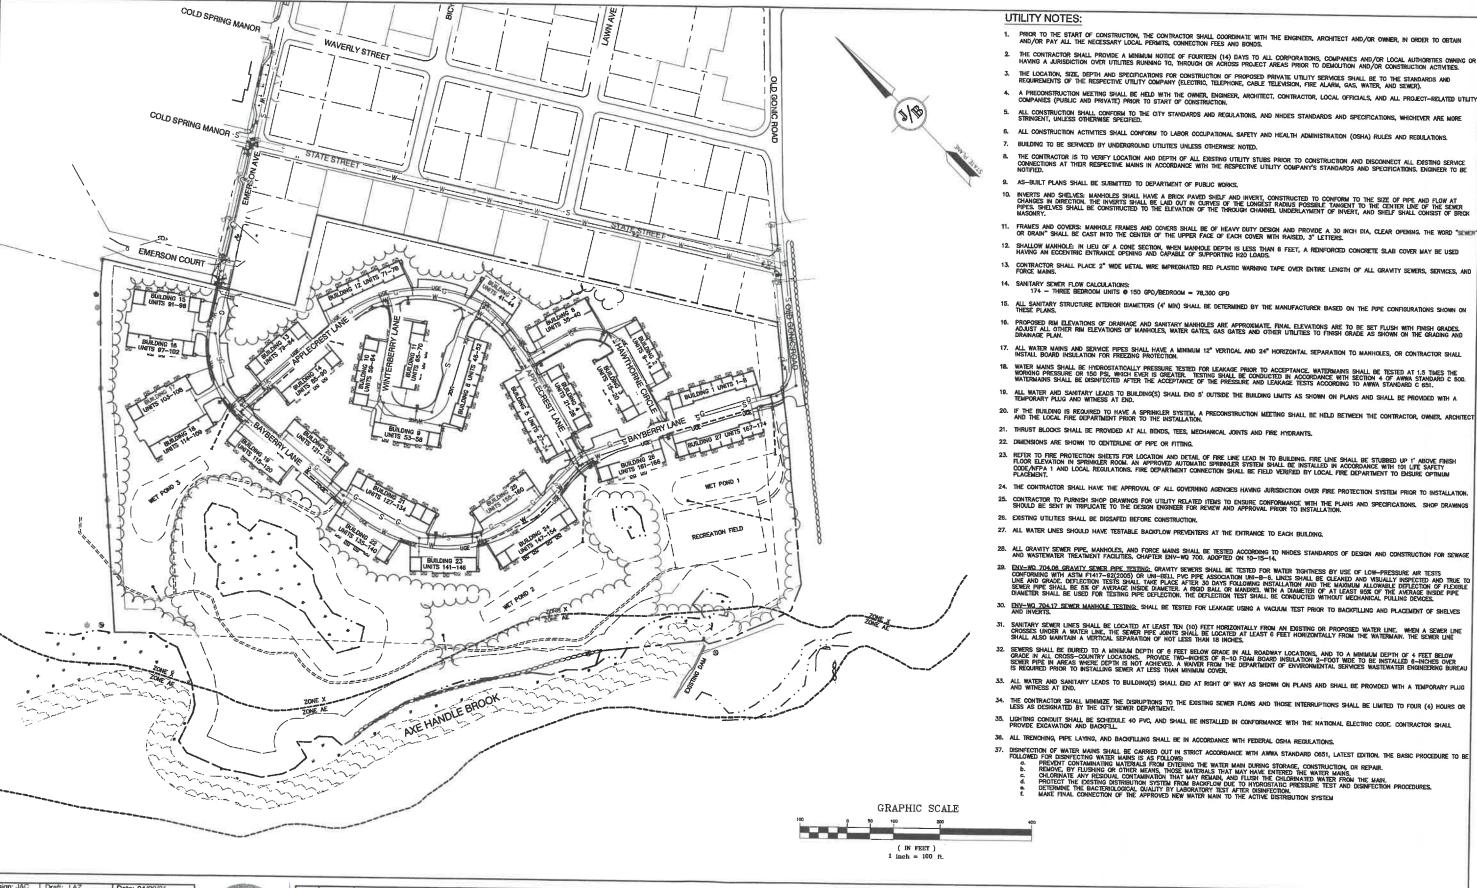


 Design: JAC
 Draft: LAZ
 Date: 04/29/21

 Checked: JAC
 Scale: AS NOTED
 Project No.: 21090

 Drawing Name: 21090-PLAN.dwg

 THIS PLAN SHALL NOT BE MODIFIED WITHOUT WRITTEN

Drawing Name: 21090-PLAN.dwg
THIS PLAN SHALL NOT BE MODIFIED WITHOUT WRITTEN
PERMISSION FROM JONES & BEACH ENGINEERS, INC. (JBE).
ANY ALTERATIONS, AUTHORIZED OR OTHERWISE, SHALL BE
AT THE USER'S SOLE RISK AND WITHOUT LIABILITY TO JBE.

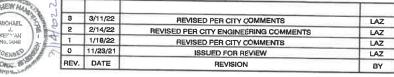

Jones & Beach Engineers, Inc.

85 Portsmouth Ave. Civil Engineering Services
PO Box 219

ring Services 603-772-4748 FAX: 603-772-0227 E-MAIL: JBE@JONESANDBEACH.COM


Plan Name: OVERVIEW UTILITY PLAN


Project:

BAYBERRY COMMONS 19 OLD GONIC ROAD, ROCHESTER, NH


Owner of Record: LEO P. LACOUTURE REV. TRUST & WILLIAN B. LACOUTURE 19 OLD GONIC RD., ROCHESTER, NH 03867 BK 4093 PG 148



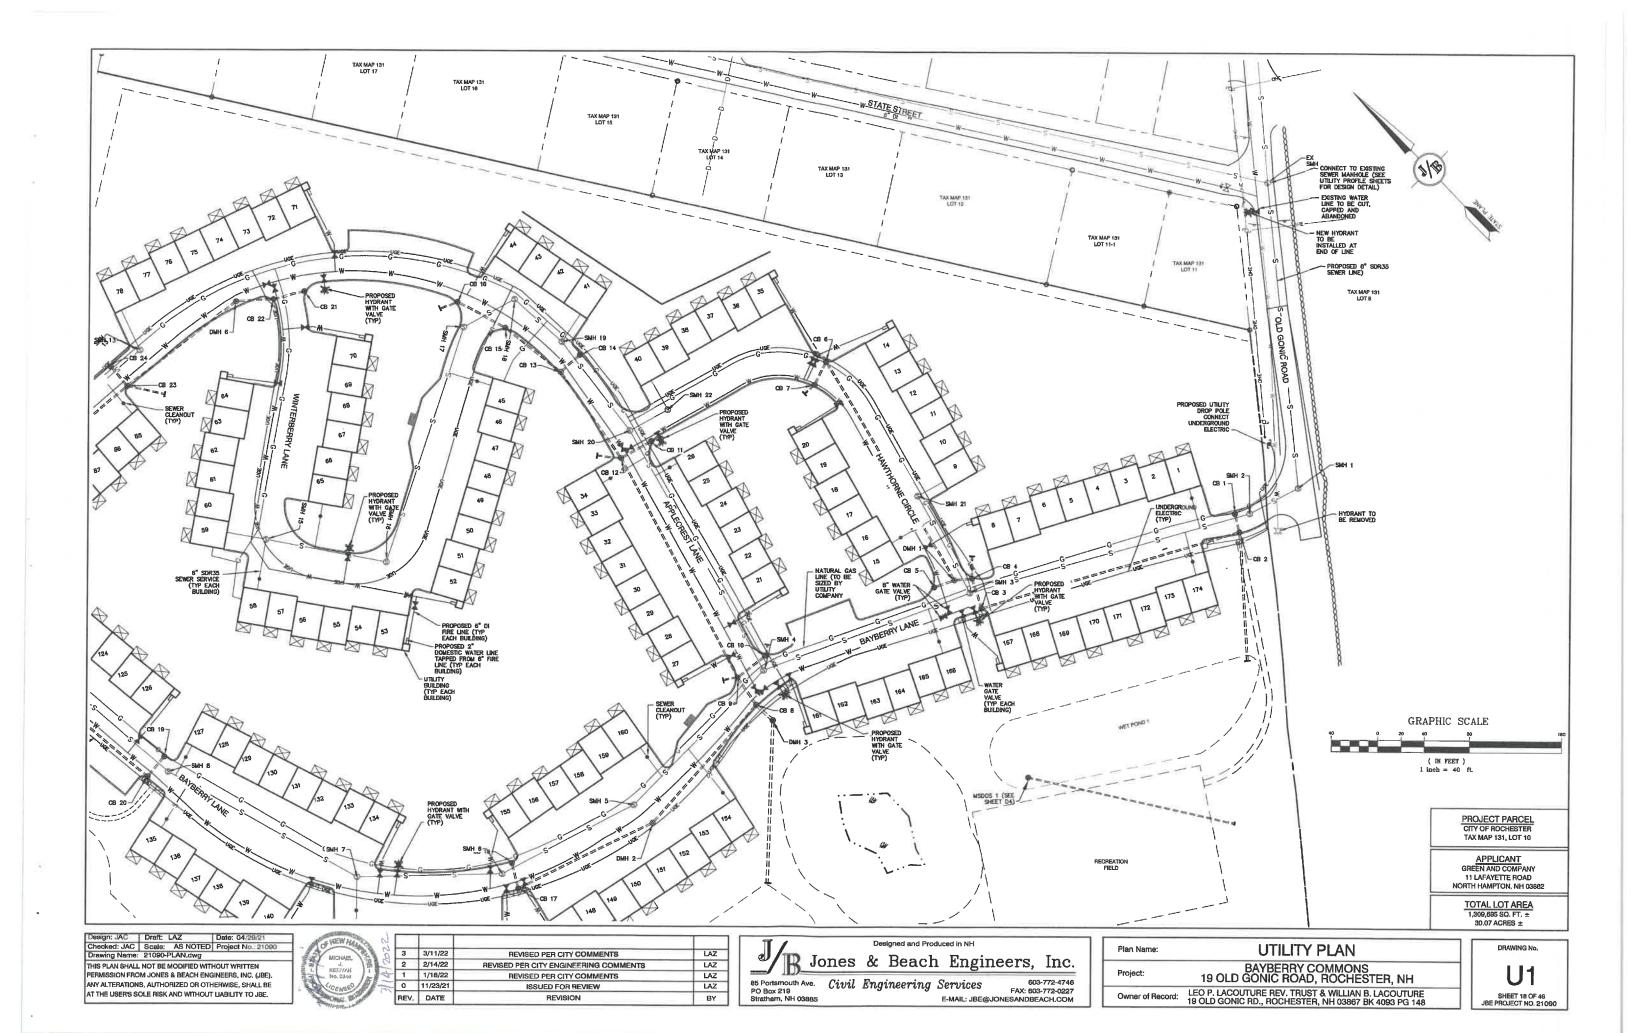

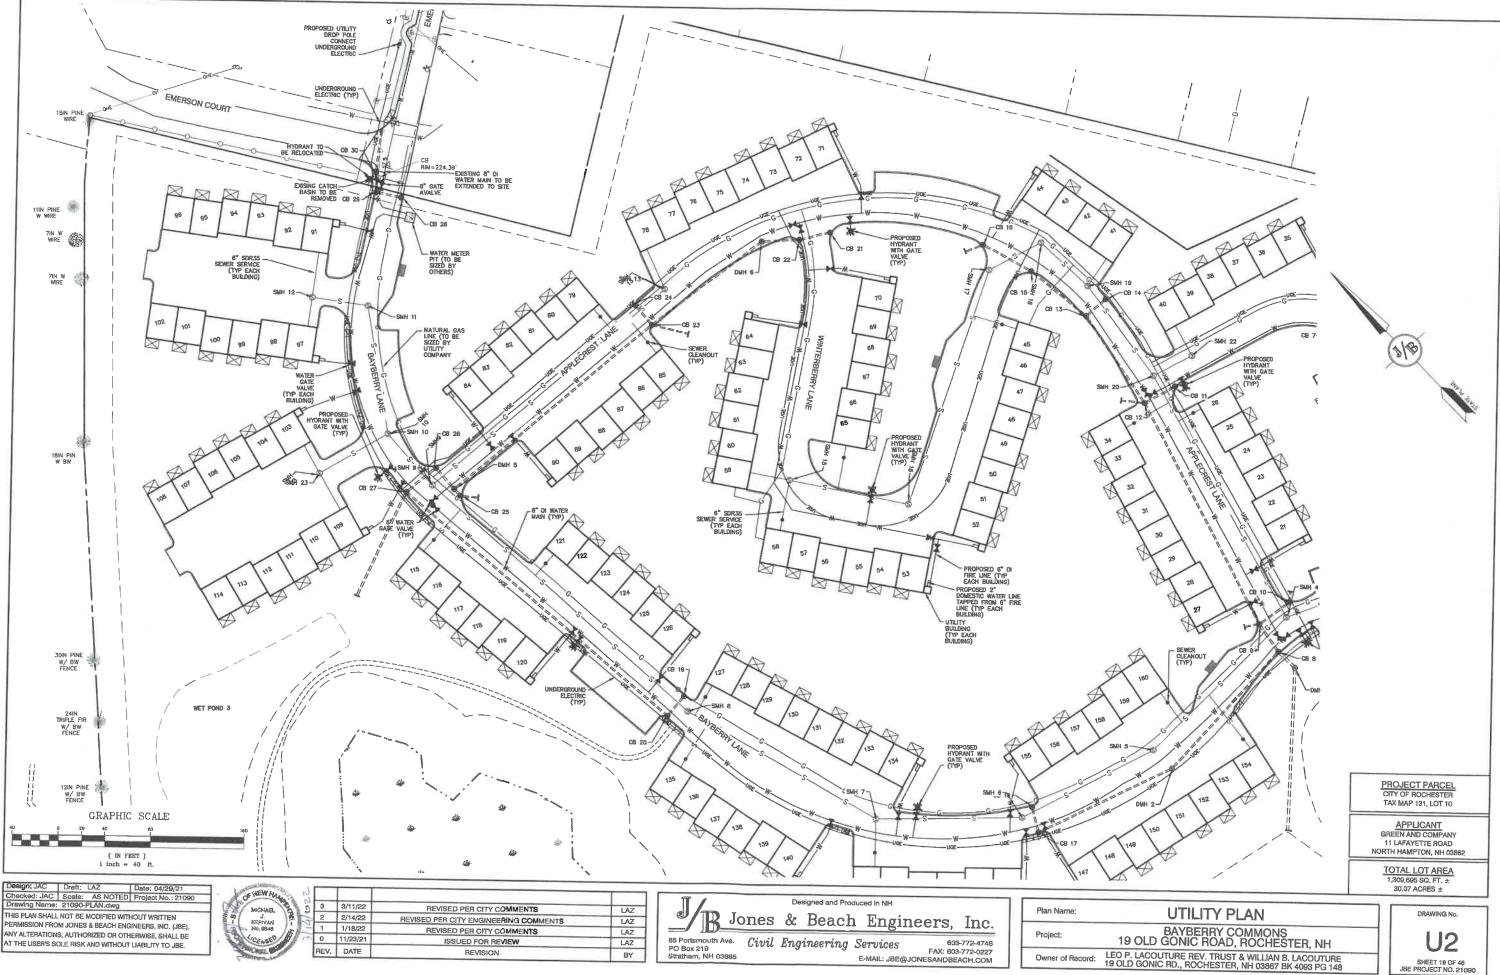

SHEET 19 OF 48 JBE PROJECT NO. 21090

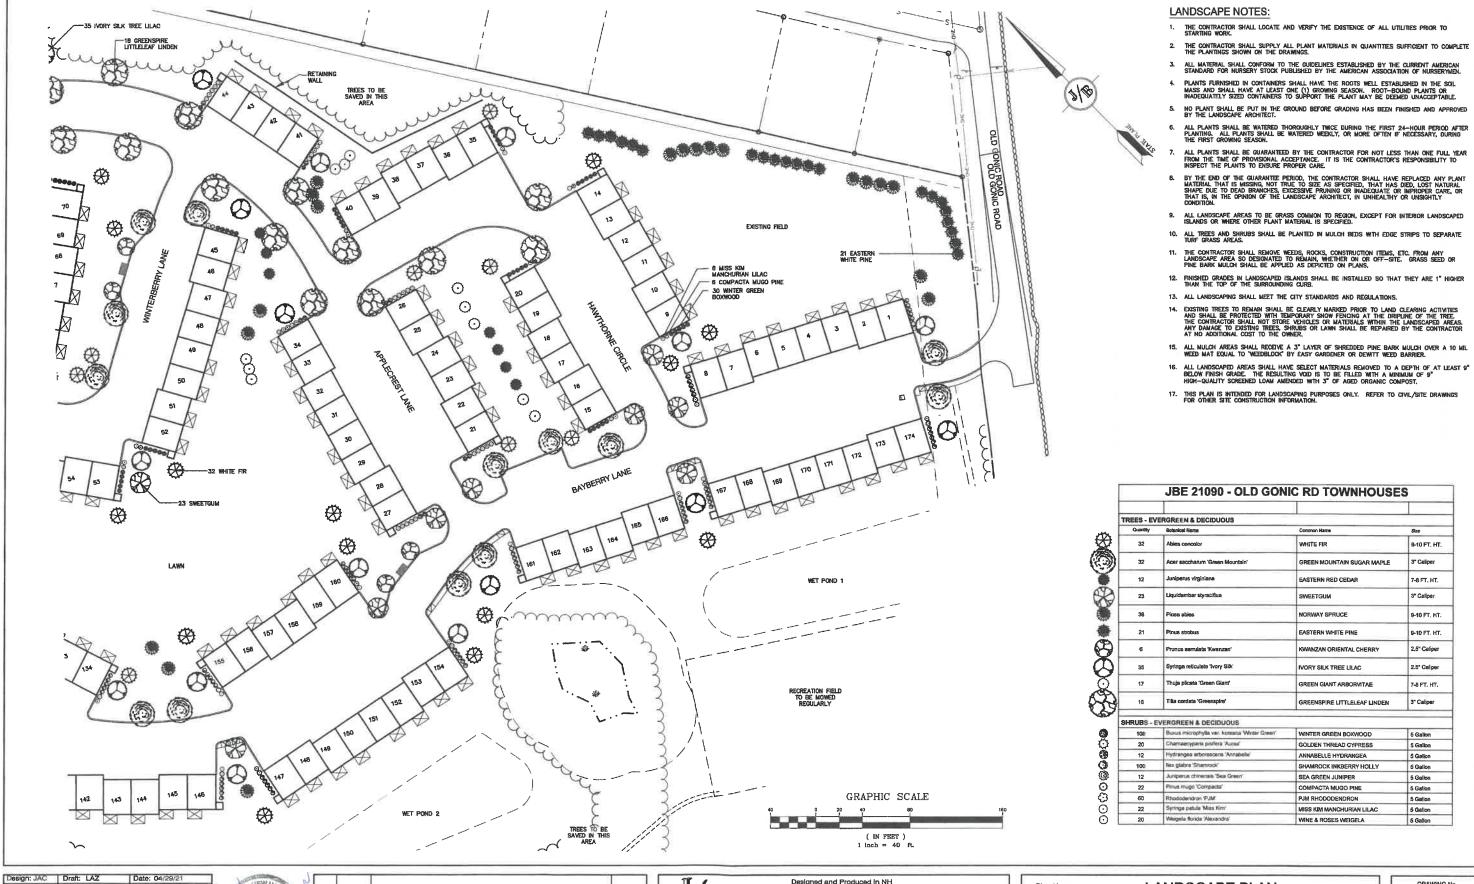

Checked: JAC	Scale:	AS NOTED	Project No.: 21090
Drawing Name:			
THIS PLAN SHALL			
PERMISSION FROM	M JONES	& BEACH ENG	GINEERS, INC. (JBE).
ANY ALTERATIONS	S, AUTHO	RIZED OR OTH	IERWISE, SHALL BE
AT THE USER'S SO	DLE RISK	AND WITHOUT	LIABILITY TO JBE.




3	3/11/22	REVISED PER CITY COMMENTS	LAZ
2	2/14/22	REVISED PER CITY ENGINEERING COMMENTS	LAZ
1	1/18/22	REVISED PER CITY COMMENTS	LAZ
0	11/23/21	ISSUED FOR REVIEW	LAZ
REV.	DATE	REVISION	BY

Designed and Produced in NH B Jones & Beach Engineers, Inc. 85 Portsmouth Ave. Civil Engineering Services FAX: 603-772-0227


PO Box 219 Stratham, NH 03885 E-MAIL: JBE@JONESANDBEACH.COM

Plan Name:	LANDSCAPE PLAN
Project:	BAYBERRY COMMONS 19 OLD GONIC ROAD, ROCHESTER, NH
Owner of Record:	LEO P. LACOUTURE REV. TRUST & WILLIAN B. LACOUTURE 19 OLD GONIC RD., ROCHESTER, NH 03867 BK 4093 PG 148

DRAWING No SHEET 20 OF 46 JBE PROJECT NO. 21090

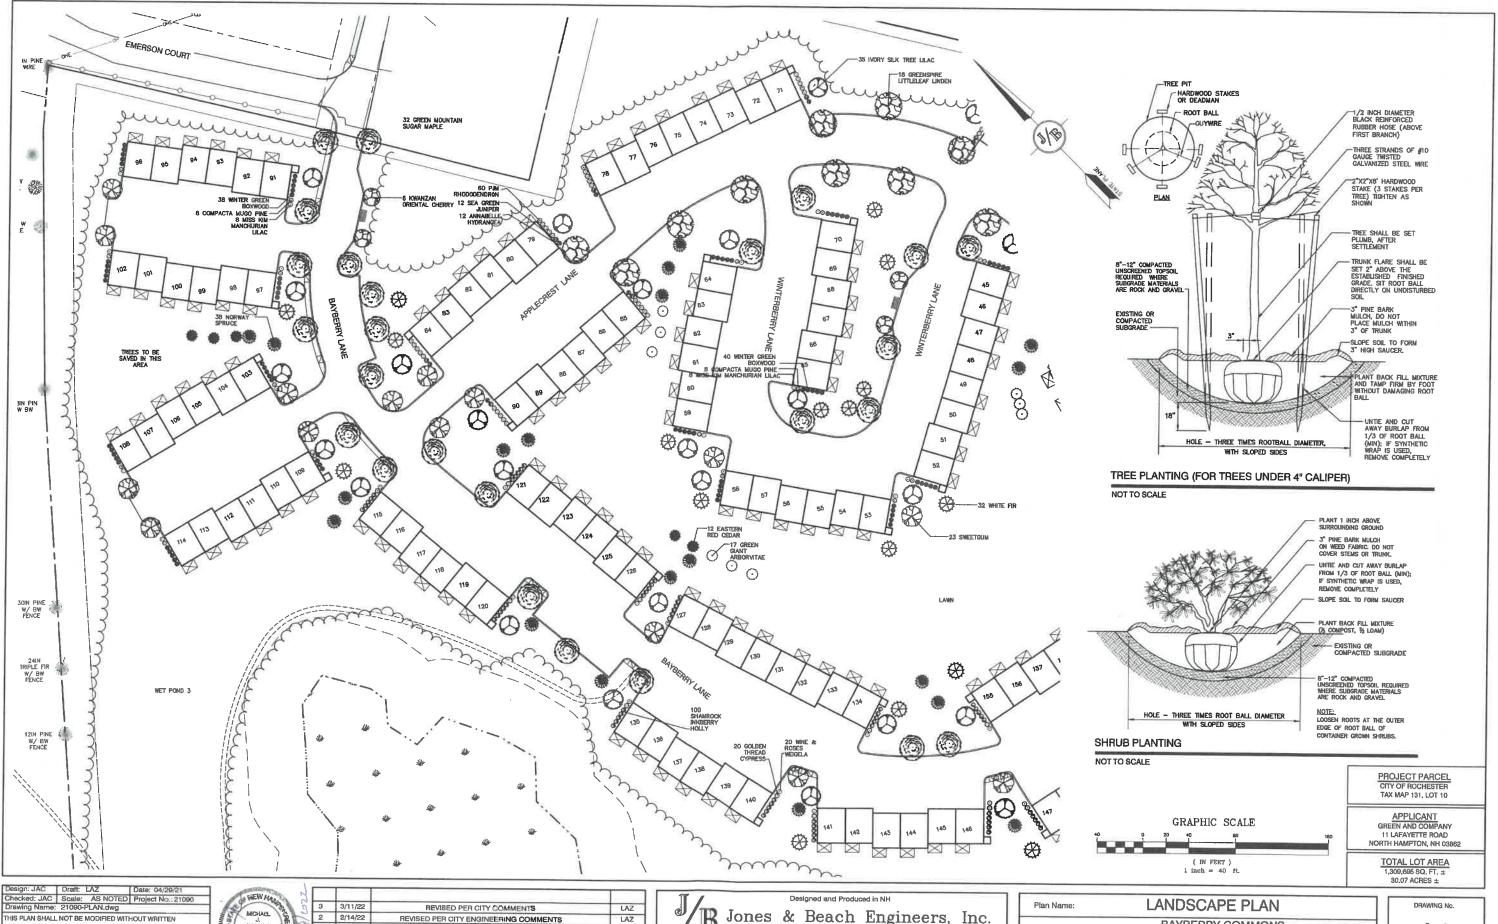

THIS PLAN SHALL NOT BE MODIFIED WITHOUT WRITTEN PERMISSION FROM JONES & BEACH ENGINEERS, INC. (JBE). ANY ALTERATIONS, AUTHORIZED OR OTHERWISE, SHALL BE AT THE USER'S SOLE RISK AND WITHOUT LIABILITY TO JBE.

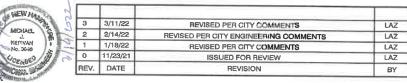


Jones & Beach Engineers, Inc.

85 Portsmouth Ave. Civil Engineering Services 603-772-4746 FAX: 603-772-0227 E-MAIL: JBE@JONESANDBEACH,COM PO Box 219 Stratham, NH 03885

Plan Name:	LANDSCAPE PLAN
Project:	BAYBERRY COMMONS 19 OLD GONIC ROAD, ROCHESTER, NH
Owner of Record:	LEO P. LACOUTURE REV. TRUST & WILLIAN B. LACOUTURE 19 OLD GONIC RD., ROCHESTER, NH 03867 BK 4093 PG 148

L2 SHEET 21 OF 46 JBE PROJECT NO. 21090

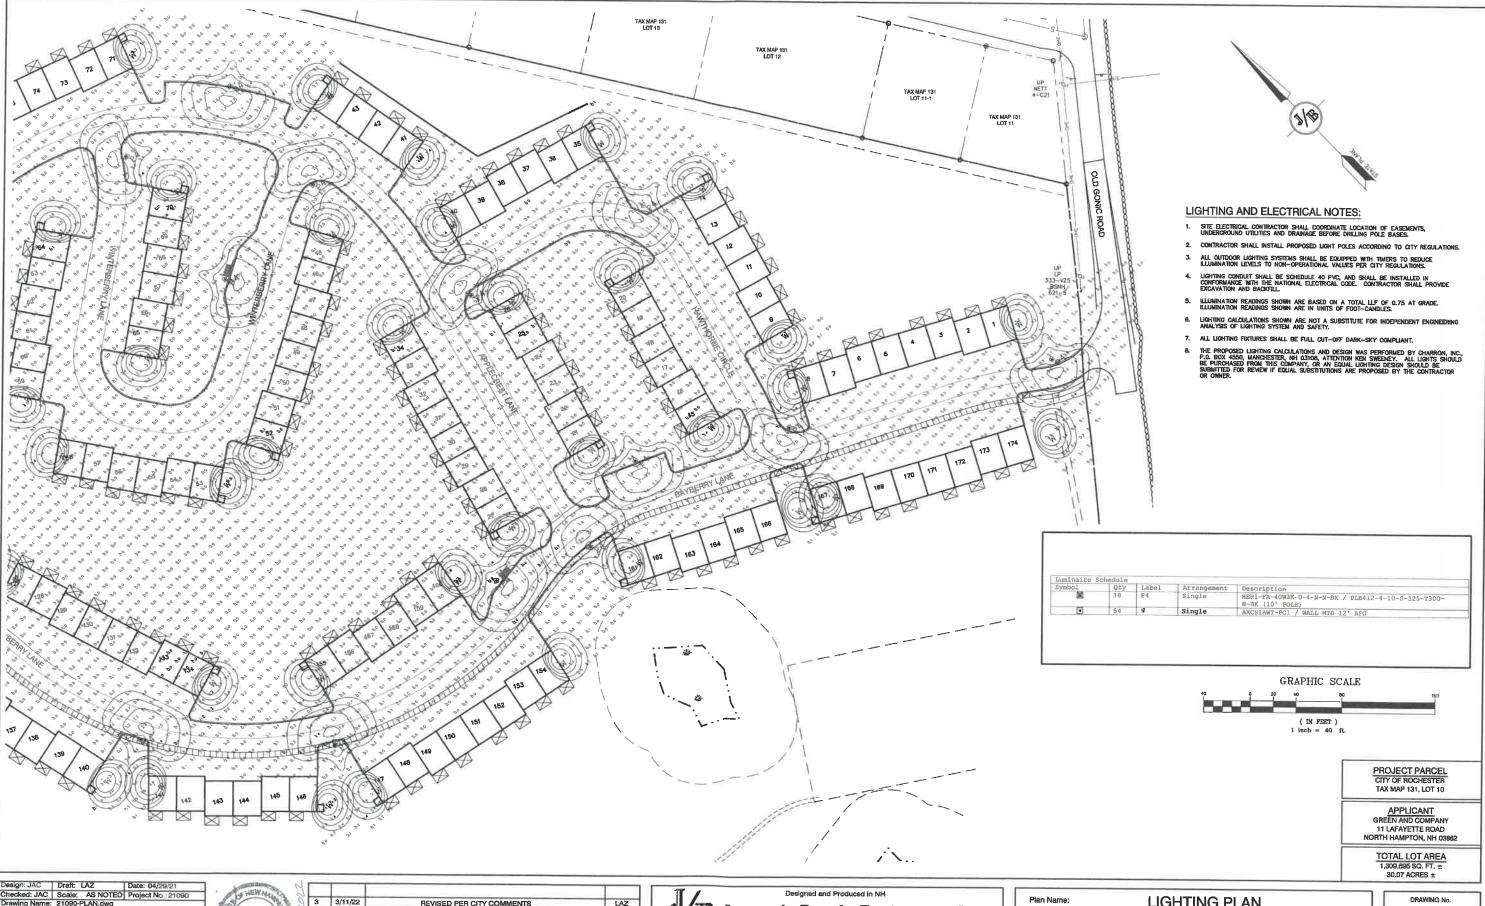

ssign: JAC	Draft: LAZ	Date: 04/29/21	Astronithmy
ecked: JAC	Scale: AS NOTED	Project No.: 21090	A HEWAL
awing Name:	21090-PLAN.dwg		
IS PLAN SHALL	NOT BE MODIFIED WITH	HOUT WRITTEN	MICHAEL J.
RMISSION FRO	M JONES & BEACH ENG	RINEERS, INC. (JBE).	KERIVAN No. 9848
Y ALTERATION	S, AUTHORIZED OR OTH	IERWISE, SHALL BE	10. 5040
THE USER'S SO	OLE RISK AND WITHOUT	LIABILITY TO JBE.	CENSE
			Section of

SEWALA I				
2 1	3	3/11/22	REVISED PER CITY COMMENTS	LAZ
MICHAEL 12	2	2/14/22	REVISED PER CITY ENGINEERING COMMENTS	LAZ
KERIVAN No. 9846	1	1/18/22	REVISED PER CITY COMMENTS	LAZ
Comes / File	0	11/23/21	ISSUED FOR REVIEW	LAZ
One: A series	REV.	DATE	REVISION	BY

Designed and Produced in NH

Jones & Beach Engineers, Inc.

B5 Portsmouth Ave. PO Box 219
Stratham, NH 03885

Designed and Produced in NH

Engineers, Inc.

603-772-4748
FAX: 603-772-0227
E-MAIL: JBE@JONESANDBEACH.COM

- I - L		LIGHTING I LAN
	Project:	BAYBERRY COMMONS 19 OLD GONIC ROAD, ROCHESTER, NH
	Owner of Record:	LEO P. LACOUTURE REV. TRUST & WILLIAN B. LACOUTURE 19 OLD GONIC RD., ROCHESTER, NH 03867 BK 4093 PG 148

DRAWING No.

L3


SHEET 22 OF 46

JBE PROJECT NO. 21090







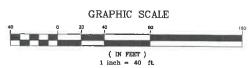

PROJECT PARCEL CITY OF ROCHESTER TAX MAP 131, LOT 10

APPLICANT GREEN AND COMPANY 11 LAFAYETTE ROAD NORTH HAMPTON, NH 03862

TOTAL LOT AREA 1,309,695 SQ. FT. ± 30.07 ACRES ±

Design: JAC	Draft: LAZ	Date: 04/29/21
Checked: JAC	Scale: AS NOTED	Project No.: 21090
Drawing Name:	Scale: AS NOTED 21090-PLAN.dwg	

THIS PLAN SHALL NOT BE MODIFIED WITHOUT WRITTEN PERMISSION FROM JONES & BEACH ENGINEERS, INC. (JBE). ANY ALTERATIONS, AUTHORIZED OR OTHERWISE, SHALL BE AT THE USER'S SOLE RISK AND WITHOUT LIABILITY TO JBE.

- 4	HEWA	AST TO SERVICE	J
1	1	1 3	6
100	MECHAE	1.8	c
10	No. 9846	101	A CONTRACTOR
20	CENSE		F
-	SANONA.	A STATE OF	

3	3/11/22	REVISED PER CITY COMMENTS	LAZ
2	2/14/22	REVISED PER CITY ENGINEERING COMMENTS	LAZ
1	1/18/22	REVISED PER CITY COMMENTS	LAZ
0	11/23/21	ISSUED FOR REVIEW	LAZ
REV.	DATE	REVISION	BY

B Jones & Beach Engineers, Inc.


85 Portsmouth Ave. Civil Engineering Services
PO Box 219
Stratham, NH 03885
E-MAIL: JBE@ Services 603-772-4746 FAX: 803-772-0227 E-MAIL: JBE@JONESANDBEACH.COM

lan Name:	LIGHTING PLAN
roject:	BAYBERRY COMMONS 19 OLD GONIC ROAD, ROCHESTER, NH

L4

DRAWING No.

Owner of Record: LEO P. LACOUTURE REV. TRUST & WILLIAN B. LACOUTURE 19 OLD GONIC RD., ROCHESTER, NH 03867 BK 4093 PG 148

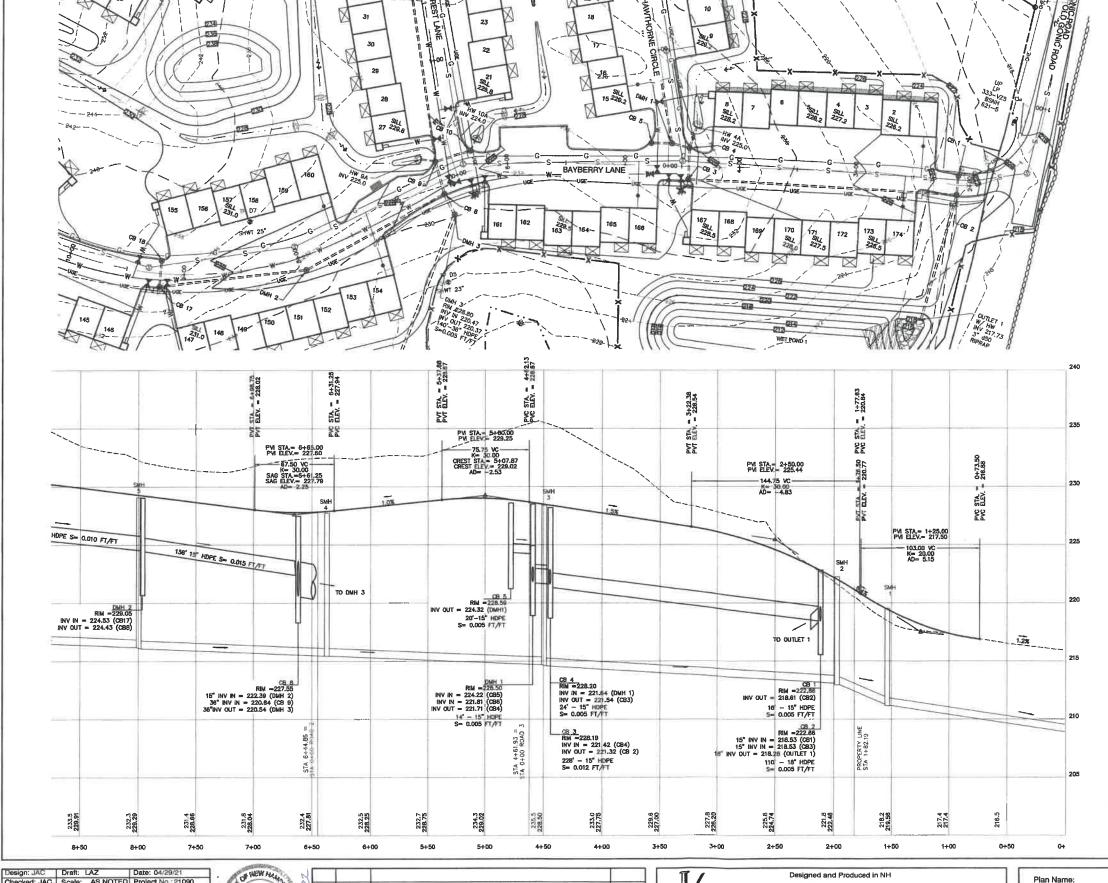

NOTES:

- ALL ROAD AND DRAINAGE WORK SHALL BE CONSTRUCTED IN ACCORDANCE WITH THE STANDARD SPECIFICATIONS FOR THE CITY, AND INIDIO'S SPECIFICATIONS FOR ROAD AND BRIDGE CONSTRUCTION, WHICHEVER IS MORE STRINGENT.
- 2. AS-BUILT PLANS TO BE SUBMITTED TO THE CITY PRIOR TO ACCEPTANCE OF THE ROADWAY.
- DEVELOPER IS RESPONSIBLE FOR COMPLYING WITH ALL APPLICABLE LOCAL, STATE AND FEDERAL WETLAND REGULATIONS, INCLUDING ANY PERMITTING AND SETBACK REQUIREMENTS REQUIRED UNDER THESE REGULATIONS.
- CONTRACTOR TO COORDINATE AND COMPLETE ALL WORK REQUIRED FOR THE RELOCATION AND/OR INSTALLATION OF ELECTRIC, CATV, TELEPHONE, AND FIRE ALARM PER UTILITY DESIGN AND STANDARDS, LOCATIONS SHOWN ARE APPROXIMATE, LOW PROFILE STRUCTURES SHALL BE USED TO THE GREATEST EXTENT POSSIBLE.
- THIS PLAN HAS BEEN PREPARED BY JONES & BEACH ENGINEERS, INC. FOR MUNICIPAL AND STATE APPROVALS AND FOR CONSTRUCTION BASED ON DATA OBTAINED FROM ON-SITE FIELD SURVEY AND EXISTING MUNICIPAL RECORDS. THROUGHOUT THE CONSTRUCTION PROCESS, THE CONTRACTOR SHALL INFORM THE ENGINEER MALEDIATELY OF ANY FIELD DISCREPANCY FROM DATA SHOWN ON THE DESIGN PLANS. THIS INCLIDES ANY UNFORESEEN CONDITIONS, SUBSURFACE OF OTHERWISE, FOR EVALUATION AND RECOMMENDATIONS. ANY CONTRADICTION BETWEEN THE PLANS AND ON-SITE CONDITIONS MUST BE RESOLVED BEFORE RELATED CONSTRUCTION HAS BEEN INITIATED.
- SILTATION AND EROSION CONTROLS SHALL BE INSTALLED PRIOR TO CONSTRUCTION, SHALL BE MAINTAINED DURING CONSTRUCTION, AND SHALL REMAIN UNTIL SITE HAS BEEN STABILIZED WITH PERMANENT VEGETATION SEE DETAIL SHEET ET FOR ADDITIONAL NOTES ON REGISION CONTROL.
- ALL DISTURBED AREAS NOT STABILIZED BY NOVEMBER 1st SHALL BE COVERED WITH AN EROSION CONTROL BLANKET. PRODUCT TO BE SPECIFIED BY THE ENGINEER.
- FINAL DRAINAGE, GRADING AND EROSION PROTECTION MEASURES SHALL CONFORM TO REGULATIONS OF THE PUBLIC WORKS DEPARTMENT.
- 9. CONTRACTOR TO VERIFY EXISTING UTILITIES AND TO NOTIFY ENGINEER OF ANY DISCREPANCY IMMEDIATELY.
- ROADWAY INTERSECTIONS WITH SLOPE GRANITE CURB SHALL EXTEND AROUND RADIUS WITH 6' STRAIGHT PIECE ALONG TANGENT.
- RETAINING WALLS SHALL BE DESIGNED AND STAMPED BY A LICENSED PROFESSIONAL ENGINEER. CONTRACTOR SHALL COORDINATE WITH MANUFACTURER PRIOR TO INSTALLATION.
- 12. 6" PERFORATED ADS UNDER DRAIN PLACEMENT TO BE DETERMINED BY THE ENGINEER DURING TIME OF SUBGRADE INSPECTION. CONTRACTOR TO ADJUST LOCATION IN THE FIELD ONLY WITH PRIOR APPROVAL OF PROJECT ENGINEER OR PUBLIC WORKS DEPARTMENT.
- 13. ALL DRIVEWAYS TO BE CONSTRUCTED MAXIMUM 10% SLOPE, SEE DETAIL SHEET,
- 14. SIDEWALK TO BE INSTALLED AT TIME OF TOP COURSE PAVING ALONG WITH DRIVEWAY APRONS.
- 15. DRAINAGE INSPECTION AND MAINTENANCE SCHEDULE: SILT FENCING WILL BE INSPECTED DURING AND AFTER STORM EVENTS TO ENSURE THAT THE FENCE STILL HAS INTEGRITY AND IS NOT ALLOWING SEDIMENT TO PASS. SEDIMENT BUILD UP IN SWALES WILL BE REMOVED IF IT IS DEPERE THAN SIX INCHES, AND IS TO BE REMOVED FROM SUMPS BELOW THE INLET OF CULVERTS SEMIANNUALLY, AS WELL AS FROM CATCH BASINS. FOLLOWING MAJOR STORM EVENTS, THE STAGE DISCHARGE OUTLET STRUCTURES ARE TO BE INSPECTED ANY DEBRIS REMOVED FROM THE ORIFICE, TRASH TRACK AND EMERGENCY SHILL WAY, INFREQUENTLY, SEDIMENT MAY ALSO HAVE TO BE REMOVED FROM THE SUMP OF THE STRUCTURE.
- 18. ALL DRAINAGE INFRASTRUCTURE SHALL BE INSTALLED AND STABILIZED PRIOR TO DIRECTING ANY RUNOFF TO IT.
- 17. DETENTION PONDS REQUIRE TIMELY MAINTENANCE AND SHOULD BE INSPECTED AFTER EVERY MAJOR STORM EVENT, AS WELL AS PREQUENTLY DURING THE FIRST YEAR OF OPERATION, AND ANNUALLY THEREAFTER, EVERY FIVE YEARS, THE SERVICES OF A PROFESSIONAL ENGINEER SHOULD BE RETAINED TO PERFORM A THOROUGH INSPECTION OF THE DETENTION PORO AND TIS MERKSTRUCTURE, MAY DEBRIS AND SEDIMENT ACQUAINLATIONS SHOULD BE REMOVED FROM THE OUTLET STRUCTURE(S) AND EMERGENCY SHLWAY(S) AND EMPOSED OF PROPERLY, DETENTION POND BERNAS SHOULD BE ROMOVED AT LEAST ONCE ANNUALLY SO AS TO PREVENT THE ESTABLISHMENT OF WOODLY VEGETATION. TREES SHOULD NEVER BE ALLOWED TO GROW ON A DETENTION POND BERNA SHOULD BE STRUCTURE AND INCREASE THE POTENTIAL FOR FALLER, AREAS SHOWING SIGNS OF EROSION OR THIN OR DYNG VEGETATION SHOULD BE REPAIRED IMMEDIATELY BY WHATEVER MEANS INCREASES AND THE MAY DESTRUCTURE OF TRAPPED AND RELOCATED IF THE PROBLEM PERSISTS.
- AND THE AMBRAIS SHOULD BE INTAPPED AND RELLOCATED IF THE PROBLEM FERRISIDIS.

 18. THE DETENTION PONDS ARE TO BE CONSTRUCTED PRIMARBLY THROUGH EXCAVATION. IN THOSE AREAS WHERE THE BERMS MUST BE CONSTRUCTED BY THE PLACEMENT OF FILL, THE ENTIRE EMBANGMENT AREA OF THE DETENTION PONDS SHALL BE EXCAVATED TO PROPOSED GRADE, STRIPPED OF ALL ORGANIC MATERIALS, COMPACTED TO AT LEAST 95% AND SCARRIED PROR TO THE PLACEMENT OF THE EMBANGMENT AMERIAL. IN THE EVENT THE FOUNDATION MATERIAL EXPOSED DOES NOT ALLOW THE SPECIFIED COMPACTION, AN ADDITIONAL ONE FOOT (17) OF EXCAVATION AND THE PLACEMENT OF A ONE FOOT (17) THE MATERIAL DESCRIBED IN THE NOTE BELOW, COMPACTED TO 85% OF ASTM D-1557 MAY BE RECESSARY, PLACEMENT AND COMPACTION SHOULD OCCUR AT A MOSITURE CONTENT OF OPTIMEM PLUS OR MINUS 3X, AND NO FROZEN OR ORGANIC MATERIAL SHOULD BE PLACED WITHIN FOR ANY REASON.
- 19. EMBANKMENT MATERIAL FOR THE BERMS SHALL BE CLEAN MINERAL SOIL WITH A CLAY COMPONENT FREE OF ROOTS, ORGANIC MATTER, AND OTHER DELETERIOUS SUBSTANCES, AND SHALL CONTAIN NO ROCKS OR LUMPS OVER FOUR INDHES (4") IN DIAMETER. THIS MATERIAL SHOULD BE INSTALLED IN 8" LIFTS AND COMPACTED TO 85% OS ASTIM D-1557, AND SHOULD MEET THE FOLLOWING SPECIFICATIONS: 4" PASSING 100%, \$4 SIEVE 25-70%, \$200 SIEVE 10-29% (IN TOTAL SAMPLE).
- 20. EMBANKMENT IS TO HAVE 3:1 SIDE SLOPES (MAX.) AND IS TO BE BROUGHT TO SPECIFIED GRADES PRIOR TO THE ADDITION OF LOAM (4" MINIMUM) SO AS TO ALLOW FOR THE COMPACTION OF THE STRUCTURE OVER TIME WHILE MAINTAINING THE PROPER BEEN LELEVATION.
- COMPACTION TESTING SERVICES (I.E. NUCLEAR DENSITY TESTS) ARE TO BE PERFORMED BY AN INDEPENDENT GEOTECHNICAL DISINSER RETAINED BY THE CONTRACTOR FOR ROADWAY CONSTRUCTION, AND ON THE FOUNDATION OF THE BERM AND ON EVERY JET OF NEWLY PLACED MATERIAL.
- 22. SLOPED GRANITE CURB TO BE TIPPED DOWN AT ALL DRIVEWAY ENTRANCES BY THE CONTRACTOR.

GRAPHIC SCALE (IN FEET) 1 inch = 40 ft Horiz. 1 inch = 4 ft Vert.

BAYBERRY LANE

Checked: JAC Scale: AS NOTED Project No.: 21090
Drawing Name: 21090-PLAN.dwg THIS PLAN SHALL NOT BE MODIFIED WITHOUT WRITTEN ERMISSION FROM JONES & BEACH ENGINEERS, INC. (JBE). ANY ALTERATIONS, AUTHORIZED OR OTHERWISE, SHALL BE

AT THE USER'S SOLE RISK AND WITHOUT LIABILITY TO JBE.



DESTRUCTION OF THE PARTY OF THE				
NEW HALL	1			
MICHAEL A	3	3/11/22	REVISED PER CITY COMMENTS	LAZ
KERIVAN	2	2/14/22	REVISED PER CITY ENGINEERING COMMENTS	LAZ
No. 9646	1	1/18/22	REVISED PER CITY COMMENTS	LAZ
CENTED A	0	11/23/21	ISSUED FOR REVIEW	LAŻ
ONL BURNE	REV.	DATE	REVISION	BY
Tona Car	_			

Jones & Beach Engineers, Inc. 85 Portsmouth Ave. Civil Engineering Services FAX: 603-772-0227 PO Box 219 Stratham, NH 03885


E-MAIL: JBE@JONESANDBEACH.COM

PLAN AND PROFILE Plan Name: Project:

BAYBERRY COMMONS 19 OLD GONIC ROAD, ROCHESTER, NH

LEO P. LACOUTURE REV. TRUST & WILLIAN B. LACOUTURE 19 OLD GONIC RD., ROCHESTER, NH 03867 BK 4093 PG 148 Owner of Record:



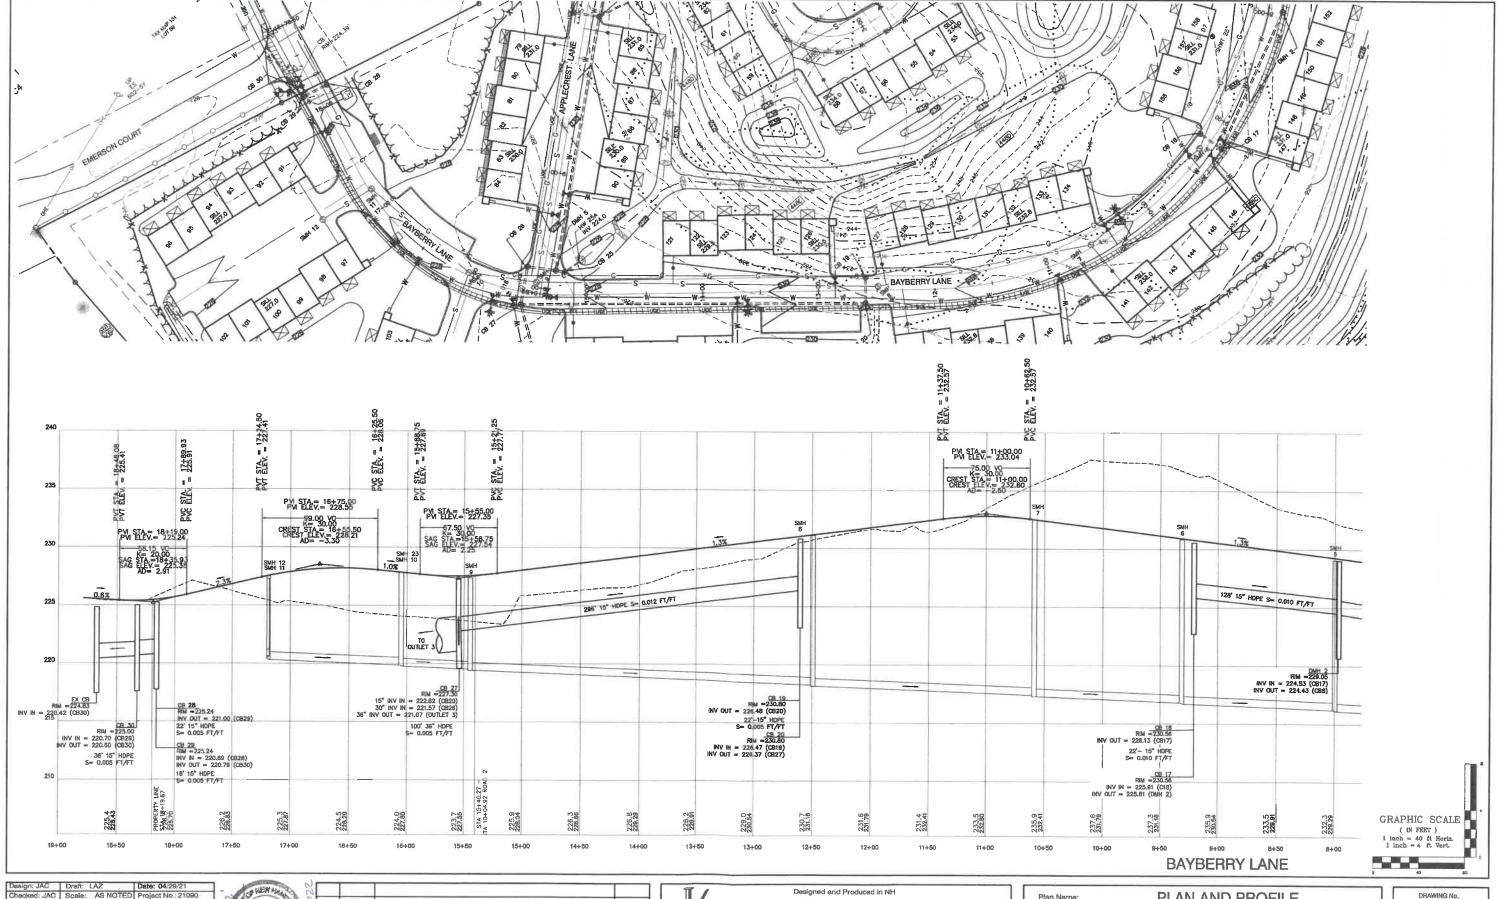

Design: JAC Draft: LAZ Date: 04/29/21
Checked: JAC Scale: AS NOTED Project No.: 21090
Drawing Name: 21090-PLAN.dwg
THIS PLAN SHALL NOT BE MODIFIED WITHOUT WRITTEN
PERMISSION FROM JONES & BEACH ENGINEERS, INC. (JBE).
ANY ALTERATIONS, AUTHORIZED OR OTHERWISE, SHALL BE
AT THE USER'S SOLE RISK AND WITHOUT LIABILITY TO JBE.

	A WEN NAME	22
AL STATE	MICHAEL	2
1	KERWAN No. 1848 Voensed	a C
3	Manthalan 20	ITIN

3	3/11/22	REVISED PER CITY COMMENTS	LAZ
2	2/14/22	REVISED PER CITY ENGINEERING COMMENTS	LAZ
1	1/18/22	REVISED PER CITY COMMENTS	LAZ
0	11/23/21	ISSUED FOR REVIEW	LAZ
REV.	DATE	REVISION	BY

Designed and Produced in NH

Jones & Beach Engineers, Inc.


85 Portsmouth Ave. PO Box 219


Civil Engineering Services
FAX: 603-772-4748
FAX: 603-772-0227

E-MAIL: JBE@JONESANDEBACH.COM

Plan Name:	PLAN AND PROFILE
Project:	BAYBERRY COMMONS 19 OLD GONIC ROAD, ROCHESTER, NH
Owner of Record:	LEO P. LACOUTURE REV. TRUST & WILLIAN B. LACOUTURE 19 OLD GONIC RD., ROCHESTER, NH 03867 BK 4093 PG 148

DRAWING No.
P2
SHEET 25 OF 48
JBE PROJECT NO. 21090

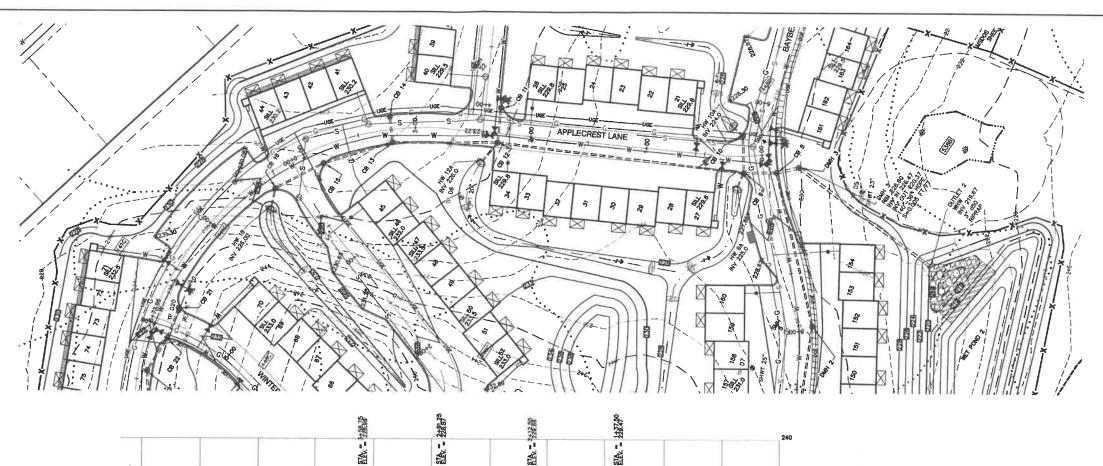

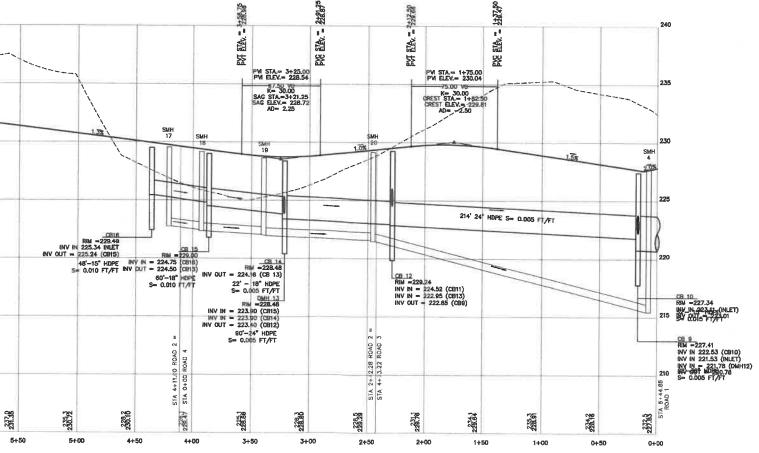

GRAPHIC SCALE (IN FEET)

1 inch = 40 ft Horiz.
1 inch = 4 ft Vert.

		Date: 04/29/21
Checked: JAC	Scale: AS NOTED	Project No.: 21090
	21090-PLAN.dwg	
THIS PLAN SHALL	NOT BE MODIFIED WITH M JONES & BEACH ENG	HOUT WRITTEN

ANY ALTERATIONS, AUTHORIZED OR OTHERWISE, SHALL BE AT THE USER'S SOLE RISK AND WITHOUT LIABILITY TO JBE.

	I I		
3	3/11/22	REVISED PER CITY COMMENTS	LAZ
2	2/14/22	REVISED PER CITY ENGINEERING COMMENTS	LAZ
1	1/18/22	REVISED PER CITY COMMENTS	LAZ
0	11/23/21	ISSUED FOR REVIEW	LAZ
REV.	DATE	REVISION	BY

Jones & Beach Engineers, Inc. Services 603-772-4746 FAX: 603-772-0227 E-MAIL: JBE@JONESANDBEACH.COM 85 Portsmouth Ave. PO Box 219
Stratham, NH 03885

Civil Engineering Services
E-MAIL: JBE@


Plan Name:	PLAN AND PROFILE


BAYBERRY COMMONS 19 OLD GONIC ROAD, ROCHESTER, NH

APPLECREST LANE

LEO P. LACOUTURE REV. TRUST & WILLIAN B. LACOUTURE 19 OLD GONIC RD., ROCHESTER, NH 03867 BK 4093 PG 148 Owner of Record:

DRAWING No. **P3** SHEET 26 OF 46 JBE PROJECT NO.21090

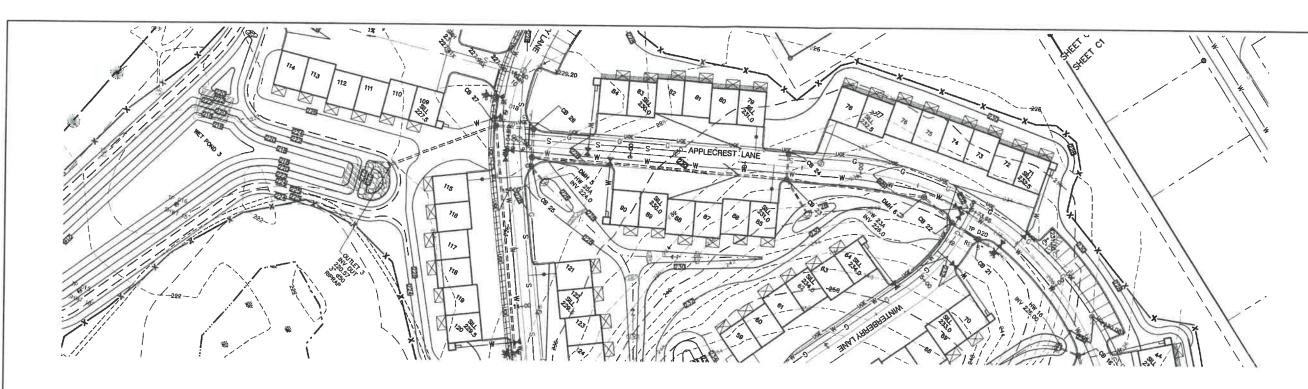

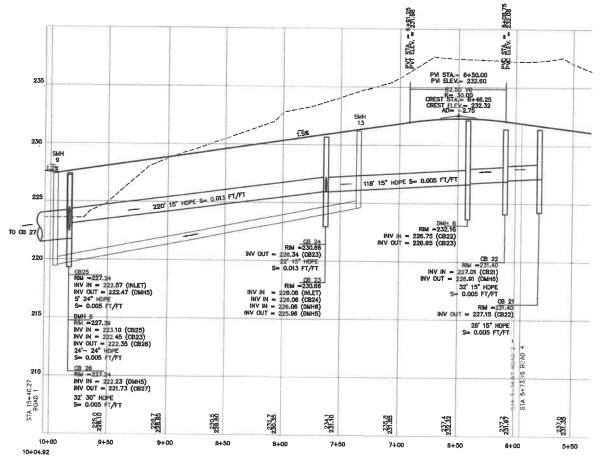

GRAPHIC SCALE (IN FEET)

1 inch = 40 ft Horiz.
1 inch = 4 ft Vert.

APPLECREST LANE

Design: JAC	Draft:	LAZ	Date: 04/29/21
Checked: JAC	Scale:	AS NOTED	Project No.: 21090
Drawing Name:	21090-F	PLAN.dwg	
THO DI AN OLIVA			

THIS PLAN SHALL NOT BE MODIFIED WITHOUT WRITTEN PERMISSION FROM JONES & BEACH ENGINEERS, INC. (JBE). ANY ALTERATIONS, AUTHORIZED OR OTHERWISE, SHALL BE AT THE USER'S SOLE RISK AND WITHOUT LIABILITY TO JBE.




0	11/23/21	ISSUED FOR REVIEW	LAZ
1	1/18/22	REVISED PER CITY COMMENTS	LAZ
2	2/14/22	REVISED PER CITY ENGINEERING COMMENTS	LAZ
3	3/11/22	REVISED PER CITY COMMENTS	LAZ


Ĩ /		De	signed and Pro	duced in NH		
BIG	ones	&	Beach	n Engir	ieers,	Inc.
85 Portsmouth Ave. PO Box 219	Civil	Eng	ineering	Services	603 FAX: 603	3-772-4746 3-772-0227
Stratham, NH 03885				E-MAIL: JBE@L		

E-MAIL: JBE@JONESANDBEACH.COM

Plan Name:	PLAN AND PROFILE
Project:	BAYBERRY COMMONS 19 OLD GONIC ROAD, ROCHESTER, NH
Owner of Record:	LEO P. LACOUTURE REV. TRUST & WILLIAN B. LACOUTURE 19 OLD GONIC RD., ROCHESTER, NH 03867 BK 4093 PG 148

DRAWING No. **P4** SHEET 27 OF 46 JBE PROJECT NO.21090

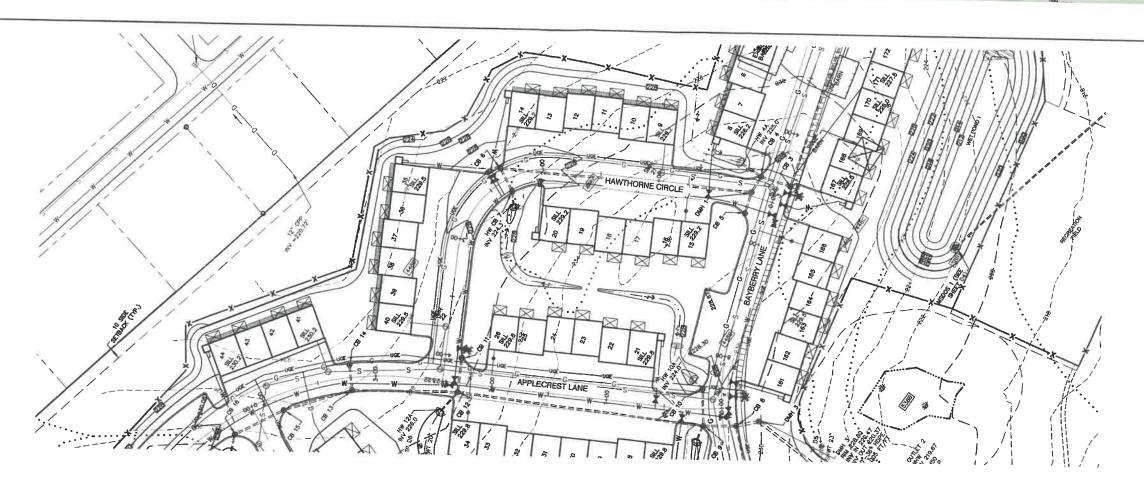

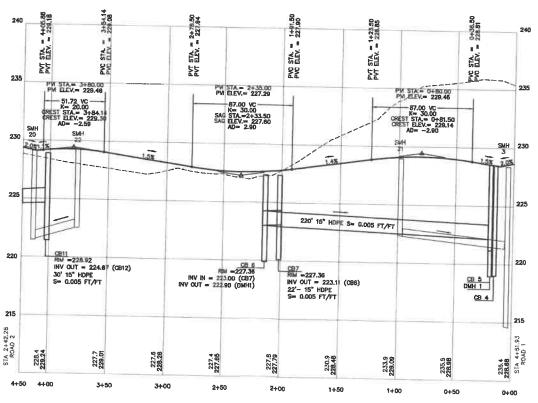

GRAPHIC SCALE
(IN FEST)
1 inch = 40 ft Horiz.
1 inch = 4 ft Vert.

Design: JAC	Draft: LAZ	Date: 04/29/21
Checked: JAC	Scale: AS NOTED	Project No.:21090
Drawing Name:	21090-PLAN.dwg	FTOJECT NO.: 21090

THIS PLAN SHALL NOT BE MODIFIED WITHOUT WRITTEN
PERMISSION FROM JONES & BEACH ENGINEERS, INC. (JBE).
ANY ALTERATIONS, AUTHORIZED OR OTHERWISE, SHALL BE
AT THE USER'S SOLE RISK AND WITHOUT LIABILITY TO JBE.



3	3/11/22	REVISED PER CITY COMMENTS	LAZ
2	2/14/22	REVISED PER CITY ENGINEERING COMMENTS	LAZ
1	1/18/22	REVISED PER CITY COMMENTS	LAZ
0	11/23/21	ISSUED FOR REVIEW	LAZ
REV.	DATE	REVISION	BY

Designed and Produced In NH

Jones & Beach Engineers, Inc.


85 Portsmouth Ave. PO Box 219 Engineering Services FAX: 603-772-4746
FAX: 603-772-0227
Strathern, NH 03885 E-MAIL: JBE@JONESANDBEACH.COM


	HAWTHORNE CIRCLE
Plan Name:	PLAN AND BROEF F
	PLAN AND PROFILE

Project: BAYBERRY COMMONS
19 OLD GONIC ROAD, ROCHESTER, NH

Owner of Record: LEO P. LACOUTURE REV. TRUST & WILLIAN B. LACOUTURE
19 OLD GONIC RD., ROCHESTER, NH 03867 BK 4093 PG 148

P5 SHEET 28 OF 48 JBE PROJECT NO.21090

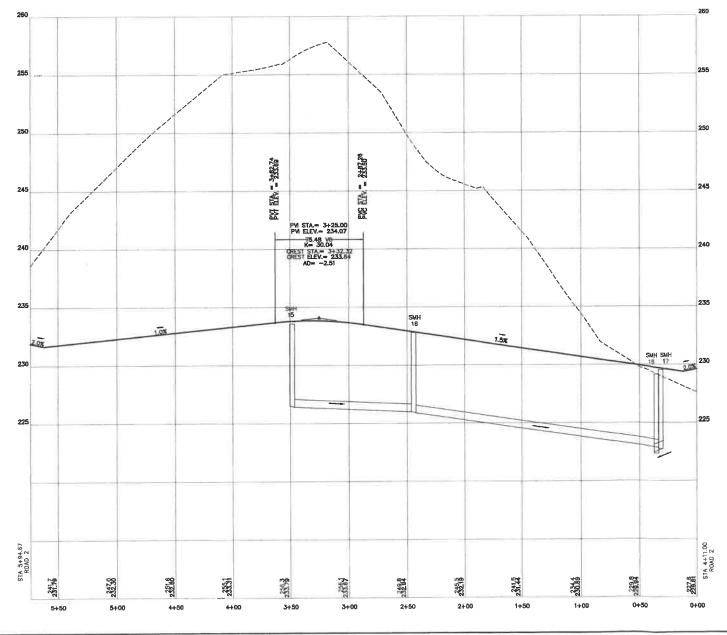

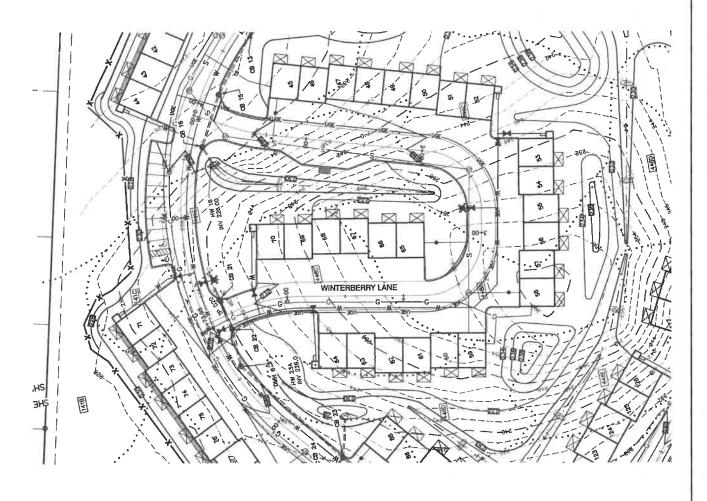

WINTERBERRY LANE

GRAPHIC SCALE
(IN FEET)
1 inch = 40 ft Horiz.
1 inch = 4 ft Vert.

Design: JAC	Dreft: LAZ	Date: 04/29/21
Checked: JAC	Scale: AS NOTED 21090-PLAN.dwg	Project No.: 21090
Drawing Name:	21090-PLAN.dwg	

THIS PLAN SHALL NOT BE MODIFIED WITHOUT WRITTEN
PERMISSION FROM JONES & BEACH ENGINEERS, INC. (JBE).
ANY ALTERATIONS, AUTHORIZED OR OTHERWISE, SHALL BE
AT THE USER'S SOLE RISK AND WITHOUT LIABILITY TO JBE.




3	3/11/22	REVISED PER CITY COMMENTS	LAZ
2	2/14/22	REVISED PER CITY ENGINEERING COMMENTS	LAZ
1	1/18/22	REVISED PER CITY COMMENTS	LAZ
0	11/23/21	ISSUED FOR REVIEW	LAZ
REV.	DATE	REVISION	BY

Designed and Produced in NH Jones & Beach Engineers, Inc.

85 Portsmouth Ave. Civil Engineering Services
PO Box 219
Stratham, NH 03885
E-MAIL: JBE@

Services 603-772-4748 FAX: 603-772-0227 E-MAIL: JBE@JONESANDBEACH.COM

Plan Name:	PLAN AND PROFILE
Project:	BAYBERRY COMMONS 19 OLD GONIC ROAD, ROCHESTER, NH
Owner of Record	LEO P. LACOUTURE REV. TRUST & WILLIAN B. ŁACOUTURE 19 OLD GONIC RD., ROCHESTER, NH 03867 BK 4093 PG 148

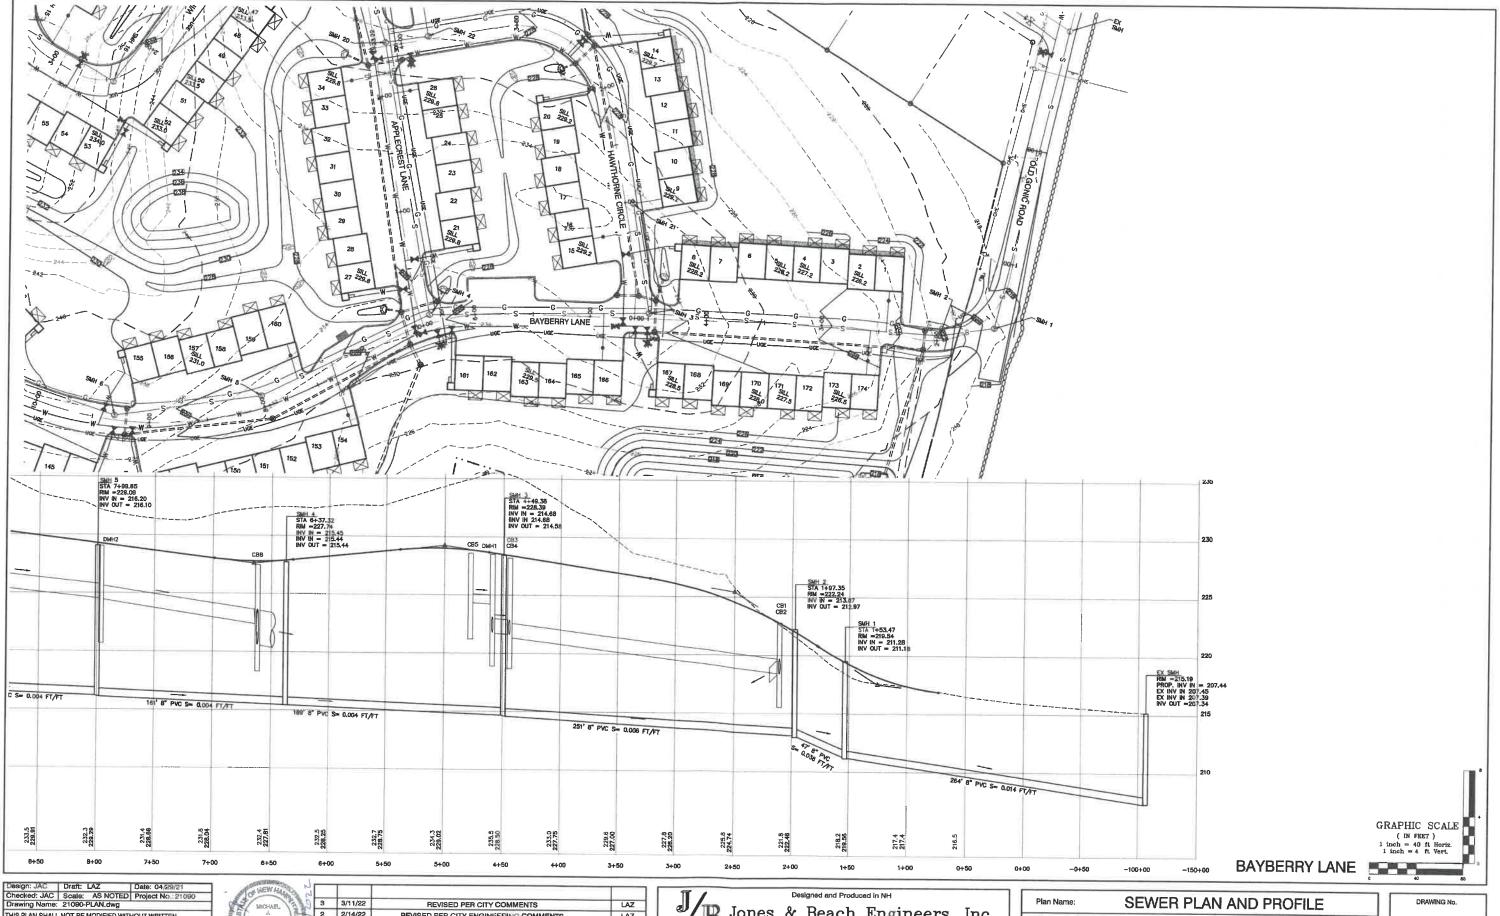

2 2/14/22 REVISED PER CITY ENGINEERING COMMENTS LAZ 1 1/18/22 REVISED PER CITY COMMENTS LAZ 0 11/23/21 LAZ ISSUED FOR REVIEW REV. DATE REVISION

Jones & Beach Engineers, Inc.


85 Portsmouth Ave. PO Box 219
Stratham, NH 03885

Civil Engineering Services

E-MAIL: JBE© Services 603-772-4746 FAX: 603-772-0227 E-MAIL: JBE@JONESANDBEACH.COM

Plan Name:	SEWER PLAN AND PROFILE
Project:	BAYBERRY COMMONS 19 OLD GONIC ROAD, ROCHESTER, NH
Owner of Record:	LEO P. LACOUTURE REV. TRUST & WILLIAN B. LACOUTURE 19 OLD GONIC RD., ROCHESTER, NH 03867 BK 4093 PG 148

P7 SHEET 30 OF 46 JBE PROJECT NO.21090

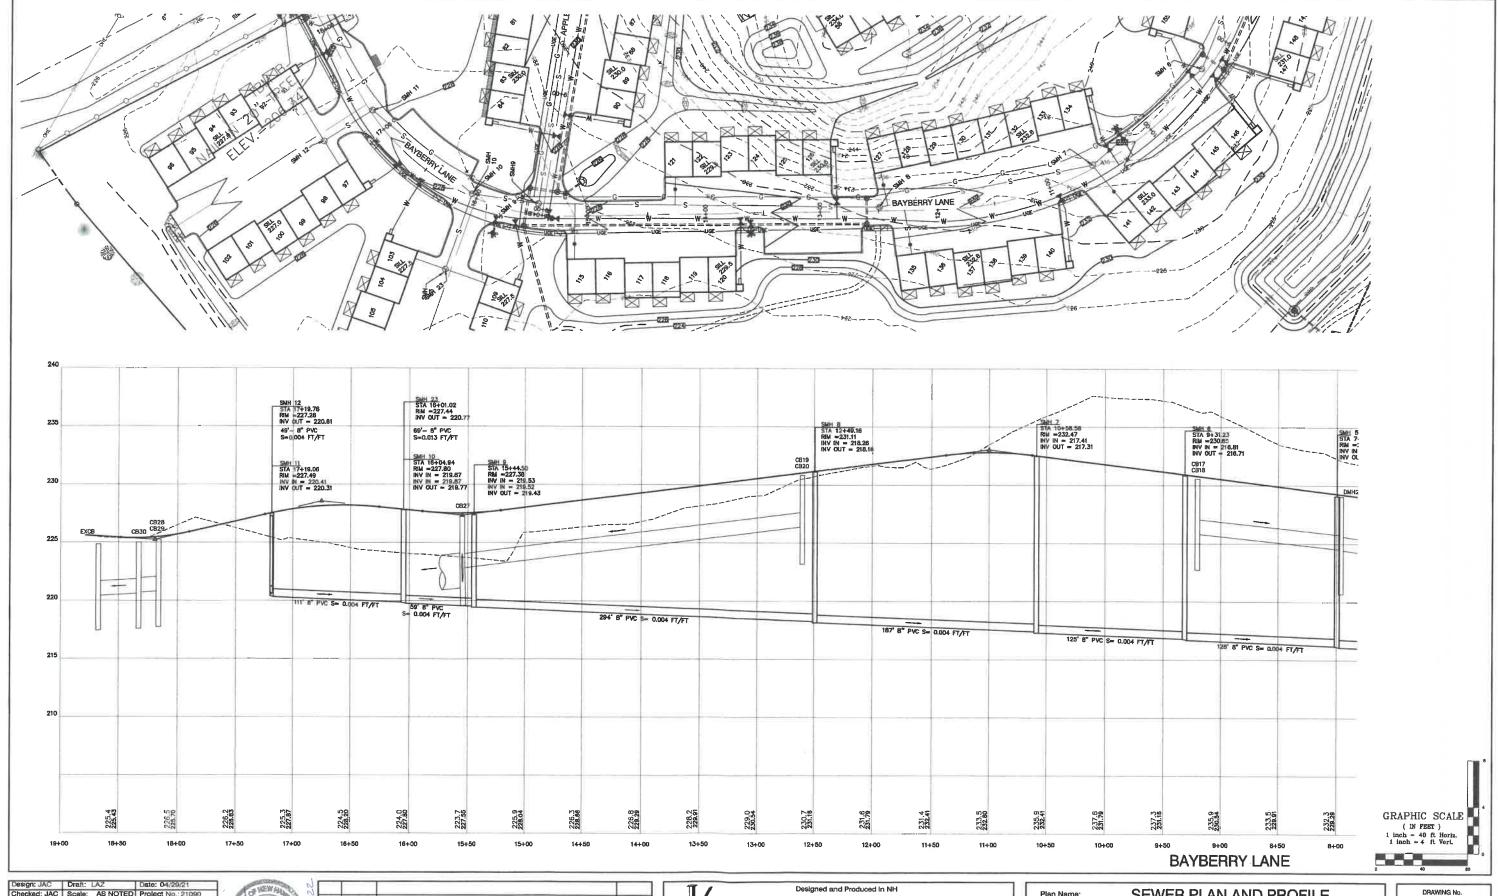


3	3/11/22	REVISED PER CITY COMMENTS	LAZ
2	2/14/22	REVISED PER CITY ENGINEERING COMMENTS	LAZ
1	1/18/22	REVISED PER CITY COMMENTS	LAZ
0	11/23/21	ISSUED FOR REVIEW	LAZ
REV.	DATE	REVISION	BY


Jones & Beach Engineers, Inc. B5 Portsmouth Ave. Civil Engineering Services
PO Box 219
Stratham, NH 03885
E-MAIL: JBE@ 603-772-4746 Services
FAX: 603-772-0227
E-MAIL: JBE@JONESANDBEACH,COM

Owner of Record:

SEWER PLAN AND PROFILE Plan Name: BAYBERRY COMMONS 19 OLD GONIC ROAD, ROCHESTER, NH Project: LEO P. LACOUTURE REV. TRUST & WILLIAN B. LACOUTURE 19 OLD GONIC RD., ROCHESTER, NH 03867 BK 4093 PG 148

P8 SHEET 31 OF 46 JBE PROJECT NO.21090

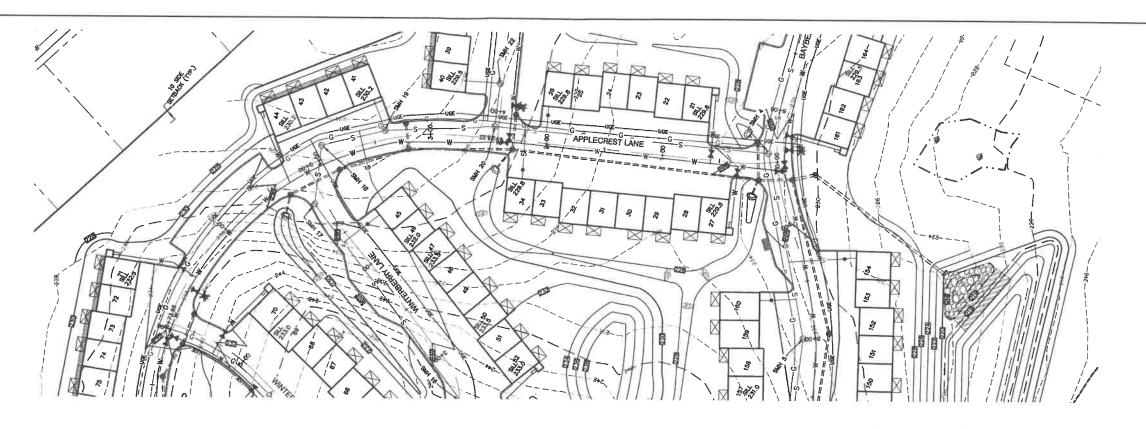

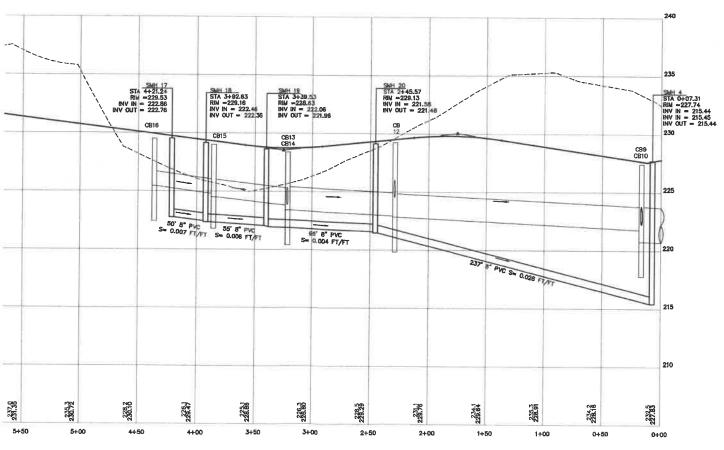

GRAPHIC SCALE
(IN FEET)
1 inch = 40 ft Horiz.
1 inch = 4 ft Vert.

Design: JAC	Draft: LAZ	Date: 04/29/21
Checked: JAC	Scale: AS NOTED	Project No.: 21090
Drawing Name:	21090-PLAN.dwg	

THIS PLAN SHALL NOT BE MODIFED WITHOUT WRITTEN PERMISSION FROM JONES & BEACH ENGINEERS, INC. (JBE). ANY ALTERATIONS, AUTHORIZED OR OTHERWISE, SHALL BE AT THE USER'S SOLE RISK AND WITHOUT LIABILITY TO JBE.

П		
3	3/11/22	REVISED
2	2/14/22	REVISED PER CIT
	1/18/22	REVISED F
\	11/23/21	ISSU
EV.	DATE	

REVISED PER CITY COMMENTS	LAZ	1
ED PER CITY ENGINEERING COMMENTS	LAZ	
REVISED PER CITY COMMENTS	LAZ	:
ISSUED FOR REVIEW	LAZ	5
REVISION	BY	


11		De	signed and Pro	duced in NH		
B Jo	ones	&	Beach	n Engir	neers,	Inc.
85 Portsmouth Ave. PO Box 219 Stratham, NH 03885	Civil	Eng	ineering	Services	FAX: 603	3-772-4746 3-772-0227


Plan Name:	SEWER PLAN AND PROFILE
Project:	BAYBERRY COMMONS 19 OLD GONIC ROAD, ROCHESTER, NH
Owner of Record:	LEO P. LACOUTURE REV. TRUST & WILLIAN B. LACOUTURE 19 OLD GONIC RD., ROCHESTER, NH 03867 BK 4093 PG 148

APPLECREST LANE

DRAWING No.

P9
SHEET 32 OF 46
JBE PROJECT NO.21090

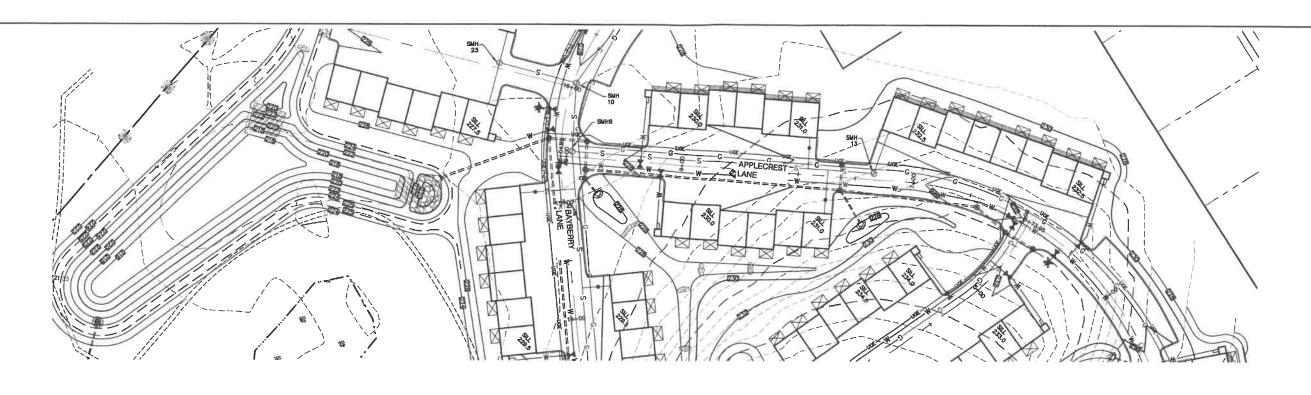

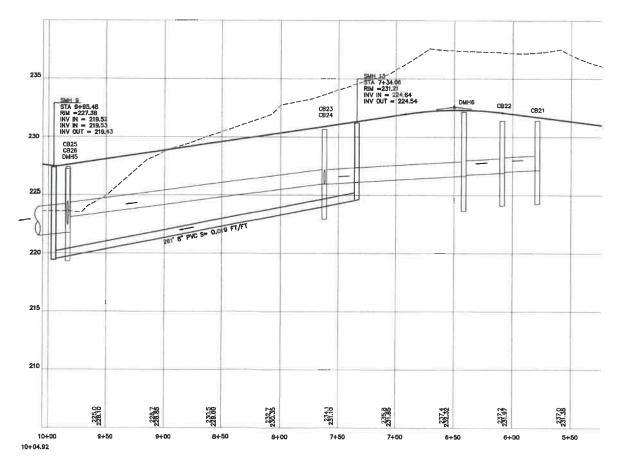

(IN FEET)

1 inch = 40 ft Horiz.
1 lnch = 4 ft Vert.

Design: JAC Draft: LAZ Date: 04/29/21
Checked: JAC | Scale: AS NOTED | Project No.: 21090
Drawling Name: 21090-PLAN.dwg
THIS PLAN SHALL NOT BE MODIFIED WITHOUT WRITTEN

THIS PLAN SHALL NOT BE MODIFIED WITHOUT WRITTEN PERMISSION FROM JONES & BEACH ENGINEERS, INC. (JBE). ANY ALTERATIONS, AUTHORIZED OR OTHERWISE, SHALL BE AT THE USER'S SOLE RISK AND WITHOUT LIABILITY TO JBE.



3	3/11/22	REVISED PER CITY COMMENTS	LAZ
2	2/14/22	REVISED PER CITY ENGINEERING COMMENTS	LAZ
1	1/18/22	REVISED PER CITY COMMENTS	LAZ
0	11/23/21	ISSUED FOR REVIEW	LAZ
REV.	DATE	REVISION	BY

Jones & Beach Engineers, Inc.

85 Portsmouth Ave. PO Box 219
Stratham, NH 03885

Designed and Produced In NH


Reach Engineers, Inc.


603-772-4748
FAX: 603-772-0227
E-MAIL: JBE@JONESANDBEACH.COM

Plan Name:	PLAN AND PROFILE
Project:	BAYBERRY COMMONS 19 OLD GONIC ROAD, ROCHESTER, NH
Owner of Record:	LEO P. LACOUTURE REV. TRUST & WILLIAN B. LACOUTURE 19 OLD GONIC RD., ROCHESTER, NH 03867 BK 4093 PG 148

P10
SHEET 33 OF 46
JBE PROJECT NO.2109

GRAPHIC SCALE

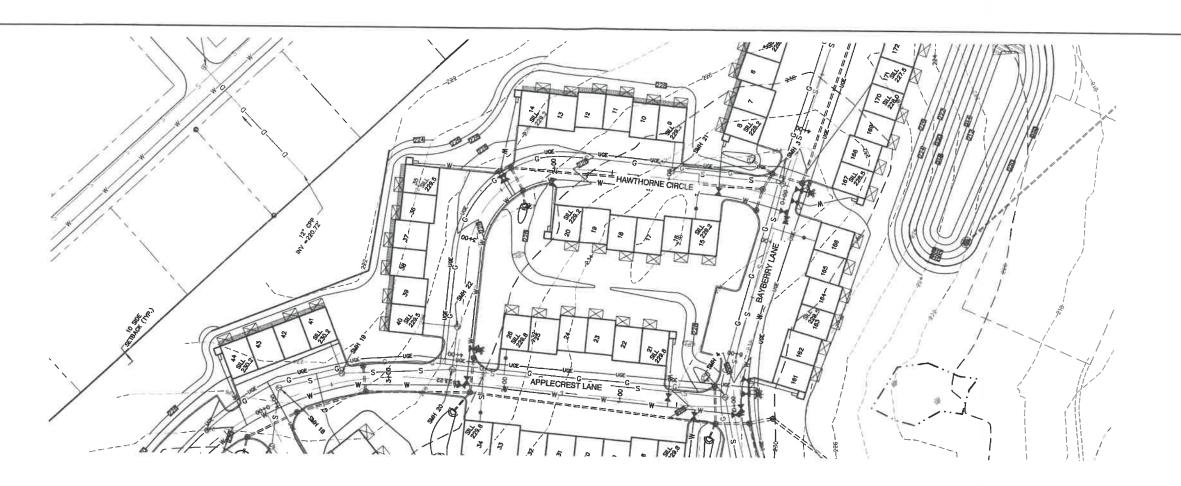

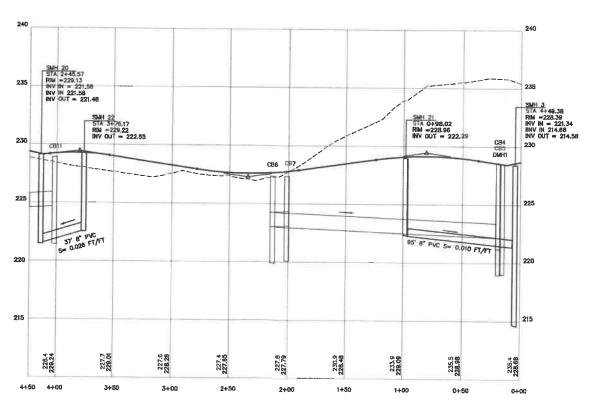

LAZ LAZ

LAZ

LAZ

BY

GRAPHIC SCALE
(IN FEET)
1 Inch = 40 ft Horiz.
1 inch = 4 ft Vert.

Drawing Name:	21090-PLAN.dwg	
Checked: JAC	Scale: AS NOTED	Project No.: 21090
Design: JAC		Date: 04/29/21

THIS PLAN SHALL NOT BE MODIFIED WITHOUT WRITTEN PERMISSION FROM JONES & BEACH ENGINEERS, INC. (JBE). ANY ALTERATIONS, AUTHORIZED OR OTHERWISE, SHALL BE AT THE USER'S SOLE RISK AND WITHOUT LIABILITY TO JBE.

THE PERSON NAMED IN	$\overline{}$		
EMHAT N			
CHAPL 3	3	3/11/22	REVISED PER CITY COMMENTS
J. BUAN	2	2/14/22	REVISED PER CITY ENGINEERING COMMENTS
9846	1	1/18/22	REVISED PER CITY COMMENTS
NATED IN	0	11/23/21	ISSUED FOR REVIEW
C. S. Commercial	REV.	DATE	REVISION


Designed and Produced in NH Jones & Beach Engineers, Inc.


85 Portsmouth Ave. Civil Engineering Services 603-772-4746
PO Box 219
Stratham, NH 03865 E-MAIL: JBE@JONESANDBEACH.COM

Plan Name:	SEWER PLAN AND PROFILE
Project:	BAYBERRY COMMONS 19 OLD GONIC ROAD, ROCHESTER, NH
Owner of Record:	LEO P. LACOUTURE REV. TRUST & WILLIAN B. LACOUTURE 19 OLD GONIC RD., ROCHESTER, NH 03867 BK 4093 PG 148

HAWTHORNE CIRCLE

P11
SHEET 34 OF 46
JBE PROJECT NO.21090

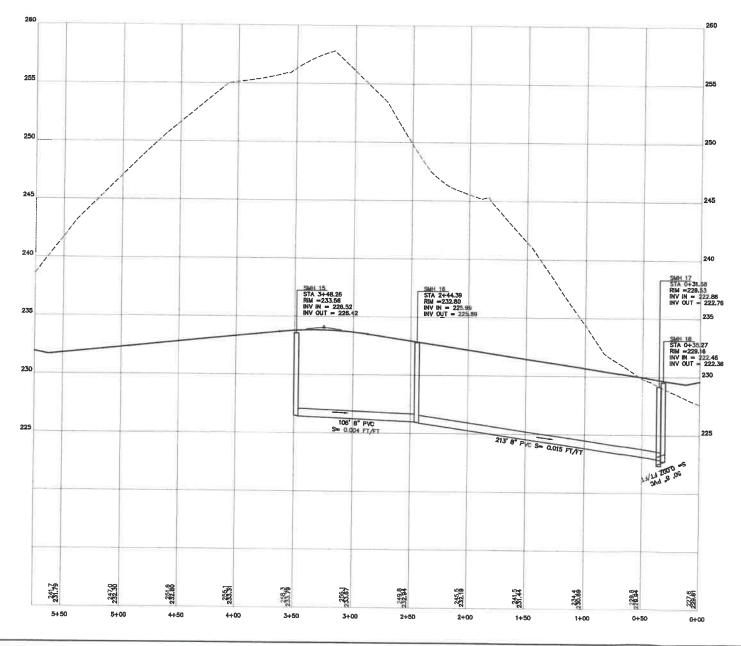

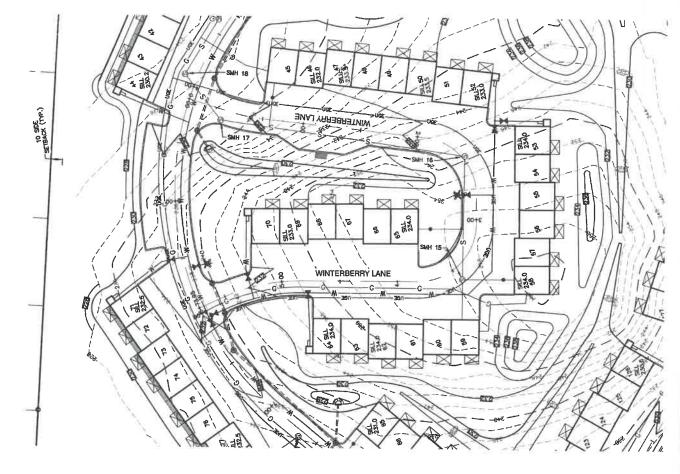

GRAPHIC SCALE

(IN FEET)

1 Inch = 40 ft Horiz.
1 inch = 4 ft Vert.

WINTERBERRY LANE

Design: JAC		Date: 04/29/21
Checked: JAC	Scale: AS NOTED	Project No.: 21090
Drawing Name:	21090-PLAN.dwg	

THIS PLAN SHALL NOT BE MODIFIED WITHOUT WRITTEN
PERMISSION FROM JONES & BEACH ENGINEERS, INC. (JBE).
ANY ALTERATIONS, AUTHORIZED OR OTHERWISE, SHALL BE
AT THE USER'S SOLE RISK AND WITHOUT LIABILITY TO JBE.



3	3/11/22	REVISED PER CITY COMMENTS	LAZ
2	2/14/22	REVISED PER CITY ENGINEERING COMMENTS	LAZ
1	1/18/22	REVISED PER CITY COMMENTS	LAZ
0	11/23/21	ISSUED FOR REVIEW	LAZ
REV.	DATE	REVISION	BY

Designed and Produced in NH


Jones & Beach Engineers, Inc.


85 Portsmouth Ave. PO Box 219
Stratham, NH 03885

Civil Engineering Services
FAX: 603-772-4746
FAX: 603-772-0227
E-MAIL: JBE@JONESANDBEACH.COM

	Plan Name:	SEWER PLAN AND PROFILE
19 OLD GONIC ROAD ROCHESTER NH	Project:	BAYBERRY COMMONS 19 OLD GONIC ROAD, ROCHESTER, NH

P12
SHEET 35 OF 46
JBE PROJECT NO.21090

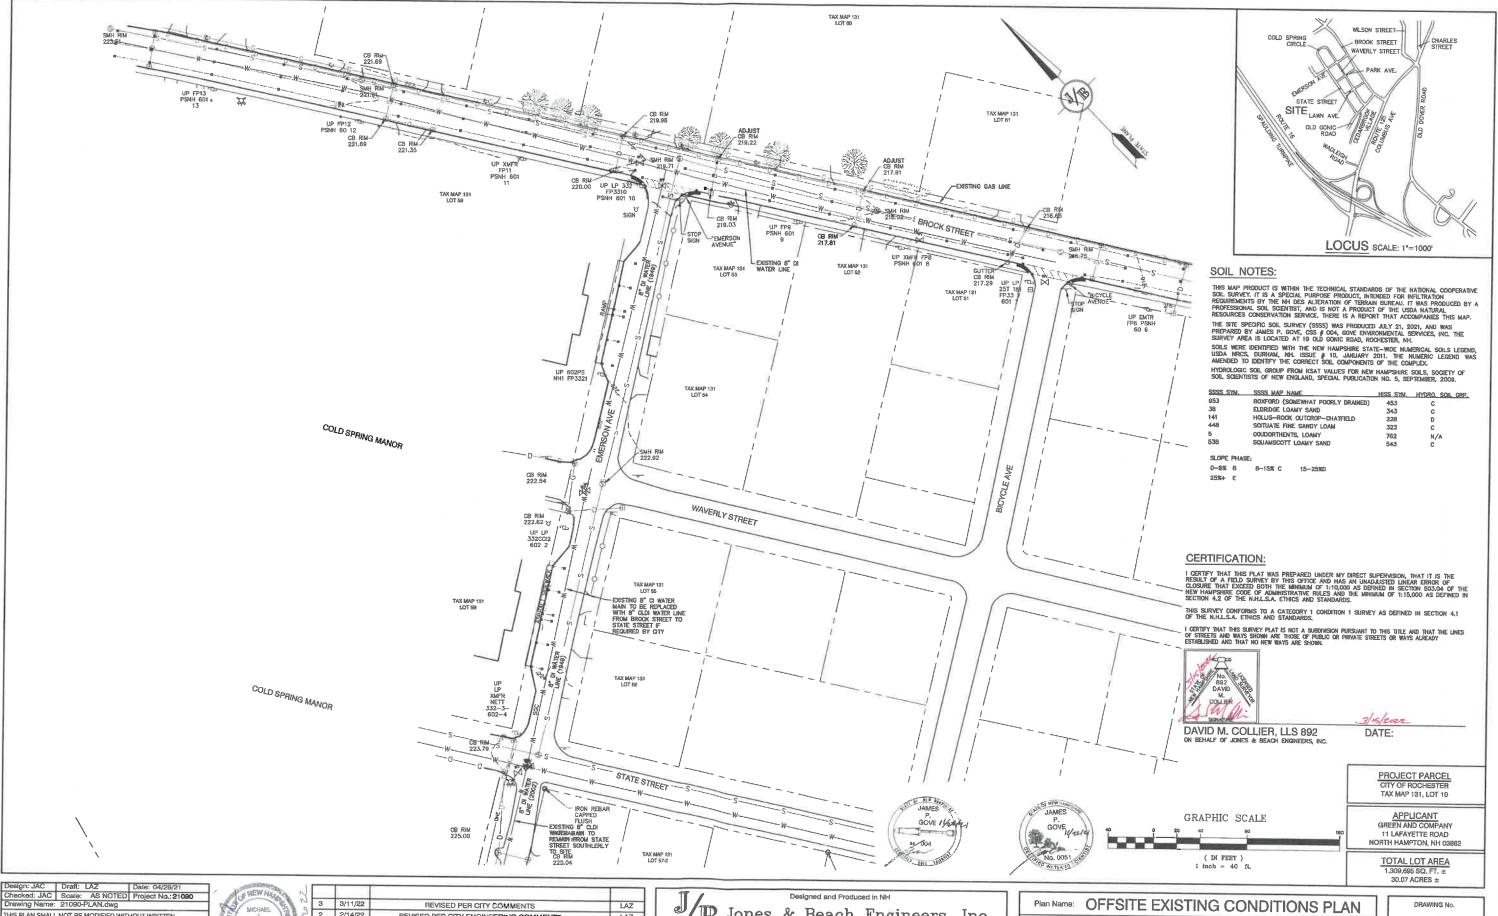

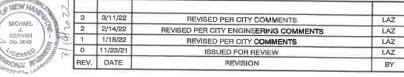


Jones & Beach Engineers, Inc.


85 Portsmouth Ave. Civil Engineering Services 603-772-4746 FAX: 603-772-0227 PO Box 219 Stratham, NH 03885 E-MAIL: JBE@JONESANDBEACH.COM

BAYBERRY COMMONS 19 OLD GONIC ROAD, ROCHESTER, NH

Owner of Record: LEO P. LACOUTURE REV. TRUST & WILLIAN B. LACOUTURE 19 OLD GONIC RD., ROCHESTER, NH 03867 BK 4093 PG 148



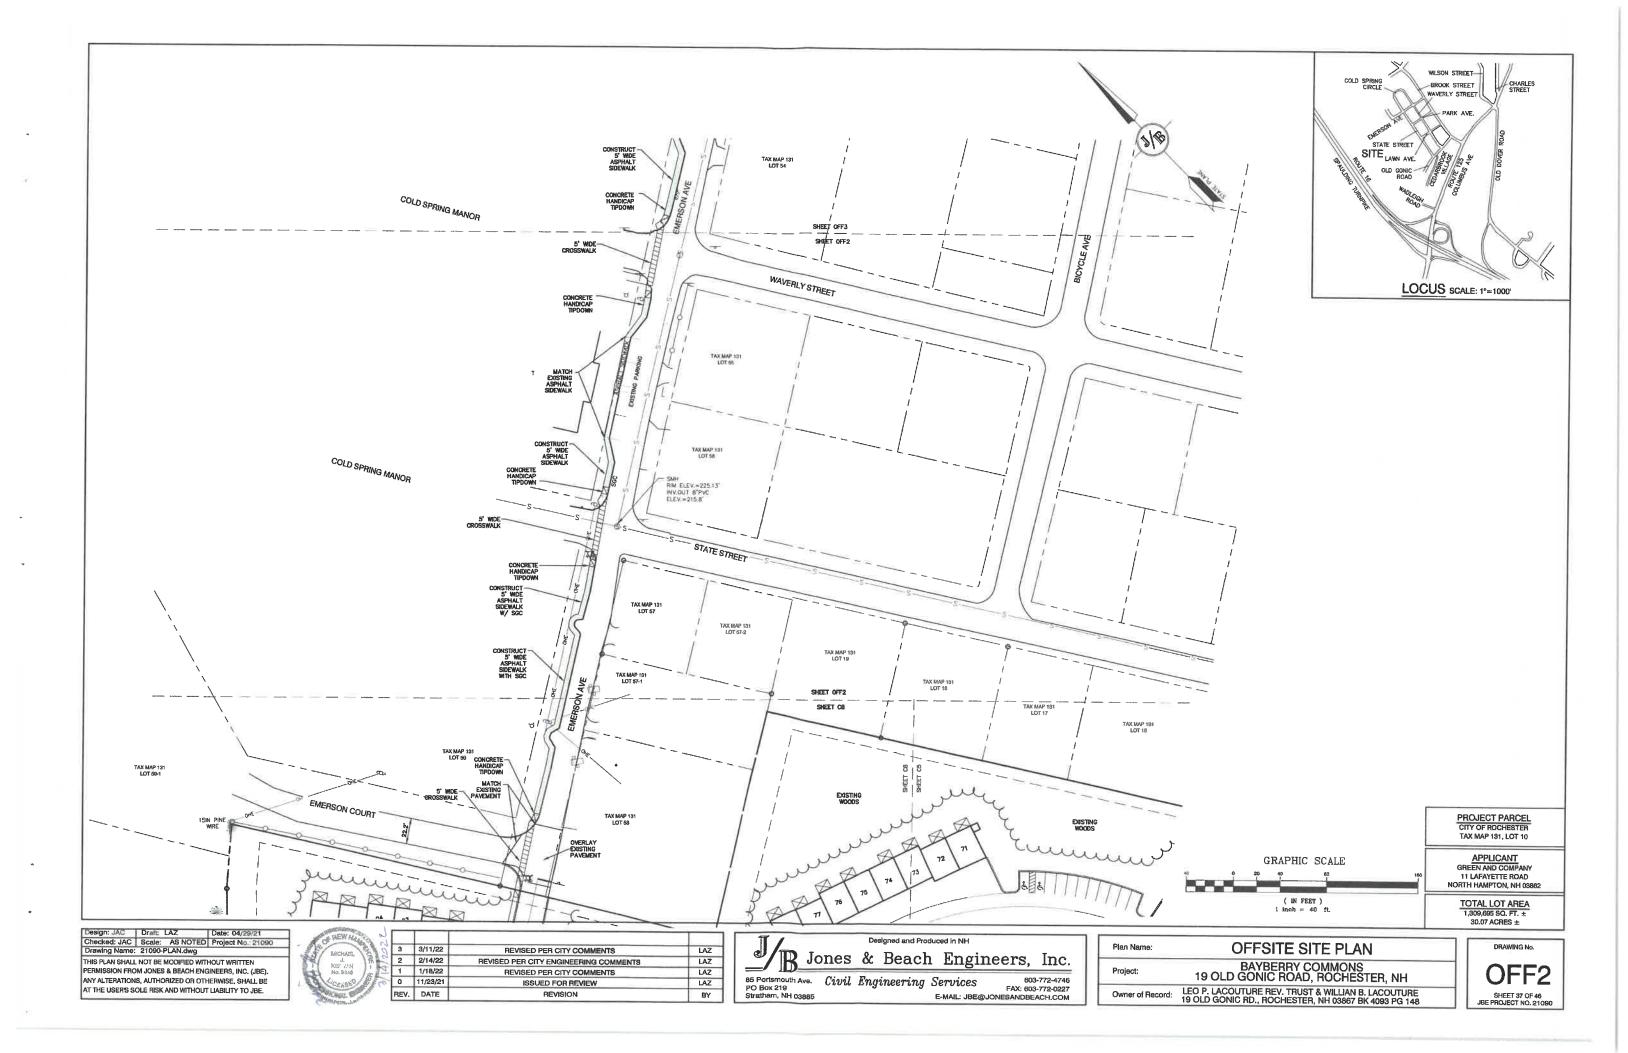

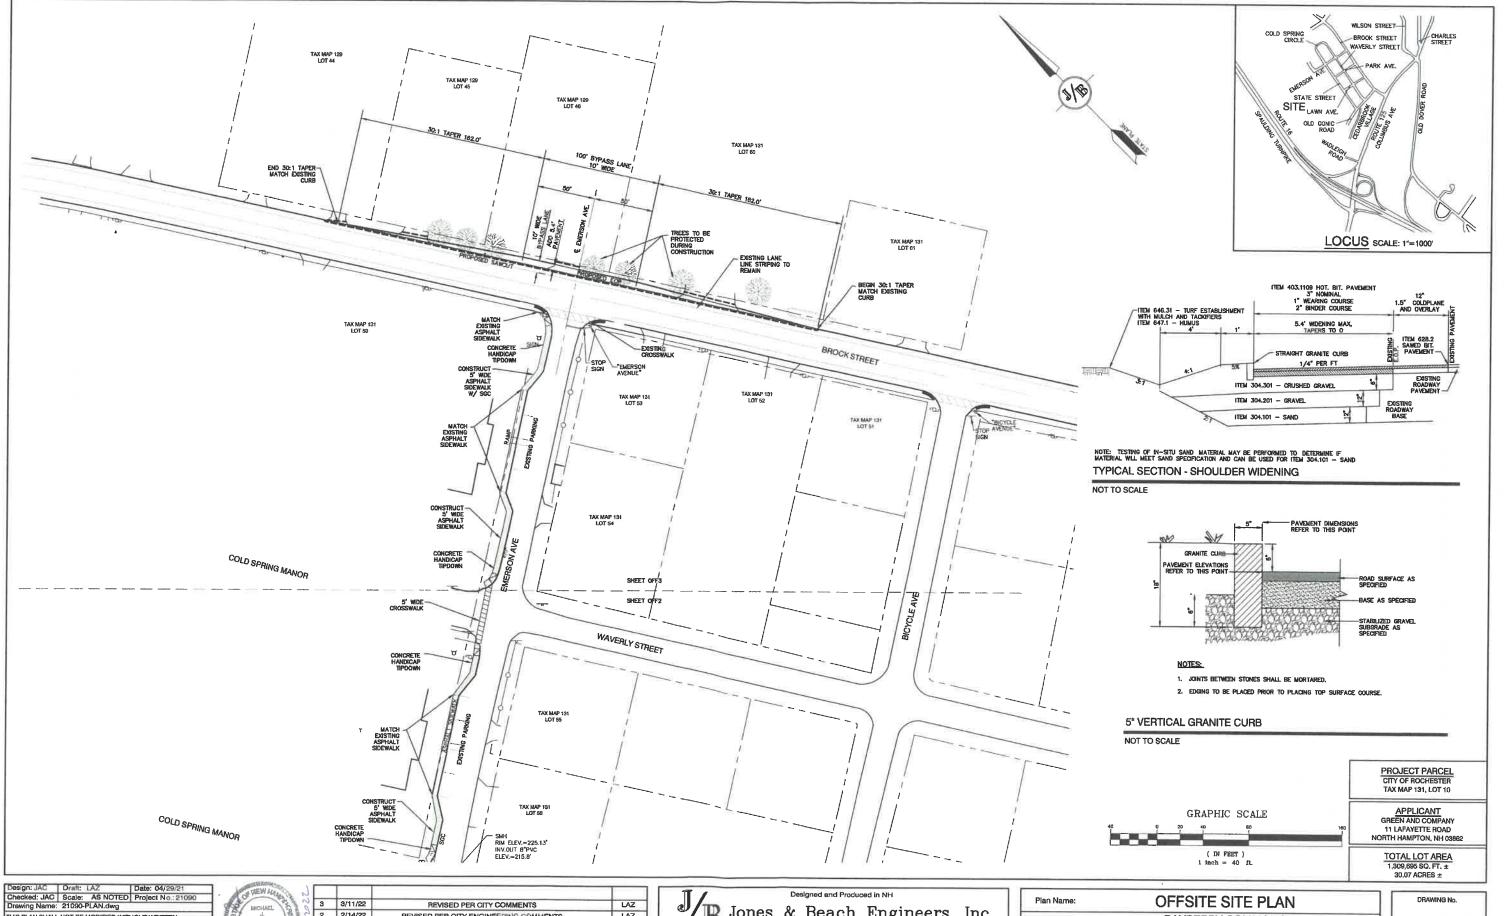




3	3/11/22	REVISED PER CITY COMMENTS	LAZ
2	2/14/22	REVISED PER CITY ENGINEERING COMMENTS	LAZ
1	1/18/22	REVISED PER CITY COMMENTS	LAZ
0	11/23/21	ISSUED FOR REVIEW	LAZ
REV.	DATE	REVISION	BY

Jones & Beach Engineers, Inc.

85 Portsmouth Ave. Civil Engineering Services
PO Box 219
Stratham, NH 03885 E-MALL: JBE@ FAX: 603-772-0227 E-MAIL: JBE@JONESANDBEACH.COM

BAYBERRY COMMONS 19 OLD GONIC ROAD, ROCHESTER, NH Project: Owner of Record: LEO P. LACOUTURE REV. TRUST & WILLIAN B. LACOUTURE 19 OLD GONIC RD., ROCHESTER, NH 03867 BK 4093 PG 148

OFF3 SHEET 38 OF 46 JBE PROJECT NO. 21090

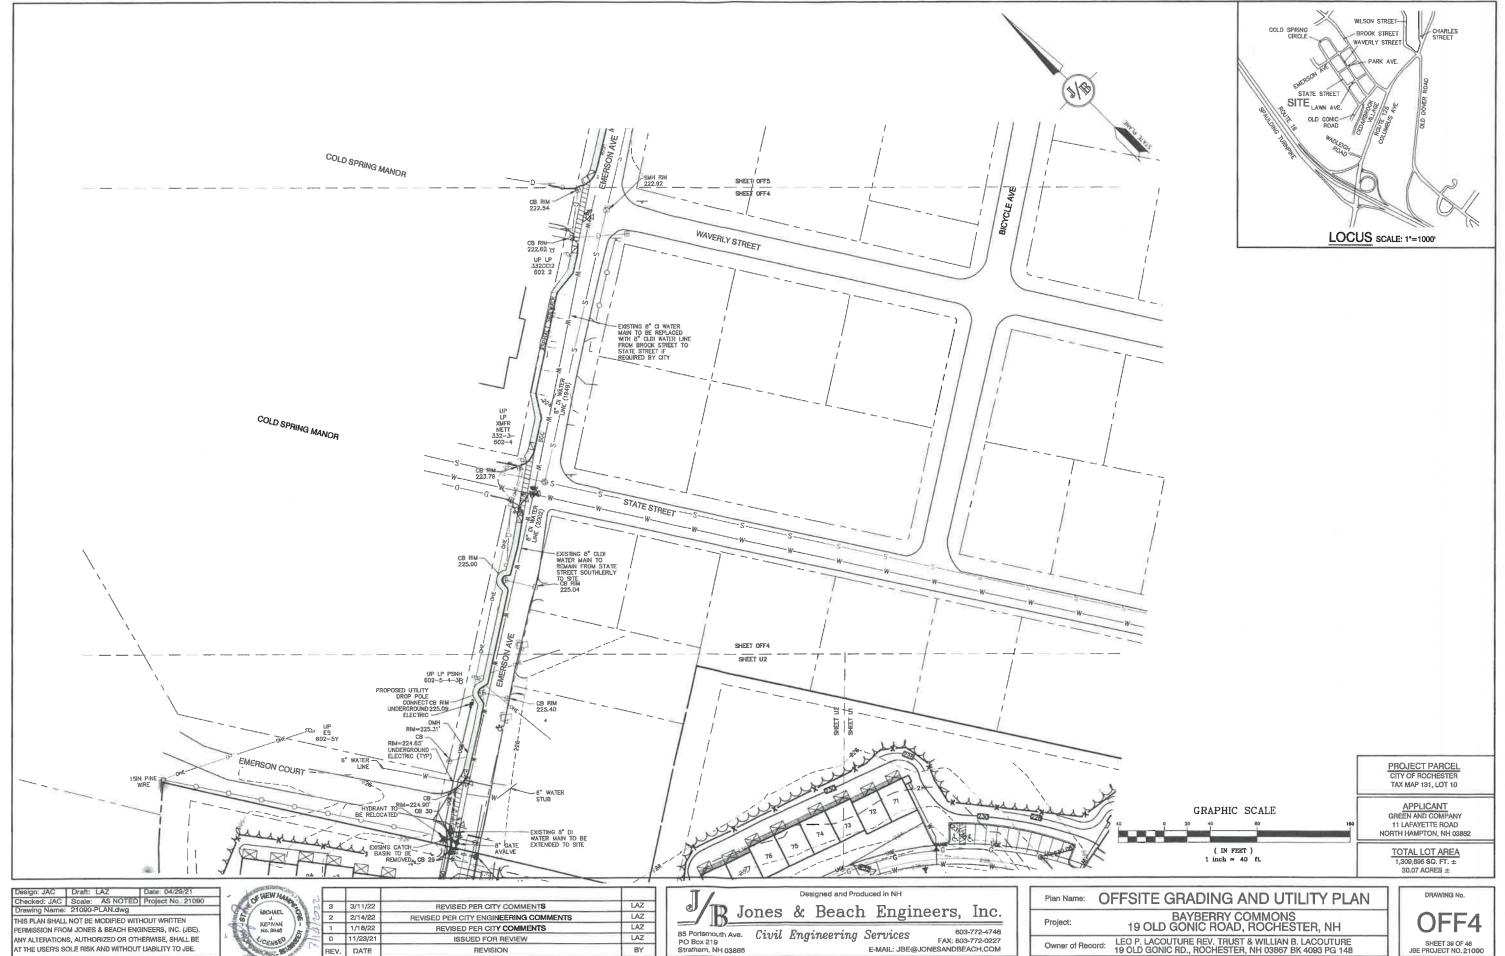


AT THE USER'S SOLE RISK AND WITHOUT LIABILITY TO JBE.


REV. DATE

REVISION

BY

SHEET 39 OF 46 JBE PROJECT NO. 21090

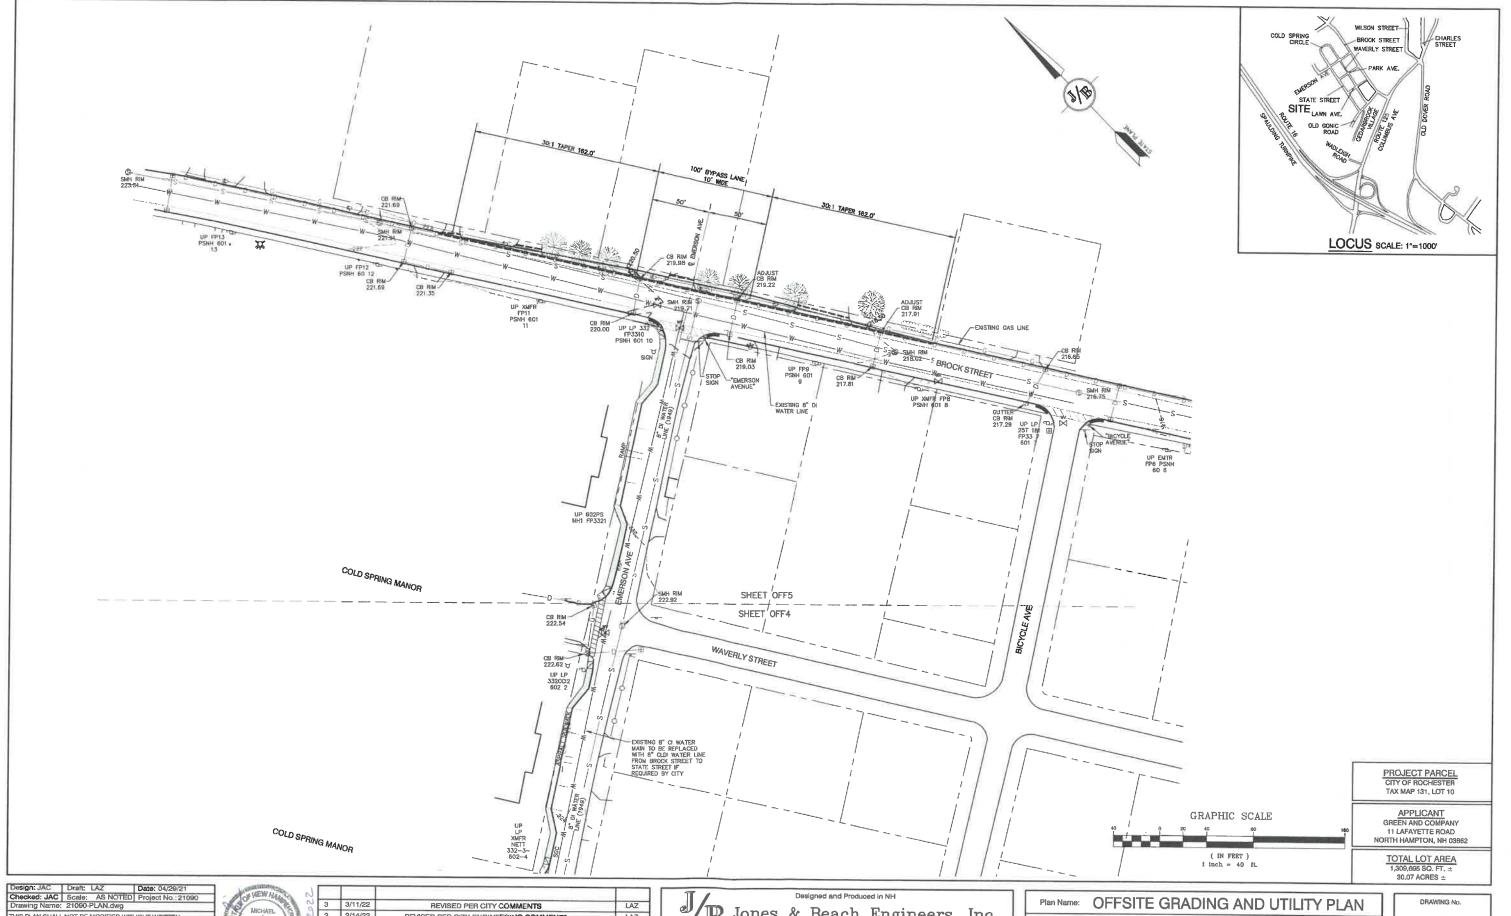

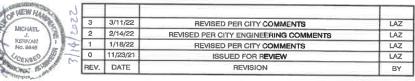


Jones & Beach Engineers, Inc.

85 Portsmouth Ave. Civil Engineering Services
PO Box 219
Stratham, NH 03885
E-MAIL: JBE@ Services 603-772-4746 FAX: 603-772-0227 E-MAIL: JBE@JONESANDBEACH.COM

BAYBERRY COMMONS 19 OLD GONIC ROAD, ROCHESTER, NH


LEO P. LACOUTURE REV. TRUST & WILLIAN B. LACOUTURE 19 OLD GONIC RD., ROCHESTER, NH 03867 BK 4093 PG 148



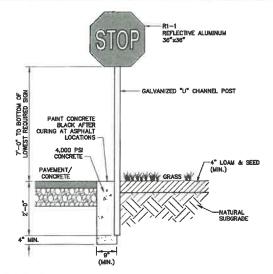

STOP SIGN (R1-1)

NOT TO SCALE

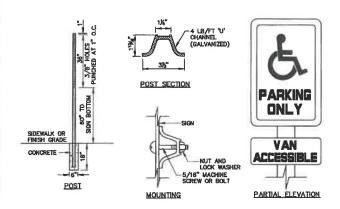

HANDICAP SIGN DETAILS

NOT TO SCALE

NOT TO SCALE

Design: JAC | Draft: LAZ


Checked: JAC Scale: AS NOTED Project No.:21090
Drawing Name: 21090-PLAN.dwg

PERMISSION FROM JONES & BEACH ENGINEERS, INC. (JBE).

ANY ALTERATIONS, AUTHORIZED OR OTHERWISE, SHALL BE

AT THE USER'S SOLE RISK AND WITHOUT LIABILITY TO JBE.

THIS PLAN SHALL NOT BE MODIFIED WITHOUT WRITTEN

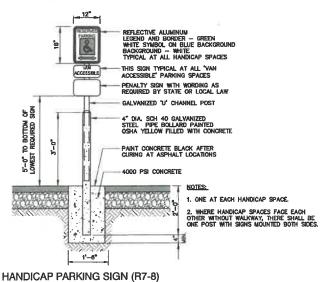

Date: 04/29/21

INJULES.

1. THE MACHIUM ALLOWARLE CROSS SLOPE OF ACCESSBILE ROUTE (SDEMALK) AND CURB SHALL BE 1.5%.

2. THE MACHIUM ALLOWARLE SLOPE OF ACCESSBILE ROUTE EXCLUDING CURB RAMPS SHALL BE 5%.

3. THE MACHIUM ALLOWARLE SLOPE OF ACCESSBILE ROUTE (SOCIONALY) CURB RAMPS SHALL BE 8%.

4. A MEMBAUM OF 4 PEST CLEAR SHALL BE MANTAMED AT ANY PERMANENT OBSTACLE IN ACCESSBILE ROUTE (Le., HOPRANIES, TUTLY POLES, THEE WELLS, SONS, ETC.).


5. CURB TREATMENT VARIES, SEE PLANS FOR CURB TYPE

8. BASE OF RAMP SHALL BE GRAZED TO PREVENT PORDING.


7. SEE TYPICAL SECTION FOR RAMP CONSTRUCTION.


ACCESSIBLE CURB RAMP (TYPE 'B')

NOT TO SCALE

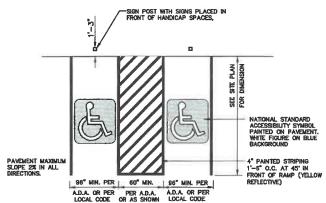

HANDICAP PARKING LAYOUT

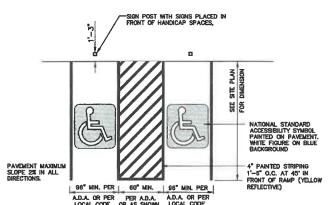

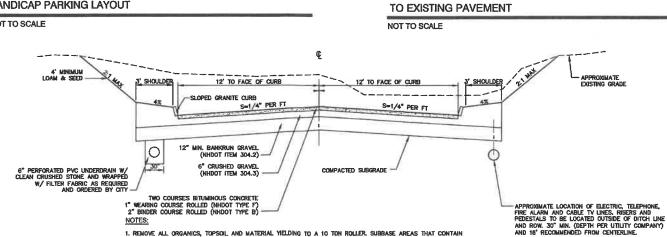

REMOVE ALL ORGANICS, TOPSOIL AND MATERIAL MELDING TO A 10 TON ROLLER. SUBBASE AREAS THAT CONTAIN UNSUTABLE MATERIALS MUST BE EXCAVATED TO A DEPTH NO LESS THAN 38° BELOW FINISH GRADE AND BE REPLACED WITH GRAVEL COMPACTED TO 95%.

- 3. CITY MAY REQUIRE UNDERDRAIN, ADDITIONAL GRAVEL AND/OR ADDITIONAL DRAINAGE IF SOIL CONDITIONS WARRANT
- 4. WOVEN GEOTEXTILE FABRIC SHALL BE PLACED ABOVE SUBGRADE AT ALL WETLAND CROSSINGS.

TYPICAL ROADWAY SECTION W/CURBING

NOT TO SCALE

LAZ 3 3/11/22 REVISED PER CITY COMMENTS 2 2/14/22 REVISED PER CITY ENGINEERING COMMENTS LAZ 1 1/18/22 LAZ REVISED PER CITY COMMENTS 11/23/21 LAZ ISSUED FOR REVIEW BY BEV. DATE REVISION

Designed and Produced in NH Jones & Beach Engineers, Inc. 85 Portsmouth Ave. Civil Engineering Services PO Box 219 FAX: 603-772-0227 E-MAIL: JBE@JONESANDBEACH.COM

FULL LENGTH OF PUBLIC USE AREA OF PLATFORD

00000000

00000000 000000000

00000000

DETECTABLE WARNINGS SHALL CONSIST OF A SURFACE OF TRUNCATED DOMES AND SHALL COMPLY WITH THE FOLLOWING:

A. TRUNCATED DOMES SHALL HAVE A BASE DIAMETER OF 0.9" (MIN.) AND 1.4" (MAC.), A TOP DIAMETER OF 50% OF THE BASE DIAMETER MINIMUM TO 65% OF THE BASE DIAMETER MINIMUM TO 65% OF THE BASE DIAMETER MARSHAIN, AND A HEIGHT OF 0.2" SPACING OF 1.6" MINIMUM AND 2.4" MASKILL HAVE A CHIEN-TO-BASE SPACING OF 1.6" MINIMUM AND 2.4" MASKILL, AND A BASE-TO-BASE SPACING OF 6.5" MINIMUM AND 1.4" MASKILL, AND A BASE-TO-BASE SPACING OF 0.6" MINIMUM AND 1.4" MASKILL, AND A DASK-TO-BASE SPACING OF 0.6" MINIMUM AND 1.4" MASKILL, AND A DASK-TO-BASE SPACING OF 0.6" MINIMUM AND 1.4" MASKILL, AND A DASK-TO-BASE SPACING OF 0.6" MINIMUM AND 1.4" MASKILL HAVEN OF 0.5" MINIMUM FOR THE ORDER OF THE ORDER O

TRUNCATED DOMES TO BE PLACED IN SIDEWALK BASE IN PUBLIC TRAFFIC AREAS. ACCESSIBLE CURB RAMP TRUNCATED DOMES

95% COMPACTED SUBGRADE OR ROCK FILL

1'-0"

KEYWAY

KEYWAY DETAIL FOR CONNECTION

TYPICAL BITUMINOUS PAVEMENT

NOT TO SCALE

BILLIN M. COURSE

BASE COURSE-


-6" NHDOT ITEM 304.3 CRUSHED GRAVEL 95% MIN. COMPACTION INCLUDING RECLAIMED MATERIAL

12" - NHDOT ITEM 304.2 BANK

##6" CRUSHED GRAVEL

12" MIN. GRAVEL


|೦೦೦೦೦೦೦೦| ಀೣ 000000000

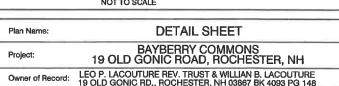

WIDTH VARIES SEE SITE PLANS 1.5" BASE COURSE 1/4" PER ET. FINISH SURFACE 3" CRUSHED GRAVEL -6" BANK RUN GRAVEL MIN. COMPACTED SUBGRADE OR ROCK FILL

BIT. SIDEWALK W/ VERTICAL GRANITE CURB


NOT TO SCALE

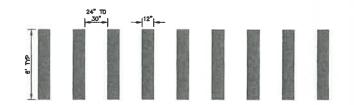

- TRANSVERSE CROSSWALK LINES SHALL BE THERMOPLASTIC, NOT LESS THAN 6" WIDE AND NOT LESS THAN 6" APART.
- SPACING FOR THE CONTINENTAL CLOCK MARKINGS SHALL BE UNIFOR FOR EACH INDIVIDUAL CROSSWALK BUT CAN BE MODIFIED FOR CHE CROSSWALK TO THE NEXT TO ELIMINATE A CROSSWALK MARKING DIRECTLY IN THE WHEELPATH.

NHDOT CONTINENTAL BLOCK MARKING DETAIL


NOT TO SCALE

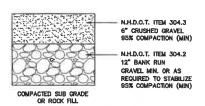

NOTE: IN AREAS OF ROCK EXCAVATION, MINIMUM 9" BANK RUN GRAVEL SHALL BE PLACED

GRAVEL SECTION

NOT TO SCALE

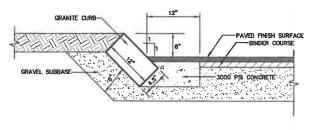


1. CURB TO BE PLACED PRIOR TO PLACING TOP SURFACE COURSE

SLOPED GRANITE CURB

NOT TO SCALE

DRAWING NO SHEET 41 OF 48

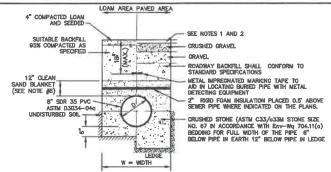


NOTES: 1. PAVEMENT REPAIR IN EXISTING ROADWAYS SHALL CONFORM TO PAVEMENT DETAILS.

- 2. NEW ROADWAY CONSTRUCTION SHALL CONFORM TO SUBDIVISION SPECIFICATIONS.
- TRENCH BACKFILL SHALL CONFORM WITH ENV. Wq 704.11(h) AND BE FREE OF DEBRIS, PAVEMENT, ORGANIC MATTER, TOP SOIL, WET OR SOFT MUCK, PEAT OR CLAY, EXCAVATED LEDGE OR ROCKS OVER SIX BICHES.
- 4. W= MAXIMUM ALLOWABLE TRENCH WIDTH TO A PLANE 12" INCHES ABOVE THE PIPE. FOR PIPES 15 INCHES NOMINAL DIAMETER OR LESS, WIDTH SHALL BE NO MORE THAN 36"; FOR PIPES GREATER THAN 15 INCHES NOMINAL DIAMETER, WIDTH SHALL BE 24 INCHES PLUS PIPE O.D. WIDTH SHALL ALSO BE THE PAYMENT WIDTH FOR LEDGE EXCAVATION AND FOR ORDERED EXCAVATION BELOW GRADE.
- RIGID FOAM INSULATION TO BE PROVIDED WHERE COVER IN THE ROADWAY IS LESS THAN 6' AND CROSS COUNTRY IS LESS THAN 4', PURSUANT TO DES WAIVER BEING ISSUED.
- PIPE SAND BLANKET MATERIAL SHALL BE GRADED SAND, FREE FROM ORGANIC MATERIALS, GRADED SUCH THAT 100% PASSES A 1/2 " SIEVE AND A MAXIMUM OF 15% PASSES A 4/200 SIEVE IN ACCORDANCE WITH Env—Wq 704.11(b).
- JOINT SEALS FOR PVC PIPE SHALL BE OIL RESISTANT COMPRESSION RINGS OF ELASTOMERIC MATERIAL AND CERTIFIED BY THE MANUFACTURER AS CONFORMING TO THE ASTM DAZIZE STANDARD IN EFFECT WHICH THE JOINT SEALS WERE MANUFACTURED, AND SHALL BE PUSH-ON, BELL-AND-SPROOT TYPE PER En:—WAY 704.05 (9).

SEWER TRENCH

NOT TO SCALE

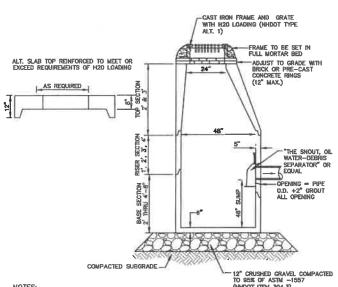


NOTES:

1. BASE SECTION SHALL BE MONOLITHIC WITH 48" INSIDE DIAMETER.

- 2. ALL SECTIONS SHALL BE DESIGNED FOR H20 LOADING.
- 3. CONCRETE SHALL BE COMPRESSIVE STRENGTH 4000 PSI, TYPE II CEMENT.
- FRAMES AND GRATES SHALL BE HEAVY DUTY AND DESIGNED FOR H20 LOADING
- PROVIDE "V" KNOCKOUTS FOR PIPES WITH 2" MAX. CLEARANCE TO OUTSIDE OF PIPE. MORTAR ALL PIPE CONNECTIONS SO AS TO BE WATERTIGHT.
- 6. JOINT SEALANT BETWEEN PRECAST SECTIONS SHALL BE BUTYL RUBBER.
- ALL CATCH BASIN FRAMES AND GRATES SHALL BE NHOOT CATCH BASIN TYPE ALTERNATE 1 OR NEENAH R-3570 OR APPROVED EQUAL (24"x24" TYPICAL).
- STANDARD CATCH BASIN FRAME AND GRATE(S) SHALL BE SET IN FULL MORTAR BED. ADJUST TO GR WITH CLAY BRICK AND MORTAR (2 BRICK COURSES TYPICALLY, 5 BRICK COURSES MAXIMUM, BUT NO MORE THAN 12"). OR PRECAST CONCRETE DONUTS:
- 9. ALL CATCH BASINS ARE TO BE FITTED WITH GREASE HOODS.


CATCH BASIN WITH GREASE HOOD

NOT TO SCALE

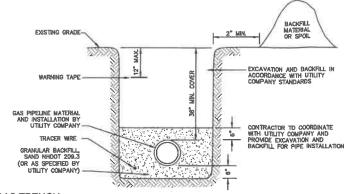


GAS TRENCH

NOT TO SCALE

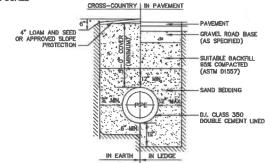

WATER SYSTEM TRENCH

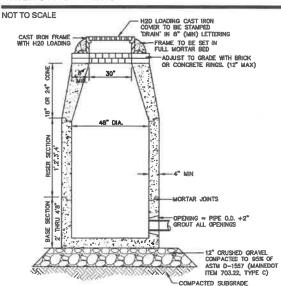

NOTES:

- 1. BASE SECTION SHALL BE MONOLITHIC WITH 48" INSIDE DIAMETER
- 2. ALL SECTIONS SHALL BE DESIGNED FOR H20 LOADING.
- 3. CONCRETE SHALL BE COMPRESSIVE STRENGTH 4000 PSI, TYPE II CEMENT.
- 4. Frames and grates shall be heavy duty and designed for H20 Loading.
- PROWDE "V" KNOCKOUTS FOR PIPES WITH 2" MAX. CLEARANCE TO OUTSIDE OF PIPE. MORTAR ALL PIPE CONNECTIONS SO AS TO BE WATERTIGHT.
- 7. ALL DRAIN MANHOLE FRAMES AND GRATES SHALL BE NEENAM R-1798 OR APPROVED EQUAL (30" DIA.
- STANDARD FRAME(S) AND GRATE(S) SHALL BE SET IN FULL MORTAR BED. ADJUST TO GRADE WITH CLAY BRICK AND MORTAR (2 BRICK COURSES TYPICALLY, 5 BRICK COURSES MAXIMUM, BUT NO MORE THAN 12"), OR PRECAST CONCRETE 'DONUTS'.

LAZ

LAZ

LAZ


LAZ

BY

PO Box 219

DRAIN MANHOLE (4' DIAM.)

NOT TO SCALE

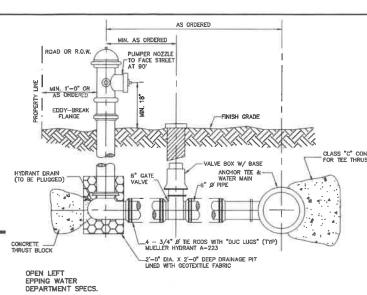


- NOTES.

 1. ALL PIPE FITTINGS TO BE D.I. PRESSURE CLASS 350, THICKNESS CLASS 52.


 2. HYDRANT TO BE PAINTED RED WITH WHITE "REFLECTOR" PAINT ON BONNET.

 3. MECHANICAL JOINTS SHALL HAVE MEGALUG RETAINING GLANDS AS MADE BY EBBA OR APPROVED EQUAL.

HYDRANT INSTALLATION

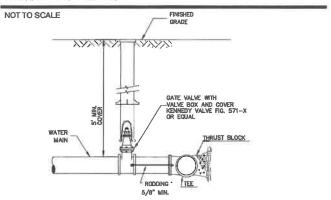

BURIED GATE VALVE DETAIL

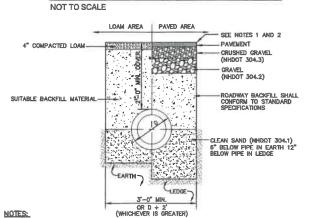


1. PAVEMENT REPAIR IN EXISTING ROADWAYS SHALL CONFORM TO STREET OPENING REGULATIONS

E-MAIL: JBE@JONESANDBEACH.COM

- 2. NEW ROADWAY CONSTRUCTION SHALL CONFORM WITH PROJECT AND CITY SPECIFICATIONS.
- 3. ALL MATERIALS ARE TO BE COMPACTED TO 95% OF ASTM D-1557.

DRAINAGE TRENCH


NOT TO SCALE

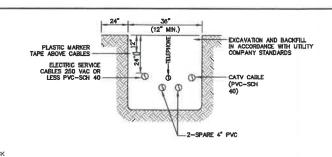

NOTE: ALL UTILITIES SHALL BE REVIEWED AND APPROVED BY APPROPRIATE UTILITY COMPANY,

UTILITY TRENCH

NOT TO SCALE

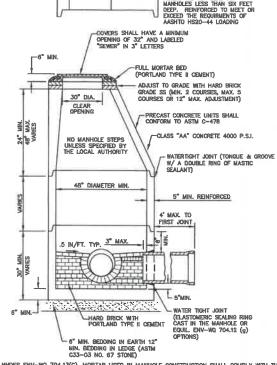

- 1. PER NHOES ENV-WQ 704-13(C), MORTAR USED IN MANHOLE CONSTRUCTION SHALL COMPLY WITH THE FOLLOWING:

 a. MORTAR SHALL BE COMPOSED OF TYPE II PORTLAND CENENT AND SAND WITH OR WITHOUT HYDRATED LINE ADDITION

 b. PROPORTIONS IN MORTAR OF PARTS BY VOLUMES SHALL BE PER TABLE 704-4:

 (1) 4.5 PARTS SAND AND 1.5 PARTS CEMENT; OR

 (2) 4.5 PARTS SAND AND 1.5 PARTS CEMENT; OR PART HYDRATED LIME;

 c. CEMENT SHALL BE TYPE II PORTLAND CEMENT THAT IS CERTIFIED BY ITS MANUFACTURER AS CONFORMING TO THE ASTM CISO/CISOM STANDARD IN EFFECT AT THE TIME THE CEMENT WAS MANUFACTURED.
- CONFORMING TO THE ASTM CISO/CISOM STANDARD IN EFFECT AT THE TIME THE CEMENT WAS MANUFACTURED

 d. HYDRATED LIME SHALL BE TYPE S THAT IS CERTIFIED BY ITS MANUFACTURER AS CONFORMING TO THE ASTM COOP STANDARD IN EFFECT AT THE TIME THE HYDRATED LIME WAS PROCESSED 6. SAND SHALL CONSIST OF INERT NATURAL SAND THAT IS CERTIFIED BY ITS SUPPLIER AS CONFORMING TO THE ASTM CSS STANDARD IN EFFECT AT THE TIME THE SAND IS PROCESSED BY STANDARD SPECIFICATIONS FOR CONCRETE, FINE AGGREGATES

 CONCRETE FOR DROP SUPPORTS SHALL CONFORM TO THE REQUIREMENT FOR CLASS ANA CONCRETE OF THE NEW HAMPSHIRE DEPARTMENT OF TRANSPORTATIONS STANDARD SPECIFICATIONS FOR ROAD AND BRIDGE CONSTRUCTION AS AVAILABLE AT:

HTTP://WWW.NH.GOV/DOT/ORG/PROJECTDEVELOPMENT/HIGHWAYDESIGN/SPECIFICATIONS/INDEX.HTM

- SHELVES SHALL BE CONSTRUCTED TO THE ELEVATION OF THE HIGHEST PIPE CROWN AND SLOPED TO DRAIN TOWARD THE FLOWING THROUGH CHANNEL IN ACCORDANCE WITH ENV-WQ 704.12 (K).
- ALL MANHOLES SHALL BE TESTED FOR LEAKAGE IN ACCORDANCE WITH ENV-WQ 704.17 (a) THROUGH
- SEWER MANHOLE COVERS SHALL CONFORM TO ASTM A48/48M WITH A CASTING EQUAL TO CLASS 30 IN ACCORDANCE WITH ENV-WQ 704.13 (a) (B).
- ALL PRECAST SECTIONS SHALL BE COATED ON THE EXTERIOR WITH A BITUMINOUS DAMP-PROOFING COATING IN ACCORDANCE WITH ENV-WQ 704.12 (J).
- ALL PRECAST SECTIONS AND BASES SHALL HAVE THE DATE OF MANUFACTURE AND THE NAME OR TRADEMARK OF THE MANUFACTURER IMPRESSED OR INDELIBLY MARKED ON THE INSIDE WALL PER ETV-MO 704-12(f).
- 7. BRICK MASONRY SHALL CONFORM TO ASTM C32 (ENV-WQ 704.12(a)(9))

SEWER MANHOLE

DETAIL SHEET

NOT TO SCALE


Plan Name:

Design: JAC Draft: LAZ Date: 04/29/21
Checked: JAC Scale: AS NOTED Project No.: 21090 3 3/11/22 REVISED PER CITY COMMENTS rawing Name: 21090-PLAN.dwg 2 2/14/22 REVISED PER CITY ENGINEERING COMMENTS HIS PLAN SHALL NOT BE MODIFIED WITHOUT WRITTEN 1 1/18/22 ERMISSION FROM JONES & BEACH ENGINEERS, INC. (JBE). REVISED PER CITY COMMENTS ANY ALTERATIONS, AUTHORIZED OR OTHERWISE, SHALL BE 0 11/23/21 ISSUED FOR REVIEW AT THE USER'S SOLE RISK AND WITHOUT LIABILITY TO JBE. REV. DATE REVISION

Designed and Produced in NH Jones & Beach Engineers, Inc. 85 Portsmouth Ave. Civil Engineering Services FAX: 603-772-0227


BAYBERRY COMMONS 19 OLD GONIC ROAD, ROCHESTER, NH Project: LEO P. LACOUTURE REV. TRUST & WILLIAN B. LACOUTURE Owner of Record:

DRAWING No. JBE PROJECT NO. 21090

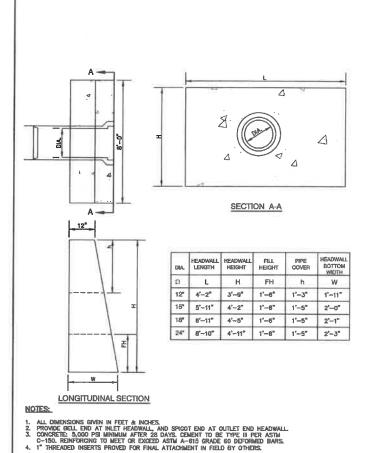


PRECAST CONCRETE HEADWALL

NOT TO SCALE

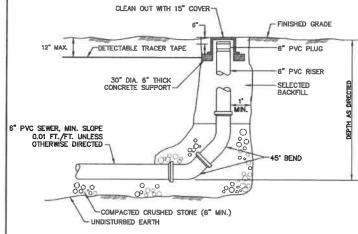

SEWER CLEAN OUT

NOT TO SCALE

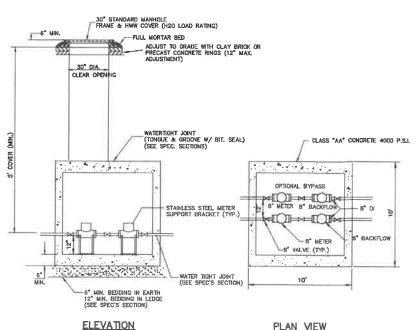

PLAN VIEW

NOTES

1. METER TO BE SENSUS OWNI C2 OF APPROPRIATE SIZE.

2. BACKFLOW TO BE TESTABLE DOUBLE CHECK VALVE ASSEMBLY WITH CENTER-SHAFT OR TOP HINGE CHECKS (MUSINIS JSOAST OR EGUAL) OF APPROPRIATE SIZE, IF APPLICATION IS DESIGNED LOW HAZARD.

3. OPTIONAL BYPASS MY BE SIZED FOR DOMESTIC SERVICE ONLY.

4. VAULT TO HAVE ADEQUATE ANTI-BOUYANCY FEATURES.

5. VAULT COMPRS TO BE STAMPED WITH "WATER" AND MATCH EGISTING CITY OF ROCHESTER INFRASTRUCTURE STANDARDS.


6. ISCALTION VALVES REQUIRED AROUND EQUIPMENT FOR MAINTENCE, TESTING AND SERVICE.

7. IF APPLICATION IS DESIGNATED HIGH HAZARD, THE ASSEMBLY MUST USE APP SEACHLOW DEWICS AND BE LOCATED IN AN ABOVE GRADE, HEATED AND INSULATED ENCLOSURE TO DEWICS AND SELOCATED IN AN ABOVE GRADE, HEATED AND INSULATED ENCLOSURE TO AND COMPLETE REPLACEMENT OF BEWICES.

BYPASS USAGE: 9. F OPTIONAL BYPASS LINE IS INSTALLED, WHEN MAIN FEED IS TAKEN OFLINE AND BYPASS BNGAGED, OWNER SHALL CALL 330-7128 TO COORDINATE LOW FLOW CONDITION WITH ROCHESTER FIRE DEPARTMENT AND ROCHESTER PUBLIC WORKS

WATER METER PIT ROCHESTER

NOT TO SCALE

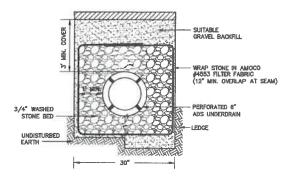


NOTES:

- 1. PAVEMENT REPAIR IN EXISTING ROADWAYS SHALL CONFORM TO STREET OPENING REGULATIONS.
- 2. NEW ROADWAY CONSTRUCTION SHALL CONFORM TO PROJECT AND CITY SPECIFICATIONS.

ROADWAY UNDERDRAIN TRENCH


NOT TO SCALE

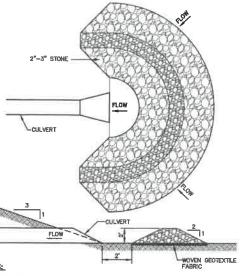

- TEMPORARY CULVERT INLET PROTECTION CHECK DAMS SHALL BE CONSTRUCTED OF 2-3" STONE OVER WOVEN GEOTEXTILE FABRIC.
- PROPOSED CULVERTS LOCATED BELOW (DOWNSTREAM) FROM AND WITHIN 100' OF THE PROJECT SITE.
- SEDIMENT SHALL BE REMOVED FROM BEHIND THE STRUCTURE WHEN IT HAS ACCUMULATED TO ONE HALF THE ORIGINAL HEIGHT OF THE STRUCTURE.
- STRUCTURES SHALL BE REMOVED WHEN THE SITE IS STABILIZED WITH VEGETATION AND THE CHANNEL SHALL BE SMOOTHED AND REVEGETATED.


TEMPORARY CULVERT INLET PROTECTION CHECK DAM

NOT TO SCALE

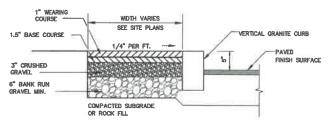

BIT. SIDEWALK W/ VERTICAL GRANITE CURB

NOT TO SCALE

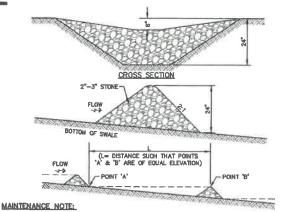

1. STONE CHECK DAMS SHOULD BE CHECKED AFTER EACH RAINFALL AND AT LEAST DAILY DURING PROLONGED RAINFALL. ANY NECESSARY REPAIRS SHOULD BE MADE IMMEDIATELY. PARTICULAR ATTENTION SHOULD BE GIVEN TO BID RUM AND REGISION AT THE DOWNSTREAM TOE OF THE STRUCTURES WHEN THE STRUCTURES ARE REMOVED, THE DISTURBED PORTION SHOULD BE BROUGHT TO THE ESISTING CHANNEL. GRADE AND THE AREAS PREPARED, SEEDED AND MULCHED. WHILE THIS PRACTOC'S NOT INTENDED TO BE USED PRIMABILLY POR SEDIMENT TRAPPING, SOME SEDIMENT WILL ACCUMULATE BEHIND THE STRUCTURES. SEDIMENT SHALL BE REMOVED FROM BEHIND THE STRUCTURES WHEN IT HAS ACCUMULATED TO ONE HALF OF THE ORIGINAL HEIGHT OF THE STRUCTURE.

E-MAIL: JBE@JONESANDBEACH.COM

STONE CHECK DAM


NOT TO SCALE

WIRE SCREEN SHALL BE PLACED BETWEEN STONE AND BLOCKS TO PREVENT THE AGGREGATE FROM BEING WASHED INTO THE STRUCTURE CONCRETE BLOCKS -FILTERED WATER DROP INLET WITH GRATE MAINTENANCE NOTE:

1. ALL STRUCTURES SHOULD BE INSPECTED AFTER EVERY RAINFALL AND REPAIRS MADE AS NECESSARY, SEDIMENT SHOULD BE REMOVED FROM TRAPPING DENCES AFTER THE SEDIMENT HAS REACHED A MAXOMIN OF ONE HALF THE DEPTH OF THE TRAP. THE SEDIMENT SHOULD BE DISPOSED IN A SUITABLE UPLAND AREA AND PROTECTED FROM EROSION BY EITHER STRUCTURE OR VEGETATIVE MEANS. THE TEMPORARY TRAPS SHOULD BE REMOVED AND THE AREA REPAIRED AS SOON AS THE CONTRIBUTING DRAINAGE AREA TO THE INLET HAS BEEN COMPLETELY STRUILIZED.

TEMPORARY CATCH BASIN INLET PROTECTION (Block and Gravel Drop Inlet Sediment Filter)

NOT TO SCALE

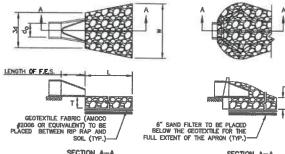

SECTION A-A PIPE OUTLET TO FLAT AREA WITH NO DEFINED CHANNEL SECTION A-A PIPE OUTLET TO WELL-DEFINED

TABLE 7-24-RECOMMEND	ED RIP RAP GRADATION RANGES
THICKNESS OF RIP RAP =	1.5 FEET
d50 SIZE= 0.50	FEET 6 INCHES
% OF WEIGHT SMALLER THAN THE GIVEN d50 SIZE	SIZE OF STONE (INCHES) FROM TO
100%	9 12
85%	8 11
50%	6 9
15%	2 3

- THE SUBGRADE FOR THE GEOTEXTILE FABRIC AND RIP RAP SHALL BE PREPARED TO THE LINES AND GRADES SHOWN ON THE PLANS.
- 2. THE RIP RAP SHALL CONFORM TO THE SPECIFIED GRADATION.
- 3. GEOTEXTILE FABRICS SHALL BE PROTECTED FROM PUNCTURE OR TEARING DURING THE PLACEMENT OF THE ROCK RIP. DAMAGED AREAS IN THE FABRIC SHALL BE REPAIRED BY PLACING A PIECE OF FABRIC OVER THE DAMAGED AREA OR BY COMPLETE REPLACEMENT OF THE FABRIC, ALL OVERLAPS REQUIRED FOR REPAIRS OR JOINING TWO PIECES OF FABRIC SHALL BE A MINIMUM OF 12 INCHES.
- 4. STONE FOR THE RIP RAP MAY BE PLACED BY EQUIPMENT AND SHALL BE CONSTRUCTED TO THE FULL LAYER THICKNESS IN ONE OPERATION AND IN SUCH A MANNER AS TO PREVENT SEGREGATION OF THE STONE SIZES.
- OUTLETS TO A DEFINED CHANNEL SHALL HAVE 2:1 OR FLATTER SIDE SLOPES AND SHOULD BEGIN AT THE TOP OF THE CULVERT AND TAPER DOWN TO THE CHANNEL. BOTTOM THROUGH THE LENGTH OF THE APRON.
- 6. MAINTENANCE: THE OUTLET PROTECTION SHOULD BE CHECKED AT LEAST ANNUALLY AND AFTER EVERY MAJOR STORM. IF THE RIP RAP HAS BEEN DISPLACED, UNDERMINED OR DAMAGED, IT SHOULD BE REPAIRED MINEDIATELY. THE CHANNEL IMMEDIATELY BELOW THE OUTLET SHOULD BE CHECKED TO SEE THAT EROSION IS NOT OCCURRING. THE DOWNSTREAM CHANNEL SHOULD BE KEPT CLEAR OF OBSTRUCTIONS SUCH AS FALLEN TREES, DEBRIS, AND SEDIMENT THAT COULD CHANGE FLOW PATTERNS AND/OR TAILWARD REPS. DEBRIS, AND SEDIMENT THAT COULD CHANGE FLOW PATTERNS AND/OR TAILWARD REPS. REPAIRS MUST BE CARRIED OUT IMMEDIATELY TO AVOID ADDITIONAL DAMAGE TO OUTLIET FROTERION.

RIP RAP OUTLET PROTECTION APRON

NOT TO SCALE

REVISED PER CITY COMMENTS 1.AZ REVISED PER CITY ENGINEERING COMMENTS LAZ LAZ REVISED PER CITY COMMENTS LAZ ISSUED FOR REVIEW BY Stratham, NH 03885

Designed and Produced in NH Jones & Beach Engineers, Inc. 85 Portsmouth Ave. Civil Engineering Services
PO Box 219

-	Plan Name:	DETAIL SHEET
-	Project:	BAYBERRY COMMONS 19 OLD GONIC ROAD, ROCHESTER, NH
	Owner of Record:	LEO P. LACOUTURE REV. TRUST & WILLIAN B. LACOUTURE 19 OLD GONIC RD., ROCHESTER, NH 03867 BK 4093 PG 148

DRAWING No. SHEET 43 OF 46 JBE PROJECT NO. 21090

Design: JAC	Draft: LAZ	Date: 04/29/21
Checked: JAC	Scale: AS NOTED	Project No.: 21090
Drawing Name:	21090-PLAN.dwg	
THIS PLAN SHALL	NOT BE MODIFIED WITH M JONES & BEACH ENG	HOUT WRITTEN INEERS, INC. (JBE). IERWISE, SHALL BE




3 3/11/22

2 2/14/22

1 1/18/22

0 11/23/21

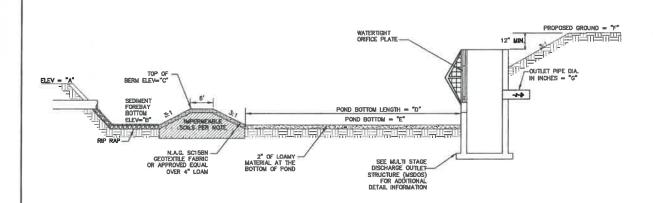

POND TABLE


POND	ELEVATIONS/DIMENSIONS						
	A	8	С	D	E	F	G
POND 1	220.00	216.00	218.00	169'	212.00	220.00	12"
POND 2	220.00	217.00	219.00	310"	212.00	220.00	12"
POND 3	225.00	220.00	222.00	200'	216.00	225.50	12"

WET POND SECTION (PONDS 1, 2 & 3)

NOT TO SCALE


WET POND CONSTRUCTION CRITERIA

- FOUNDATION PREPARATION THE FOUNDATION AREA SHALL BE CLEARED OF TREES LOSS, STUMPS, ROOTS, BRUSH, BOULDERS, SOD, AND RUBBISH, IP NEEDED TO ESTABLISH VEGETATION, THE TOPSOIL AND SOD SHALL BE. STOCKPILED AND SPREAD ON THE COMPLETED DAM AND SPILLWAYS, FOUNDATION SUFFACES SHALL BE SLOPED NO STEEPER THAN 1-1.1. THE FOUNDATION AREA SHALL BE THOROUGHLY SCARIFED BEFORE PLACEMENT OF THE MATERIAL THE SUFFACE SHALL HAVE NOTSTURE ADDED OR IT SHALL BE THOROUGHLY SCARIFED THE FIRST LAYER OF FILL MATERIAL CAN BE COMPACTED. AND BONDED TO THE FOUNDATIONS, THE CUTOFF TRENCH AND ANY OTHER REQUIRED EXCAVATIONS SHALL BE USED IN THE PERMANENT FILL. EUSTING STREAM CHANNELS IN THE FOUNDATION AREA SHALL BE SLOPED NO STEEPER THAN 1:1 AND DEEPENED AND MODIFIED AS INCESSARY TO REMOVE ALL STONES, GRALL, SAND, STUMPS, ROOTS, AND OTHER GRACETONABLE MATERIAL. AND TO ACCOMMODATE COMPACTION EQUIPMENT, FILL PLACEMENT THE MATERIAL, PLACED IN THE FILL SHALL BE FREE OF DETRIBUENTAL ANDOUNTS OF SOO, ROOTS, FROZEN SOOL, STONES MORE THAN 6 INCHES IN DIAMETER (EXCEPT FOR ROCK FILLS), AND OTHER OBJECTIONABLE MATERIAL.
- SELECTED BACK FILL MATERIA. SHALL BE PLACED AROUND STRUCTURES, PIPE CONDUITS AND ANTI SEEP COLLARS AT ABOUT THE SAME RATE ON ALL SIDES, TO PREVENT DAMAGE FROM UNCOUNT, LOADING, THE PLACING AND SPREADING OF FILL UNITED ALL SHALL BE STARTED AT THE LOWEST POINT OF THE POUNDATION AND THE FILL REPOLATED THE INDIRECT SHALL BE STARTED AT THE LOWEST POINT OF THE POUNDATION AND THE FILL SHALL BE CONSTRUCTED IN CONTINUOUS HORIZONTAL LAYERS EXCEPT WHERE OPENINGS OR SECTIONALIZED FILLS ARE REQUIRED. IN THOSE CASES, THE SLOPE OF THE BONDING SURPRACES BETWEEN THE EMBRANKENT IN PLACE AND THE EMBRANKENT TO BE PLACED SHALL NOT BE STEEPER THAN 3 HORIZONTAL TO 1 VERTICAL THE BONDING SURPRACES BHALL BE TREATED THE SAME AS THAT SPECIFIED FOR THE FOUNDATION. SO TO INSIDE A GOOD BOND WITH THE NEW FILL THE DISTRIBUTION AND GRADATION OF MATERIALS SHALL BE SUCH THAT NO LENSES, POCKETS, STREAKS, OR LAYERS OF MATERIAL DIFFER SUBSTANTIALLY IN TEXTURE OF GRADATION FROM THE SURROUNDING MATERIAL. IF IT IS INCESSARY TO USE MATERIALS OF VARYING TEXTURE AND SAADATION, THE MORE IMPERIOUS MATERIAL SHALL BE PLACED IN THE CONTERP AND SCIENCE AND OF THE PLACE SHALL BE TO THE SAME AS THAT CONFORM TO THE UNITED THE CONFORM TO THE CONFORM TO THE CONFORM PARTS OF THE FILL IF ZONED FILLS OF SUBSTANTIALLY DIFFERING MATERIALS ARE SPECIFIED. THE ZONED IN THE CONFORM TO THE UNITED AND CRANKES OF THE FILL IF ZONED FILLS OF SUBSTANTIALLY DIFFERING MATERIALS AND CONFORM TO THE LINES, GRADES, AND ELEVATIONS SHOWN ON THE DRAWINGS OF AS STAKED IN THE PREADUR.
- COMPACTION —— CONSTRUCTION EQUIPMENT SHALL BE OPERATED OVER THE AREAS OR EACH LAYER OF FILL TO INSURE THAT THE REQUIRED COMPACTION IS OBTAINED. SPECIAL EQUIPMENT SHALL BE USED IF NEEDED TO OBTAIN THE REQUIRED COMPACTION. IF A MINIMUM REQUIRED ENSITY SET SPECIFIED, EACH LAYER OF FILL SHALL BE COMPACTED AS INCESSEARY TO OBTAIN THAT OBSITY. FILL ADJACENT TO STRUCTURES, PIPE CONDUITS, AND ANTI SEEP COLLARS SHALL BE COMPACTED TO A DENSITY EQUIVALENT TO THAT OF THE SURRQUINDING FILL BY MEANS OF HAND TAMPHIG OR MANUALLY DIRECTED POWER TAMPER OR PLATE VIBRATORS. FILL ADJACENT TO CONCRETE STRUCTURES SHALL NOT BE COMPACTED UNTIL THE CONCRETE STRUCTURES SHALL NOT BE
- PROTECTION --- A PROTECTIVE COVER OF VEGETATION SHALL BE ESTABLISHED ON ALL EXPOSED SURFACES OF THE EMBANKMENT, SPILLWAY, AND BORROW AREA IF SOIL AND CLIMATIC CONDITIONS PERMIT. IF SOIL OR CLIMATIC CONDITIONS PRECLULER THE USE OF VEGETATION AND PROTECTION IS NEEDED, NON-VEGETATIVE MEANS SUCH AS MULCHES OR GRAVEL MAY BE USED. IN SOME PLACES, TEMPORARY VEGETATION MAY BE USED UNTIL CONDITIONS PERMIT ESTABLISHMENT OF PERMANENT VEGETATION. THE EMBANKMENT AND SPILLWAY SHALL BE FENCED IF NECESSARY OF PROTECT THE VEGETATION.
- 6. SEEDBED PREPARATION, SEEDING, FERTILIZING, AND MULCHING SHALL COMPLY WITH THE APPROPRIATE VEGETATIVE BMP'S.
- CONCRETE --- THE MIX DESIGN AND TESTING OF CONCRETE SHALL BE CONSISTENT WITH THE STRENGTH REQUIREMENTS OF THE JOB. MIX REQUIREMENTS OR INCRESSARY STRENGTH SHALL BE SPECIFIED. THE TYPE OF CEMENT, AIR ENTRAPMENT, SUMP, AGGREGATE, OR OTHER PROPERTIES SHALL BE SPECIFIED IN RECESSARY ALL OCNCRETE IS TO CONSIST OF A WORKABLE MIX THAT CAN BE PLACED AND FINISHED IN AN ACCEPTABLE MANNER, INCESSARY CURING SHALL BE SPECIFIED, REINFORCING STEEL SHALL BE PLACED AS INDICATED ON THE PLANS AND SHALL BE HELD SECURELY IN PLACE DURING CONCRETE PLACEBERT, SUB GRADES AND FORMS SHALL BE INSTALLED TO LINE AND GRADE, AND THE FORMS SHALL BE MORTAR TIGHT AND UNYTELDING AS THE CONCRETE IS PLACED.
- THE CONTRACTOR WILL NOTIFY JONES AND BEACH ENGINEERS AFTER EACH OF THE GRAVEL WETLAND PONDS HAVE BEEN EXCAVATED TO THE BOTTOM OF THE SYSTEM FOR A MANDATORY INSPECTION PRIOR TO BUILDING BERMS, PLACING STONE OR INSTALLING PIPE SYSTEM.
- 9. BERMS AND WERS SEPARATING THE FOREBAY AND TREATMENT CELLS SHOULD BE CONSTRUCTED WITH CLAY, OR MON-CONDUCTIVE SOILS, AND/OR A FINE GEOTEXTILE, OR SOME COMBINATION THEREOF, TO AVOID WATER SEEPAGE AND SOIL PIPING THROUGH THESE EARTHEN DIVIDERS.

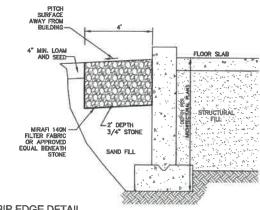

DRIP EDGE DETAIL


NOT TO SCALE

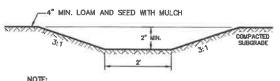

ALL VEGETATED SWALES ARE TO BE STABILIZED WITH NORTH AMERICAN GREEN EROSION CONTROL BLANKET SECURED WITH BIODEGRADABLE 'BIO' OR 'ECO-STAKES'.

VEGETATED SWALE

NOT TO SCALE

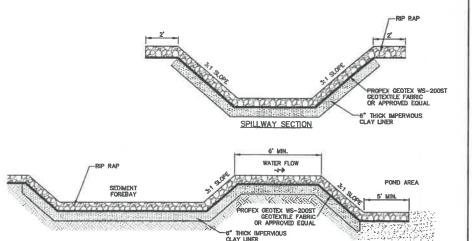

NOTES:

A 6" THICK INPERVIOUS CLAY LINER IS TO BE PLACED UNDER ENTIRE SEDIMENT FOREBAY AND SPILLWAY AND ONLY
AROUND THE SIDES OF THE ENTIRE BIORETENTION AREA.

SPILLWAY PROFILE

- SEDIMENT SHALL BE REMOVED FROM BEHIND THE STRUCTURE WHEN IT HAS ACCUMULATED TO ONE HALF THE ORIGINAL HEIGHT OF THE STRUCTURE.
- 3. EMBANKMENT MATERIAL SHALL BE CLEAN MINERAL SOIL FREE OF ROOTS, ORGANIC MATTER, AND OTHER DELETERIOUS SUBSTANCES. IT SHALL CONTAIN NO ROCKS OR LUMPS OVER FOUR RICHES (**) IN DIAMETER. THIS MATERIAL SHALL BE INSTALLED IN 6" LIFTS COMPACTED TO 925 OF ASTM D-1557, AND SHALL MEET THE FOLLOWING SPECIFICATIONS: 6" PASSING 100%, #4 SIEVE 40-90%, #40 SIEVE 50-80%, #100 SIEVE 25-40%, #200
- 4. 6" THICK IMPERVIOUS CLAY LINER MATERIAL SHALL BE CLEAN SILTY-CLAY BORROW FREE OF ROOTS, ORGANIC MATTER, AND OTHER DELETERIOUS SUBSTANCES, AND SHALL CONTAIN NO ROCKS OR LIMPS OVER THREE INCHES (3") IN DIAMETER. THIS MATERIAL SHALL BE IN STALLED IN 8" LIFTS COMPACTED TO 92% OF TAID 1-1557, AND SHALL MEET THE FOLLOWING SPECIFICATIONS: 6" PASSING 100%, \$4 SIEVE 95-100%, \$40 SIEVE 60-90%, \$100 SIEVE 40-60%, \$200 SIEVE 25-46% (0" THE FRACTION PASSING THE \$45 SIEVE). THE CLAY COMPONENT SHALL HAVE A PLASTICITY INDEX OF AT LEAST 8 AND A HYDRAULIC CONDUCTIVITY OF 10 TO THE -6 CM/SEC.
- COMPACTION AND MATERIALS TESTING SERVICES SHALL BE PERFORMED BY AN INDEPENDENT GEOTECHNICAL ENGINEER RETAINED BY THE OWNER.


SEDIMENT FOREBAY SPILLWAY

NOT TO SCALE

Plan Name **DETAIL SHEET** BAYBERRY COMMONS 19 OLD GONIC ROAD, ROCHESTER, NH Project: LEO P. LACOUTURE REV. TRUST & WILLIAN B. LACOUTURE 19 OLD GONIC RD., ROCHESTER, NH 03867 BK 4093 PG 148 Owner of Record:

D4 SHEET 44 OF 46

DRAWING No.

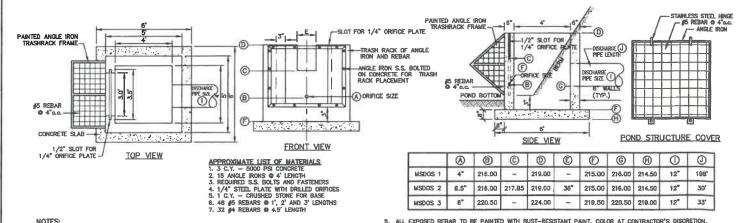

- NOTES:

 . REINFORCING STEEL SHALL CONSIST OF A SINGLE LAYER OF HORIZONTAL AND VERTICAL PLACED #4 REBAR ®
- 12 O.C.

 2 CONCRETE BOX TO BE CONSTRUCTED OR PRECAST OF EQUIAL DIMENSIONS AND REINFORCING.

 3 CONCRETE SLAB TO BE CONSTRUCTED ALONG WITH BASE. FOR PRECAST BOX, A SLOTTED CONCRETE SLAB TO BE USED.

 4. SECTION JOINTS AND PIPE OPENING SHALL BE SEALED WATERTIGHT WITH MORTAR BY CONTRACTOR.

MULTI-STAGE DISCHARGE OUTLET STRUCTURE (MSDOS)

NOT TO SCALE

Design: JAC	Draft: LAZ	Date: 04/29/21	UFW LLC
Checked: JAC	Scale: AS NOTED	Project No.: 21090	
Drawing Name:	21090-PLAN.dwg		MICHAEL.
THIS PLAN SHALL PERMISSION FRO	MERVAN No. 9946		
ANY ALTERATION AT THE USER'S SO	(CENSED		



3	3/11/22	REVISED PER CITY COMMENTS	LAZ
2	2/14/22	REVISED PER CITY ENGINEERING COMMENTS	LAZ
1	1/18/22	REVISED PER CITY COMMENTS	LAZ
0	11/23/21	ISSUED FOR REVIEW	LAZ
REV.	DATE	REVISION	BY

TO BE SUPPLIED BY CAPITAL CONCRETE PRODUCTS OF HENNIKER, N.H., (1-603-428-3218) OR EQUAL STRUCTURE TO HAVE TEMPORARY PLYWOOD INSTALLED IN THE ORIFICE PLATE SLOT UNTIL THE SITE IS

STABLIZED.

STRUCTURE IS TO BE DESIGNED FOR H20 LOADING.

SOIL UNDERLYING THE STRUCTURE IS TO BE COMPACTED TO 95% MODIFIED PROCTOR.


Designed and Produced in NH Jones & Beach Engineers, Inc. __/ D 603-772-4746 85 Portsmouth Ave. Civil Engineering Services

Stratham, NH 03885

Delottes	FAX: 603-772-0227	П	
E-MAIL: JBE@JOI	NESANDBEACH.COM		

BLASTING SPECIFICATIONS

- BEST MANAGEMENT PRACTICES FOR BLASTING, ALL ACTIVITIES RELATED TO BLASTING SHALL FOLLOW REST MANAGEMENT BEAL MONRON TRANSMICE PLANT PROCEDURES TO THE PROPERTY OF THE
- (1) LOADING PRACTICES. THE FOLLOWING BLASTHOLE LOADING PRACTICES TO MINIMIZE ENVIRONMENTAL EFFECTS SHALL BE FOLLOWED:
- (a) DRILLING LOGS SHALL BE MAINTAINED BY THE DRILLER AND COMMUNICATED DIRECTLY TO THE BLASTER. THE LOGS SHALL INDICATE DEPTHS AND LENGTHS OF VOIDS, CANTIES, AND FAULT ZONES OR OTHER WEAK ZONES ENCOUNTERED AS WELL AS GROUNDWATER CONDITIONS.
- (b) EXPLOSIVE PRODUCTS SHALL BE MANAGED ON-SITE SO THAT THEY ARE EITHER USED IN THE BOREHOLE, RETURNED TO THE DELIVERY VEHICLE, OR PLACED IN SECURE CONTAINERS FOR OFF-SITE DISPOSAL.
- (c) SPILLAGE AROUND THE BOREHOLE SHALL EITHER BE PLACED IN THE BOREHOLE OR CLEANED UP AND RETURNED TO AN APPROPRIATE VEHICLE FOR HANDLING OR PLACEMENT IN SECURED CONTAINERS FOR OFF-SITE DISPOSAL.
- (d) LOADED EXPLOSIVES SHALL BE DETONATED AS SOON AS POSSIBLE AND SHALL NOT BE LEFT IN THE BLASTHOLES OVERNIGHT, UNLESS WEATHER OR OTHER SAFETY CONCERNS REASONABLY DICTATE THAT DETONATION SHOULD BE
- (e) LOADING EQUIPMENT SHALL BE CLEANED IN AN AREA WHERE WASTEWATER CAN BE PROPERLY CONTAINED AND HANDLED IN A MANNER THAT PREVENTS RELEASE OF CONTAMINANTS TO THE ENVIRONMENT.
- (f) EXPLOSIVES SHALL BE LOADED TO MAINTAIN GOOD CONTINUITY IN THE COLUMN LOAD TO PROMOTE COMPLETE DETONATION. INDUSTRY ACCEPTED LOADING PRACTICES FOR PRIMING, STEMMING, DECKING AND COLUMN RISE NEED TO
- (2) EXPLOSIVE SELECTION. THE FOLLOWING BMPS SHALL BE FOLLOWED TO REDUCE THE POTENTIAL FOR GROUNDWATER CONTAMINATION WHEN EXPLOSIVES ARE USED:
- (a) EXPLOSIVE PRODUCTS SHALL BE SELECTED THAT ARE APPROPRIATE FOR SITE CONDITIONS AND SAFE BLAST EXECUTION.
- (b) EXPLOSIVE PRODUCTS SHALL BE SELECTED THAT HAVE THE APPROPRIATE WATER RESISTANCE FOR THE SITE CONDITIONS PRESENT TO MINIMIZE THE POTENTIAL FOR HAZARDOUS EFFECT OF THE PRODUCT UPON GROUNDWATER.
- (3) PREVENTION OF MISFIRES, APPROPRIATE PRACTICES SHALL BE DEVELOPED AND IMPLEMENTED TO PREVENT MISFIRES.
- MUCK PILE MANAGEMENT, MUCK PILES (THE BLASTED PIECES OF ROCK) AND ROCK PILES SHALL BE MANAGED IN A MANNER TO REDUCE THE POTENTIAL FOR CONTAMINATION BY IMPLEMENTING THE FOLLOWING MEASURES:
- (a) REMOVE THE MUCK PILE FROM THE BLAST AREA AS SOON AS REASONARY POSSIBLE
- (b) MANAGE THE INTERACTION OF BLASTED ROCK PILES AND STORMWATER TO PREVENT CONTAMINATION OF WATER
- (5) SPILL PREVENTION MEASURES AND SPILL MITIGATION. SPILL PREVENTION AND SPILL MITIGATION MEASURES SHALL BE IMPLEMEDTED TO PREVENT THE RELEASE OF FILE, AND OTHER RELATED SUBSTANCES TO THE ENVIRONMENT. THE MEASURES SHALL INCLIDE AT A MINIMUM.
- a. THE FUEL STORAGE REQUIREMENTS SHALL INCLUDE:
- 1. STORAGE OF REGULATED SUBSTANCES ON AN IMPERVIOUS SURFACE.
- 2. SECURE STORAGE AREAS AGAINST UNAUTHORIZED ENTRY.
- 3. LABEL REGULATED CONTAINERS CLEARLY AND VISIBLY.
- 5. COVER REGULATED CONTAINERS IN OUTSIDE STORAGE AREAS.
- 8. WHEREVER POSSIBLE, KEEP REQULATED CONTAINERS THAT ARE STORED OUTSIDE MORE THAN 50 FEET FROM SURFACE WATER AND STORM DRAINS, 75 FEET FROM PRIVATE WELLS, AND 400 FEET FROM PUBLIC WELLS.
- 7. SECONDARY CONTAINMENT IS REQUIRED FOR CONTAINERS CONTAINING REGULATED SUBSTANCES STORED OUTSIDE, EXCEPT FOR ON PREMISE USE HEATING FUEL TANKS, OR ABOVEGROUND OR UNDERGROUND STORAGE TANKS OTHERWISE REGULATED.
- b. THE FUEL HANDLING REQUIREMENTS SHALL INCLUDE:
- 1. EXCEPT WHEN IN USE, KEEP CONTAINERS CONTAINING REGULATED SUBSTANCES CLOSED AND SEALED.
- 2.PLACE DRIP PANS UNDER SPIGOTS, VALVES, AND PUMPS.
- 3. HAVE SPILL CONTROL AND CONTAINMENT EQUIPMENT READILY AVAILABLE IN ALL WORK AREAS.
- 4.USE FUNNELS AND DRIP PANS WHEN TRANSFERRING REGULATED SUBSTANCES. 5. PERFORM TRANSFERS OF REGULATED SUBSTANCES OVER AN IMPERVIOUS SURFACE.
- c. THE TRAINING OF ON-SITE EMPLOYEES AND THE ON-SITE POSTING OF RELEASE RESPONSE INFORMATION
- DESCRIBING WHAT TO DO IN THE EVENT OF A SPILL OF REGULATED SUBSTANCES.
- d. FUELING AND MAINTENANCE OF EXCAVATION, EARTHMOVING AND OTHER CONSTRUCTION RELATED EQUIPMENT WILL COMPLY WITH THE REGULATIONS OF NHDES [NOTE THESE REQUIREMENTS ARE SUMMARIZED IN WO-DWG8-22-8; "BES MANAGEMENT PRACTICES FOR FUELING AND MAINTENANCE OF EXCAVATION AND EARTHMOVING EQUIPMENT" OR ITS

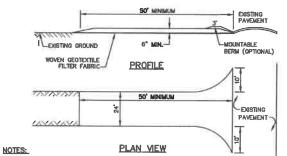

- INSTINE FOR STABILIZED CONSTRUCTION ENTRANCE SHALL BE 1 TO 2 INCH STONE, RECLAIMED STONE, OR RECYCLED CONCRETE CRAYALENT.

 THE LENGTH OF THE STABLEZED ENTRANCE SHALL NOT BE LESS THAN SO FEET, EXCEPT FOR A SINGLE RESIDENTIAL LOT WHERE A SO FOOT MINIMUM LENGTH WOULD APPLY.

 THICKNESS OF THE STONE FOR THE STABLEZED ENTRANCE SHALL NOT BE LESS THAN 6 INCHES.

 THICKNESS OF THE STONE FOR THE STABLEZED ENTRANCE SHALL NOT BE LESS THAN FOR THE ENTRANCE WHERE NORSESS OF ERRESS OCCURS, OR 10 FEET, WHICKEVER IS GREATEN AFTER FOR THE STONE.

 FLITER FABRIC SHALL BE PLACED OVER THE ENTRE AREA PRIOR TO PLACING THE STONE.

 FLITER FABRIC IS NOT REQUIRED FOR A SINGLE FAMILY RESIDENTIAL LOT.

 B. ALL SURFACE WATER THAT IS FLOWING TO OR DIVERTED TOWARD THE CONSTRUCTION ENTRANCE SHALL BE PREDE BEHATH THE ENTRANCE. IF SUBSTITUTED FOR THE PIPE.

 THE ENTRANCE SHALL BE MAINTAINED IN A CONDITION THAT WILL PREVENT TRACKING OR FLOWING OF SEDIMENT ONTO THE PUBLIC BE MAINTAINED HAD A CONDITION THAT WILL PREVENT TRACKING OR FLOWING OF SEDIMENT ONTO THE PUBLIC RIGHT—OF—WAY. THIS MAY REQUIRE PERIODIC TOP DRESSING WITH ADDITIONAL STONE. AS CONDITIONS DEAMED AND REPAIR AND/OR CLEAN DUT OF ANY MEASURES USED TO TRAP
- SEDIMENT ONLD THE PUBLIC RIGHT-OF-WAY, THIS MAY REQUIRE PERIODIC TOP DRESSING WITH ADDITI STONE AS CONDITIONS DEMAND AND REPAIR AND/OR CLEAN OUT OF ANY MEASURES USED TO TRAP SEDIMENT, ALL SEDIMENT SPILLED, WASHED, OR TRACKED ONTO THE PUBLIC RIGHT-OF-WAY MUST BE REMOVED PROMPTLY.

STABILIZED CONSTRUCTION ENTRANCE

Date: 04/29/21

AS NOTED Project No.: 21090

NOT TO SCALE

Design: JAC | Draft: LAZ

Checked: JAC | Scale: AS NOTE Drawing Name: 21090-PLAN.dwg

TEMPORARY EROSION CONTROL NOTES

- THE SMALLEST PRACTICAL AREA OF LAND SHALL BE EXPOSED AT ANY ONE TIME AT NO TIME SHALL AN AREA IN EXCESS OF 5 ACRES BE EXPOSED AT ANY ONE TIME BEFORE DISTURBED AREAS ARE STABILIZED.
- EROSION, SEDIMENT AND DETENTION MEASURES SHALL BE INSTALLED AS SHOWN ON THE PLANS AND AT LOCATIONS AS REQUIRED. DIRECTED BY THE ENGINEER.
- ALL DISTURBED AREAS (INCLUDING POND AREAS BELOW THE PROPOSED WATERLINE) SHALL BE RETURNED TO PROPOSED GRADES AND ELEVATIONS. DISTURBED AREAS SHALL BE LOAMED WITH A MINIMUM OF 6" OF SCREENED ORGANIC LOAM AND SEEDED WITH SEED MIXTURE "C" AT A RATE NOT LESS THAN 1.10 POUNDS OF SEED PER 1,000 S.F. OF AREA (48 185 / ACRE) LBS. / ACRE).
- SILT FENCES AND OTHER BARRERS SHALL BE INSPECTED EVERY SEVEN CALENDAR DAYS AND WITHIN 24 HOURS OF A RAINFALL OF 0.5° OR GREATER. ALL DAWAGED AREAS SHALL BE REPAIRED, AND SEDIMENT DEPOSITS SHALL PERIODICALLY BE REMOVED AND DISPOSED OF.
- AFTER ALL DISTURBED AREAS HAVE BEEN STABILIZED, THE TEMPORARY EROSION CONTROL MEASURES SHALL BE REMOVED AND THE AREA DISTURBED BY THE REMOVAL SMOOTHED AND RE-VEGETATED.
- AREAS MUST BE SEEDED AND MULCHED OR DTHERMISE PERMANENTLY STABILIZED WITHIN 3 DAYS OF FINAL GRADING, OR TEMPORABILY STABILIZED WITHIN 14 DAYS OF THE INITIAL DISTURBANCE OF SOIL ALL AREAS SHALL BE STABILIZED WITHIN 45 DAYS OF INTIAL DISTURBANCE.
- 7. IN AREAS WHERE FINAL GRADING HAS NOT OCCURRED, TEMPORARY STABILIZATION MEASURES SHOULD BE IN PLACE WITHIN 5 CALENDAR DAYS FOR EXPOSED SOIL AREAS THAT ARE WITHIN 100 FEET OF A SURFACE WATERBODY OR A WELLAND AND NO MORE THAN 14 CALENDAR DAYS FOR ALL OTHER AREAS. PERMANENT STABILIZATION SHOULD BE IN PLACE WITHIN 3 CALENDAR DAYS FOLLOWING COMPLETION OF FINAL GRADING OF EXPOSED SOIL AREAS.
- ALL PROPOSED VEGETATED AREAS THAT DO NOT EXHIBIT A MINIMUM OF 85 PERCENT VEGETATIVE GROWTH BY OCTOBER 15, OR WHICH ARE DISTURBED AFTER OCTOBER 15, SHALL BE STABILIZED BY SEEDING AND INSTALLING NORTH AMERICA. GREEN S75 EROSION CONTROL BLANKETS (OR AM EQUIVALENT APPROVED IN WRITING BY THE ENGINEER) ON SLOPES GREATER THAN 3:1, AND SEEDING AND PLACING 3 TO 4 TONS OF MULCH APP ACRE, SECURED WITH ANCHORD NETHING, ELSEWHERE, THE INSTALLATION OF EROSION CONTROL BLANKETS OR MULCH AND NETHING SHALL NOT OCCUR OVER ACCUMULATED SNOW OR ON FROZEN GROUND AND SHALL BE COMPLETED IN ADVANCE OF THAW OR SPRING MELT EVENTS.
- ALL DITCHES OR SWALES WHICH DO NOT EXHIBIT A MINIMUM OF 85 PERCENT VEGETATIVE GROWTH BY OCTOBER 15, OR WHICH ARE DISTURBED AFTER OCTOBER 15, SHALL BE STABILIZED TEMPORARILY WITH STONE OR EROSION CONTROL BLANKETS APPROPRIATE FOR THE DESIGN FLOW CONDITIONS.
- AFTER OCTOBER 15th, INCOMPLETE ROAD OR PARKING SURFACES, WHERE WORK HAS STOPPED FOR THE WINTER SEASON, SHALL BE PROTECTED WITH A MINIMUM OF 3" OF CRUSHED GRAVEL PER NHDOT ITEM 304.3.
- 11. AN AREA SHALL BE CONSIDERED STABLE IF ONE OF THE FOLLOWING HAS OCCURRED:
- a. BASE COURSE GRAVELS HAVE BEEN INSTALLED IN AREAS TO BE PAVED;
- c. A MINIMUM OF 3" OF NON-EROSIVE MATERIAL SUCH STONE OR RIPRAP HAS BEEN INSTALLED; OR
- 11. FUGITIVE DUST CONTROL IS REQUIRED TO BE CONTROLLED IN ACCORDANCE WITH ENV-A 1000, AND THE PROJECT IS TO MEET. THE REQUIREMENTS AND INTENT OF RSA 430:53 AND AGR 3800 RELATIVE TO INVASIVE SPECIES.
- 12. PRIOR TO BEGINNING CONSTRUCTION, THE CONTRACTOR'S NAME, ADDRESS, AND PHONE NUMBER SHALL BE SUBMITTED TO
- . IN ORDER TO ENSURE THE STABILITY OF THE SITE AND EFFECTIVE IMPLEMENTATION OF THE SEDIMENT AND EROSION CONTROL MEASURES SPECIFIED IN THE PLANS FOR THE DURATION OF CONSTRUCTION, THE CONTRACTOR SHALL BE IN STRICT COMPLIANCE WITH THE FOLLOWING INSPECTION AND MAINTENANCE REQUIREMENTS IN ADDITION TO THOSE CALLED FOR IN THE SWIPPP:
- a. A CERTIFIED PROFESSIONAL IN EROSION AND SEDIMENT CONTROL OR A PROFESSIONAL ENGINEER LICENSED IN THE STATE OF NEW HAMPSHIRE ("MONITOR") SHALL BE EMPLOYED TO INSPECT THE SITE FROM THE START OF ALTERATION OF TERRAIN ACTIVITIES UNTIL THE SITE IS IN FULL COMPLIANCE WITH THE SITE SPECIFIC PERMIT ("PERMIT").
- b. DURING THIS PERIOD, THE MONITOR SHALL INSPECT THE SUBJECT SITE AT LEAST ONCE A WEBK, AND IF POSSIBLE, DURING ANY 16 INCH OR GREATER RAIN EVENT (I.E. 16 INCH OF PRECIPITATION OR MORE WITHIN A 24 HOUR PERIOD). IF UNABLE TO BE PRESENT DURING SUCH A STORM, THE MONITOR SHALL INSPECT THE SITE WITHIN 24 HOURS OF THIS EVENT.
- THE MONITOR SHALL PROVIDE TECHNICAL ASSISTANCE AND RECOMMENDATIONS TO THE CONTRACTOR ON THE APPROPRIATE BEST MANAGEMENT PRACTICES FOR EROSION AND SEMILENT CONTROLS REQUIRED TO MEET THE REQUIREDITYS OF RSA 458 A17 AND ALL APPLICABLE DES PERMIT CONDITIONS.
- d. WITHIN 24 HOURS OF EACH INSPECTION, THE MONITOR SHALL SUBMIT A REPORT TO DES VIA EMAIL (RIDGELY MAJICK AT: RIDGELY.MAJICK@DES.NH.GOV).
- e. THE MONITOR SHALL MEET WITH DES TO DECIDE UPON A REPORT FORMAT. THE REPORT FORMAT SHALL BE REVIEWED AND APPROVED BY DES PRIOR TO THE START OF CONSTRUCTION.

Earth Berm PLAN VIEW CROSS SECTION

TEMPORARY SEDIMENT BASIN

NOT TO SCALE

SEEDING SPECIFICATIONS

- GRADING AND SHAPING
 A SLOPES SHALL NOT BE STEEPER THAN 2:1 WITHOUT APPROPRIATE EROSION CONTROL MEASURES AS SPECIFIED ON THE PLANS (3:1 SLOPES OR FLATTER ARE PREFERED).
 B. WHERE MOWING WILL BE DONE, 3:1 SLOPES OR FLATTER ARE RECOMMENDED.

- 2. SEEDBED PREPARATION.

 A. SURFACE AND SEEPAGE WATER SHOULD BE DRAINED OR DIVERTED FROM THE SITE TO PREVENT DROWNING.
- OR WINTER KILLING OF THE PLANTS.

 B. STONES LARGER THAN 4 INCHES AND TRASH SHOULD BE REMOVED BECAUSE THEY INTERFERE WITH SEEDING AND FUTURE MAINTENANCE OF THE AREA. WHERE FEASIBLE, THE SOIL SHOULD BE TILLED TO A DEPTH OF ABOUT 4 INCHES TO PREPARE A SEEDBED AND FERTILIZER AND LIME MIXED INTO THE SOIL. T SEEDBED SHOULD BE LEFT IN A REASONABLY FIRM AND SMOOTH CONDITION. THE LAST TILLAGE OPERATION SHOULD BE PERFORMED ACROSS THE SLOPE WHEREVER PRACTICAL

- 3. ESTABLISHING A STAND.

 A. LIME AND FERTILIZER SHOULD BE APPLIED PRIOR TO OR AT THE TIME OF SEEDING AND INCORPORATED INTO THE SOIL. TYPES AND AMOUNTS OF LIME AND FERTILIZER SHOULD BE BASED ON AN EVALUATION OF SOIL TESTS. WHEN A SOIL TEST IS NOT AVAILABLE, THE FOLLOWING MINIMUM AMOUNTS SHOULD BE
 - APPLIED:
 AGRICULTURAL LIMESTONE, 2 TONS PER ACRE OR 100 LBS. PER 1,000 SQ.FT. NITROGEN(M), 50 LBS, PER ACRE OR 1.1 LBS, PER 1,000 SQ.FT.
 PHOSPHATE(P205), 100 LBS, PER ACRE OR 2.2 LBS, PER 1,000 SQ.FT.
 POTASH(K20), 100 LBS, PER ACRE OR 2.2 LBS, PER 1,000 SQ.FT.
 - (NOTE: THIS IS THE EQUIVALENT OF 500 LBS, PER ACRE OF 10-20-20 FERTILIZER OR 1,000 LBS, PER
- SEED SHOULD BE SPREAD UNIFORMLY BY THE METHOD MOST APPROPRIATE FOR THE SITE. METHODS INCLUDE BROADCASTING, DRILLING AND HYDROSEEDING, WHERE BROADCASTING IS USED, COVER SEED WITH 2.25 INCH OF SOLIC OR LESS, BY CULTIPACKING OR RANDING.
- .25 INCH OF SOIL OR LESS, BY CULTIPACKING OR RAKING.

 REFERT OT THE "SEEDING GUIDE" AND SEEDING RATES TABLES ON THIS SHEET FOR APPROPRIATE SEED

 MIXTURES AND RATES OF SEEDING. ALL LEGAIMES (CROWNVETCH, BIRDSFOOT, TREFGIL AND FLATPEA)

 MUST BE NOCULLATED WITH THEIR SPECIFIC INCOLLANT PRORT OT THEIR HITROUCHON TO THE SITE.

 WHEN SEEDED AREAS ARE MULCHED, PLANTINGS MAY BE MADE FROM EARLY SPRING TO EARLY OCTOBER.

 WHEN SEEDED AREAS ARE NOT MULCHED, PLANTINGS SHOULD BE MADE FROM EARLY SPRING TO MAY 20th

 OR FROM AUGUST 10th TO SEPTEMBER 1st.

MULCH.
 HAY, STRAW, OR OTHER MULCH, WHEN NEEDED, SHOULD BE APPLIED IMMEDIATELY AFTER SEEDING.
 MULCH WILL BE HELD IN PLACE USING APPROPRIATE TECHNIQUES FROM THE BEST MANAGEMENT PRACTICE FOR MULCHING, HAY OR STRAW MULCH SHALL BE PLACED AT A RATE OF 90 LBS PER 1000 S.F.

- MAINTENANCE TO ESTABLISH A STAND
 PLANTED AREAS SHOULD BE PROTECTED FROM DAMAGE BY FIRE, GRAZING, TRAFFIC, AND DENSE WEED
- CROWTH.
 FERTILIZATION NEEDS SHOULD BE DETERMINED BY ONSITE INSPECTIONS. SUPPLEMENTAL FERTILIZER IS
 USUALLY THE KEY TO FULLY COMPLETE THE ESTABLISHMENT OF THE STAND BECAUSE MOST PERENNIALS
 TAKE 2 TO 3 YEARS TO BECOME FULLY ESTABLISHED.

C.	IN WATERWAYS, CHANNELS, OR SWALES	WHERE UNIFORM FLOW CONDITIONS ARE ANTICIPATED, ANNUA	AL
	MOWING MAY BE NECESSARY TO CONTR	ROL GROWTH OF WOODY VEGETATION.	

USE	SEEDING MIXTURE 1/	DROUGHTY	DRAINED	MODERATELY WELL DRAINED	POORLY DRAINED
STEEP CUTS AND FILLS, BORROW AND DISPOSAL AREAS	A B C	FAIR POOR POOR	GOOD GOOD	GOOD FAIR EXCELLENT	FAIR FAIR GOOD
	D	FAIR	EXCELLENT	EXCELLENT	POOR
WATERWAYS, EMERGENC SPILLWAYS, AND OTHER CHANNELS WITH FLOWING WATER.		GOOD GOOD	GOOD EXCELLENT	GOOD EXCELLENT	FAIR FAIR
LIGHTLY USED PARKING LOTS, ODD AREAS, UNUSED LANDS, AND LOW INTENSITY USE RECREATION SITES.	A B C	G000 G000	GOOD GOOD EXCELLENT	GOOD FAIR EXCELLENT	FAIR POOR FAIR
PLAY AREAS AND ATHLETIC FIELDS. (TOPSOIL IS ESSENTIAL FOR GOOD TURF.)	E	FAIR FAIR	EXCELLENT	EXCELLENT	2/2/

GRAVEL PIT, SEE NH-PM-24 IN APPENDIX FOR RECOMMENDATION REGARDING RECLAMATION OF SAND AND GRAVEL PITS. 1/ REFER TO SEEDING MIXTURES AND RATES IN TABLE BELOW.
2/ POORLY DRAINED SOILS ARE NOT DESIRABLE FOR USE AS PLAYING AREA AND ATHLETIC FIELDS.

NOTE: TEMPORARY SEED MIX FOR STABILIZATION OF TURF SHALL BE WINTER RYE OR OATS AT A RATE OF 2.5 LBS. PER 1000 S.F. AND SHALL BE PLACED PRIOR TO OCTOBER 15th, IF PERMANENT SEEDING NOT VET COMPLETS.

SEEDING GUIDE


MIXTURE	POUNDS PER ACRE	POUNDS PER 1.000 So. Ft.
A. TALL FESCUE	20	0.45
CREEPING RED FESCUE	20	0.45
RED TOP	2	0.05
TOTAL	42	0.95
B. TALL FESCUE CREEPING RED FESCUE CROWN VETCH OR	15 10 15	0.35 0.25 0.35
FLAT PEA	30	0.75
TOTAL	40 OR 55	0.95 OR 1.35
C. TALL FESCUE CREEPING RED FESCUE BIRDS FOOT TREFOIL TOTAL	20 20 8 48	0.45 0.45 0.20 1.10
D. TALL FESCUE	20	0.45
FLAT PEA	30	0.75
TOTAL	50	1.20
E. CREEPING RED FESCUE 1/	50	1.15
KENTUCKY BLUEGRASS 1/	50	1.15
TOTAL	100	2.30
F. TALL FESCUE 1	150	3.60

SEEDING RATES

E-MAIL: JBE@JONESANDBEACH.COM

CONSTRUCTION SEQUENCE

- PRIOR TO THE START OF ANY ACTIVITY, IT IS THE RESPONSIBILITY OF THE SITE'S SITE DEVELOPER (OR DWNERT) TO FILE A NOTICE OF INTENT (NOV) FORM WITH THE ENVIRONMENTAL PROTECTION AGENCY (EPA) IN ORDER TO GAIN COVERAGE UNDER THE MPDES GENERAL PERMIT FOR STORM WATER DISCHARGES FROM COVISTRUCTION ACTIVITIES. A PRE-CONSTRUCTION MEETING IS TO BE HELD WITH ALL DEPARTMENT HEADS PRIOR TO THE STRATE OF CONSTRUCTION.
- 2. WETLAND BOUNDARIES ARE TO BE CLEARLY MARKED PRIOR TO THE START OF CONSTRUCTION.
- CUT AND REMOVE TREES IN CONSTRUCTION AREA AS REQUIRED OR DIRECTED.
- INSTALL SILT FENCING, HAY BALES AND CONSTRUCTION ENTRANCES PRIOR TO THE START OF CONSTRUCTION, HESSE ARE TO SE MAINTAINED UNTIL THE FINAL PAVEMENT SURFACING AND LANDSCAPING AREAS ARE ESTABLISHED.
- CLEAR, CUT, GRUB AND DISPOSE OF DEBRIS IN APPROVED FACILITIES. THIS INCLUDES ANY REQUIRED DEMOLITION OF EXISTING STRUCTURES, UTILITIES, ETC.
- STRIP LOAM AND PAVEMENT, OR RECLAIM EXISTING PAVEMENT WITHIN LIMITS OF WORK PER THE RECOMMENDATIONS OF THE PROJECT ENGINEER AND STOCKPILE EXCESS MATERIAL, STABILIZE STOCKPILE AS NECESSARY.
- PERFORM PRELIMINARY SITE GRADING IN ACCORDANCE WITH THE PLANS, INCLIDING THE CONSTRUCTION OF ANY RETAINING WALLS.
- 9. PREPARE BUILDING PAD(S) TO ENABLE BUILDING CONSTRUCTION TO BEGIN
- INSTALL THE SEWER AND DRAINAGE SYSTEMS FIRST, THEN ANY OTHER UTILITIES IN ACCORDANCE WITH THE PLAN AND DETAILS, ANY CONFLICTS BETWEEN UTILITIES ARE TO BE RESOLVED WITH THE INVOLVEMENT AND APPROVAL OF THE ENGINEER.
- 11. INSTALL INLET PROTECTION AT ALL CATCH BASINS AS THEY ARE CONSTRUCTED IN ACCORDANCE WITH
- 12. ALL SWALES AND DRAINAGE STRUCTURES ARE TO BE CONSTRUCTED AND STABILIZED PRIOR TO HAVING RUN-OFF DIRECTED TO THEM.
- 14. PERFORM FINAL FINE GRADING, INCLUDING PLACEMENT OF 'SELECT' SUBGRADE MATERIALS.
- 15. PAVE ALL PARKING LOTS AND ROADWAYS WITH INITIAL BASE COURSE.
- 16. PERFORM ALL REMAINING SITE CONSTRUCTION (i.e. BUILDING, CURBING, UTILITY CONNECTIONS, ETC.).
- LOAM AND SEED ALL DISTURBED AREAS AND INSTALL ANY REQUIRED SEDIMENT AND EROSION CONTROL FACILITIES (i.e. RIP RAP, EROSION CONTROL BLANKETS, ETC.).
- 18. FINISH PAVING ALL ROADWAYS AND PARKING AREAS WITH 'FINISH' COURSE.
- ALL ROADWAYS AND PARKING LOTS SHALL BE STABILIZED WITHIN 72 HOURS OF ACHIEVING FINISHED GRADE.
- 20. ALL CUT AND FILL SLOPES SHALL BE SEEDED/LOAMED WITHIN 72 HOURS OF ACHIEVING FINISHED GRADE.
- REMOVE TEMPORARY EROSION CONTROL MEASURES AFTER SEEDING AREAS HAVE BEEN 75%-85% ESTABLEMED AND SITE IMPROVEMENTS ARE COMPLETE. SMOOTH AND RE-VEGETATE ALL DISTURBED AREAS.
- 23. CLEAN SITE AND ALL DRAINAGE STRUCTURES, FIPES AND SUMPS OF ALL SILT AND DEBRIS.
- 24. INSTALL ALL PAINTED PAVEMENT MARKINGS AND SIGNAGE PER THE PLANS AND DETAILS. 25. ALL EROSION CONTROLS SHALL BE INSPECTED WEEKLY AND AFTER EVERY HALF-INCH OF RAINFALL
- 26. UPON COMPLETION OF CONSTRUCTION, IT IS THE RESPONSIBILITY OF THE CONTRACTOR TO NOTIFY ANY RELEVANT PERMITTING AGENCIES THAT THE CONSTRUCTION HAS BEEN FINISHED IN A SATISFACTORY MANNER.

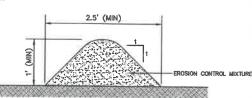

NOTES:

- 1. ORGANIC FILTER BERMS MAY BE UTILIZED IN LIEU OF SILT FENCE, UNLESS OTHERWISE SPECIFIED.
- THE EROSON CONTROL MIX USED IN THE FILTER BERMS SHALL BE A WELL-GRADED MIXTURE OF PARTICLE SIZES, MAY CONTAIN ROCKS LESS THAN 4" IN DIAMETER, STUMP GRINDINGS, SKREDOED OR COMPOSITED BARK, OR ACCEPTABLE MANUFACTURED PRODUCTS, AND SHALL BE FREE OF REFUSE, PHYSICAL CONTAMINANTS, AND MATERIAL TOXIC TO PLANT GROWTH, AND SHALL MEET THE FOLLOWING STANDARDS;
- o) THE ORGANIC CONTENT SHALL BE 80-100% OF DRY WEIGHT.
 b) PARTICLE SIZE BY WEIGHT SHALL BE 100% PASSING A 6" SCREEN, AND 70-85% PASSING A 0.75" SCREEN.
 o) THE ORGANIC PORTION SHALL BE FIBROUS AND ELONGATED.
 d) LARGE PORTIONS OF SILTS, CLAYS, OR FINE SANDS SHALL NOT BE INCLUDED IN THE MIXTURE.
- e) SOLUBLE SALTS CONTENT SHALL BE >4.0mmhos/crr
- ORGANIC FILTER BERMS SHALL BE INSTALLED ALONG A RELATIVELY LEVEL CONTOUR. IT MAY BE NECESSARY TO CUIT TALL GRASSES OR WOODY VEGETATION TO AVOID CREATING VOIDS AND BRIDGES THAT WOULD EXPLIE FINES TO WASH UNDER THE BERM.
- 4. ON SLOPES LESS THAN 5%, OR AT THE BOTTOM OF SLOPES STEEPER THAN 3:1, UP TO 20' LONG, THE BERM SHALL BE A MINIMUM OF 12" HIGH (AS MEASURED ON THE UPHILL SIDE), AND A MINIMUM OF 36" MUCE. ON LONGER OR STEEPER SLOPES, THE BERM SHALL BE WIDER TO ACCOMMODATE THE POTENTIAL ADDITIONAL RUNOFF.
- 5. FROZEN GROUND, OUTCROPS OF BEDROCK, AND VERY ROOTED FORESTED AREAS PRESENT THE MOST PRACTICAL AND EFFECTIVE LOCATIONS FOR ORGANIC FILTER BERNS. OTHER BUP'S SHOULD BE USED AT LOW POINTS OF CONCENTRATED RUNDER, BELOW CULVERT OUTLET ARRONS, AROUND CATCH BUSINS, AND AT THE BOTTOM OF STEEP PERIMETER SLOPES THAT HAVE A LARGE CONTRIBUTING AREA.
- SEDIMENT SHALL BE REMOVED FROM BEHIND THE STRUCTURES WHEN IT HAS ACCUMULATED TO ONE HALF THE ORIGINAL HEIGHT OF THE STRUCTURE.
- 7. STRUCTURES MAY BE LEFT IN PLACE ONCE THE SITE IS STABILIZED

ORGANIC FILTER BERM

NOT TO SCALE

Designed and Produced in NH Plan Name: EROSION AND SEDIMENT CONTROL DETAILS **BAYBERRY COMMONS** Project:

FAX: 603-772-0227

19 OLD GONIC ROAD, ROCHESTER, NH Owner of Record: LEO P. LACOUTURE REV. TRUST & WILLIAN B. LACOUTURE 19 OLD GONIC RD., ROCHESTER, NH 03867 BK 4093 PG 148 SHEET 45 OF 46 JBE PROJECT NO. 21090

DRAWING No

PERMISSION FROM JONES & BEACH ENGINEERS, INC. (JBF). ANY ALTERATIONS, AUTHORIZED OR OTHERWISE, SHALL BE AT THE USER'S SOLE RISK AND WITHOUT LIABILITY TO JBE,



3/11/22 LAZ REVISED PER CITY COMMENTS 2 2/14/22 LAZ REVISED PER CITY ENGINEERING COMMENTS 1 1/18/22 REVISED PER CITY COMMENTS LAZ 0 11/23/21 LAZ ISSUED FOR REVIEW REV. DATE

Jones & Beach Engineers, Inc. B5 Portsmouth Ave. Civil Engineering Services



WLSON STREET BROOK STREET WAVERLY STREET LOCUS SCALE: 1"=1000"

PHASING NOTES:

- PHASING IS MANDATORY PER NEW HAMPSIRE DEPARTMENT OF ENVIRONMENTAL SERVICES AND NEW HAMPSHIRE DEPARTMENT OF ENVIRONMENTAL SERVICES ALTERATION OF TERRAIN SHALL BE NOTIFIED OF ANY ALTERATION OF THE PHASING PLAN.
- 2. EACH PHASE MUST BE STABILIZED BEFORE PROCEEDING TO SUCCESSIVE PHASES.
- 3. AN ENVIRONMENTAL MONITOR SHALL BE EMPLOYED TO EVALUATE THE SITE DURING CONSTRUCTION.
- AREAS MUST BE STABILIZED PRIOR TO WINTER CONSTRUCTION SEASON FROM OCTOBER 15 THROUGH MAY 15 PURSUANT TO Env-Wq 1505.06 (1 AC OPEN) UNLESS A WINTER CONSTRUCTION/STABILIZATION PLAN IS SUBMITTED AND APPROVED.

PHASING SCHEDULE:

PHASE 1

CONSTRUCT: BAYBERRY LANE
ALL BUILDINGS FRONTING ON BAYBERRY LANE
ALL PONDS

PHASE 2

CONSTRUCT: APPLECREST LANE
ALL BUILDINGS FRONTING ON APPLECREST LANE

PHASE 3

CONSTRUCT: HAWTHORNE CIRCLE AND WINTERBERRY LANE ALL BUILDINGS FRONTING ON HAWTHORNE CIRCLE AND WINTERBERRY LANE

PROJECT PARCEL CITY OF ROCHESTER TAX MAP 131, LOT 10

APPLICANT GREEN AND COMPANY 11 LAFAYETTE ROAD NORTH HAMPTON, NH 03862

1,309,695 SQ, FT, ± 30.07 ACRES ±

Design: JAC Draft: LAZ Date: 04/29/21
Checked: JAC Scale: AS NOTED Project No.;21090
Drawing Name: 21090-PLAN.dwg

THIS PLAN SHALL NOT BE MODIFIED WITHOUT WRITTEN PERMISSION FROM JONES & BEACH EMBINEERS, INC. (JBE), ANY ALTERATIONS, AUTHORIZED OR OTHERWISE, SMALL BE AT THE USER'S SOLE RISK AND WITHOUT LIABILITY TO JBE.



3	3/11/22	REVISED PER CITY COMMENTS	LAZ
2	2/14/22	REVISED PER CITY ENGINEERING COMMENTS	LAZ
1	1/18/22	REVISED PER CITY COMMENTS	LAZ
0	11/23/21	ISSUED FOR REVIEW	LAZ
REV.	DATE	REVISION	BY

Designed and Produced in NH B Jones & Beach Engineers, Inc.

85 Portsmouth Ave. Civil Engineering Services
PO Box 219
Stratham, NH 03885
E-MAIL: JBE®

603-772-4746 Services 603-772-4746 FAX: 603-772-0227 E-MAIL: JBE@JONESANDBEACH.COM

Plan Name:	PHASING PLAN
Project:	BAYBERRY COMMONS 19 OLD GONIC ROAD, ROCHESTER, NH
Owner of Record:	LEO P. LACOUTURE REV. TRUST & WILLIAN B. LACOUTURE 19 OLD GONIC RD., ROCHESTER, NH 03867 BK 4093 PG 148

GRAPHIC SCALE

(IN FEET) 1 inch = 100 ft.












FRONT ELEVATION
OPTION I BOALE MY - 1-07

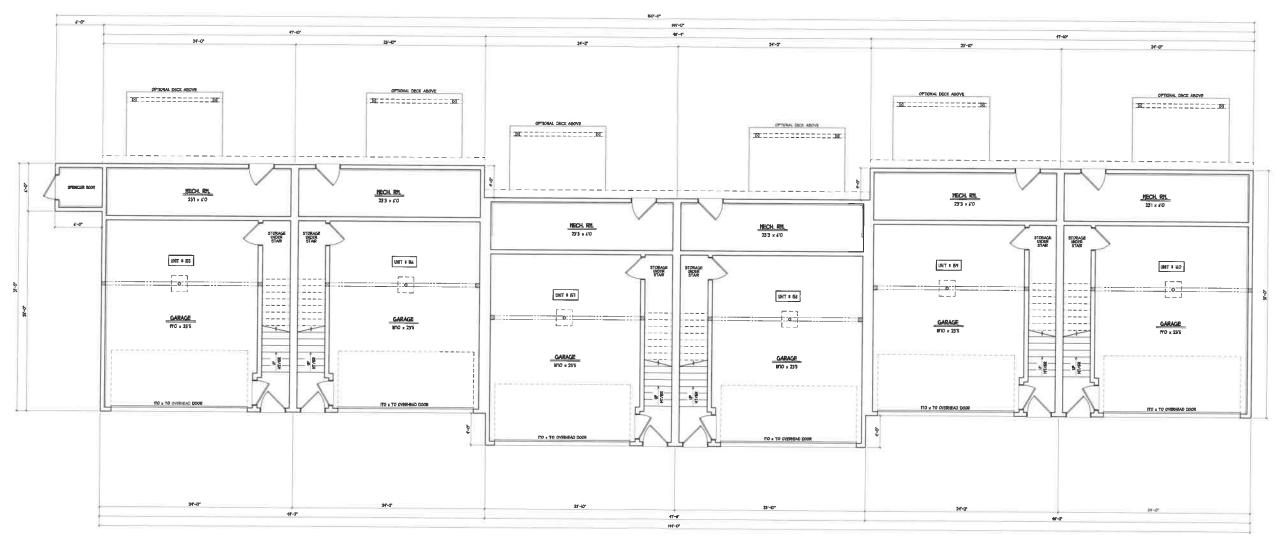

GROUND FLOOR PLAN

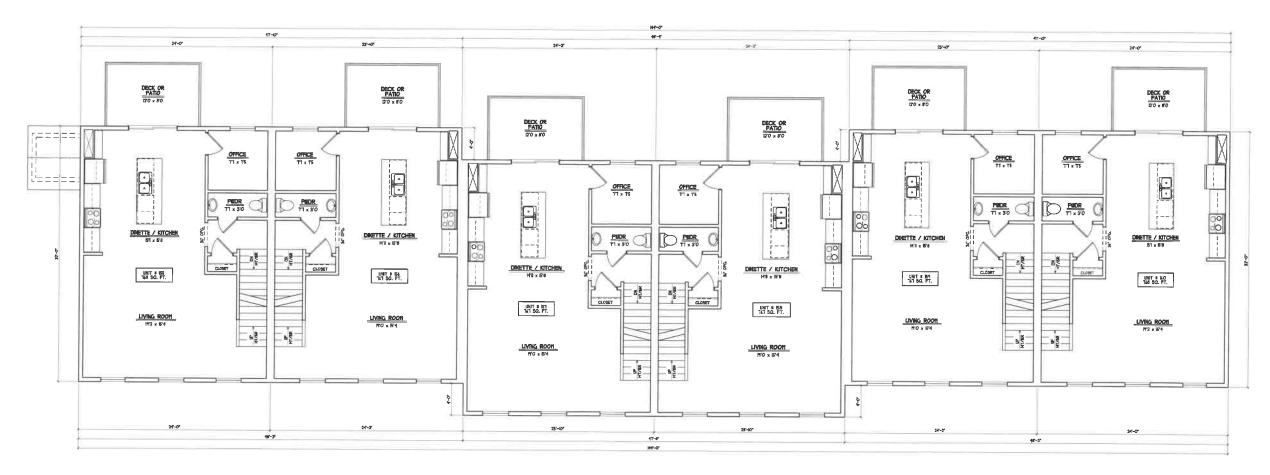

SECOND FLOOR PLAN

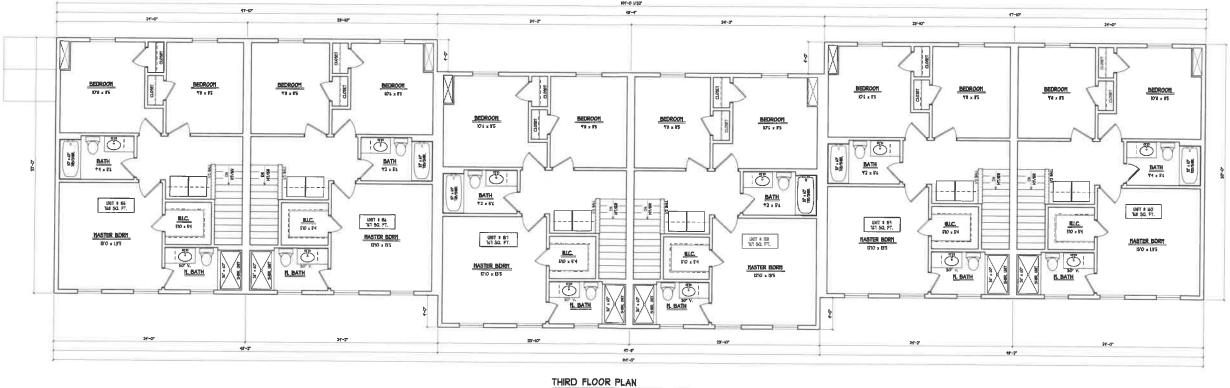


HIRD FLOOR PLAN


SCALE INF - 1:





FRONT ELEVATION

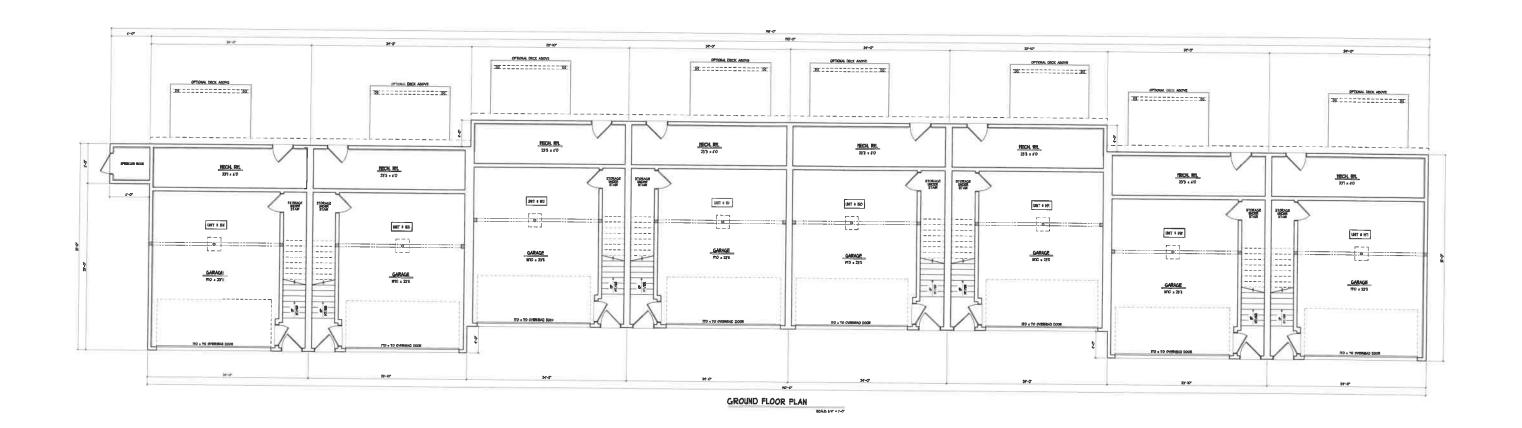

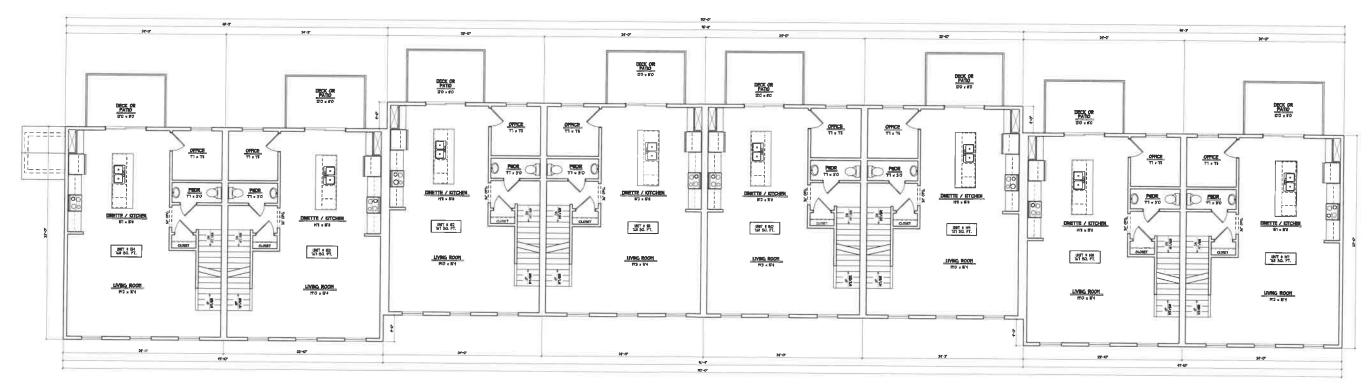

SECOND FLOOR PLAN

