
HEAVY EQUIPMI WASTE MAN BAY ADDITION SHIRE, INC.

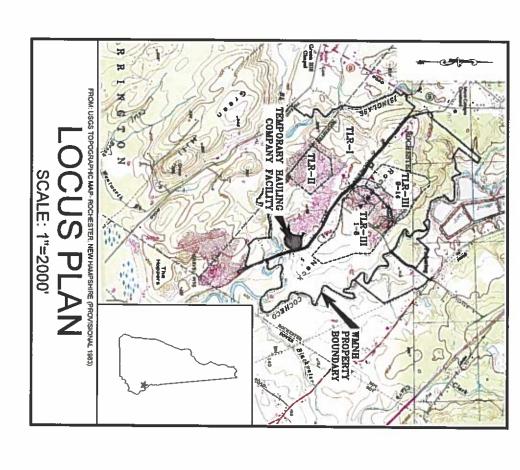

SHEET INDEX


-
OVERALL SITE
TE AND ZO
NING PLAN

- **EXISTING CONDITIONS PLAN**
- PROPOSED DEVELOPMENT PLAN
- **BUILDING FLOOR PLAN**
- **BUILDING ELEVATIONS**
- **EROSION CONTROL DETAILS**

FOR MORE INFORMATION ABOUT THESE PLANS, CONTACT THE CITY OF ROCHESTER PLANNING DEPARTMENT, 31 WAXEFIELD STREET, ROCHESTER, NH 02467 (903) 335-1338.

APPROVAL CERTIFIED BY:

THE DEVELOPMENT DEPICTED IN THESE DRAWINGS MUST BE IN COMPLIANCE WITH ALL APPLICABLE JAWANCLUDING ALL PERTINENT PROVISIONS OF THE "CITY OF ROCHESTER SITE PLAN REGULATIONS"- LINLESS OTHERWISE WALVED.

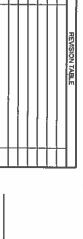



WASTE MANAGEMENT OF NEW HAMPSHIRE, INC ROCHESTER, NEW HAMPSHIRE


WASTE MANAGEMENT


SANBORN HEAD


20 FOUNDRY STREET, CONCORD, NEW HAMPSHIRE 03301 (603) 229-1900 FAX (603) 229-1919

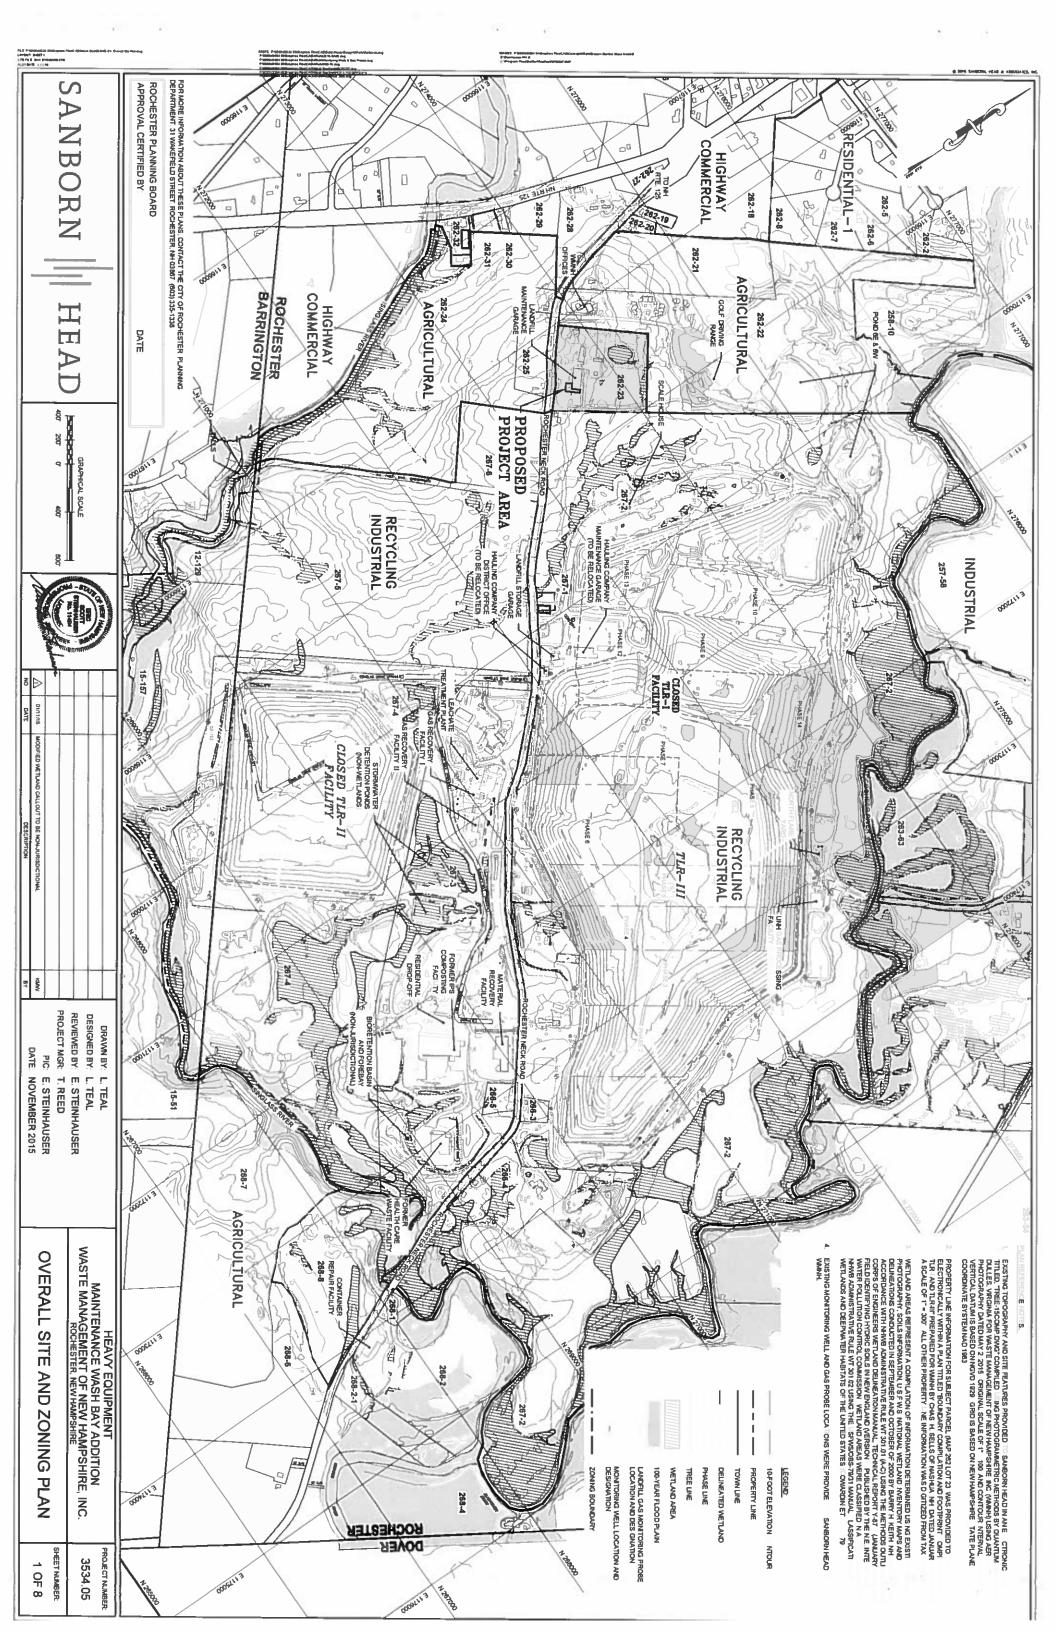

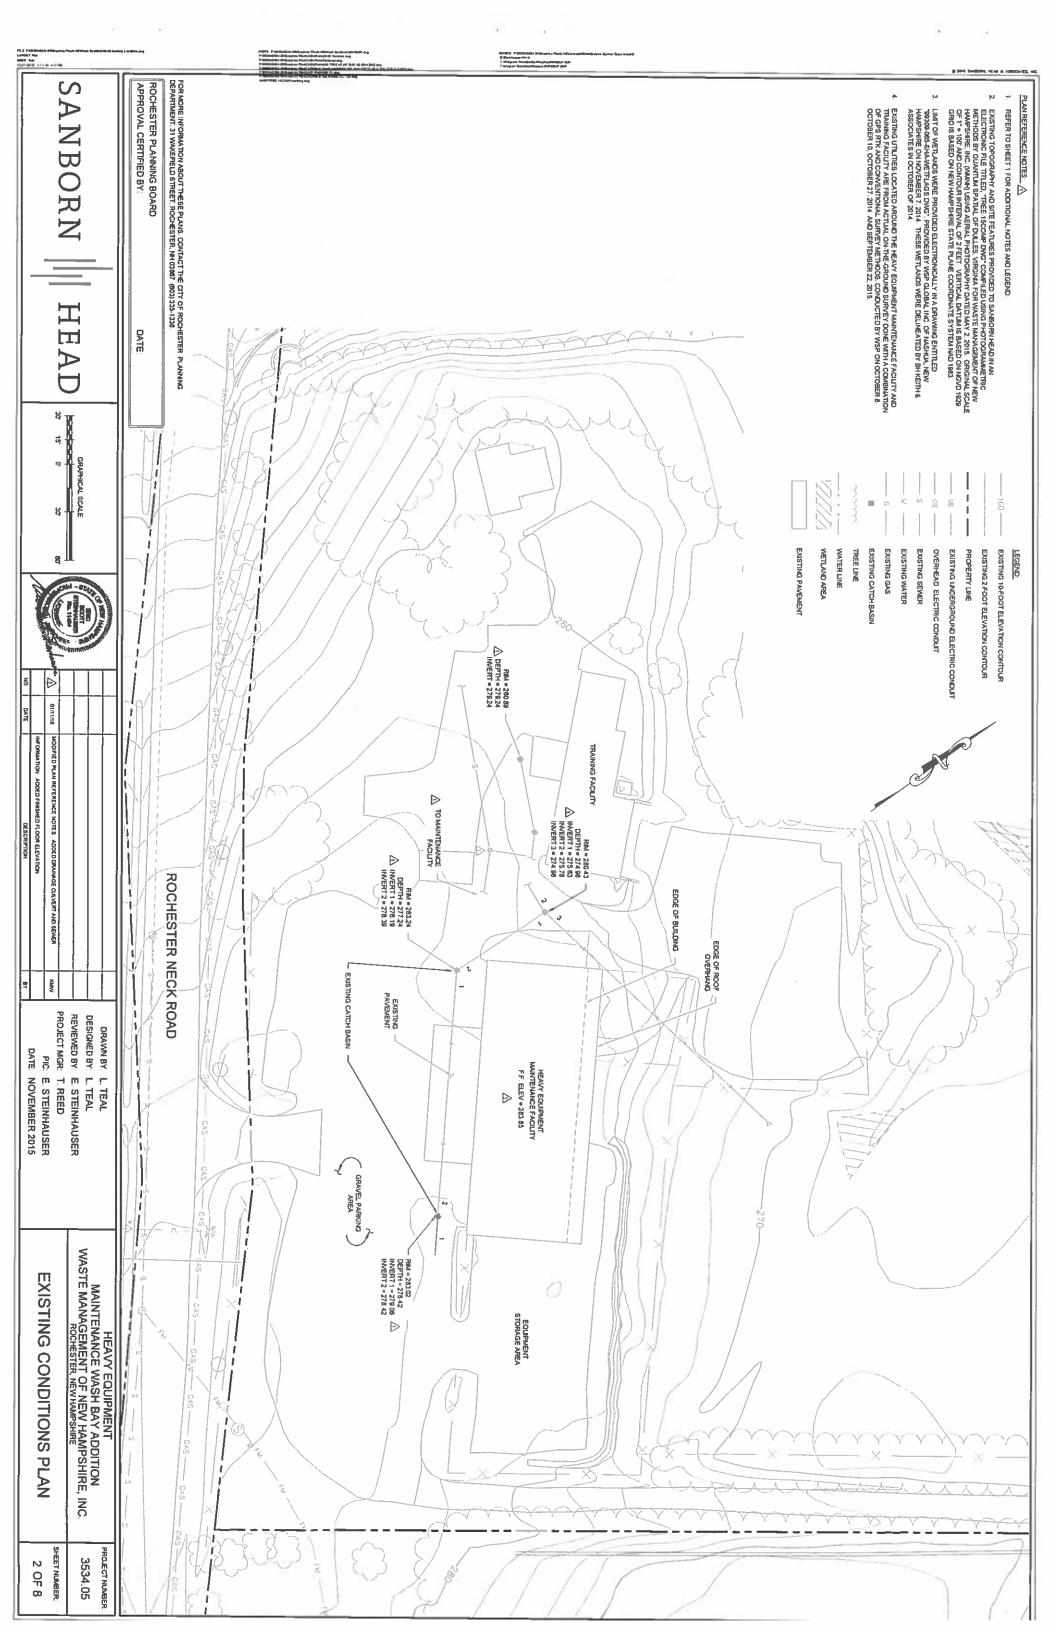

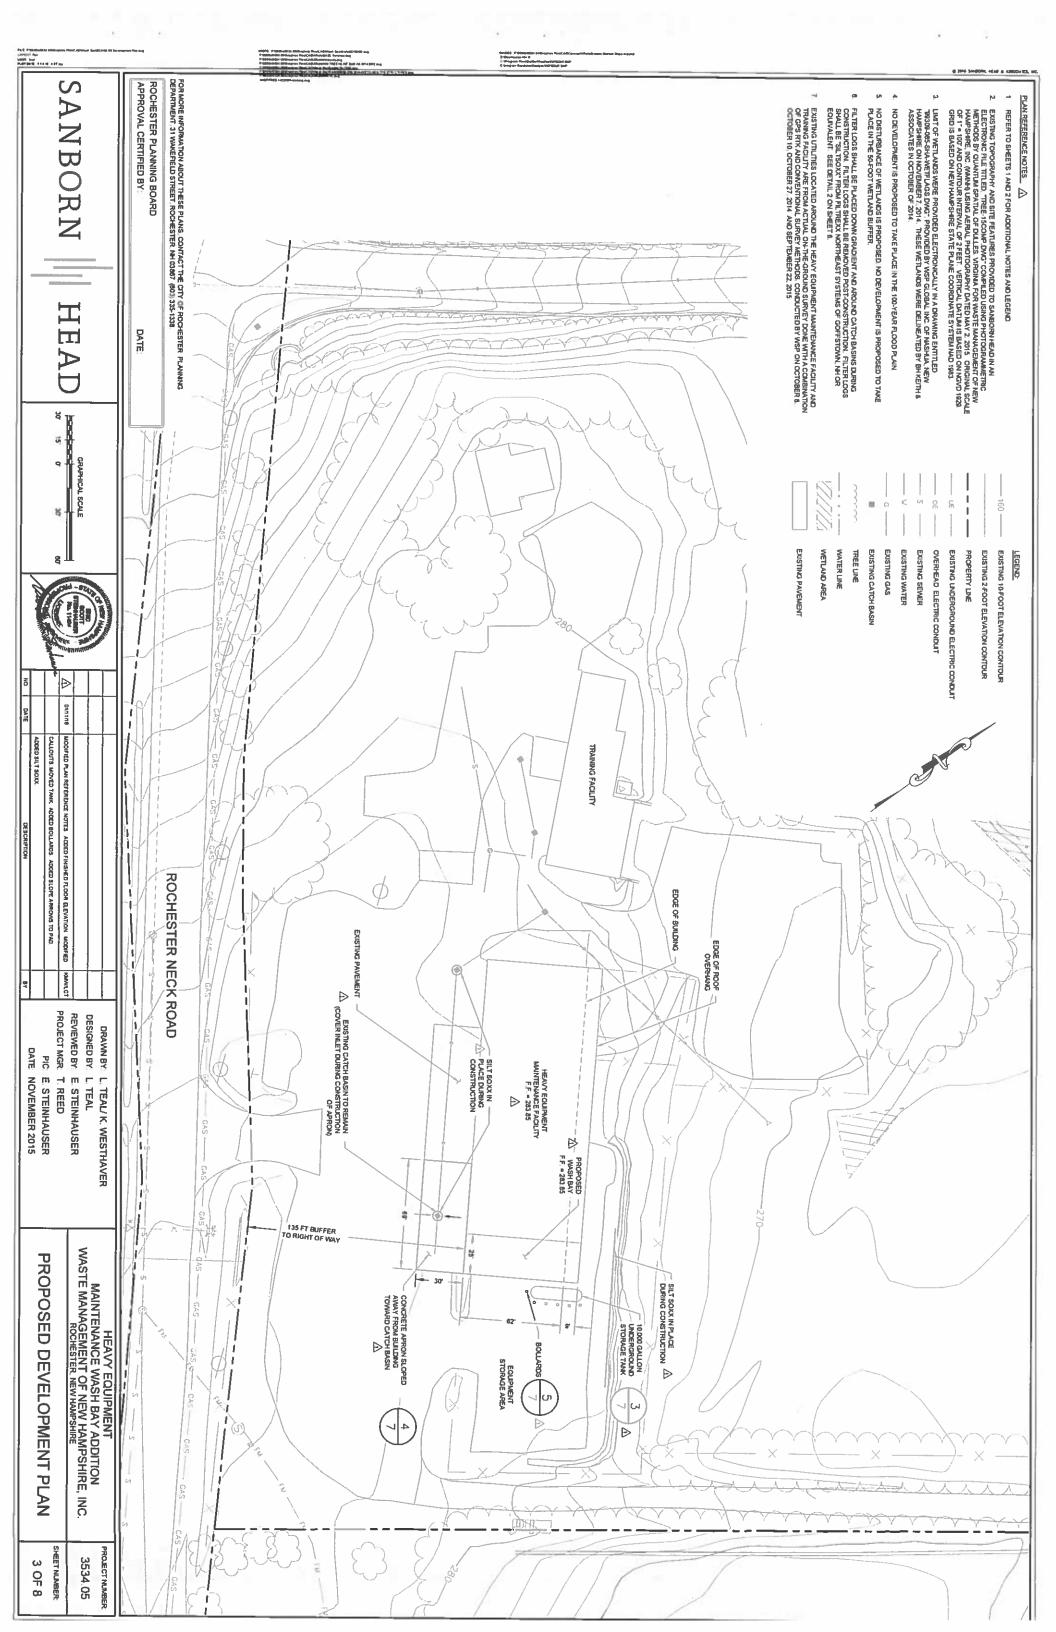


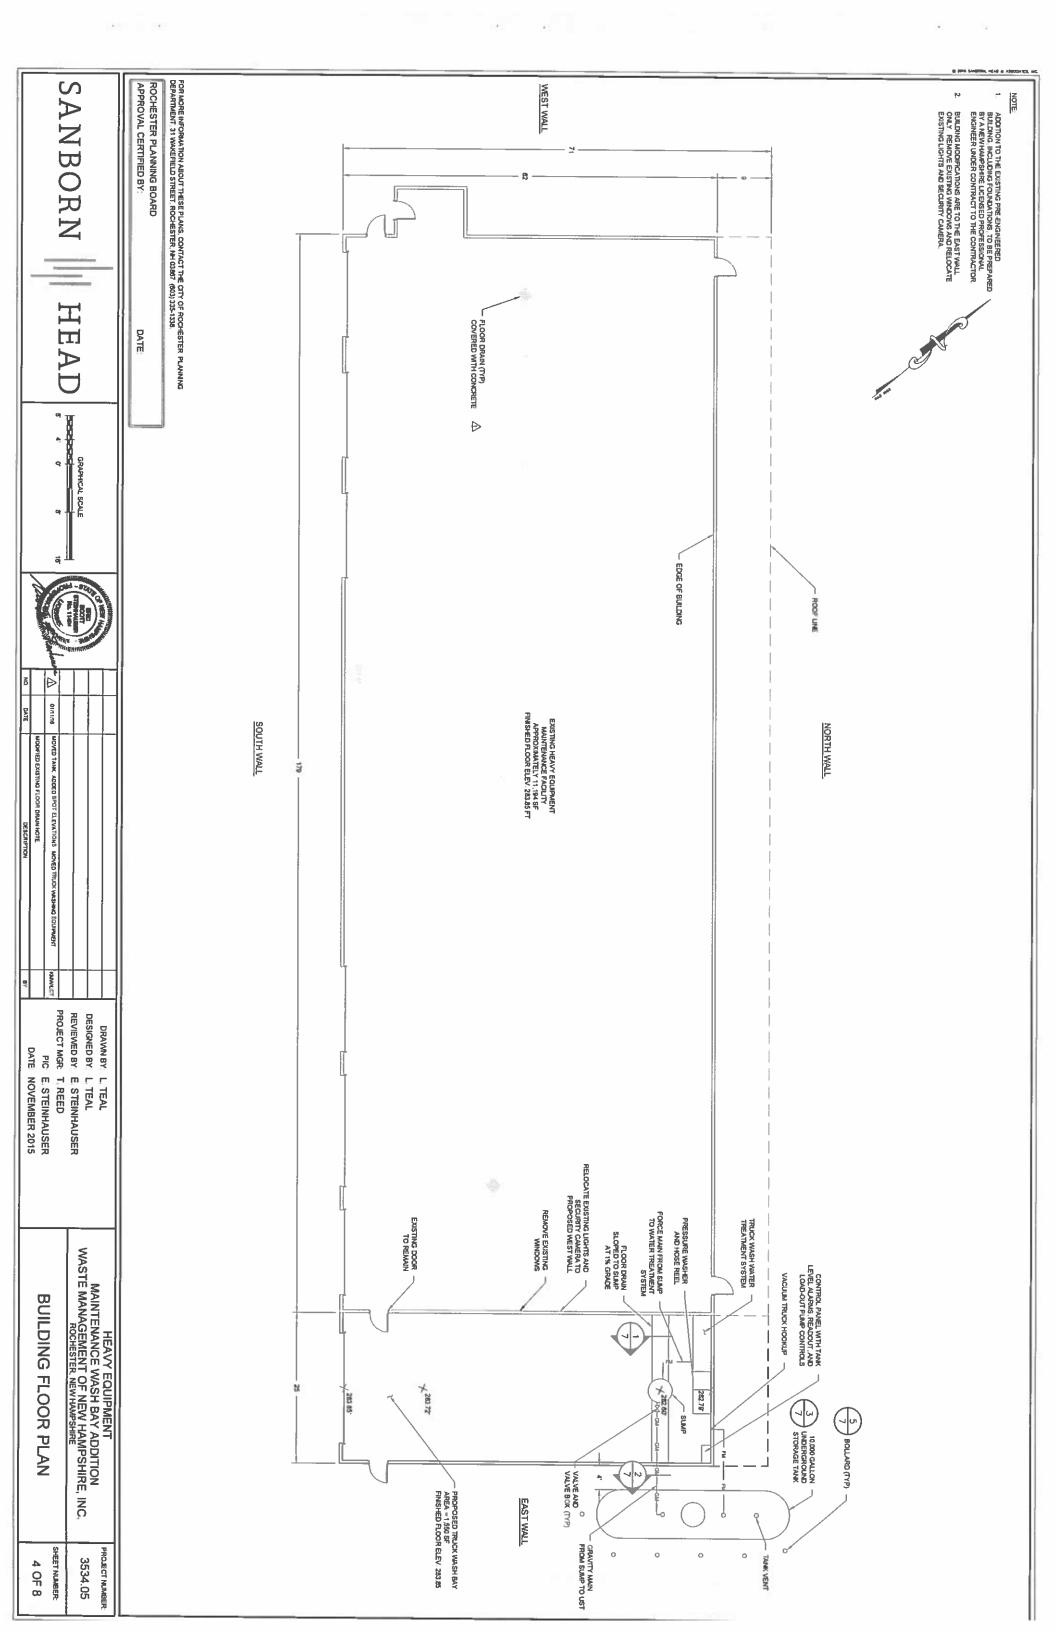

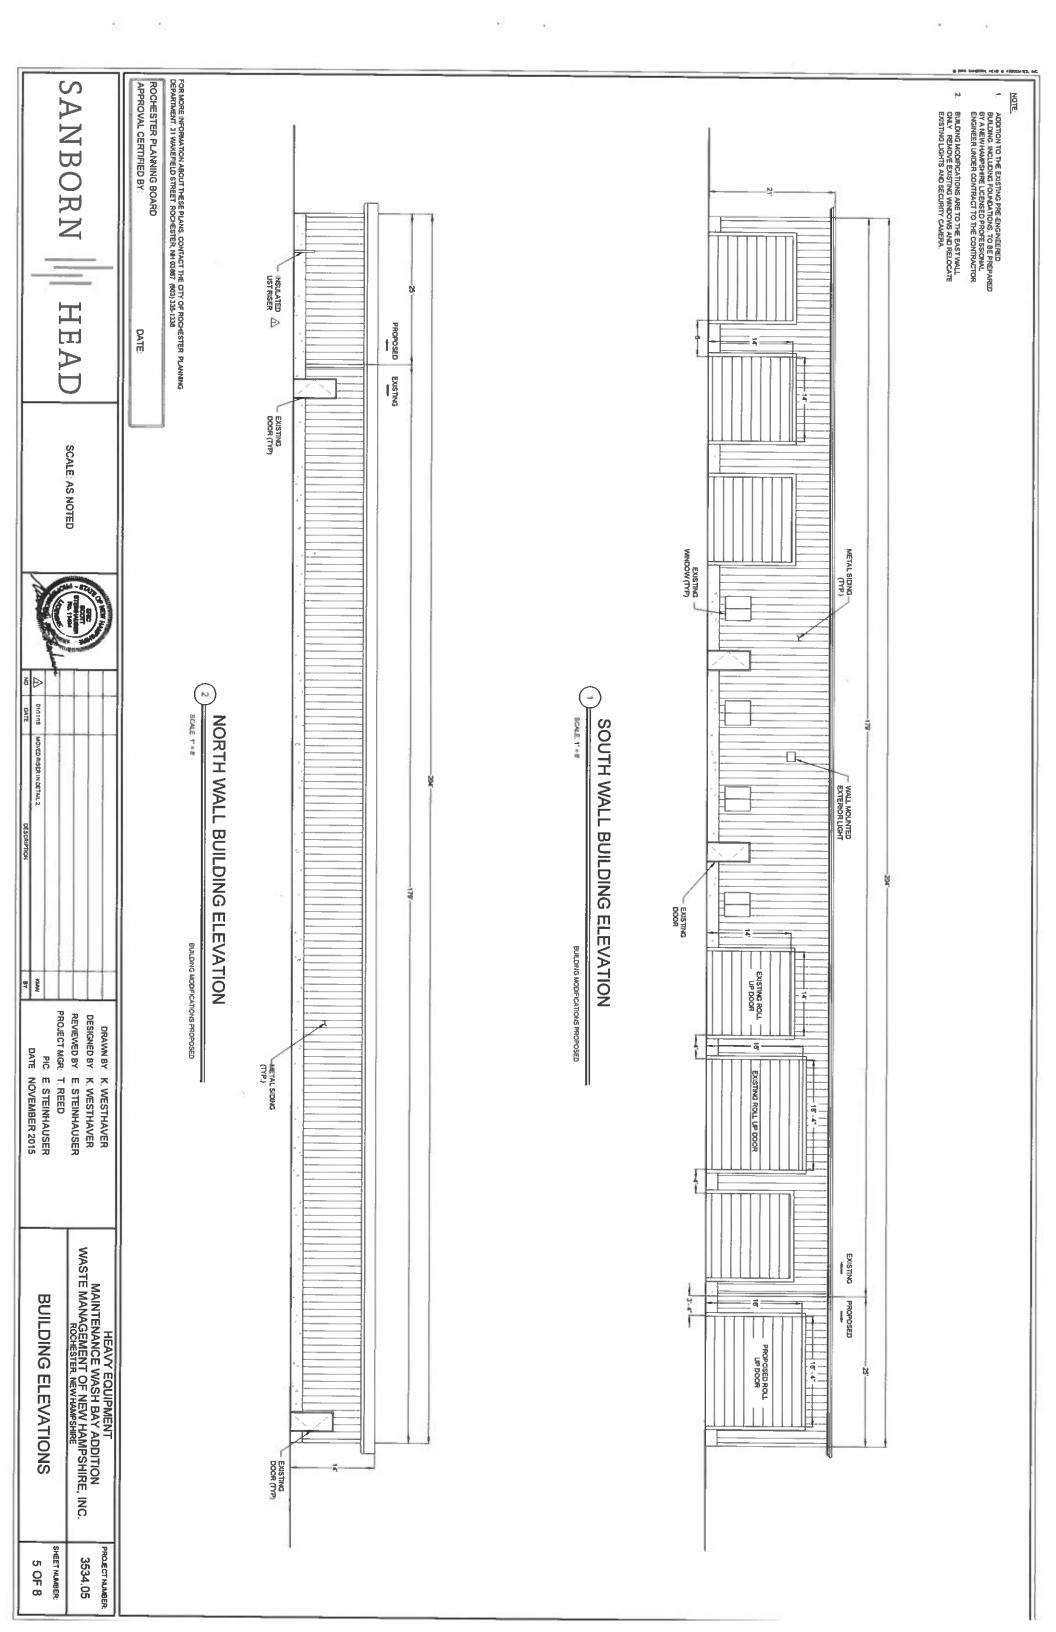

SANBORN | HEAD FOR MORE INFORMATION ABOUT THESE PLANS, CONTACT THE CITY OF ROCHESTER PLANNING DEPARTMENT, 31 WAKEFIELD STREET, ROCHESTER, NH 03887 (803) 335-1338. ROCHESTER PLANNING BOARD APPROVAL CERTIFIED BY ADDITION TO THE EXISTING PRE-ENGINEERED BUILDING, INCLUDING FOUNDATIONS. TO BE PREPARED BY A NEW HAWPSHIRE LICENSED PROFESSIONAL ENGINEER LINDER CONTRACTOR. BUILDING MODIFICATIONS ARE TO THE EAST WALL ONLY REMOVE EXISTING WINDOWS AND RELOCATE EXISTING LIGHTS AND SECURITY CAMERA. DATE SCALE: AS NOTED RELOCATED SECURITY CAMERA RELOCATED WALL MOUNTED EXTERIOR LIGHT (TYP) RELOCATED DOOR (TYP) SCALE THE EAST BUILDING WALL ELEVATION WEST BUILDING WALL ELEVATION (TYP.) BUILDING MODIFICATIONS PROPOSED NO BUILDING MODIFICATIONS PROPOSED PROJECT MGR. T. REED REVIEWED BY: E. STEINHAUSER DRAWN BY: K. WESTHAVER
DESIGNED BY: K. WESTHAVER PIC E STEINHAUSER
DATE NOVEMBER 2015 EXISTING DOOR EXISTING WALL MOUNTED EXTERIOR LIGHT (TYP) INSULATED UST RISER HEAVY EQUIPMENT
MAINTENANCE WASH BAY ADDITION
WASTE MANAGEMENT OF NEW HAMPSHIRE, INC.
ROCHESTER NEWHAMPSHIRE **BUILDING ELEVATIONS** SHEET NUMBER: PROJECT NUMBER: 6 OF 8 3534.05

NOTE

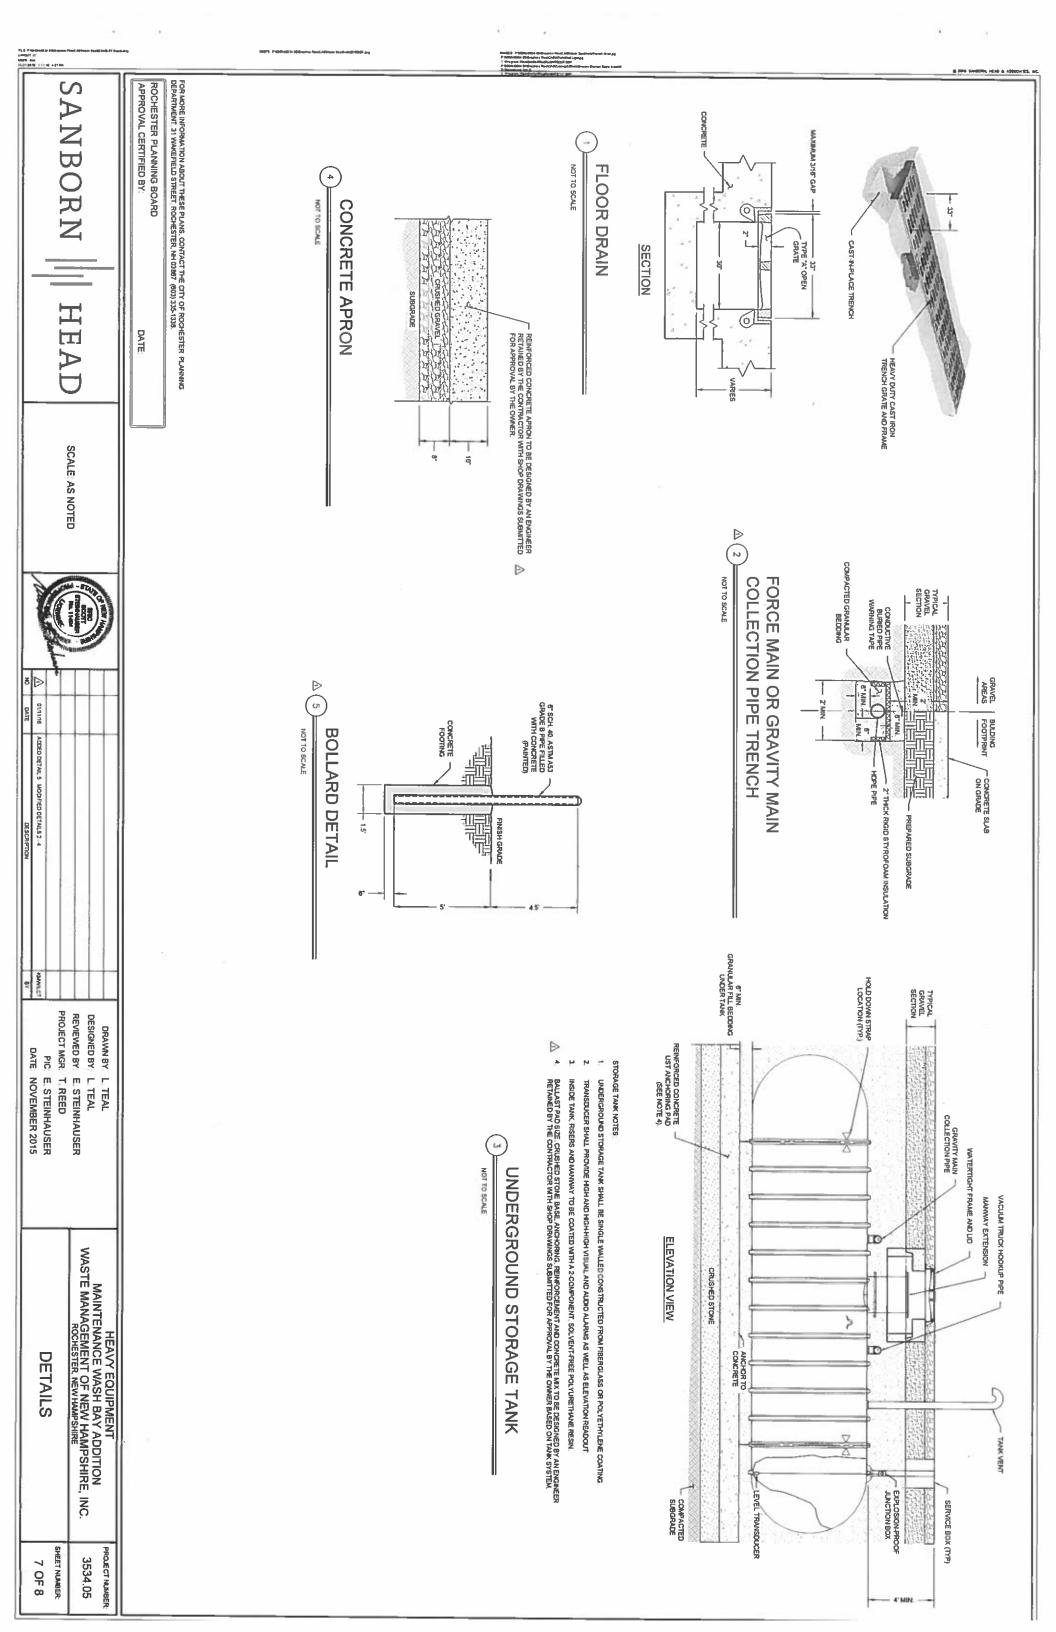

S. C. C. C.

LONGITUDRNAL ANCHOR

- BASE COURSE GRAVELS HAVE BEEN INSTALLED IN AREAS TO BE PAVED:
 A MINIMUM OF 85% VEGETATED GROWTH HAS BEEN ESTABLISHED;
 A MINIMUM OF 3 INCHES OF NON-EROSIVE MATERIAL SUCH AS STONE RIPRAP HAS BEEN
- **EROSION CONTROL BLANKETS HAVE BEEN PROPERLY INSTALLED**
- APPLY SEED, LIME, FERTILIZER, AND HAY MULCH TO DISTURBED AREAS, NEWLY-PLACED FILL SLOPES AND GRASS-LINED SWALES WITHIN SEVEN DAYS OF ACHIEVING FINAL GRADE. HAY MULCH SHALL BE APPLIED AT THE RATE OF 15 TO 2 TONS PER ACRE.
- SILT FENCE/HAY BALE EROSION CONTROL STRUCTURES SHALL BE INSTALLED AT THE DISCRETION OF ENGINEER. SILT FENCE SHALL BE INSTALLED ALONG THE CONTOUR AND TOED UPSLOPE. SILT FENCE/HAY BALE BARRIERS ARE TO BE MAINTAINED AND CLEANED UNTIL VEGETATIVE COVER IS
- ALL EROSION CONTROLS SUCH AS SILT FENCE SHALL BE INSPECTED WEEKLY DURING THE LIFE OF THE PROJECT AND AFTER EACH STORM EVENT WHICH PRODUCES 05 INCHES OF RAINFALL. ALL DAMAGED SILT FENCE SHALL BE REPAIRED PROMPTLY. ESTABLISHED.
- TRACK UP AND DOWN REGRADED SLOPES (GROUSER TRACKS PERPENDICULAR TO THE SLOPE) WITH

FINISH GRADE


- REMOVE SEDIMENT BUILD UP FROM BEHIND EROSION AND SEDIMENT CONTROL DEVICES. MAINTAIN TEMPORARY EROSION AND SEDIMENT CONTROL DEVICES UNTIL FULL ESTABLISHMENT OF PERMANENT GROUND COVER. A BULLDOZER TO LIMIT EROSION.
- DITCHES AND SWALES SHALL BE STABILIZED BEFORE RUNOFF IS DIRECTED TO THEM
- ALL ROADWAY AREAS SHALL BE STABILIZED WITHIN 72 HOURS OF ACHIEVING FINISHED GRADE
- ALL CUT AND FILL SLOPES SHALL BE SEEDED/LOAMED WITHIN 72 HOURS OF ACHIEVING FINISHED GRADE.
- ö

TOPSOIL AND SEEDING MATERIALS

ALL DISTURBED AREAS SHALL BE STABILIZED WITHIN 45 DAYS OF INITIAL DISTURBANCE

△(1 NOT TO SCALE TYPICAL LOAM AND SEED

COMPACTED OR UNDISTURBED SUBGRADE

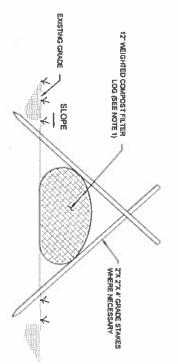

GRASS SHALL BE FROM THE SAME OR PREVIOUS YEAR'S CROP, EACH VARIETY OF SEED SHALL HAVE A PERCENTAGE OF GERMINATION NOT LESS THAN NINETY (90), A PERCENTAGE OF PURITY NOT LESS THAN EIGHTY-FIVE (85), AND SHALL HAVE NOT MORE THAN ONE PERCENT (1%) WEED CONTENT.

FERTILIZER SHALL BE LOW PHOSPHATE AND SLOW RELEASE NITROGEN AND APPLIED UNIFORMLY OVER THE DISTURBED AREA AT A RATE OF ELEVEN (11) POUNDS PER 1,000 SQUARE FEET (500

TOPSOIL SHALL BE FERTILE SOIL CAPABLE OF SUSTAINING VIGOROUS PLANT GROWTH, FREE FROM STONES GREATER THAN 3 INCHES, ROOTS, STICKS, PEAT, WEEDS, AND SOD. IT SHALL NOT CONTAIN MATERIAL HARMFUL TO PLANT GROWTH.

- 1 FILTER LOG SHALL BE "SILTSOXX" FROM FILTREXX NORTH-EAST SYSTEMS OF GOFFSTOWN, NH OR SMALAR
- PILTER LOGS SHALL BE PLACED DOWN GRADIENT OF CONSTRUCTION AREAS DURING CONSTRUCTION.

TYPICAL FILTER LOG DETAIL

Ð NOT TO SCALE



SCALE: AS NOTED

SANBORN |||| HEAD

FOR MORE INFORMATION ABOUT THESE PLANS, CONTACT THE CITY OF ROCHESTER PLANNING DEPARTMENT, 31 WAKEFIELD STREET, ROCHESTER, NH 03667 (803) 335-1338.

D

MULCH SHALL CONSIST OF DRY HAY OR STRAW AND BE FREE OF NOXIOUS WEEDS.

1.10 0.20 0 45 0.45

BIRDSFOOT TREFOIL CREEPING RED FESCUE TALL FESCUE

MIXTURE

POUNDS PER ACRE SEED MIX

POUNDS PER 1,000 SQ. FT.

20

APPLICATION OF FERTILIZER, LIME, SEED, AND MULCH SHALL ONLY BE PERFORMED DURING THOSE PERIODS WITHIN THE SEASONS WHICH ARE NORMAL FOR SUCH WORK AS DETERMINED BY THE WEATHER AND LOCALLY ACCEPTED PRACTICE, AND AS APPROVED BY ENGINEER.

ANY PART OF THE SEEDED AREA WHICH FAILS TO YIELD AN ACCEPTABLE STAND OF GRASS AFTER TWO MONTHS AS DETERMINED BY OWNER SHALL BE RETREATED WITH ADDITIONAL SEED, FERTILIZER, AND MULCH.

ROCHESTER PLANNING BOARD APPROVAL CERTIFIED BY:



NOT TO SCALE

DRAWN BY L. TEAL DATE NOVEMBER 2015

PROJECT MGR: T. REED REVIEWED BY E. STEINHAUSER DESIGNED BY: L. TEAL PIC E STEINHAUSER

HEAVY EQUIPMENT
MAINTENANCE WASH BAY ADDITION
WASTE MANAGEMENT OF NEW HAMPSHIRE, INC.
ROCHESTER NEW HAMPSHIRE

EROSION CONTROL DETAILS

PROJECT NUMBER 3534.05

SHEET NUMBER:

8 OF 8

DIMENSIONS GIVEN IN THE DRAWINGS ARE EXAMPLES; DEVICE SHOULD BE INSTALLED PER MANUFACTURER'S SPECIFICATIONS LAY BLANKETS LOOSELY AND STAKE OR STAPLE TO MAINTAIN DIRECT CONTACT WITH THE SOIL DO NOT STRETCH. APPLY PERMINENT SEEDING BEFORE PLACING BLANKETS. SLOPE SURFACE SHALL BE FREE OF ROCKS, CLODS, STICKS AND GRASS MATS/BLANKETS SHALL HAVE GOOD SOIL CONTACT SLOPE INST ALLATION EDOSION DIANLES JUCE OF JUN NOTES CHECK SLOTS TO BE CONSTRUCTED PER MANUFACTURER'S SPECIFICATIONS. DAMENSIONS GIVEN IN THE DRAWINGS ARE EXAMPLES, DEVICE SHOULD BE INSTALLED PER MANUFACTURER'S SPECIFICATIONS. STAKING OR STAPLING LAYOUT PER MANUFACTURER'S SPECIFICATIONS. CHANNEL INSTALLATION INTERVALS ISO

CHECK SLOT

TIPICAL SLOPE

SOURCE

REVI V HAMPSHIRE STORMMATER MANUAL. VOLUME 3 EROSION AND SEDIMENT CONTROLS DURING CONSTRUCTION" SION 1.0, DECEMBER 2008, PAGES 74 AND 75.

EROSION CONTROL BLANKET INSTALLATION

ELEVATION