
**NOVEMBER 2015** 

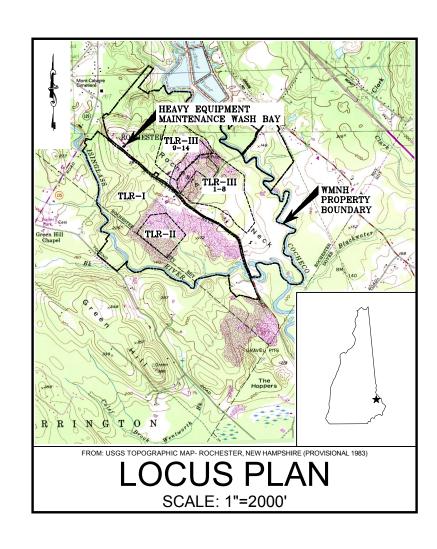

# SHEET INDEX

**OVERALL SITE AND ZONING PLAN** 

**EXISTING CONDITIONS PLAN** 

PROPOSED DEVELOPMENT PLAN

**BUILDING FLOOR PLAN** 

**BUILDING ELEVATIONS** 

**△ △ 7 DETAILS** 

**EROSION CONTROL DETAILS** 

FOR MORE INFORMATION ABOUT THESE PLANS, CONTACT THE CITY OF ROCHESTER PLANNING DEPARTMENT, 31 WAKEFIELD STREET, ROCHESTER, NH 03867 (603) 335-1338

APPROVAL CERTIFIED BY

DATE:

THE DEVELOPMENT DEPICTED IN THESE DRAWINGS MUST BE IN COMPLIANCE WITH ALL APPLICABLE AW-INCLUDING ALL PERTINENT PROVISIONS OF THE "CITY OF ROCHESTER SITE PLAI



PREPARED FOR:





WASTE MANAGEMENT OF NEW HAMPSHIRE, INC.


ROCHESTER. NEW HAMPSHIRE





20 FOUNDRY STREET, CONCORD, NEW HAMPSHIRE 03301 (603) 229-1900 FAX (603) 229-1919

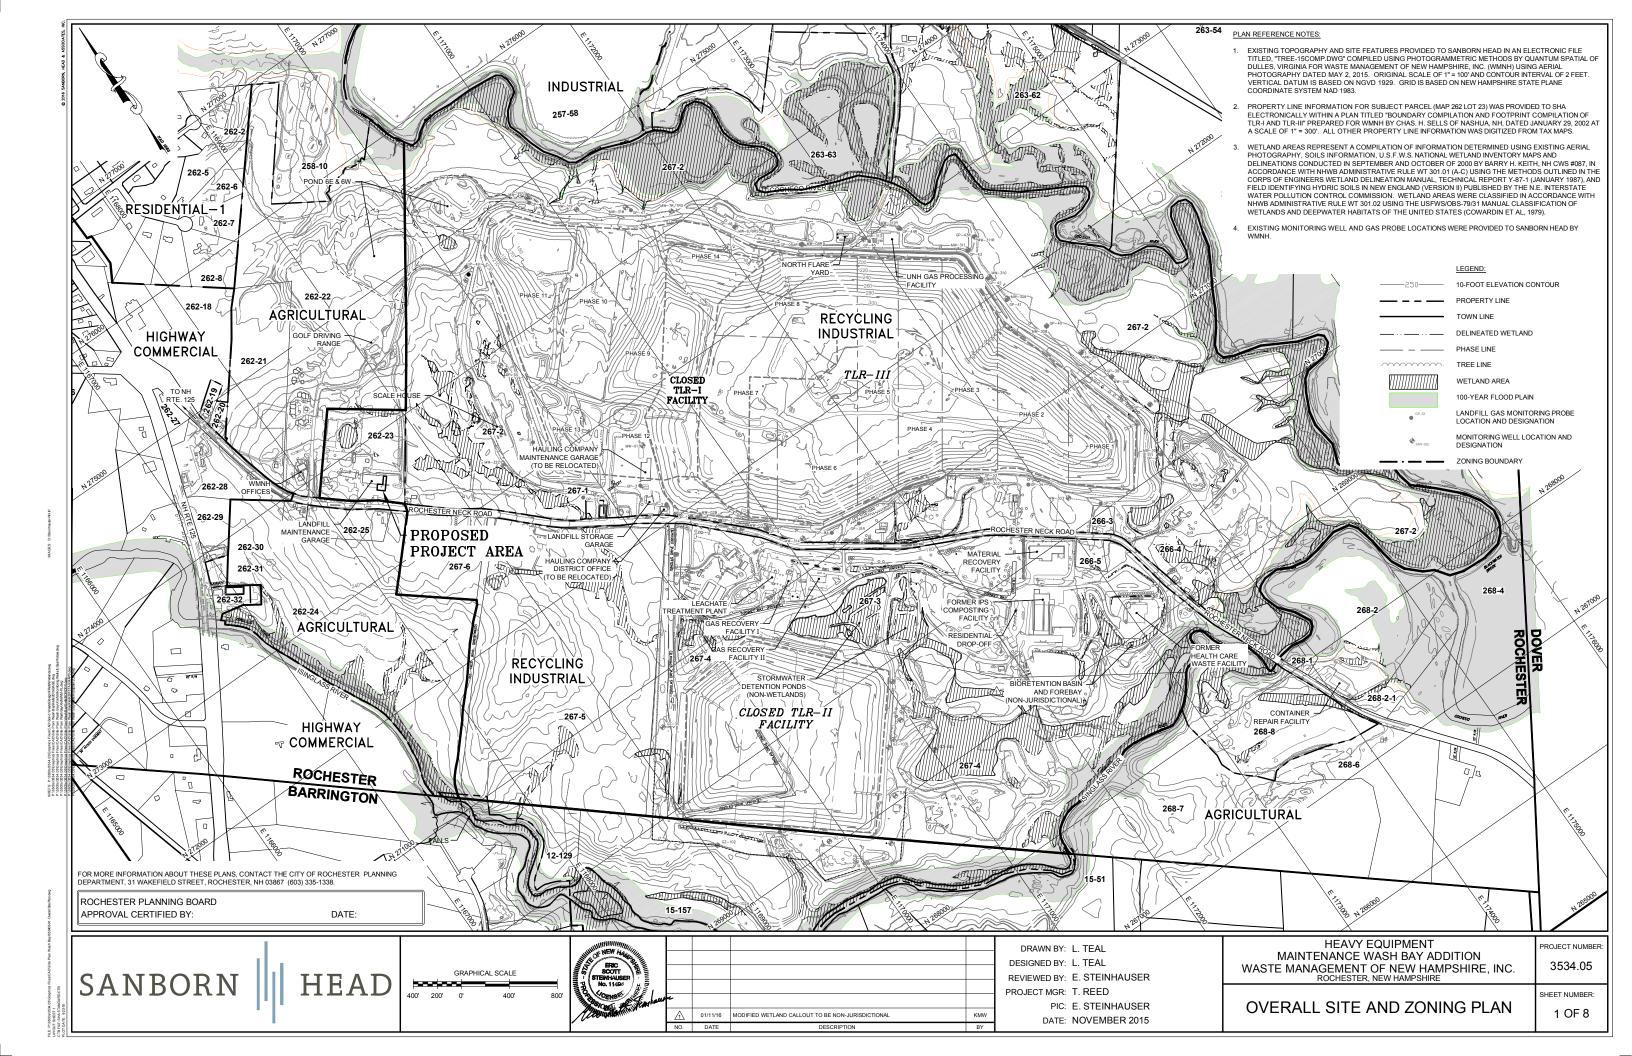

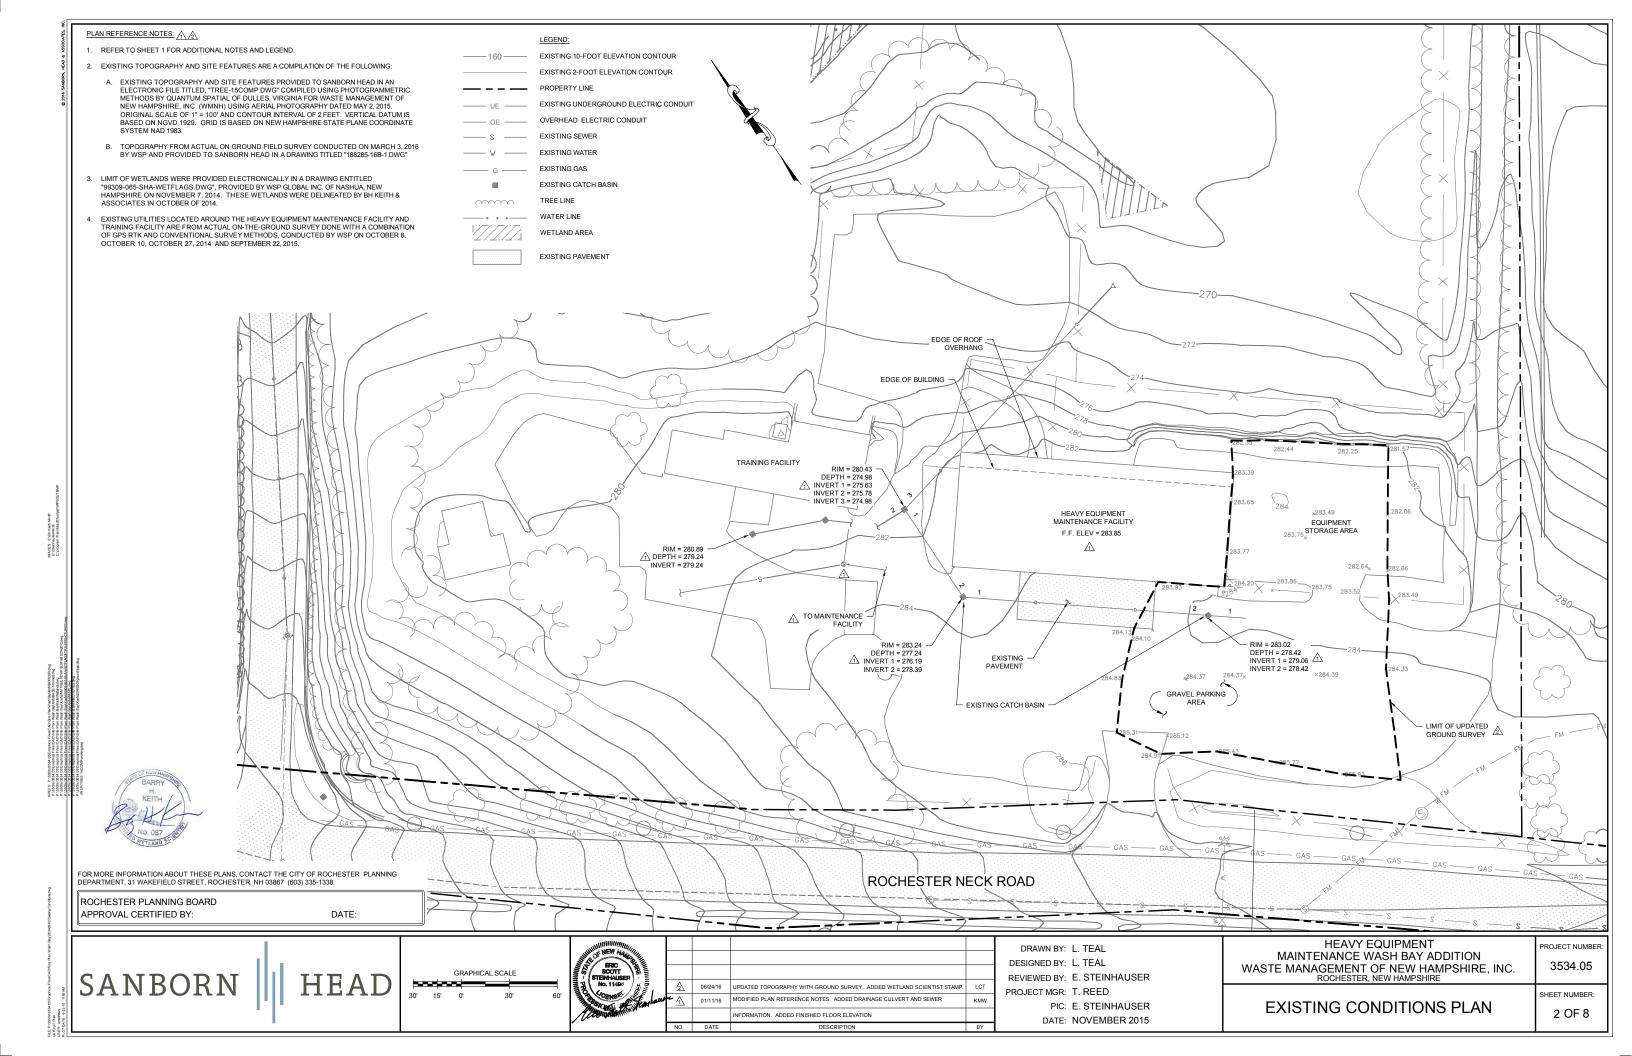

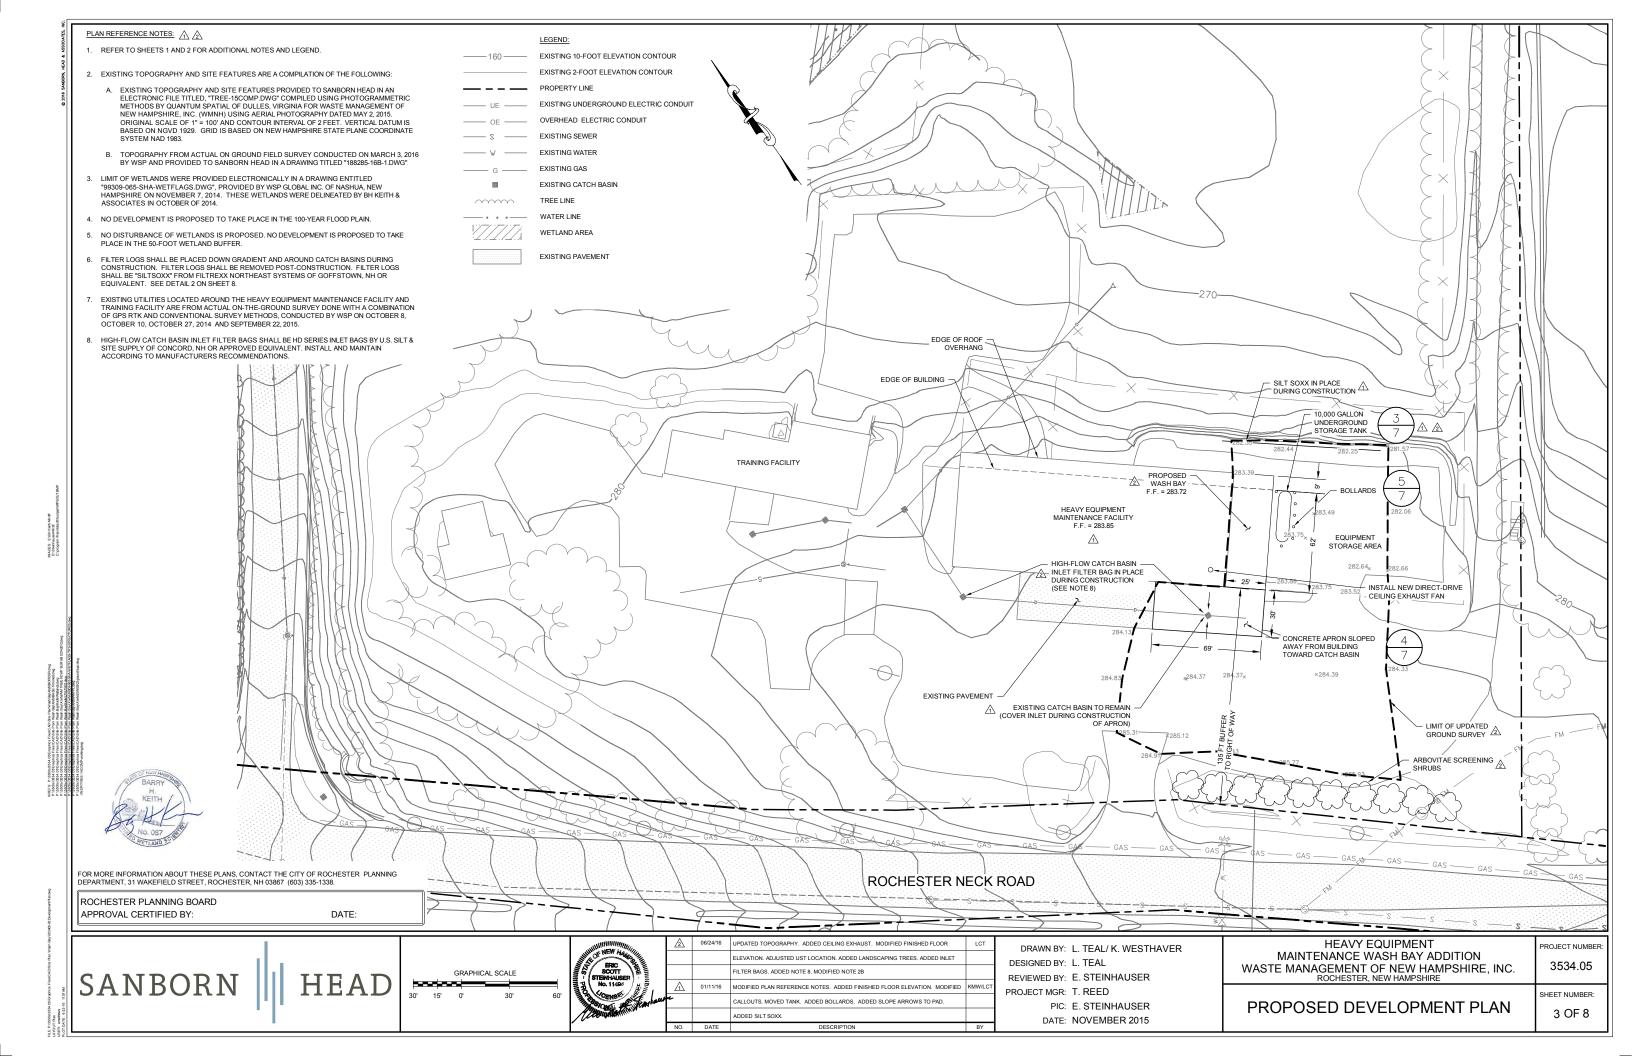


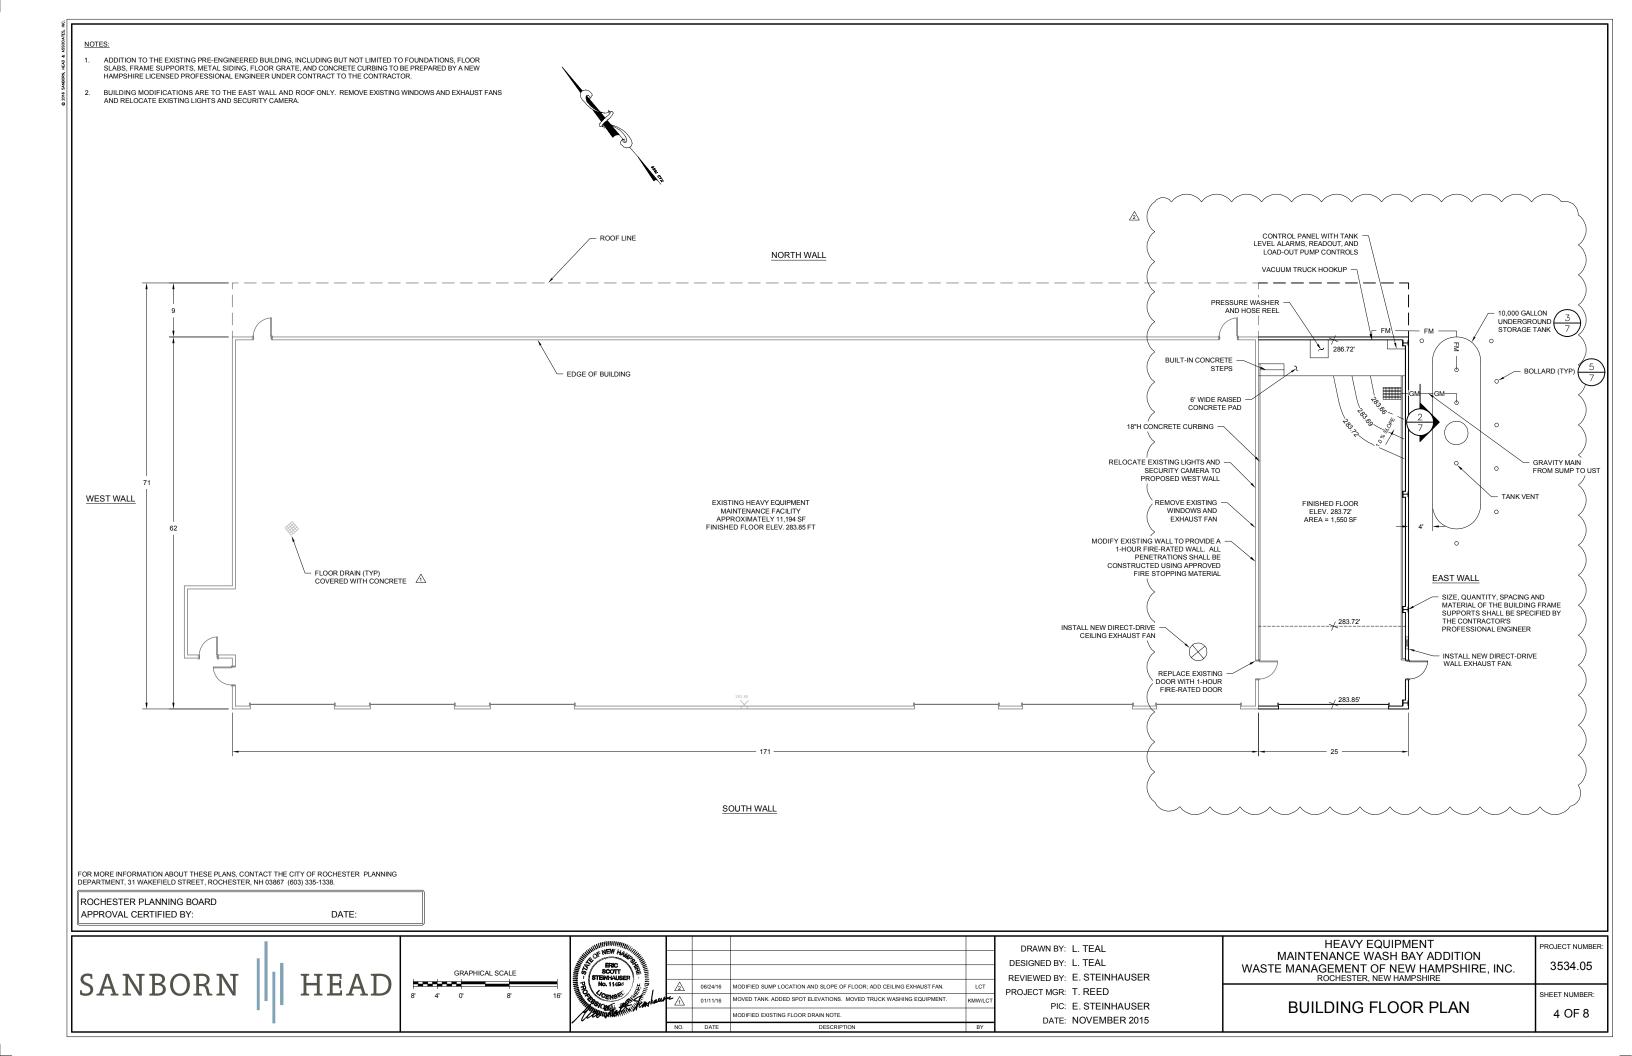

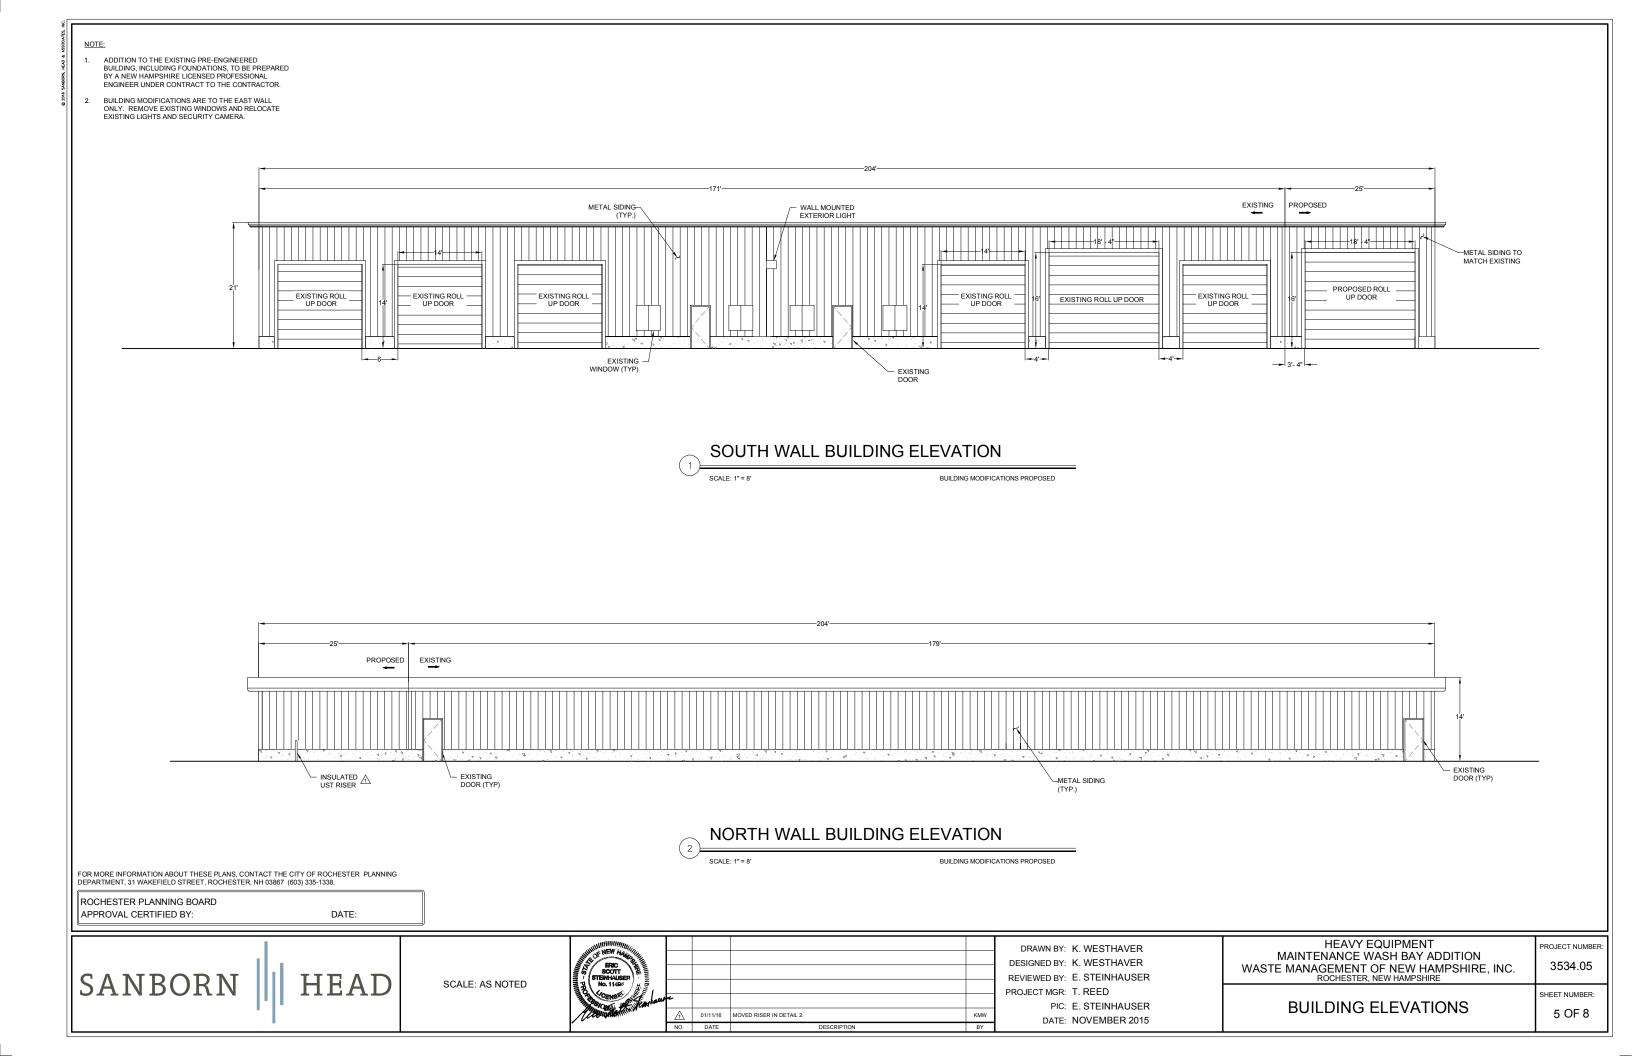


#### NOTE:

- ADDITION TO THE EXISTING PRE-ENGINEERED BUILDING, INCLUDING FOUNDATIONS, TO BE PREPARED BY A NEW HAMPSHIRE LICENSED PROFESSIONAL ENGINEER UNDER CONTRACT TO THE CONTRACTOR.
- BUILDING MODIFICATIONS ARE TO THE EAST WALL ONLY. REMOVE EXISTING WINDOWS AND RELOCATE EXISTING LIGHTS AND SECURITY CAMERA.

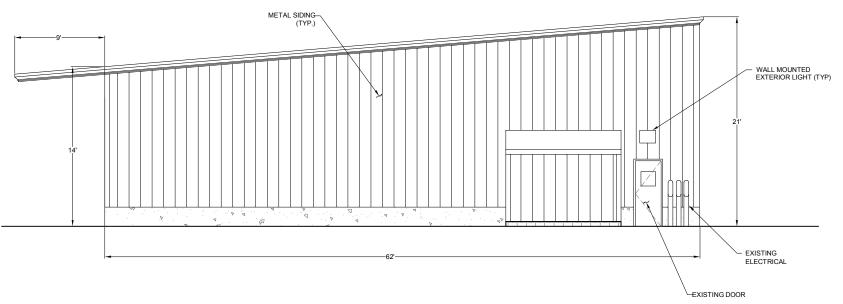

# WEST BUILDING WALL ELEVATION SCALE: 1'=5' NO BUILDING MODIFICATIONS PROPOSED

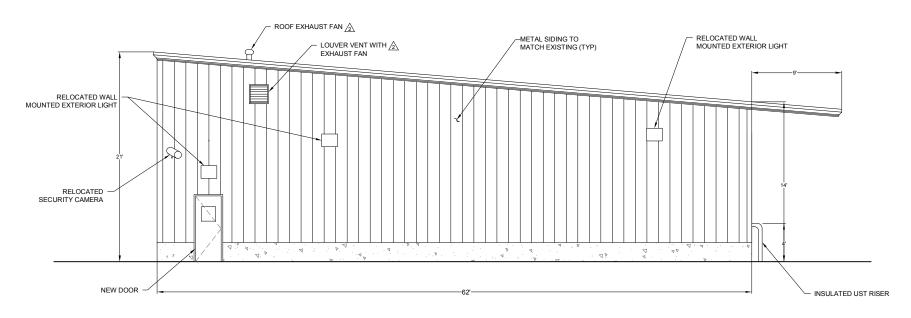

# EAST BUILDING WALL ELEVATION SCALE: 1' = 5' BUILDING MODIFICATIONS PROPOSED

FOR MORE INFORMATION ABOUT THESE PLANS, CONTACT THE CITY OF ROCHESTER PLANNING DEPARTMENT, 31 WAKEFIELD STREET, ROCHESTER, NH 03867 (603) 335-1338.

ROCHESTER PLANNING BOARD APPROVAL CERTIFIED BY:

DATE:

SANBORN	HEAD
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SCALE: AS NOTED

PORT STEPHANSER NO. 14484	<u>2</u>	06/24/16	EAST BUILDING LAYOUT. ADDED ROOF EXHAUST FAN AND LOUVER VENT	LCT	
CERTIFICATION	2	06/24/16	EAST BUILDING LAYOUT. ADDED ROOF EXHAUST FAN AND LOUVER VENT	LCT	
	NO.	DATE	DESCRIPTION	BY	

DRAWN BY: K. WESTHAVER
DESIGNED BY: K. WESTHAVER

DESIGNED BY: K. WESTHAVER
REVIEWED BY: E. STEINHAUSER

PROJECT MGR: T. REED

PIC: E. STEINHAUSER
DATE: NOVEMBER 2015


HEAVY EQUIPMENT MAINTENANCE WASH BAY ADDITION WASTE MANAGEMENT OF NEW HAMPSHIRE, INC. ROCHESTER, NEW HAMPSHIRE

BUILDING ELEVATIONS

PROJECT NUMBER

SHEET NUMBER:

6 OF 8

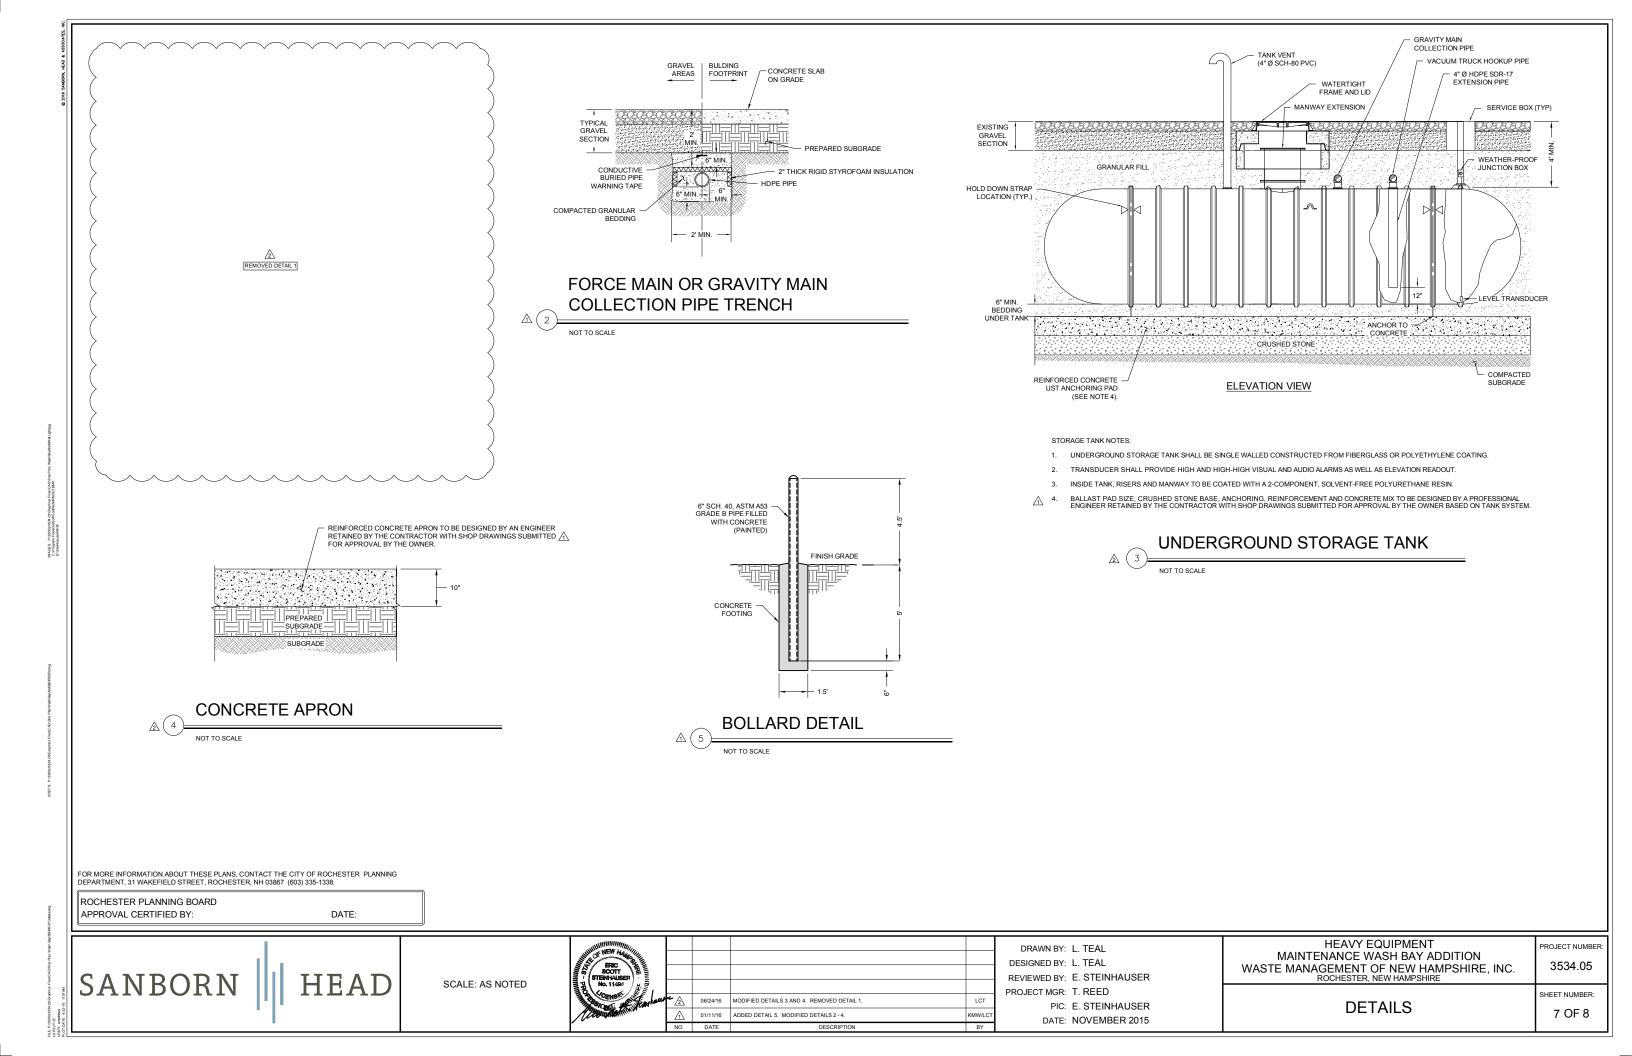

- THE SMALLEST PRACTICAL AREA SHALL BE DISTURBED DURING CONSTRUCTION, BUT IN NO CASE SHALL EXCEED 5 ACRES AT ANY ONE TIME BEFORE DISTURBED AREAS ARE STABILIZED. THE TERM "STABLE" IS DEFINED AS MEETING ONE OF THE FOLLOWING CRITERIA:
  - BASE COURSE GRAVELS HAVE BEEN INSTALLED IN AREAS TO BE PAVED;

  - A MINIMUM OF 85% VEGETATED GROWTH HAS BEEN ESTABLISHED; A MINIMUM OF 3 INCHES OF NON-EROSIVE MATERIAL SUCH AS STONE RIPRAP HAS BEEN
  - EROSION CONTROL BLANKETS HAVE BEEN PROPERLY INSTALLED.
- APPLY SEED, LIME, FERTILIZER, AND HAY MULCH TO DISTURBED AREAS, NEWLY-PLACED FILL SLOPES, AND GRASS-LINED SWALES WITHIN SEVEN DAYS OF ACHIEVING FINAL GRADE. HAY MULCH SHALL BE APPLIED AT THE RATE OF 1.5 TO 2 TONS PER ACRE.
- SILT FENCE/HAY BALE EROSION CONTROL STRUCTURES SHALL BE INSTALLED AT THE DISCRETION OF ENGINEER. SILT FENCE SHALL BE INSTALLED ALONG THE CONTOUR AND TOED UPSLOPE. SILT FENCE/HAY BALE BARRIERS ARE TO BE MAINTAINED AND CLEANED UNTIL VEGETATIVE COVER IS
- ALL EROSION CONTROLS SUCH AS SILT FENCE SHALL BE INSPECTED WEEKLY DURING THE LIFE OF THE PROJECT AND AFTER EACH STORM EVENT WHICH PRODUCES 0.5 INCHES OF RAINFALL. ALL DAMAGED SILT FENCE SHALL BE REPAIRED PROMPTLY.
- TRACK UP AND DOWN REGRADED SLOPES (GROUSER TRACKS PERPENDICULAR TO THE SLOPE) WITH A BULLDOZER TO LIMIT EROSION.
- REMOVE SEDIMENT BUILD UP FROM BEHIND EROSION AND SEDIMENT CONTROL DEVICES. MAINTAIN TEMPORARY EROSION AND SEDIMENT CONTROL DEVICES UNTIL FULL ESTABLISHMENT OF PERMANENT GROUND COVER
- DITCHES AND SWALES SHALL BE STABILIZED BEFORE RUNOFF IS DIRECTED TO THEM.
- ALL ROADWAY AREAS SHALL BE STABILIZED WITHIN 72 HOURS OF ACHIEVING FINISHED GRADE.
- ALL CUT AND FILL SLOPES SHALL BE SEEDED/LOAMED WITHIN 72 HOURS OF ACHIEVING FINISHED
- 10. ALL DISTURBED AREAS SHALL BE STABILIZED WITHIN 45 DAYS OF INITIAL DISTURBANCE.

#### SPECIFICATIONS:

### TOPSOIL AND SEEDING MATERIALS

- TOPSOIL SHALL BE FERTILE SOIL CAPABLE OF SUSTAINING VIGOROUS PLANT GROWTH, FREE FROM STONES GREATER THAN 3 INCHES, ROOTS, STICKS, PEAT, WEEDS, AND SOD. IT SHALL NOT CONTAIN MATERIAL HARMFUL TO PLANT GROWTH.
- FERTILIZER SHALL BE LOW PHOSPHATE AND SLOW RELEASE NITROGEN AND APPLIED UNIFORMLY OVER THE DISTURBED AREA AT A RATE OF ELEVEN (11) POUNDS PER 1,000 SQUARE FEET (500 POUNDS PER ACRE)
- GRASS SHALL BE FROM THE SAME OR PREVIOUS YEAR'S CROP; EACH VARIETY OF SEED SHALL HAVE A PERCENTAGE OF GERMINATION NOT LESS THAN NINETY (90), A PERCENTAGE OF PURITY NOT LESS THAN EIGHTY-FIVE (85), AND SHALL HAVE NOT MORE THAN ONE PERCENT (1%) WEED CONTENT.

GRASS SEED MIX						
MIXTURE	POUNDS PER ACRE	POUNDS PER 1,000 SQ. FT.				
TALL FESCUE	20	0.45				
CREEPING RED FESCUE	20	0.45				
BIRDSFOOT TREFOIL	8	0.20				
TOTAL	48	1.10				


- MULCH SHALL CONSIST OF DRY HAY OR STRAW AND BE FREE OF NOXIOUS WEEDS
- APPLICATION OF FERTILIZER, LIME, SEED, AND MULCH SHALL ONLY BE PERFORMED DURING THOSE PERIODS WITHIN THE SEASONS WHICH ARE NORMAL FOR SUCH WORK AS DETERMINED BY THE WEATHER AND LOCALLY ACCEPTED PRACTICE, AND AS APPROVED BY ENGINEER
- ANY PART OF THE SEEDED AREA WHICH FAILS TO YIELD AN ACCEPTABLE STAND OF GRASS AFTER TWO MONTHS AS DETERMINED BY OWNER SHALL BE RETREATED WITH ADDITIONAL SEED, FERTILIZER, AND MULCH.

FOR MORE INFORMATION ABOUT THESE PLANS, CONTACT THE CITY OF ROCHESTER PLANNING DEPARTMENT, 31 WAKEFIELD STREET, ROCHESTER, NH 03867 (603) 335-1338.


ROCHESTER PLANNING BOARD APPROVAL CERTIFIED BY:

DATE:

SCALE: AS NOTED

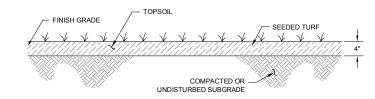




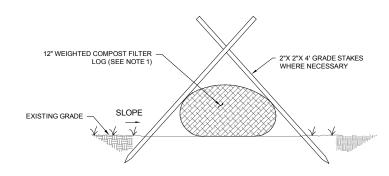


- 1. FILTER LOG SHALL BE "SILTSOXX" FROM FILTREXX NORTHEAST SYSTEMS OF GOFFSTOWN, NH OR
- 2. FILTER LOGS SHALL BE PLACED DOWN GRADIENT OF CONSTRUCTION AREAS DURING

## **ELEVATION**

## TYPICAL FILTER LOG DETAIL

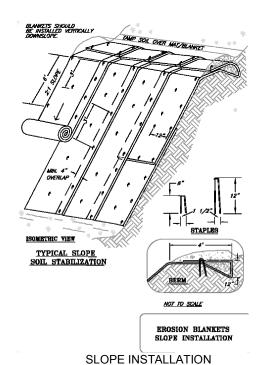

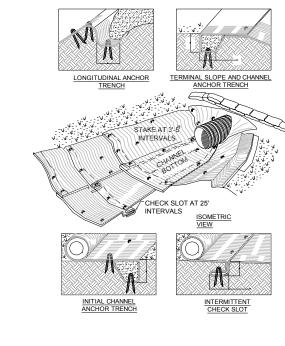

### **CHANNEL INSTALLATION**

#### NOTES:

- DIMENSIONS GIVEN IN THE DRAWINGS ARE EXAMPLES; DEVICE SHOULD BE INSTALLED PER MANUFACTURER'S SPECIFICATIONS.
- SLOPE SURFACE SHALL BE FREE OF ROCKS, CLODS, STICKS AND GRASS. MATS/BLANKETS SHALL HAVE GOOD SOIL CONTACT.
- APPLY PERMINENT SEEDING BEFORE PLACING BLANKETS
- LAY BLANKETS LOOSELY AND STAKE OR STAPLE TO MAINTAIN DIRECT CONTACT WITH THE SOIL, DO NOT STRETCH.

- DIMENSIONS GIVEN IN THE DRAWINGS ARE EXAMPLES; DEVICE SHOULD BE INSTALLED PER MANUFACTURER'S
- CHECK SLOTS TO BE CONSTRUCTED PER MANUFACTURER'S SPECIFICATIONS.
- STAKING OR STAPLING LAYOUT PER MANUFACTURER'S SPECIFICATIONS.

"NEW HAMPSHIRE STORMWATER MANUAL, VOLUME 3 EROSION AND SEDIMENT CONTROLS DURING CONSTRUCTION" REVISION 1.0, DECEMBER 2008, PAGES 74 AND 75.

## **EROSION CONTROL BLANKET INSTALLATION**

NOT TO SCALE

SANBORN

01/11/16 REVISED DETAILS 1 AND 2

DRAWN BY: L. TEAL DESIGNED BY: L. TEAL REVIEWED BY: E. STEINHAUSER PROJECT MGR: T. REED PIC: E. STEINHAUSER

DATE: NOVEMBER 2015

**HEAVY EQUIPMENT** MAINTENANCE WASH BAY ADDITION WASTE MANAGEMENT OF NEW HAMPSHIRE, INC. ROCHESTER, NEW HAMPSHIRE

PROJECT NUMBER 3534.05

**EROSION CONTROL DETAILS** 

SHEET NUMBER 8 OF 8